





KABUL MUNICIPALITY
URBAN INFRASTRUCTURE DIRECTORATE
DESIGN DEPARTMENT




Cot-e-Sangi to Demazng Road Project
پروژه سرک کوته سنگی الی دهمزنج

LOCATION : 3TH DISTRICT

LENGTH : 3226m

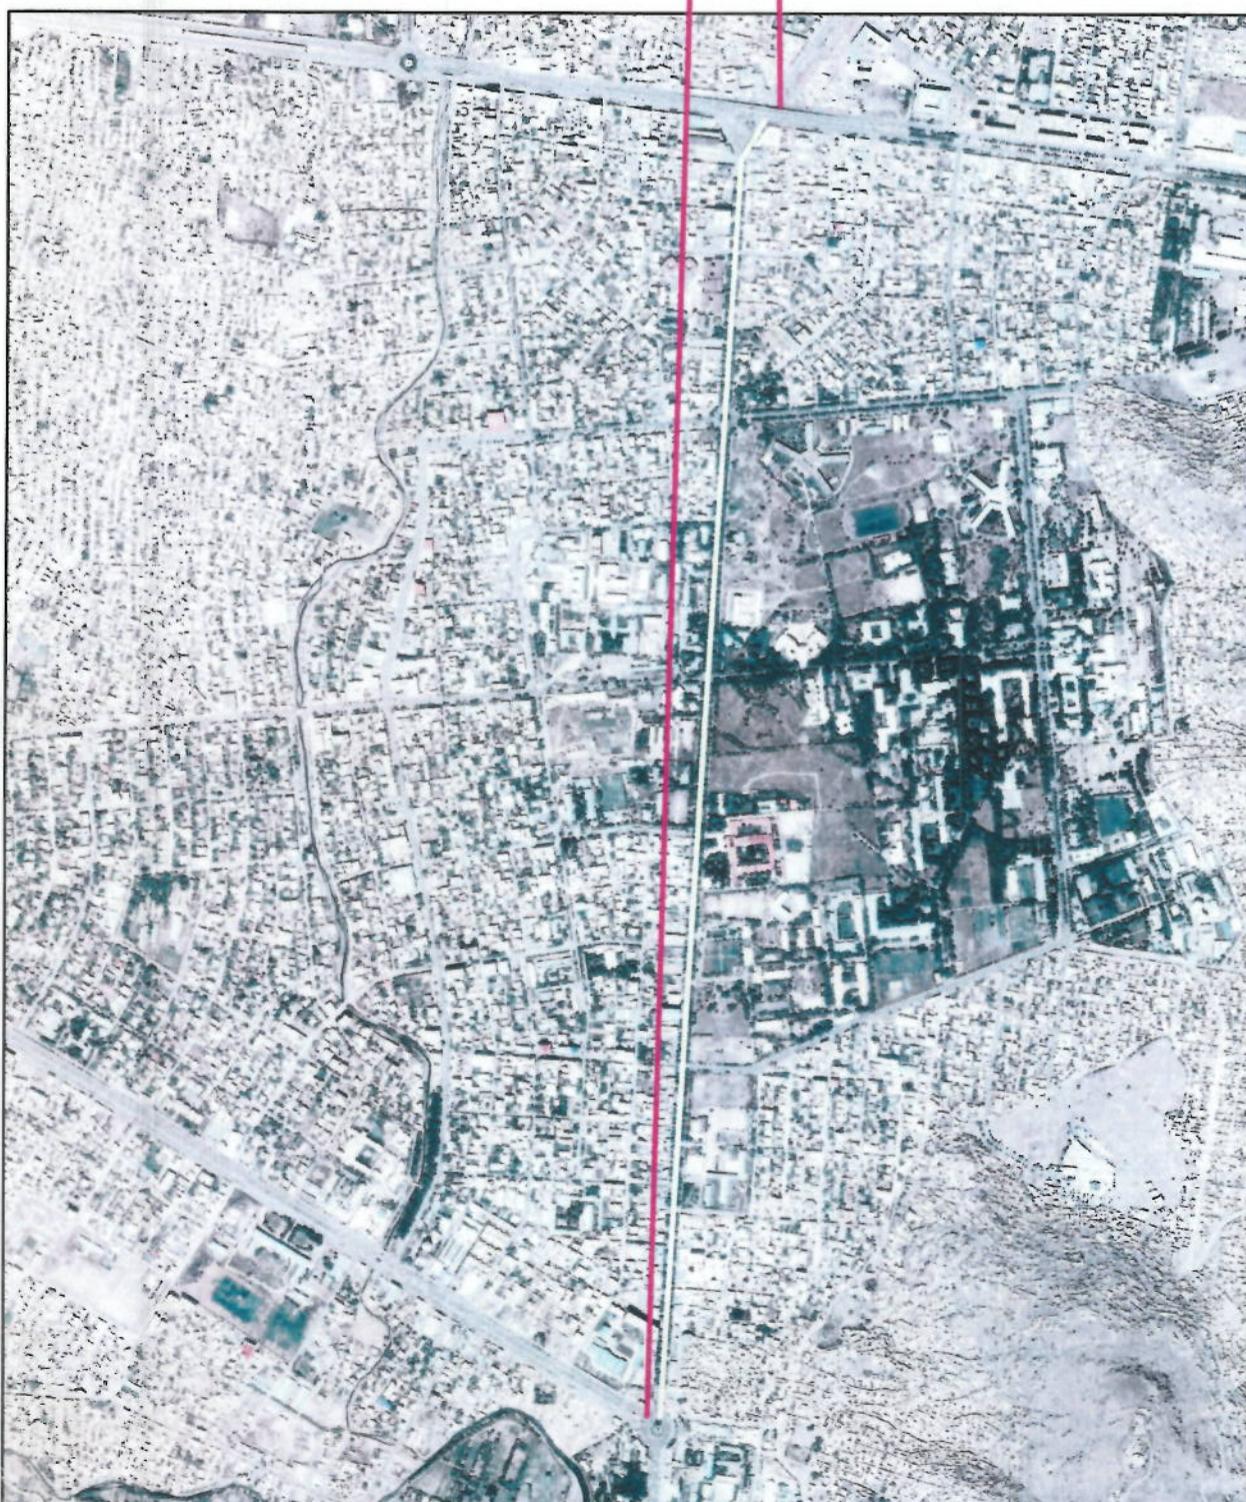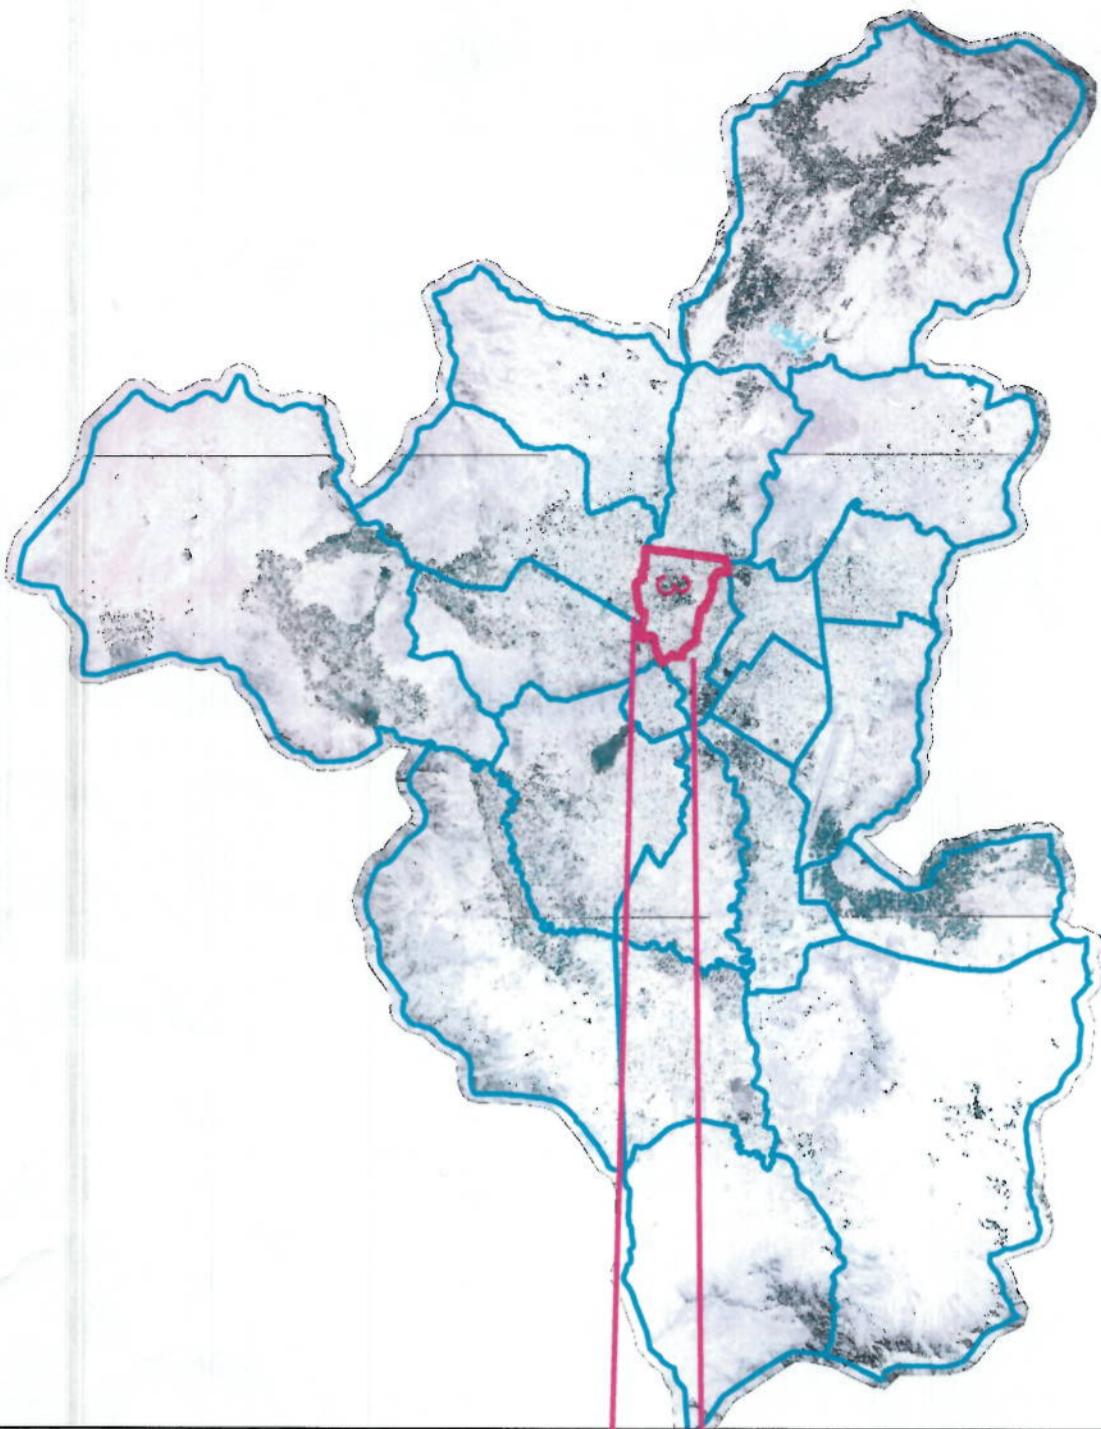

DESIGN LAYOUT

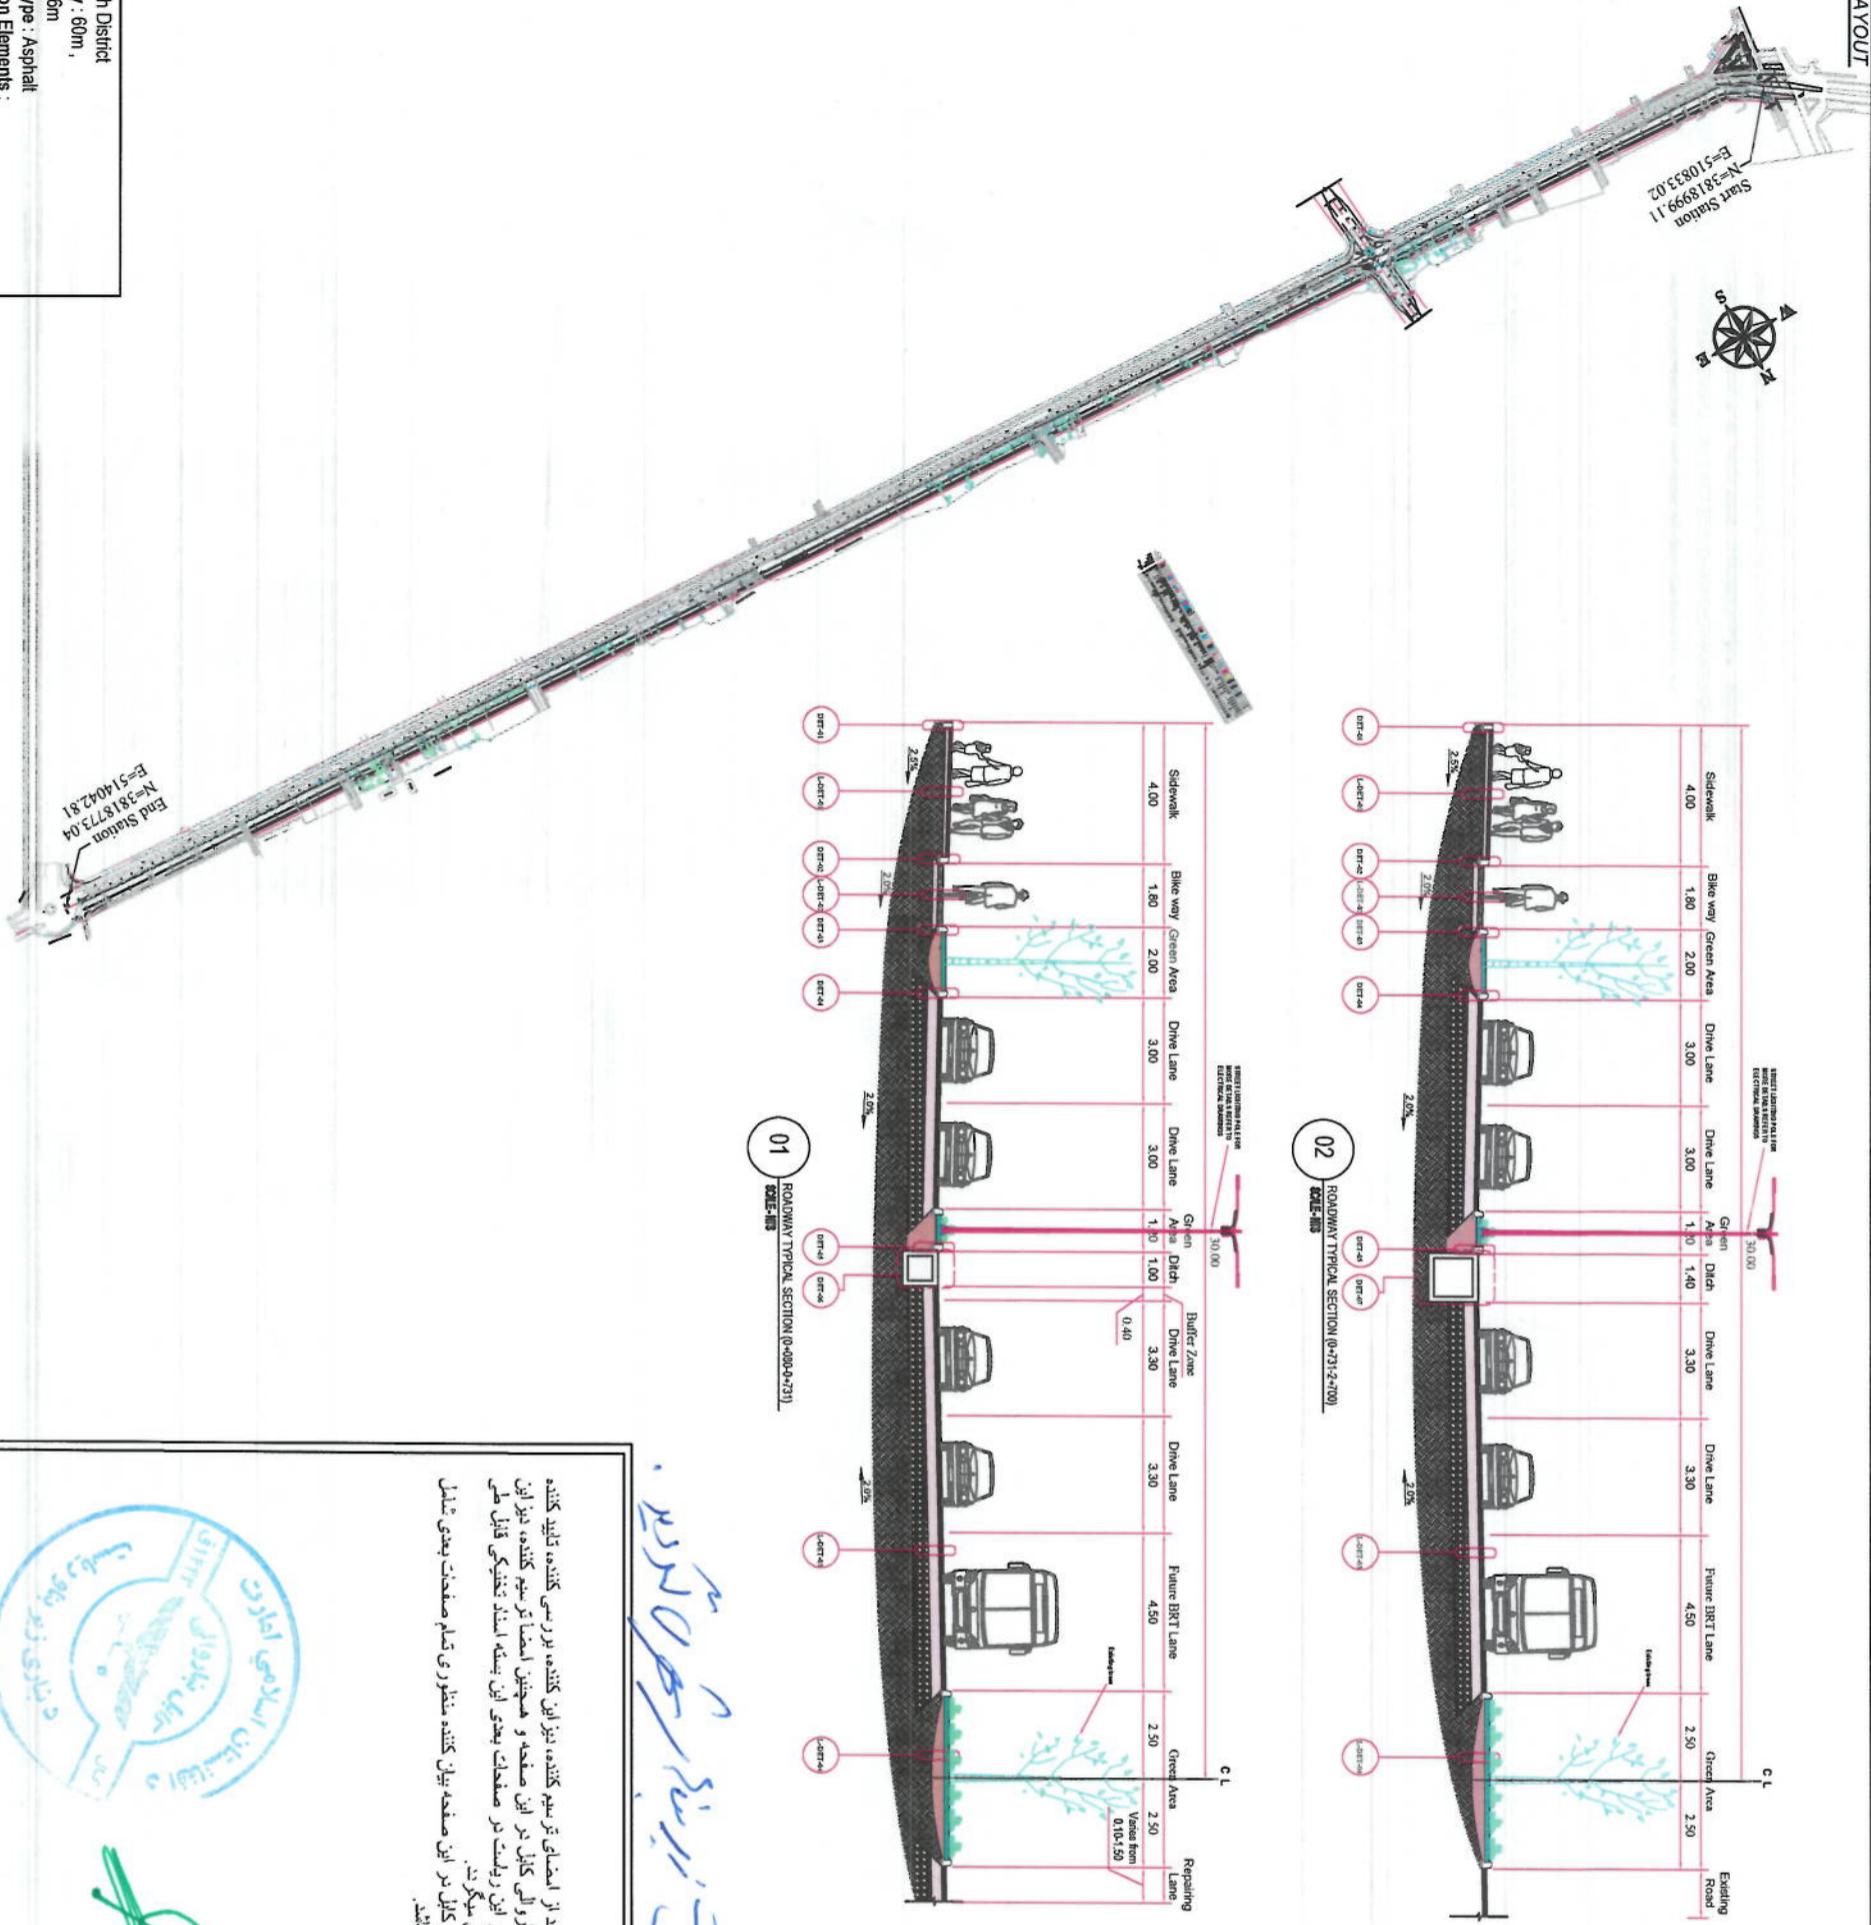

٦٣

1- پیلان پروره های اکتشافی بودجه داخلی سال 1402 که تحت نمیر 47 لر پلار استان تختیگی پروره سرک کوته سنگی الی دهرزیگ به عرض 60 متر نظریه پیلان

卷之三

2- دور پیاز سرک متینکار به عرض 60 متر در نظر گرفته شده است نظر به تزیم بید مقامات صالحه شاهرو الی کابل و کاوش مصطفی پور^{۱۵} ساخته شده است.

卷之三

گوی بیزار مندی هایی قابل میلشند، لذا فعلاً طرف چه سرک (قسمت توسعه یافته آن) به جز چهار راهی کوئه منکری و دعویزی، نیزین گر نزدیه است. تاکتیکهای بیزار که هر زمانیکه تصمیم به دیر از این پلتینیو طرف راست از نظر به مقطعه عرضی جذب کرده شود لازم است تا نظر به شرایط موجوده سرک و ساده، تنسی ساختنی هایی آن (لوش سرک، ابعاد جوی کناری و سایر ساختنی ها) هم داشته باشند، قدر یکدیگر

卷之三

جی سے مسح ۱۹۴۵ء / ۱۹۱۲ء قیدِ حبیب اور نامہ جو کھل دیا۔

Location : 3th District

Right of Way: 60m,
length: 3226m

Edgerton • 3220

Cross Section Elements :
Drive way, Side Ditches, Bikeway, Median, Curbstones,
Sidewalks

NOTE: ALL DIMENSIONS ARE IN METERS
UNLESS OTHERWISE INDICATED

LEGEND

SCODE DETAIL

THEME

1. TIL Building

2. TIL Road

3. TIL Water

4. TIL Other

5. TIL Tree

6. TIL Street Name

7. TIL Center Line

8. TIL Curve

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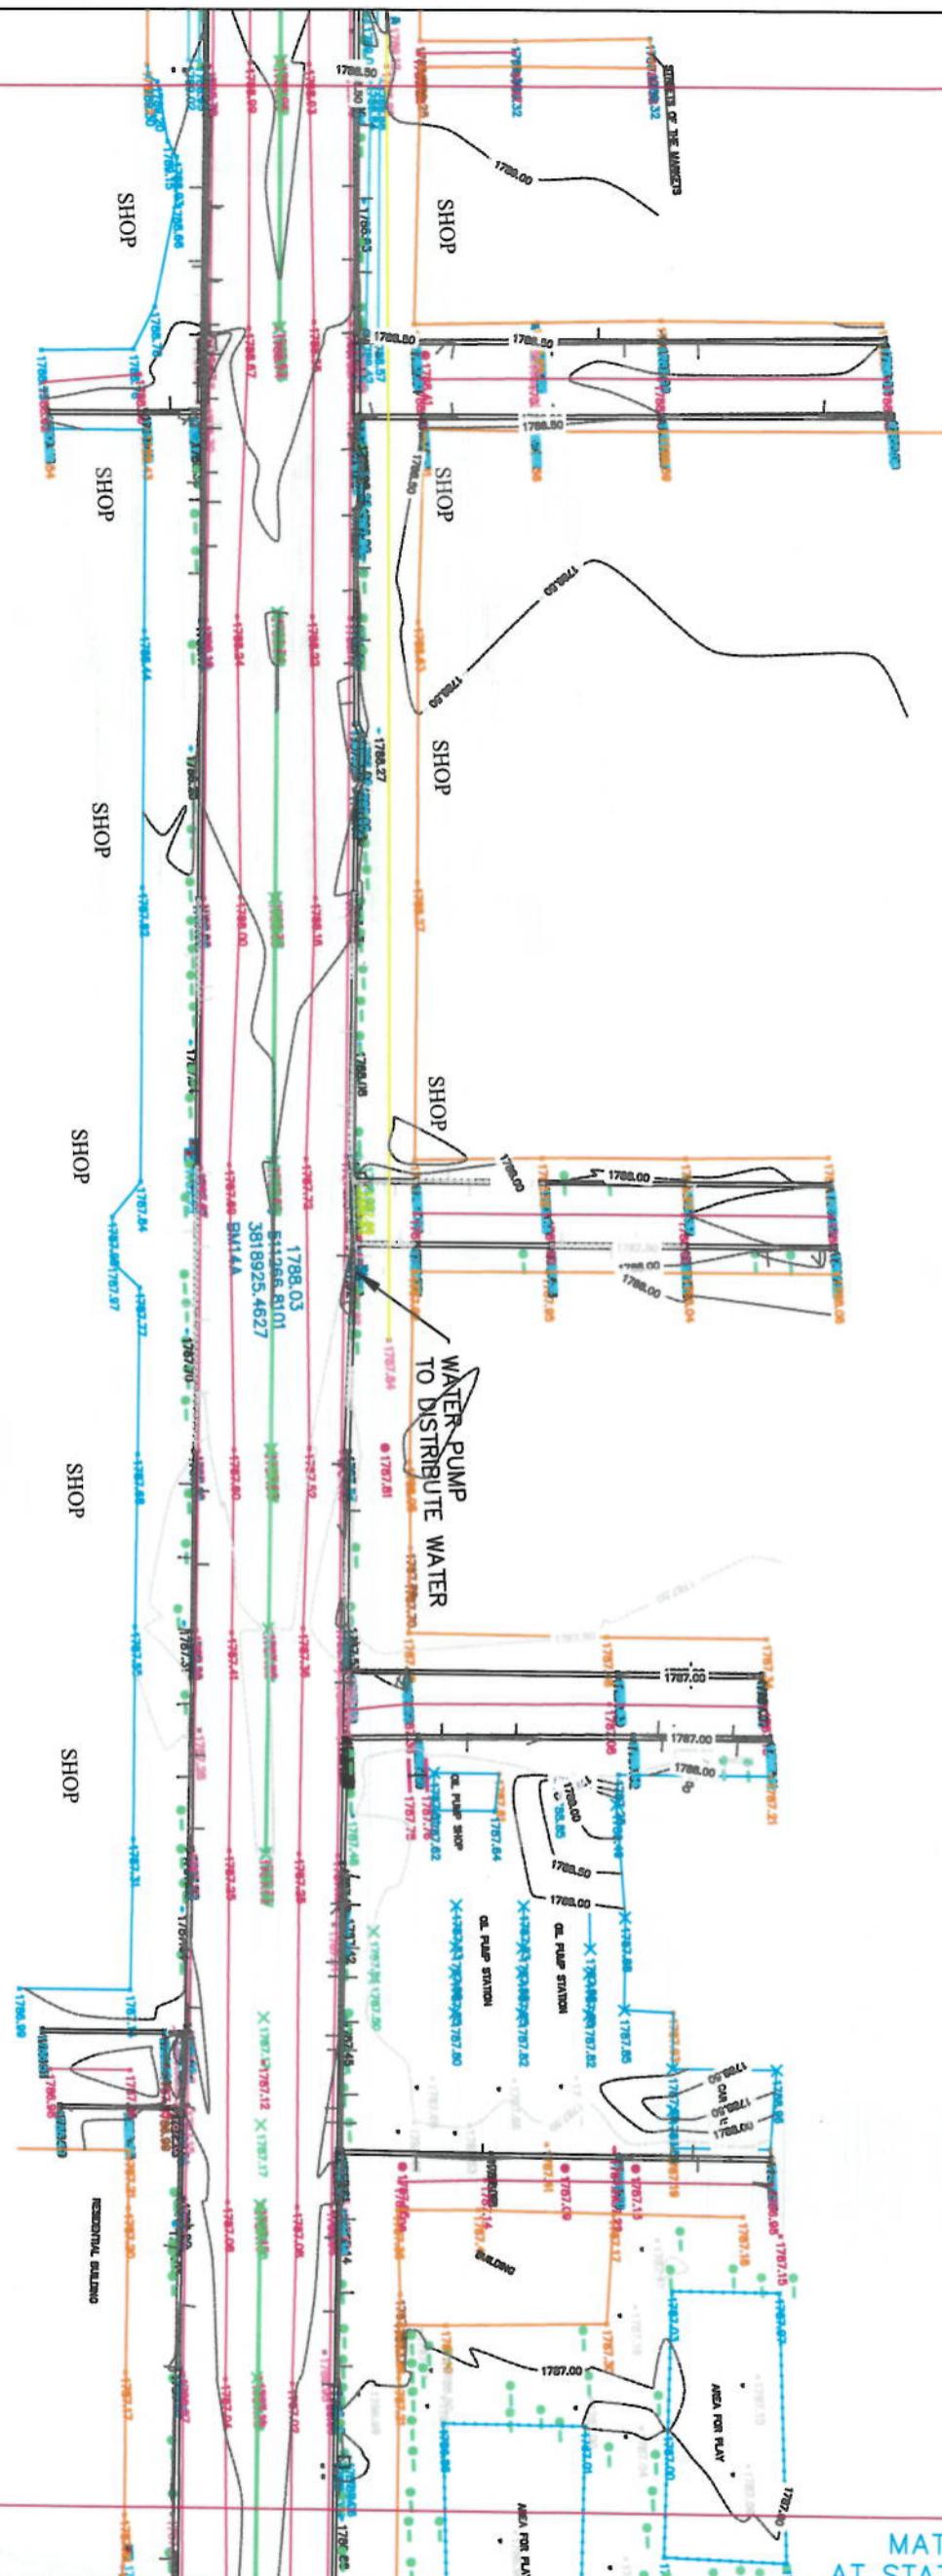
187. TIL Curve

188. TIL Curve

1

AT STATION - 0+329.00
PREVIOUS SHEET NUMBER - 1

SHOP




NOTE: ALL DIMENSIONS ARE IN METERS
UNLESS OTHERWISE INDICATED

LEGEND

NO.	CODE	DETAIL	PICTURE
1	BL	Building	
2	RD	Road	
3	ST	Street	
4	AD	Area	
5	TD	Topography	
6	UD	Unseen Survey	
7	CLC	Control Line	
8	FC	Frontage	
9	PC	Plotting	
10	SC	Section	
11	TSN	True North	
12	DR	Distance	
13	MT	Mean Height	
14	TR	True Position	
15	TM	True Meridian	
16	TMN	True Meridian	
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18	TMN	True Meridian	
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AT STATION - 0+658.00
PREVIOUS SHEET NUMBER - 2

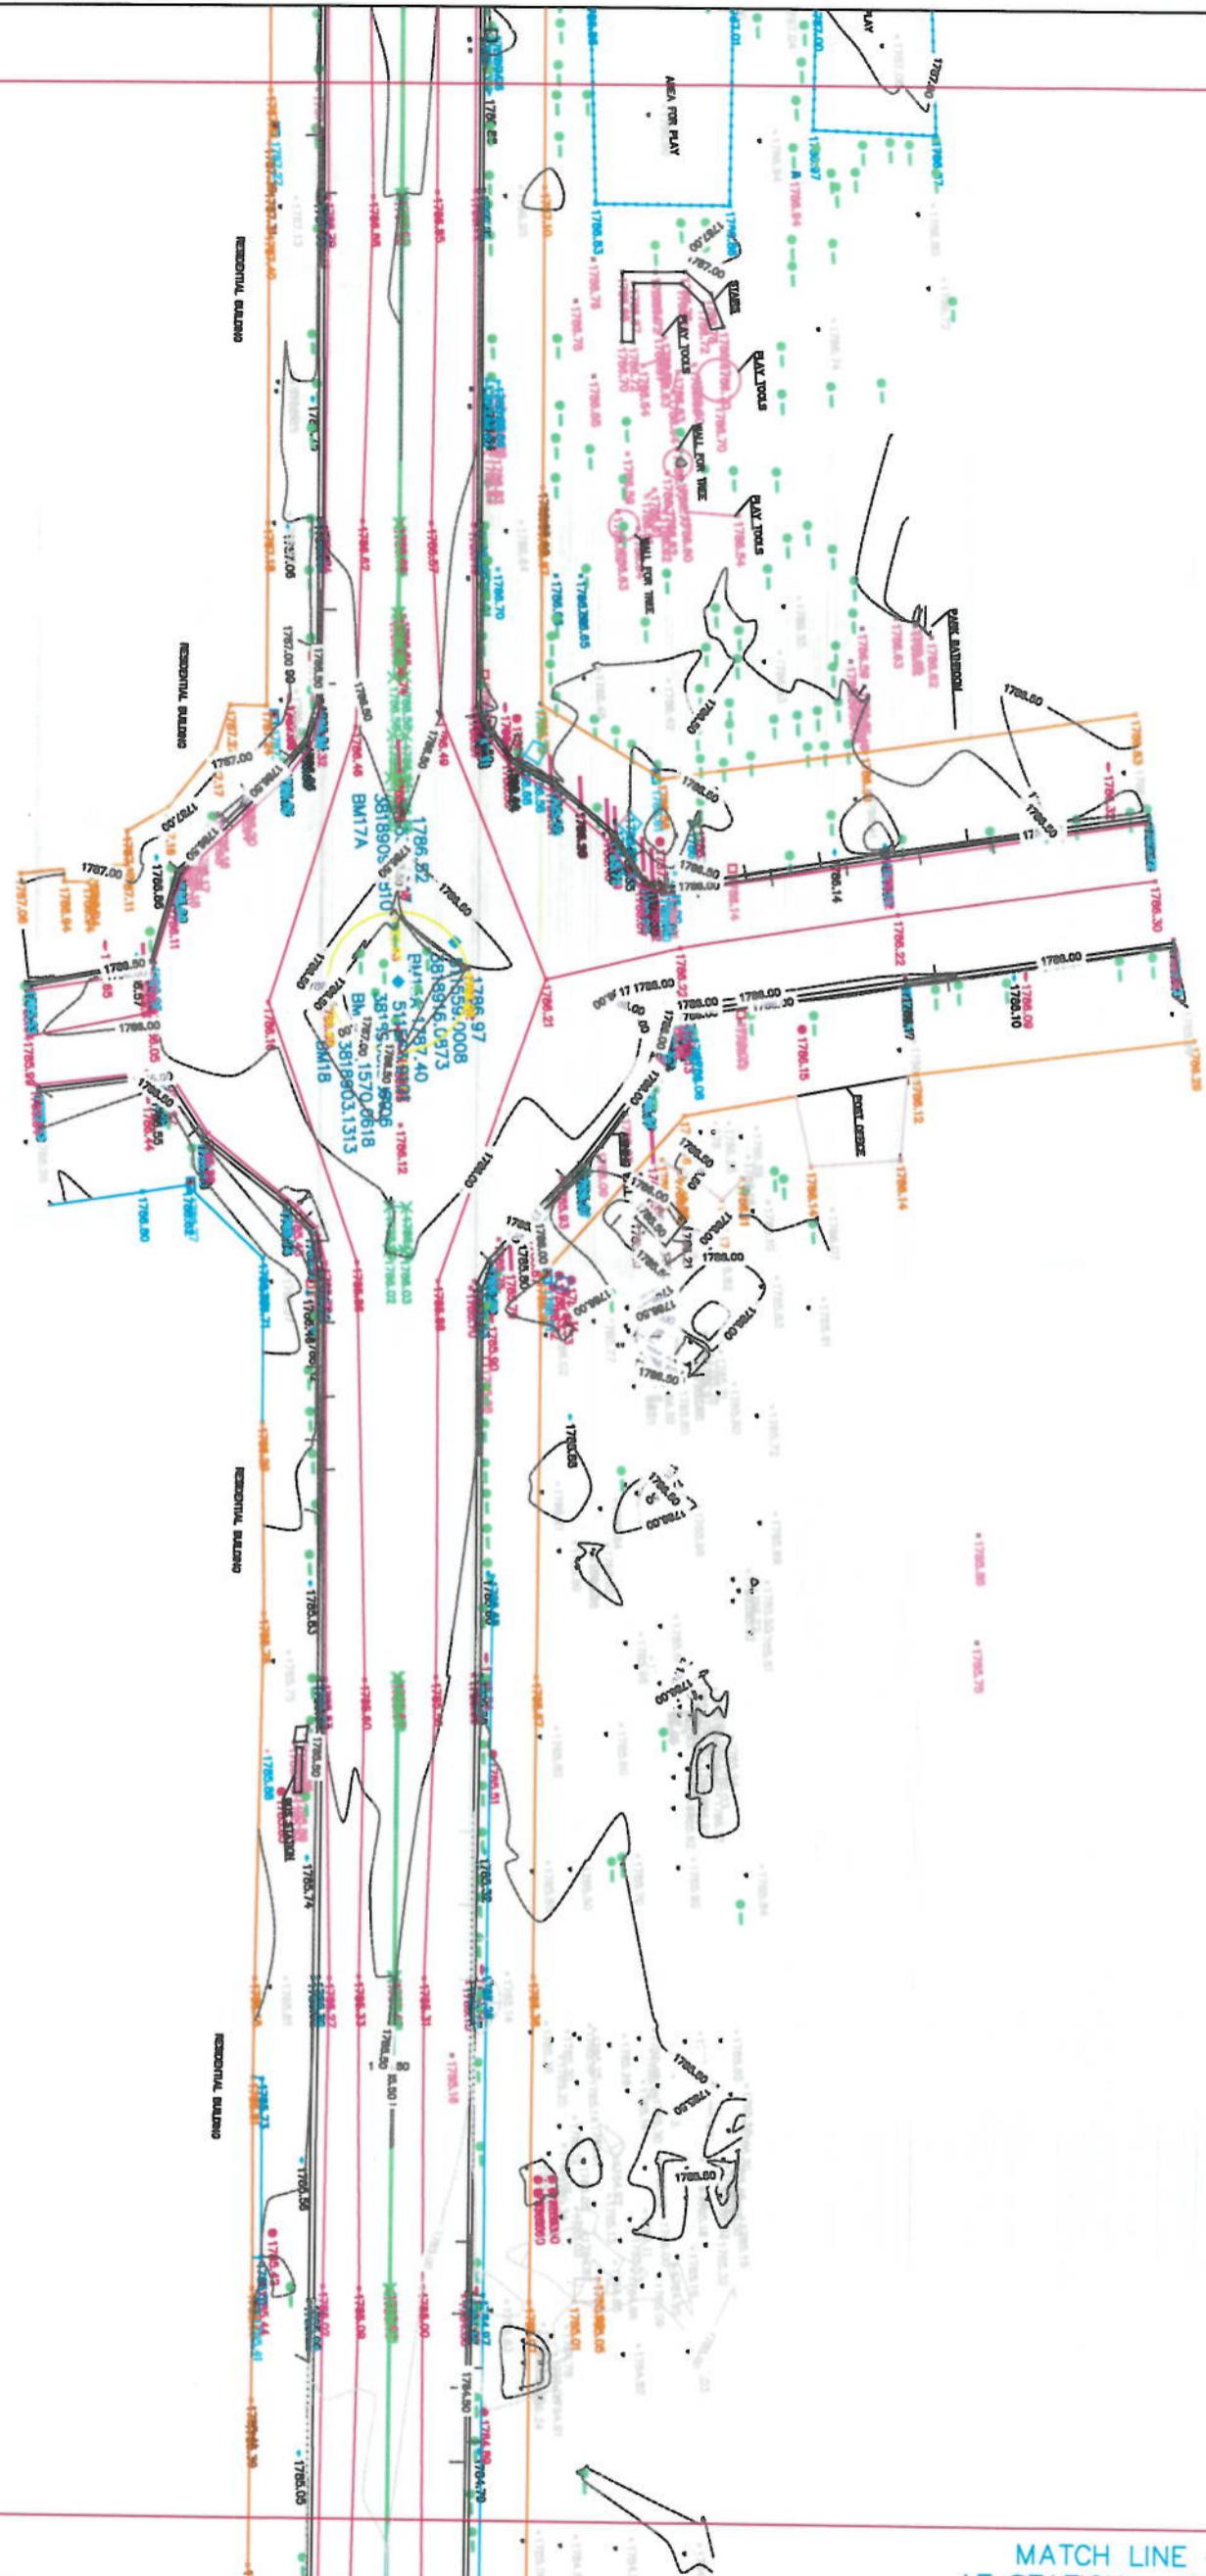

MATCH LINE - 3
AT STATION - 0+987.00

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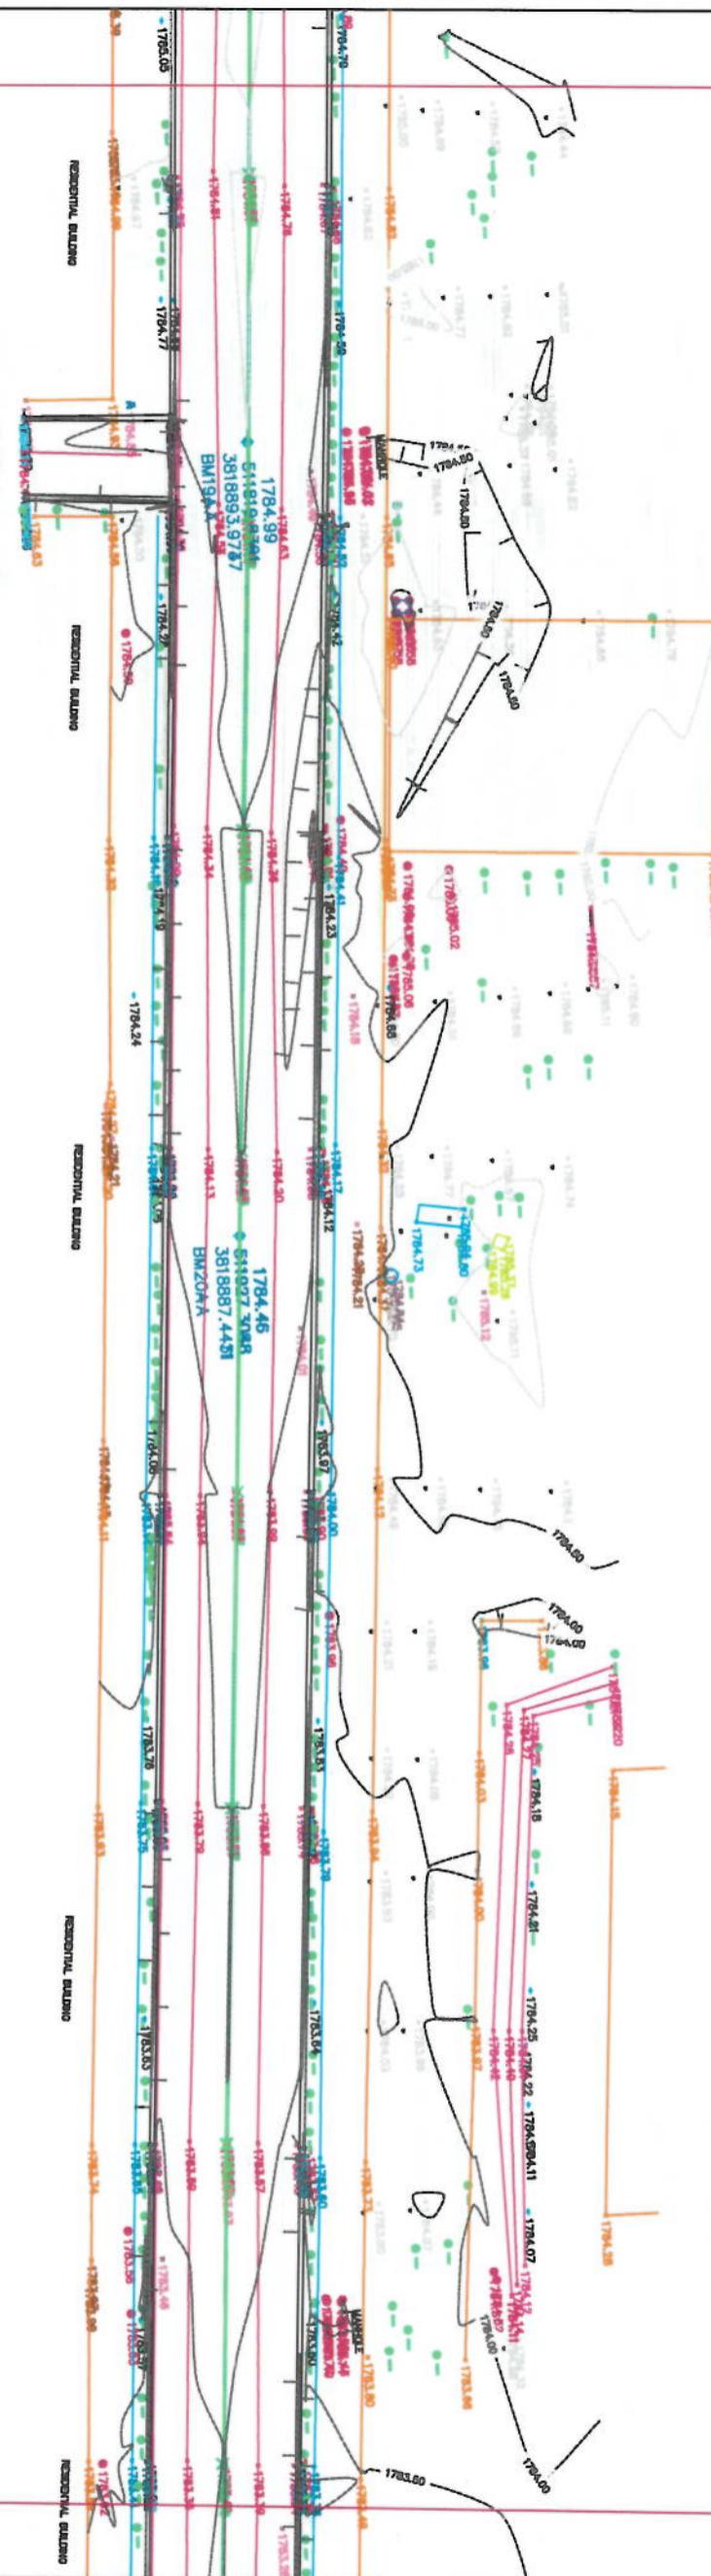
AFGHANISTAN
SURVEYED BY:
KABUL MUNICIPALITY
SURVEY TEAM

NOTE: (ALL DIMENSIONS ARE IN METERS UNLESS OTHERWISE INDICATED)	
LEGEND	
No. / Code / Detail	FIGURE
1. BL Building	
2. EH	
3. EW	
4. FW	
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592. II	

SURVEY FROM DAMAZANG SQUIRE
UP TO KOTASANGI BRIDGE

SURVEYED BY:	ENG. ABDULLAH ENG. ABDUL AHMAD
SURVEYED BY:	ENG. ABDUL AHMAD
SURVEYED BY:	ENG. HASBULLAH ENG. NAMATULAIH
HEAD OF SURVEY:	<u>ENG. SAYED ALI Q</u>
DATE:	<u>19/10/1999</u>
SCALE:	1:1000
STATUS:	TOPOGRAPHIC SURVEY
PROJECT CODE:	
DRAWING #:	3
REVISION:	

AT STATION - 0+987.00
PREVIOUS SHEET NUMBER - 3




MATCH LINE - 4
AT STATION - 1+316.00

**NOTE: ALL DIMENSIONS ARE IN METERS
UNLESS OTHERWISE INDICATED**

PROJECT NAME: SURVEY FROM DAMAZANG SQUARE UP TO KOTASANGI BRIDGE	
DRAWING TITLE: SURVEY FROM DAMAZANG SQUARE UP TO KOTASANGI BRIDGE	
SURVEYED BY: ENG. ABDILAH BEN SURVEYED BY: ENG. ABDILAH BEN SURVEYED BY: ENG. ABDILAH BEN HEAD OF SURVEY: ENG. SAYED ATIQ	SURVEYED BY: ENG. ABDILAH BEN SURVEYED BY: ENG. ABDILAH BEN SURVEYED BY: ENG. ABDILAH BEN DATE: SCALE: 1:1000
STATUS: TOPOGRAPHIC SURVEY	
PROJECT CODE:	
DRAWING #: 4	REVISE


AT STATION - 1+316.00
PREVIOUS SHEET NUMBER - 4

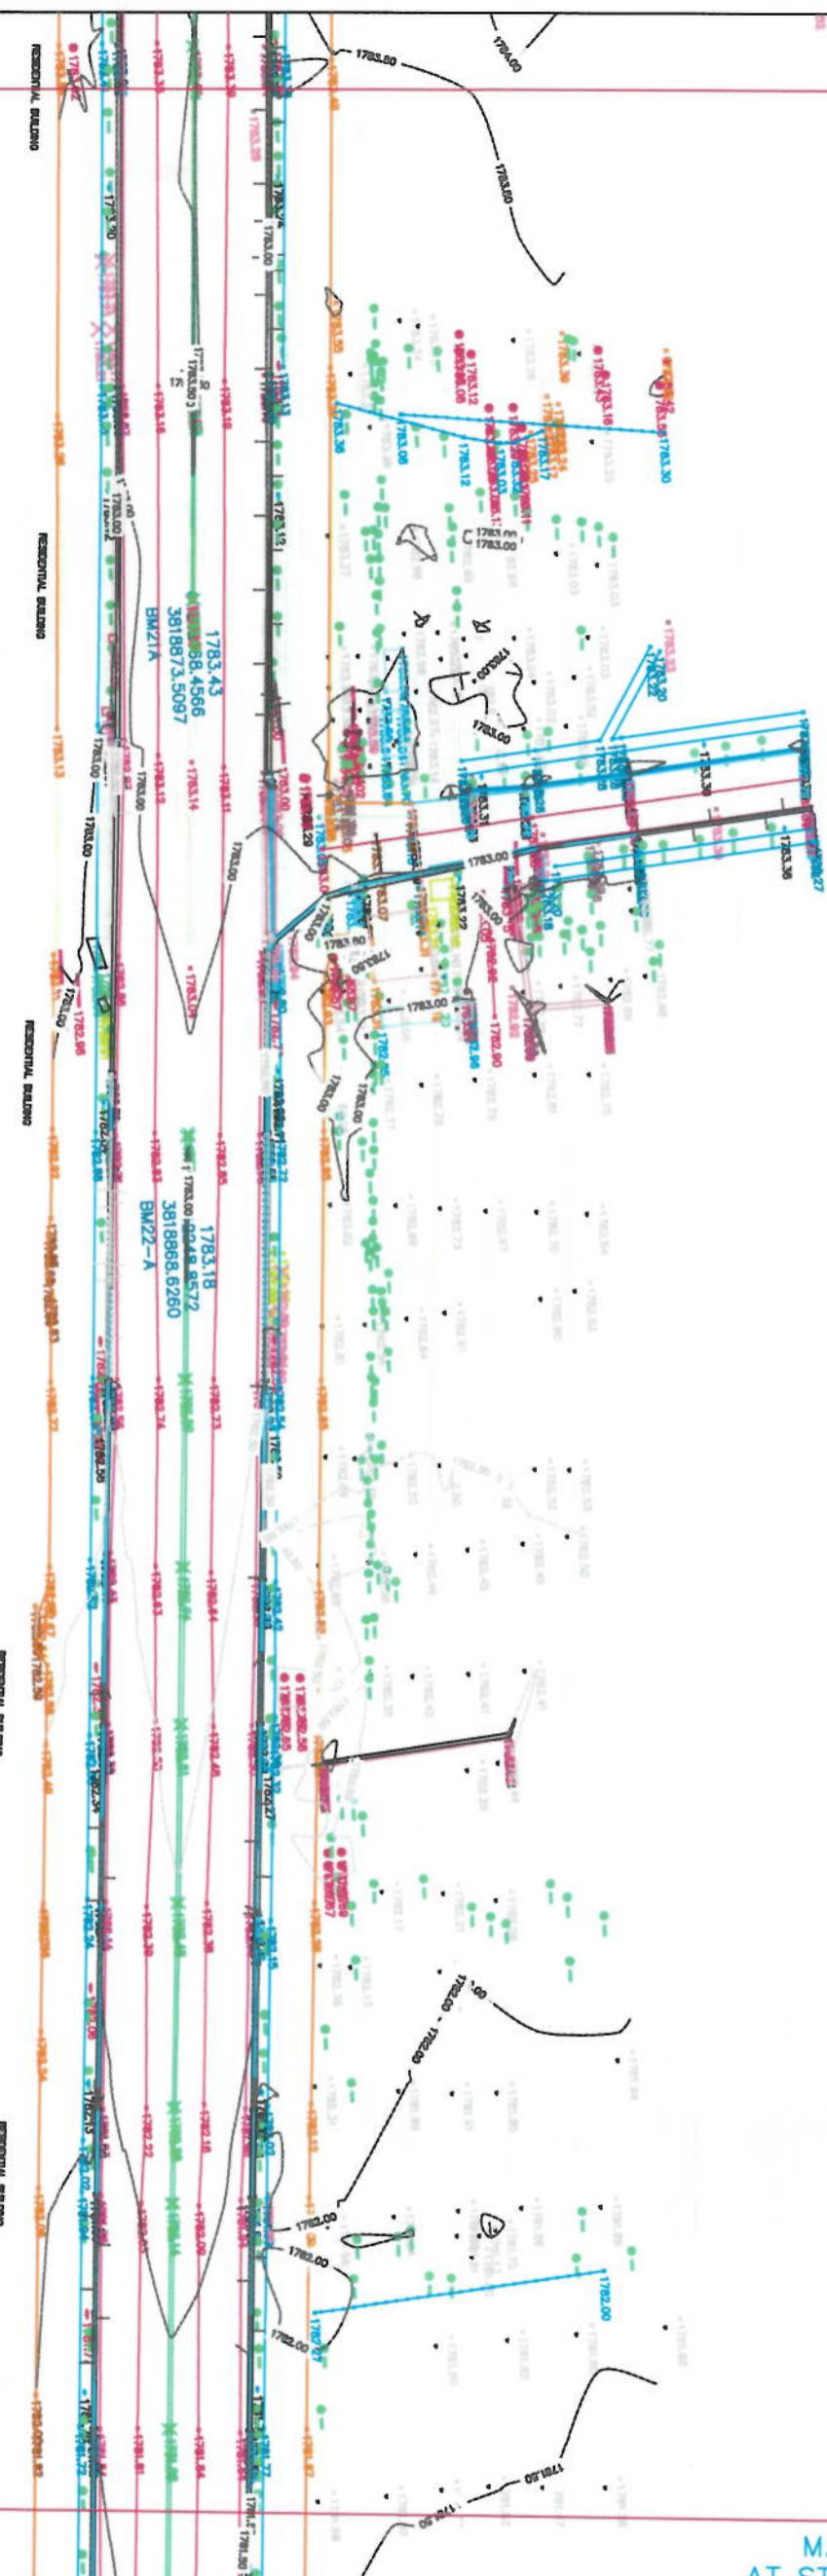

MATCH LINE - 5
AT STATION - 1+645.00

**NOTE: ALL DIMENSIONS ARE IN METERS
UNLESS OTHERWISE INDICATED**

AT STATION - 1+645.00
PREVIOUS SHEET NUMBER - 5

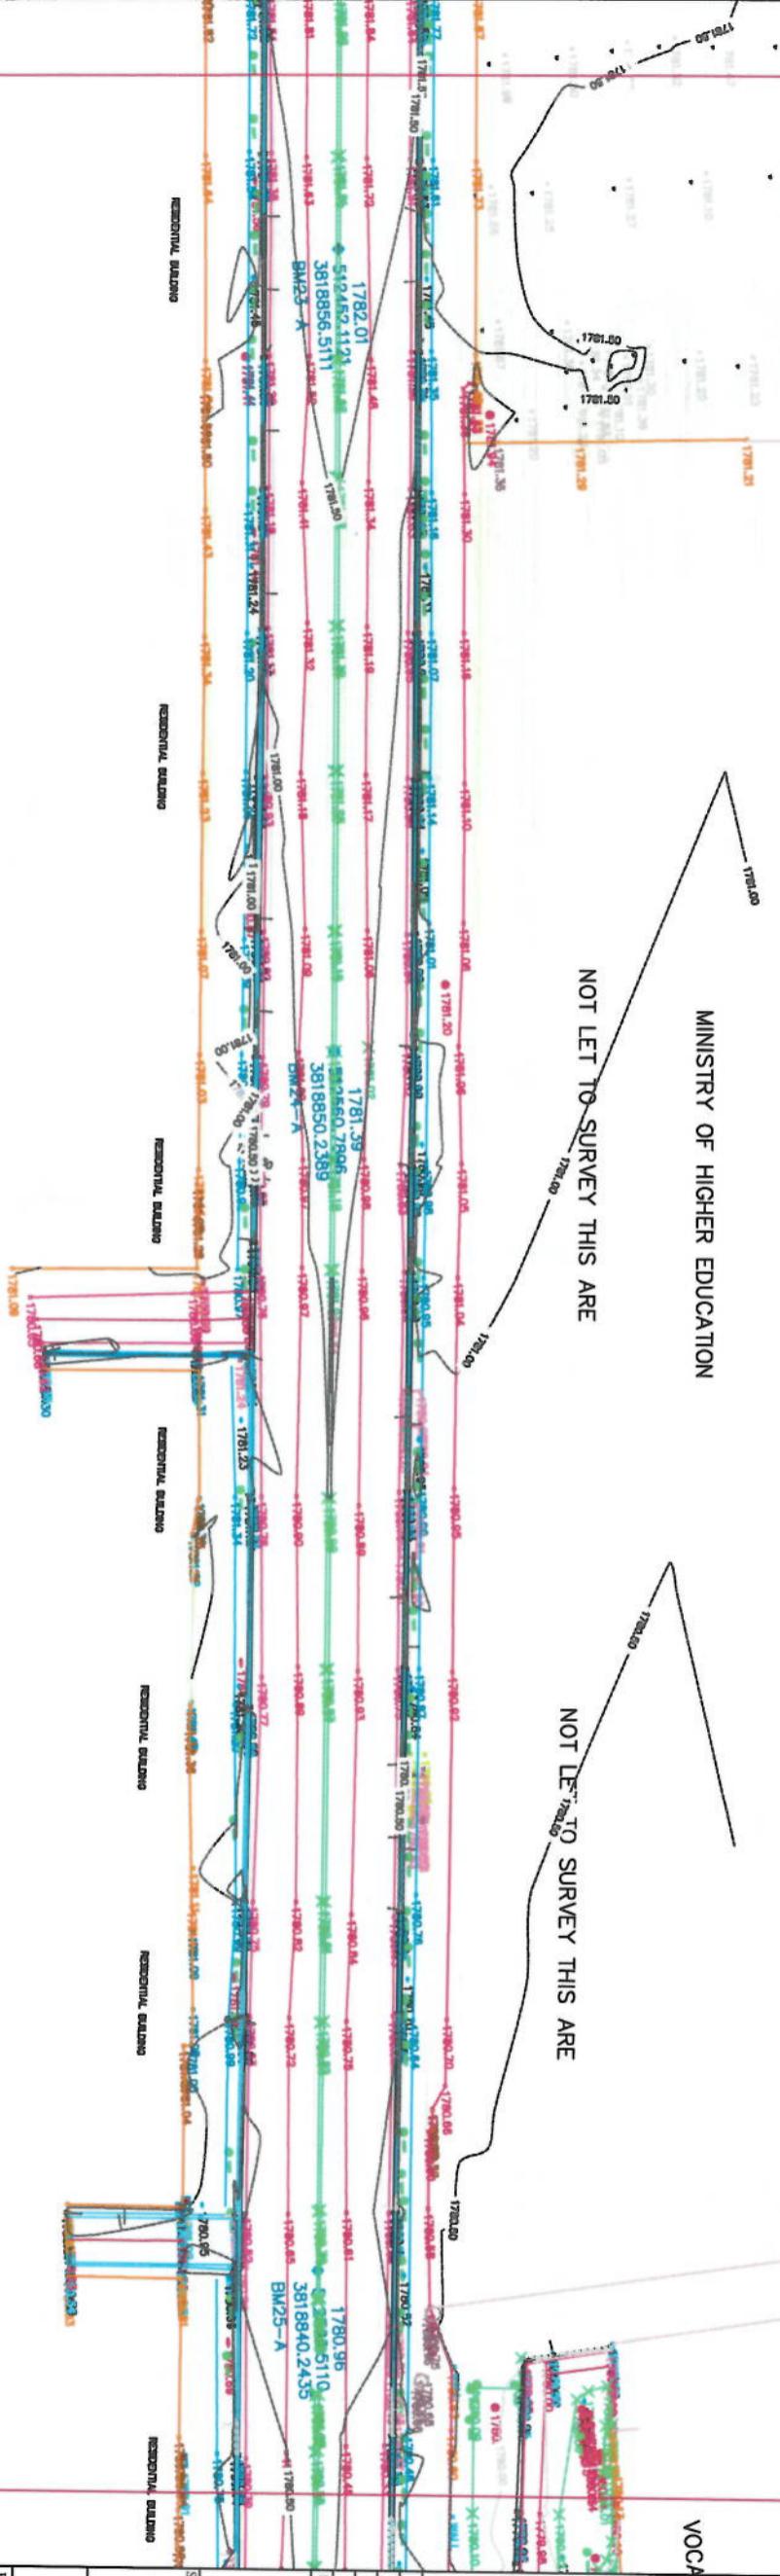


MATCH LINE - 6
AT STATION - 1+974.00

NOTE: ALL DIMENSIONS ARE IN METERS
UNLESS OTHERWISE INDICATED

LEGEND FIGURE

1	Building
2	Road
3	Water
4	Water Pipe
5	Tree
6	Bushes
7	Other Line
8	Curve
9	Point
10	Area
11	Line
12	Area
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AT STATION - 1+974.00
PREVIOUS SHEET NUMBER - 6

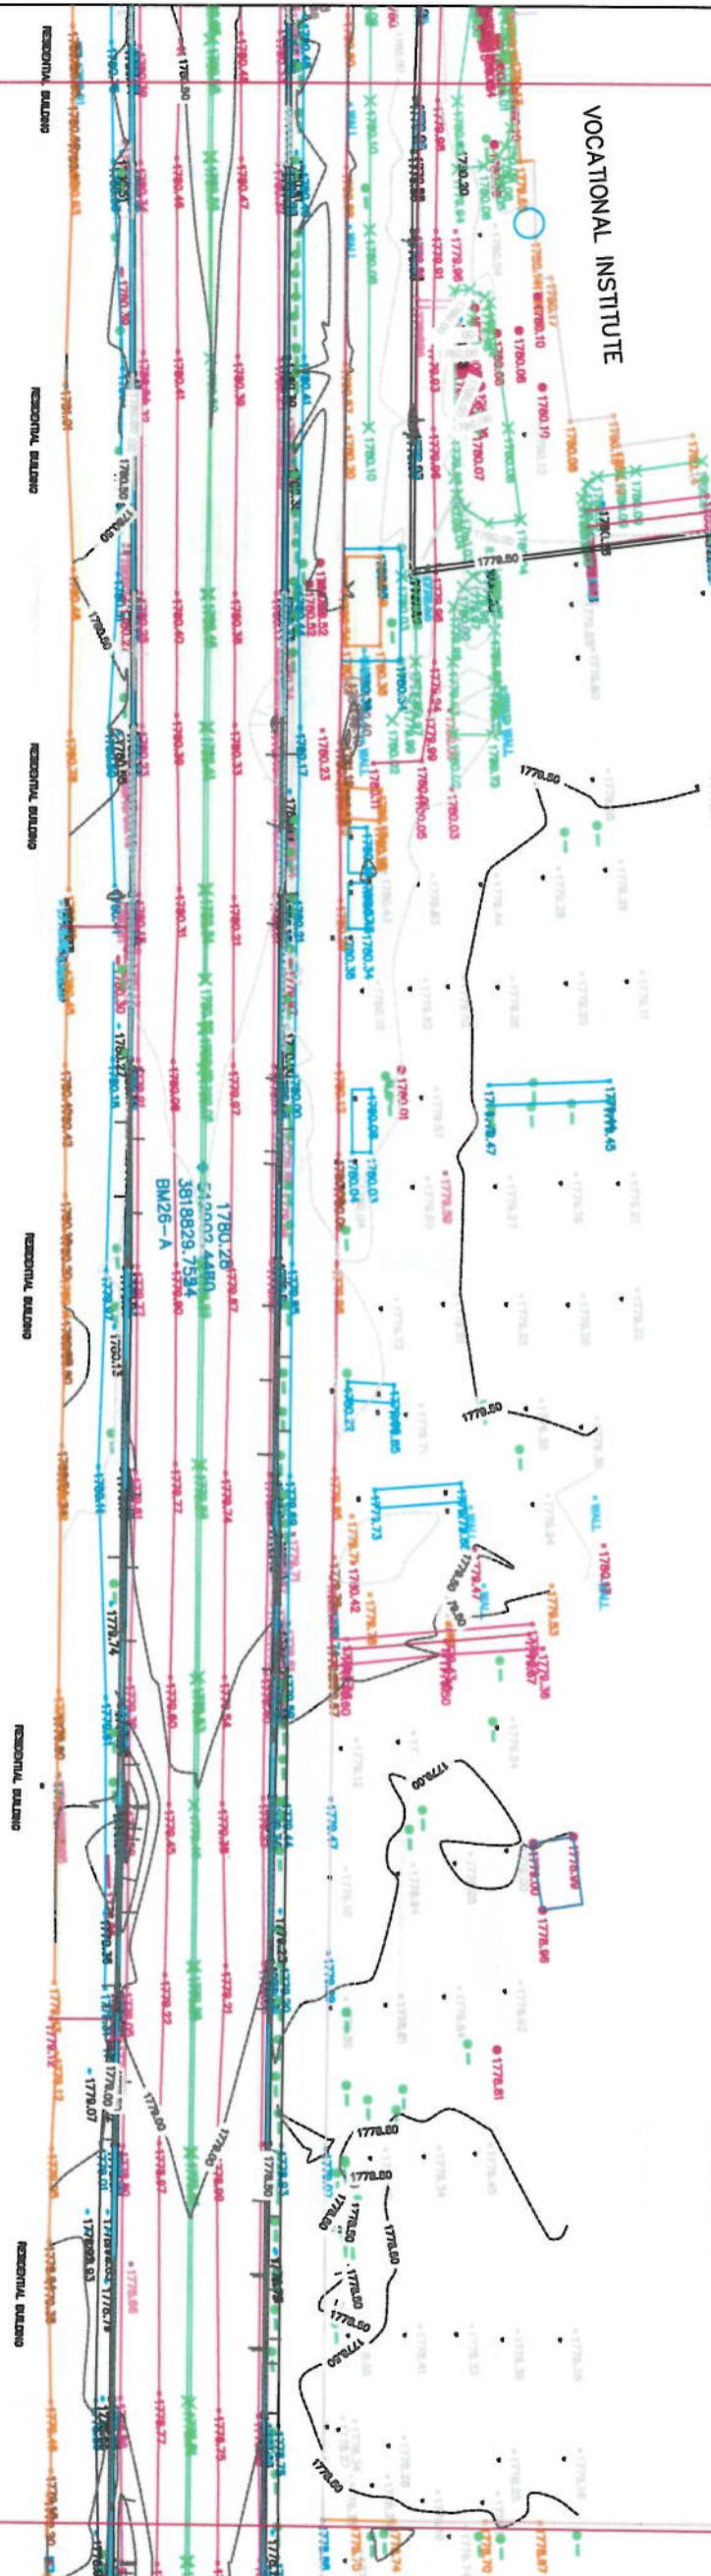

MATCH LINE - 7
AT STATION - 2+303.00

**NOTE: 1. ALL DIMENSIONS ARE IN METERS
UNLESS OTHERWISE INDICATED**

DRAWING TITLE:
SURVEY FROM DAMAZANG SQUIRE
UP TO KOTASANGI BRIDGE

AFGHANISTAN
SURVEYED BY:
**KABUL MUNICIPALITY
SURVEY TEAM**

DRAWING #:		7	
STATUS:		TOPOGRAPHIC SURVEY	
PROJECT CODE:			
DATE:		SCALE: 1:1000	
HEAD OF SURVEY: ENG. SAWID ATIQ		SURVEYED BY: ENG. ABDULLAH ENG. MAHMUD JAMSHID ENG. GABRIEL AMBAS	
SURVEYED BY: ENG. HASSIBULI ENG. HASBULIAH		SURVEYED BY: ENG. ARKADEN	

AT STATION - 2+303.00
PREVIOUS SHEET NUMBER - 7

GHAZI HIGH SCHOOL

MATCH LINE - 8
AT STATION - 2+632.00

NOTE: ALL DIMENSIONS ARE IN METERS
UNLESS OTHERWISE INDICATED

LEGEND

TO CONVENTIONAL FIGURE

T-BL Building

T-RO Road

W-Wall

C-Corner

P-Pipe

L-Lot

U-Unclassified

S-Site

E-Electrical

W-Water

SE-Sewer

SO-Sanitary

ED-Drainage

BL-Bonus Length


CL-Close Line

CC-Close Curve

CR-Close Right

CL-Close Left

AT STATION - 2+632.00
PREVIOUS SHEET NUMBER - 8

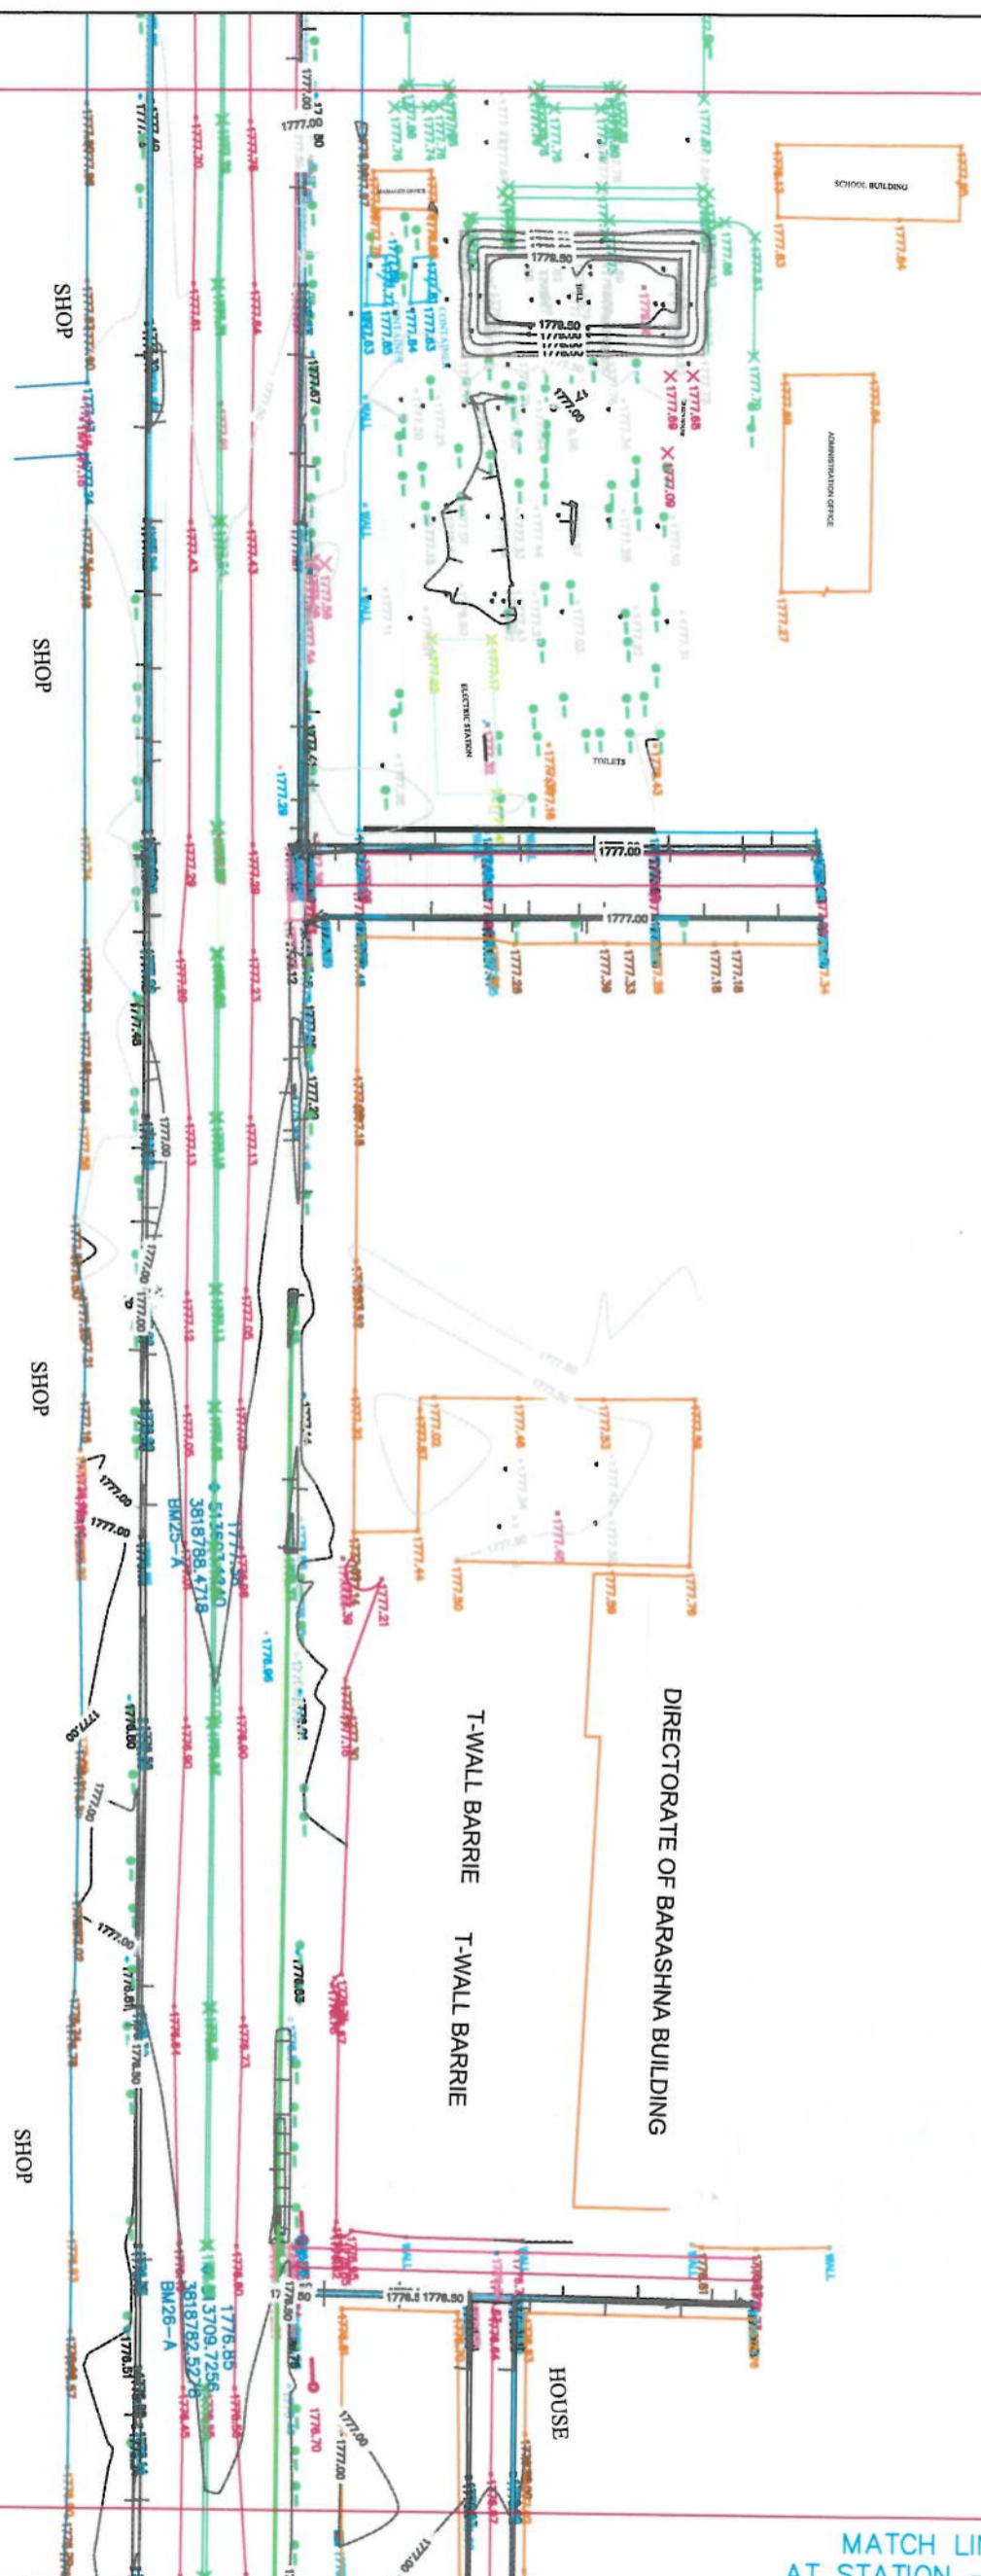

MATCH LINE - 9
AT STATION - 2+961.00


**NOTE: ALL DIMENSIONS ARE IN METERS
UNLESS OTHERWISE INDICATED**




PROJECT NAME: SURVEY FROM DAMAZANG SQUIRE UP TO KOTASANGI BRIDGE	
DRAWING TITLE: SURVEY FROM DAMAZANG SQUIRE UP TO KOTASANGI BRIDGE	
SURVEYED BY: ENG ABDULLAH	SURVEYED BY: ENG ABDULLAH
SURVEYED BY: ENG ABDULLAH	SURVEYED BY: ENG ABDULLAH
SURVEYED BY: ENG ABDULLAH	SURVEYED BY: ENG ABDULLAH
HEAD OF SURVEY: ENG SAYED ATIQ	HEAD OF SURVEY: ENG SAYED ATIQ
DATE:	SCALE: 1:1000
STATUS: TOPOGRAPHIC SURVEY	
PROJECT CODE:	
DRAWING #: 9	REV. NO.:


	SURVEYED BY: KABUL MUNICIPALITY SURVEY TEAM <small>REPUBLIC OF AFGHANISTAN</small>
---	---

AT STATION - 2+961.00
PREVIOUS SHEET NUMBER - 9

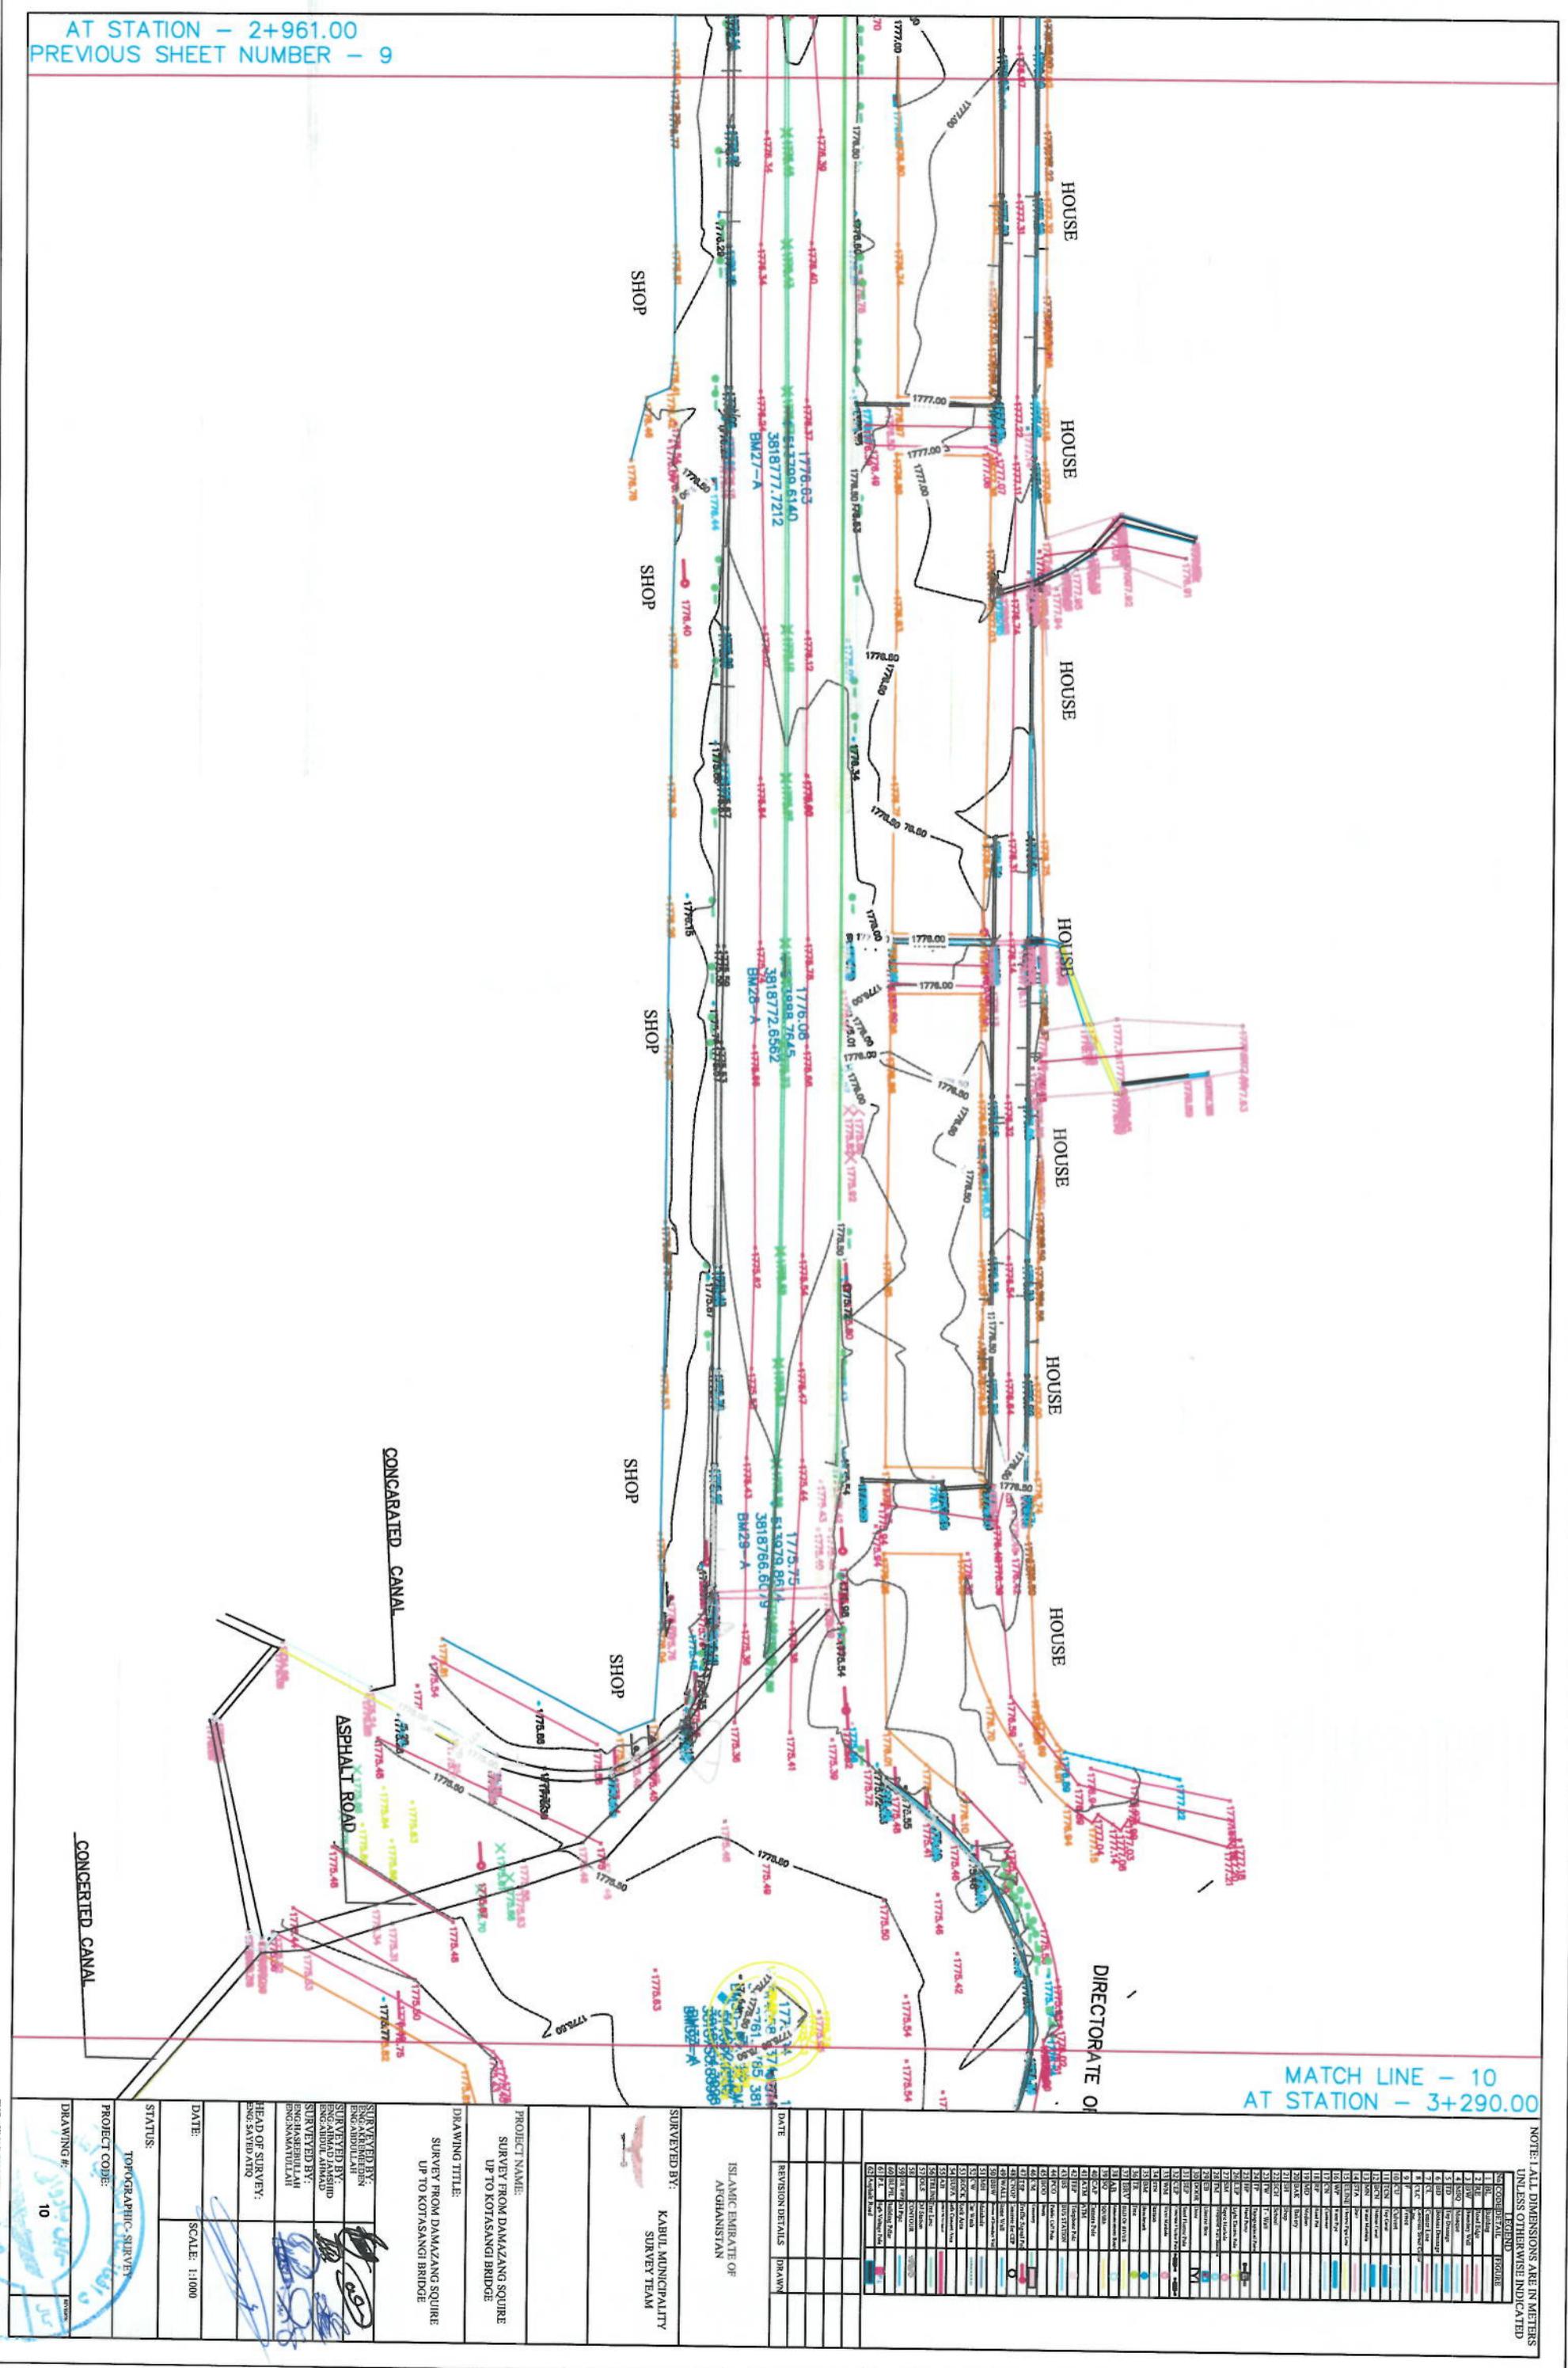

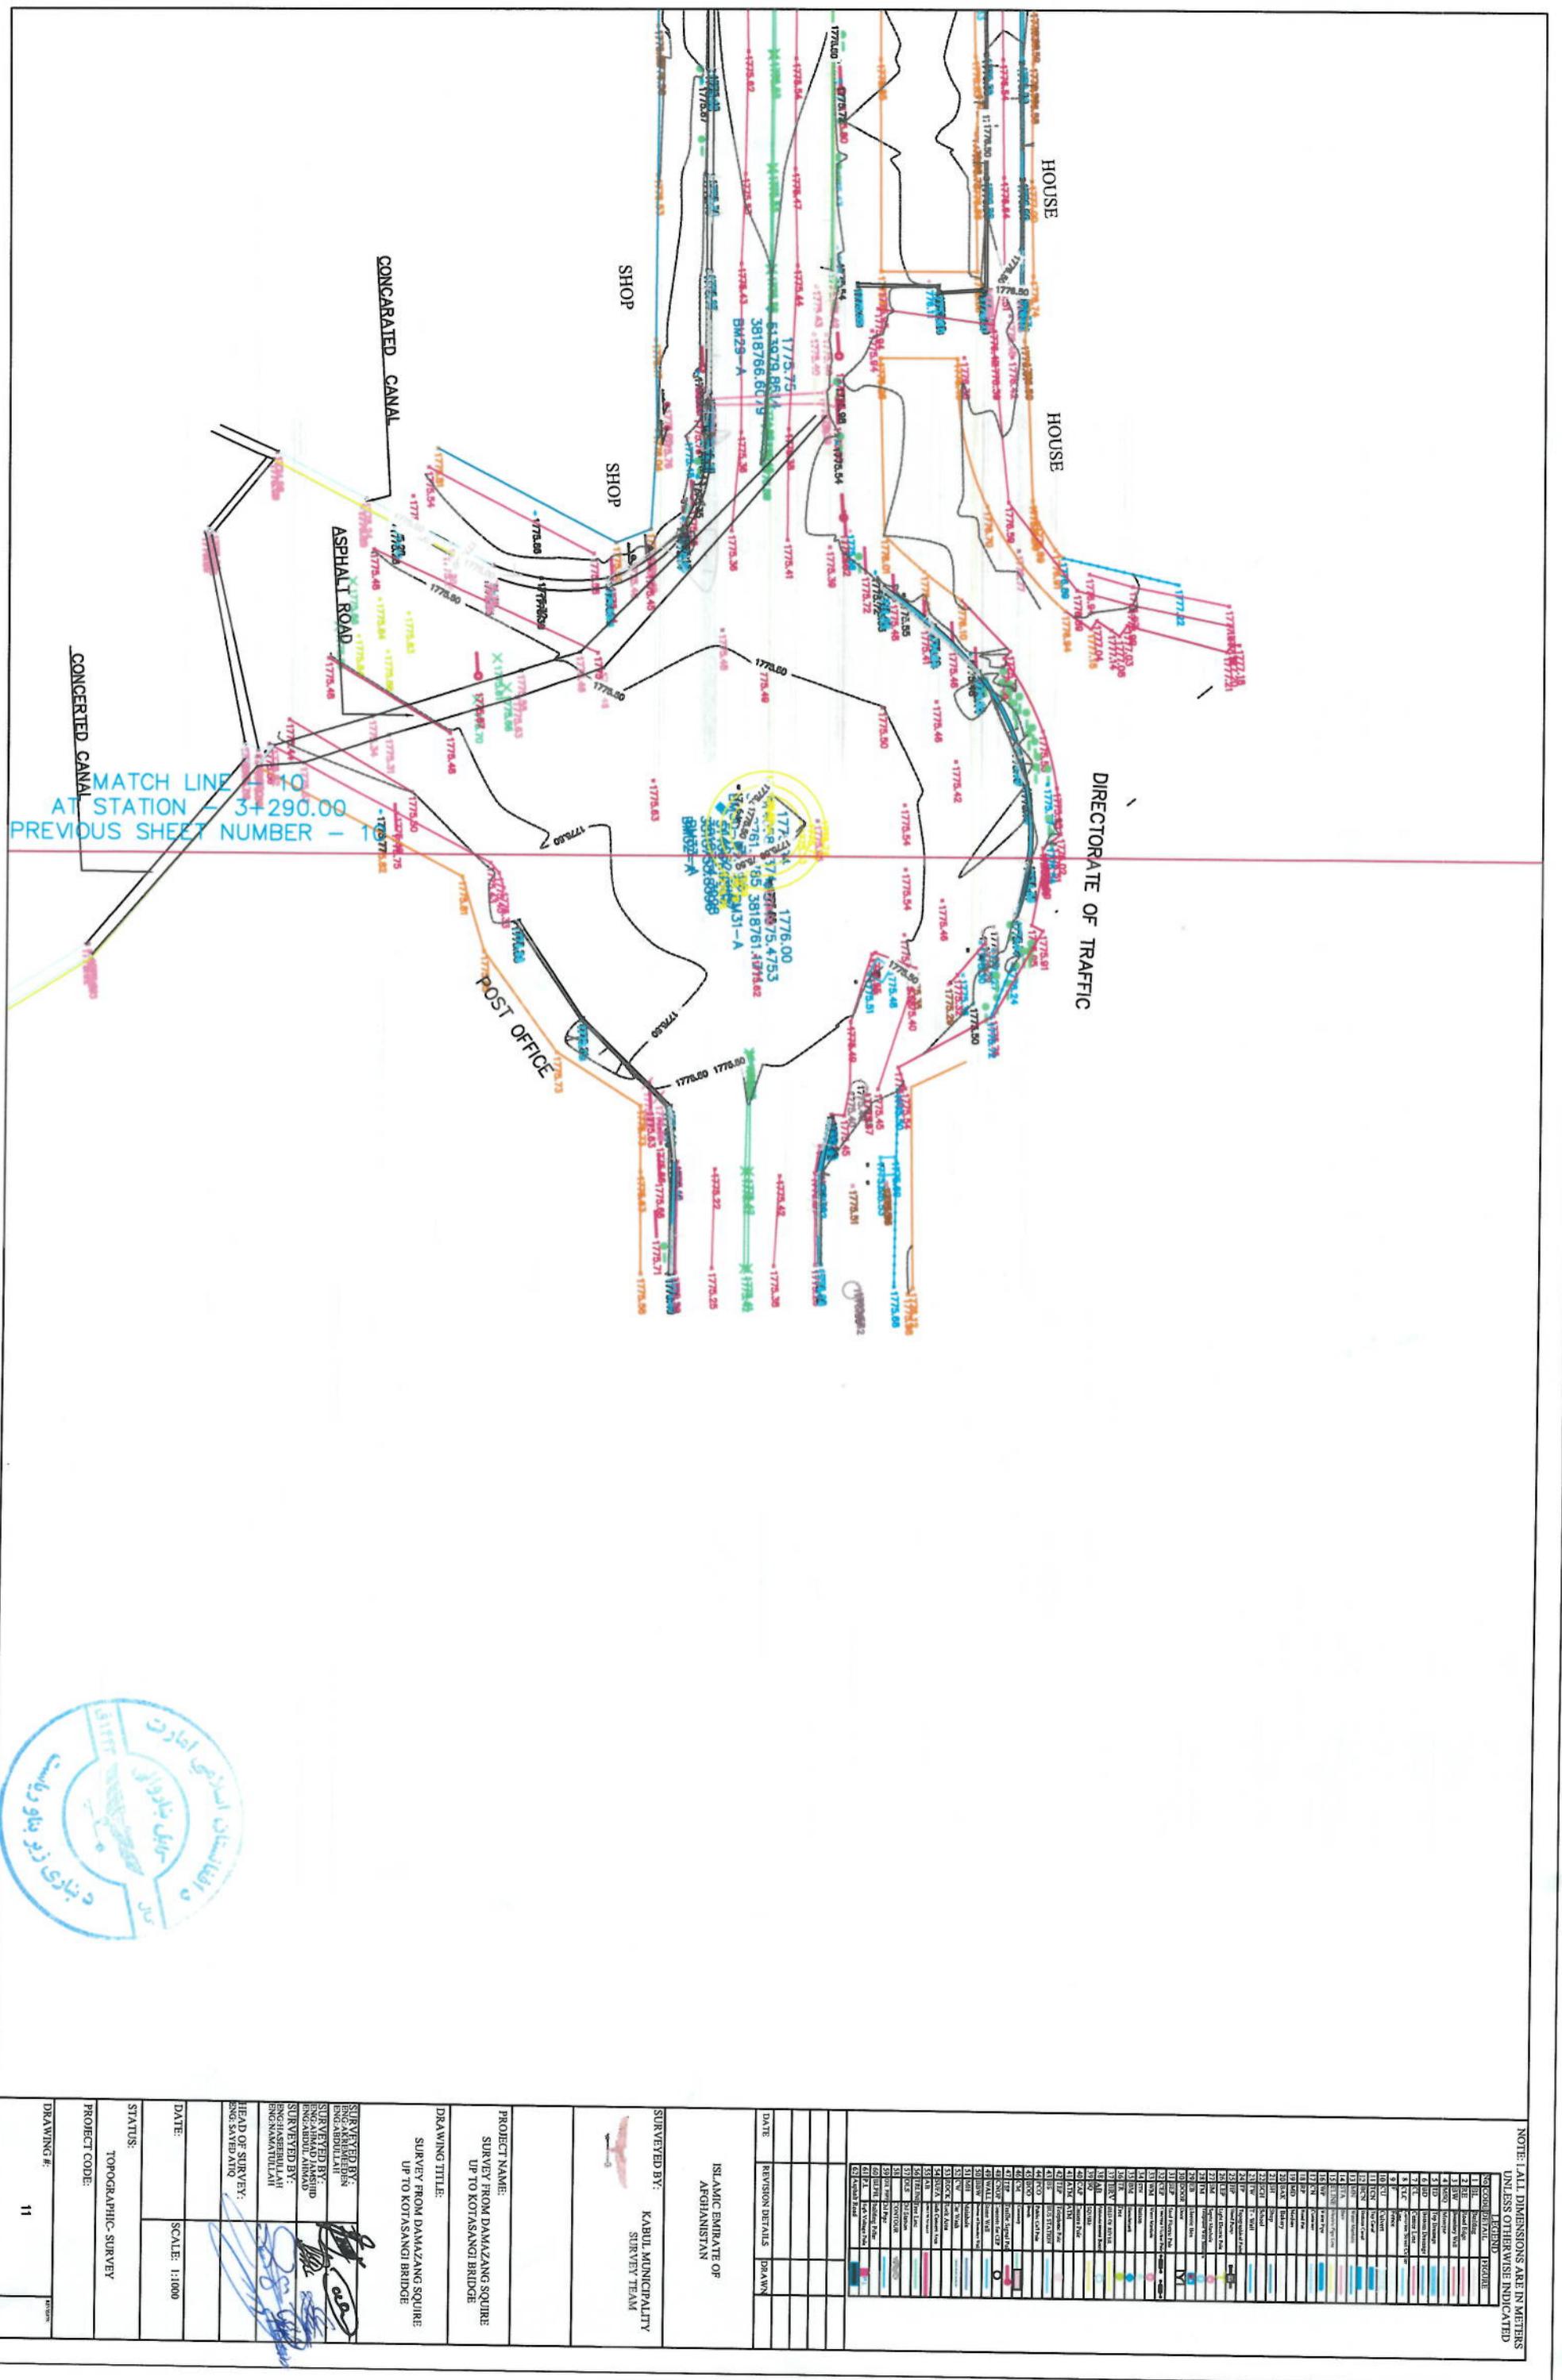

NOTE: ALL DIMENSIONS ARE IN METERS

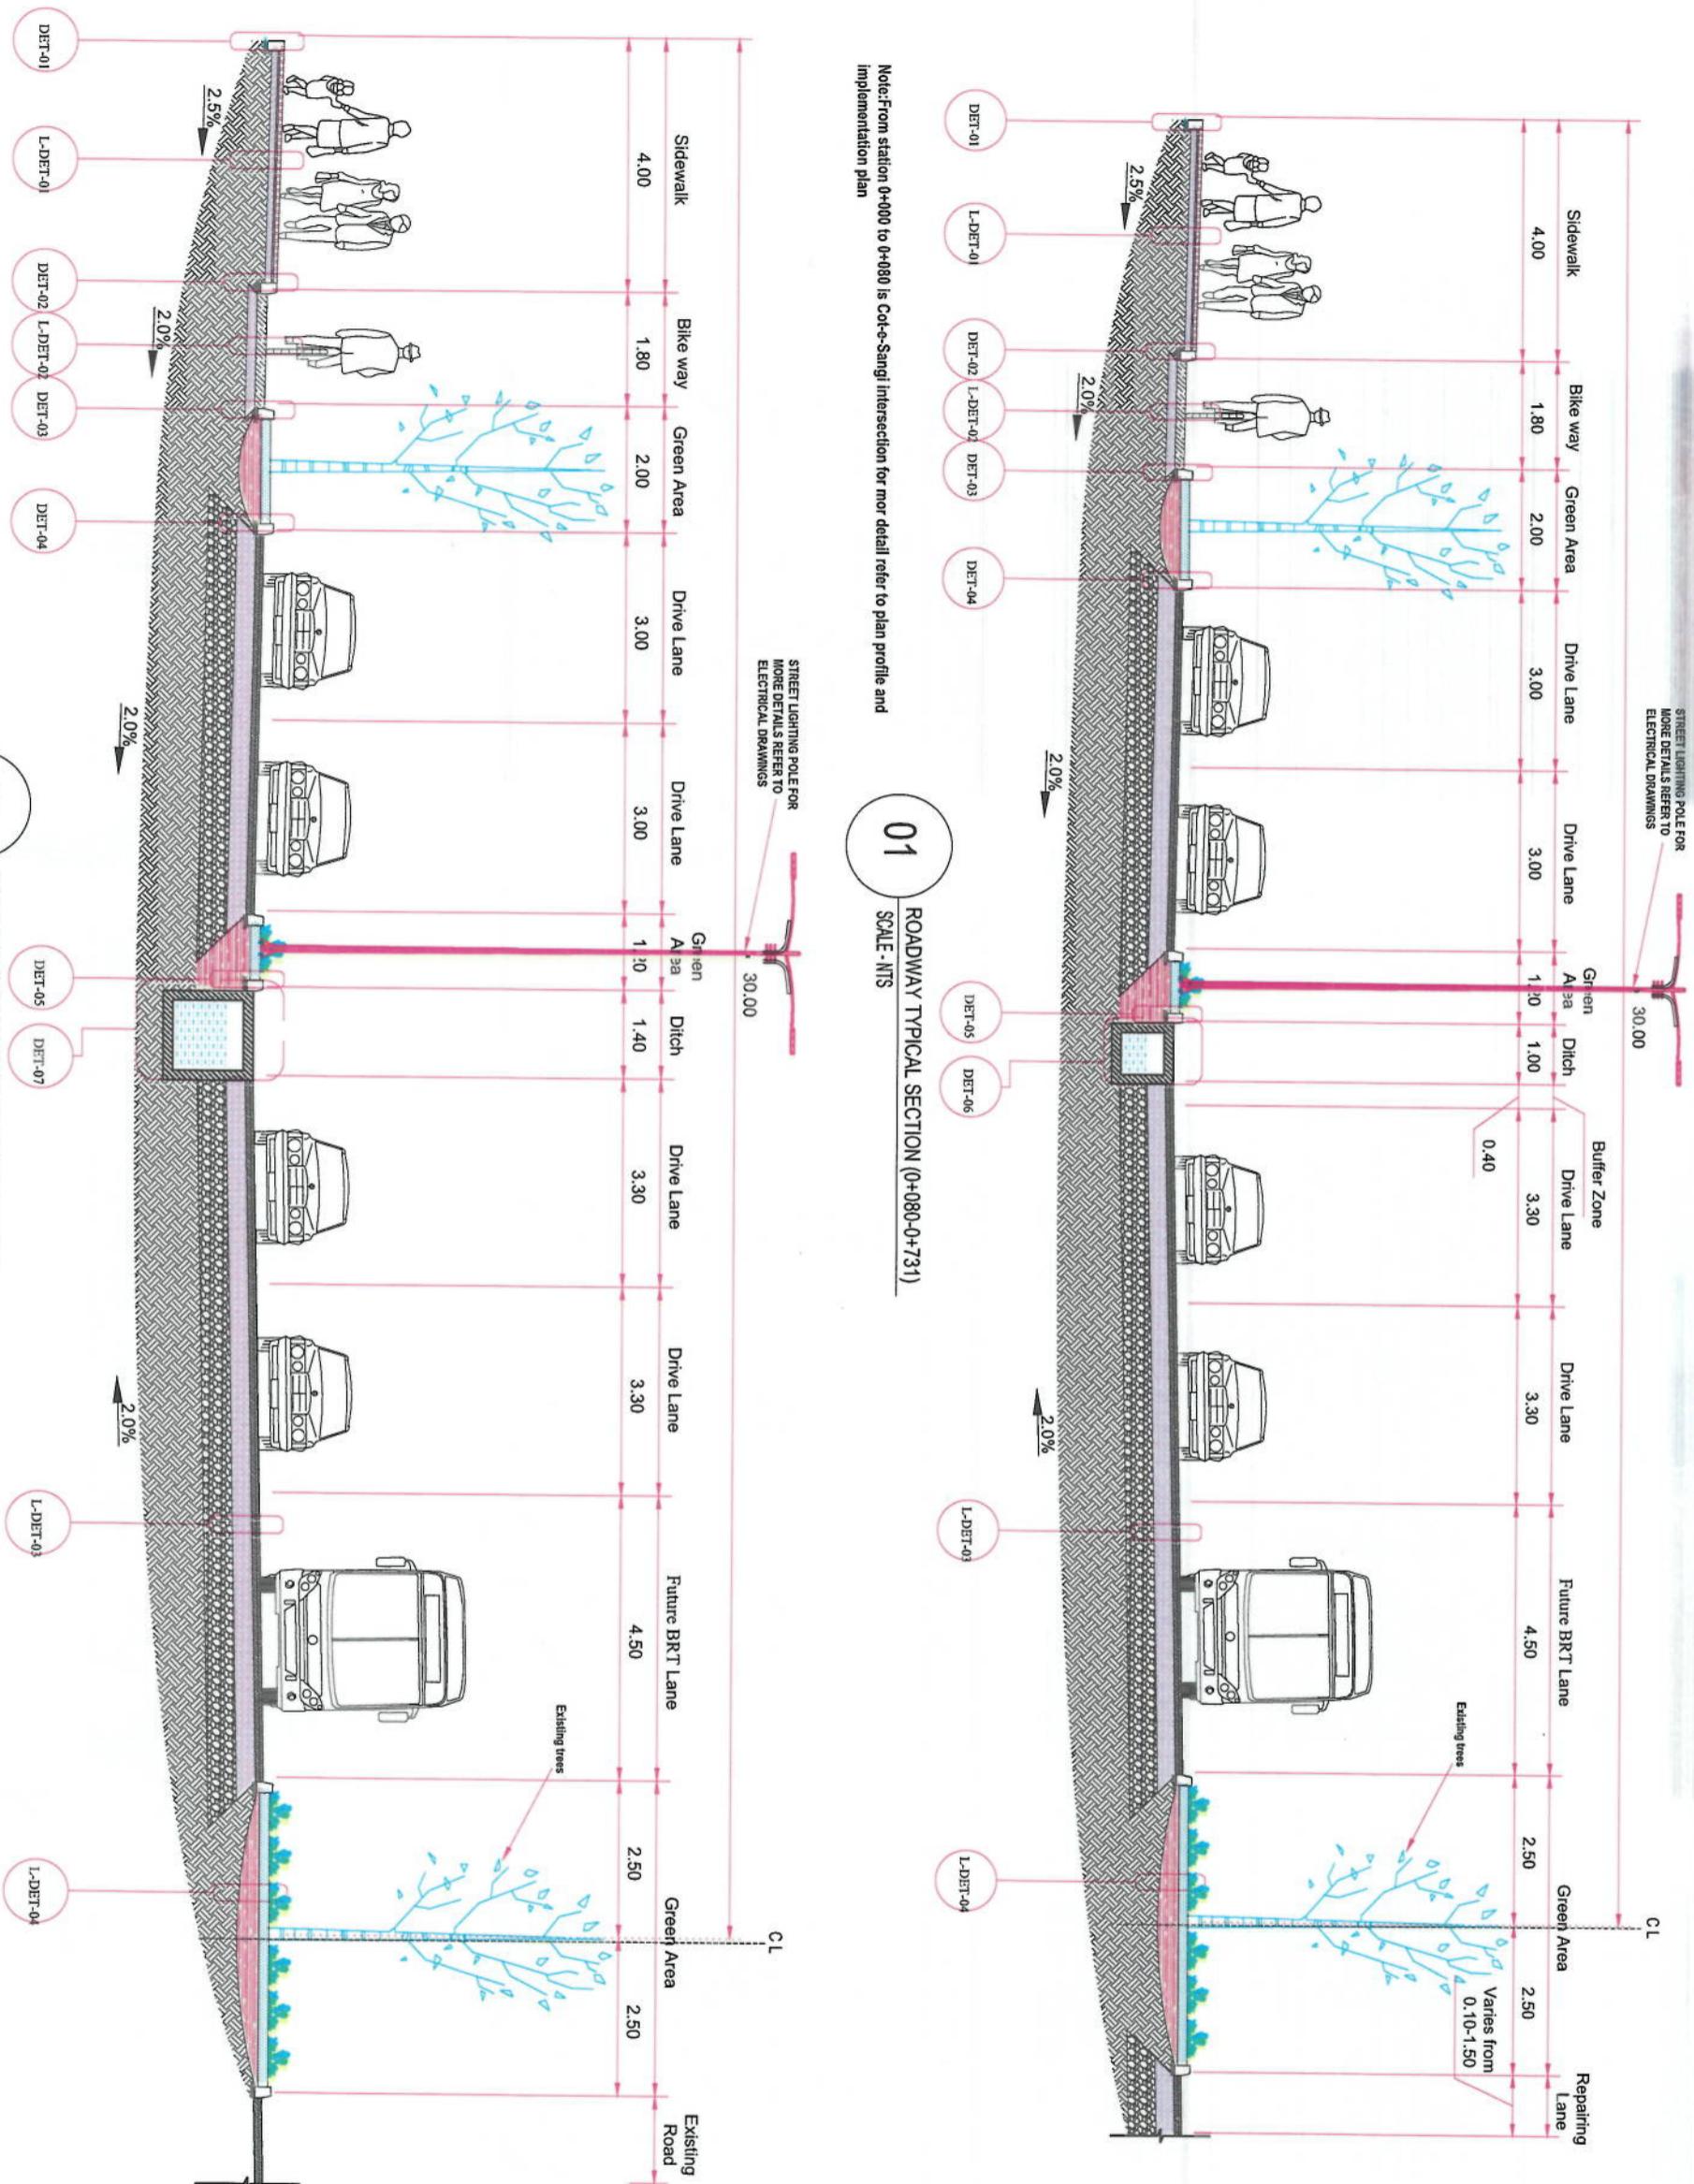

NOTE:

Afghanistan

DESIGN TEAM

Project Name:

Drawing Title:

卷之三

100

Menhajul Rahman

Mohammed Essa Sirat
Signature

Hasbulah Shalizi
Signature

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100

06-06-2023 1:200


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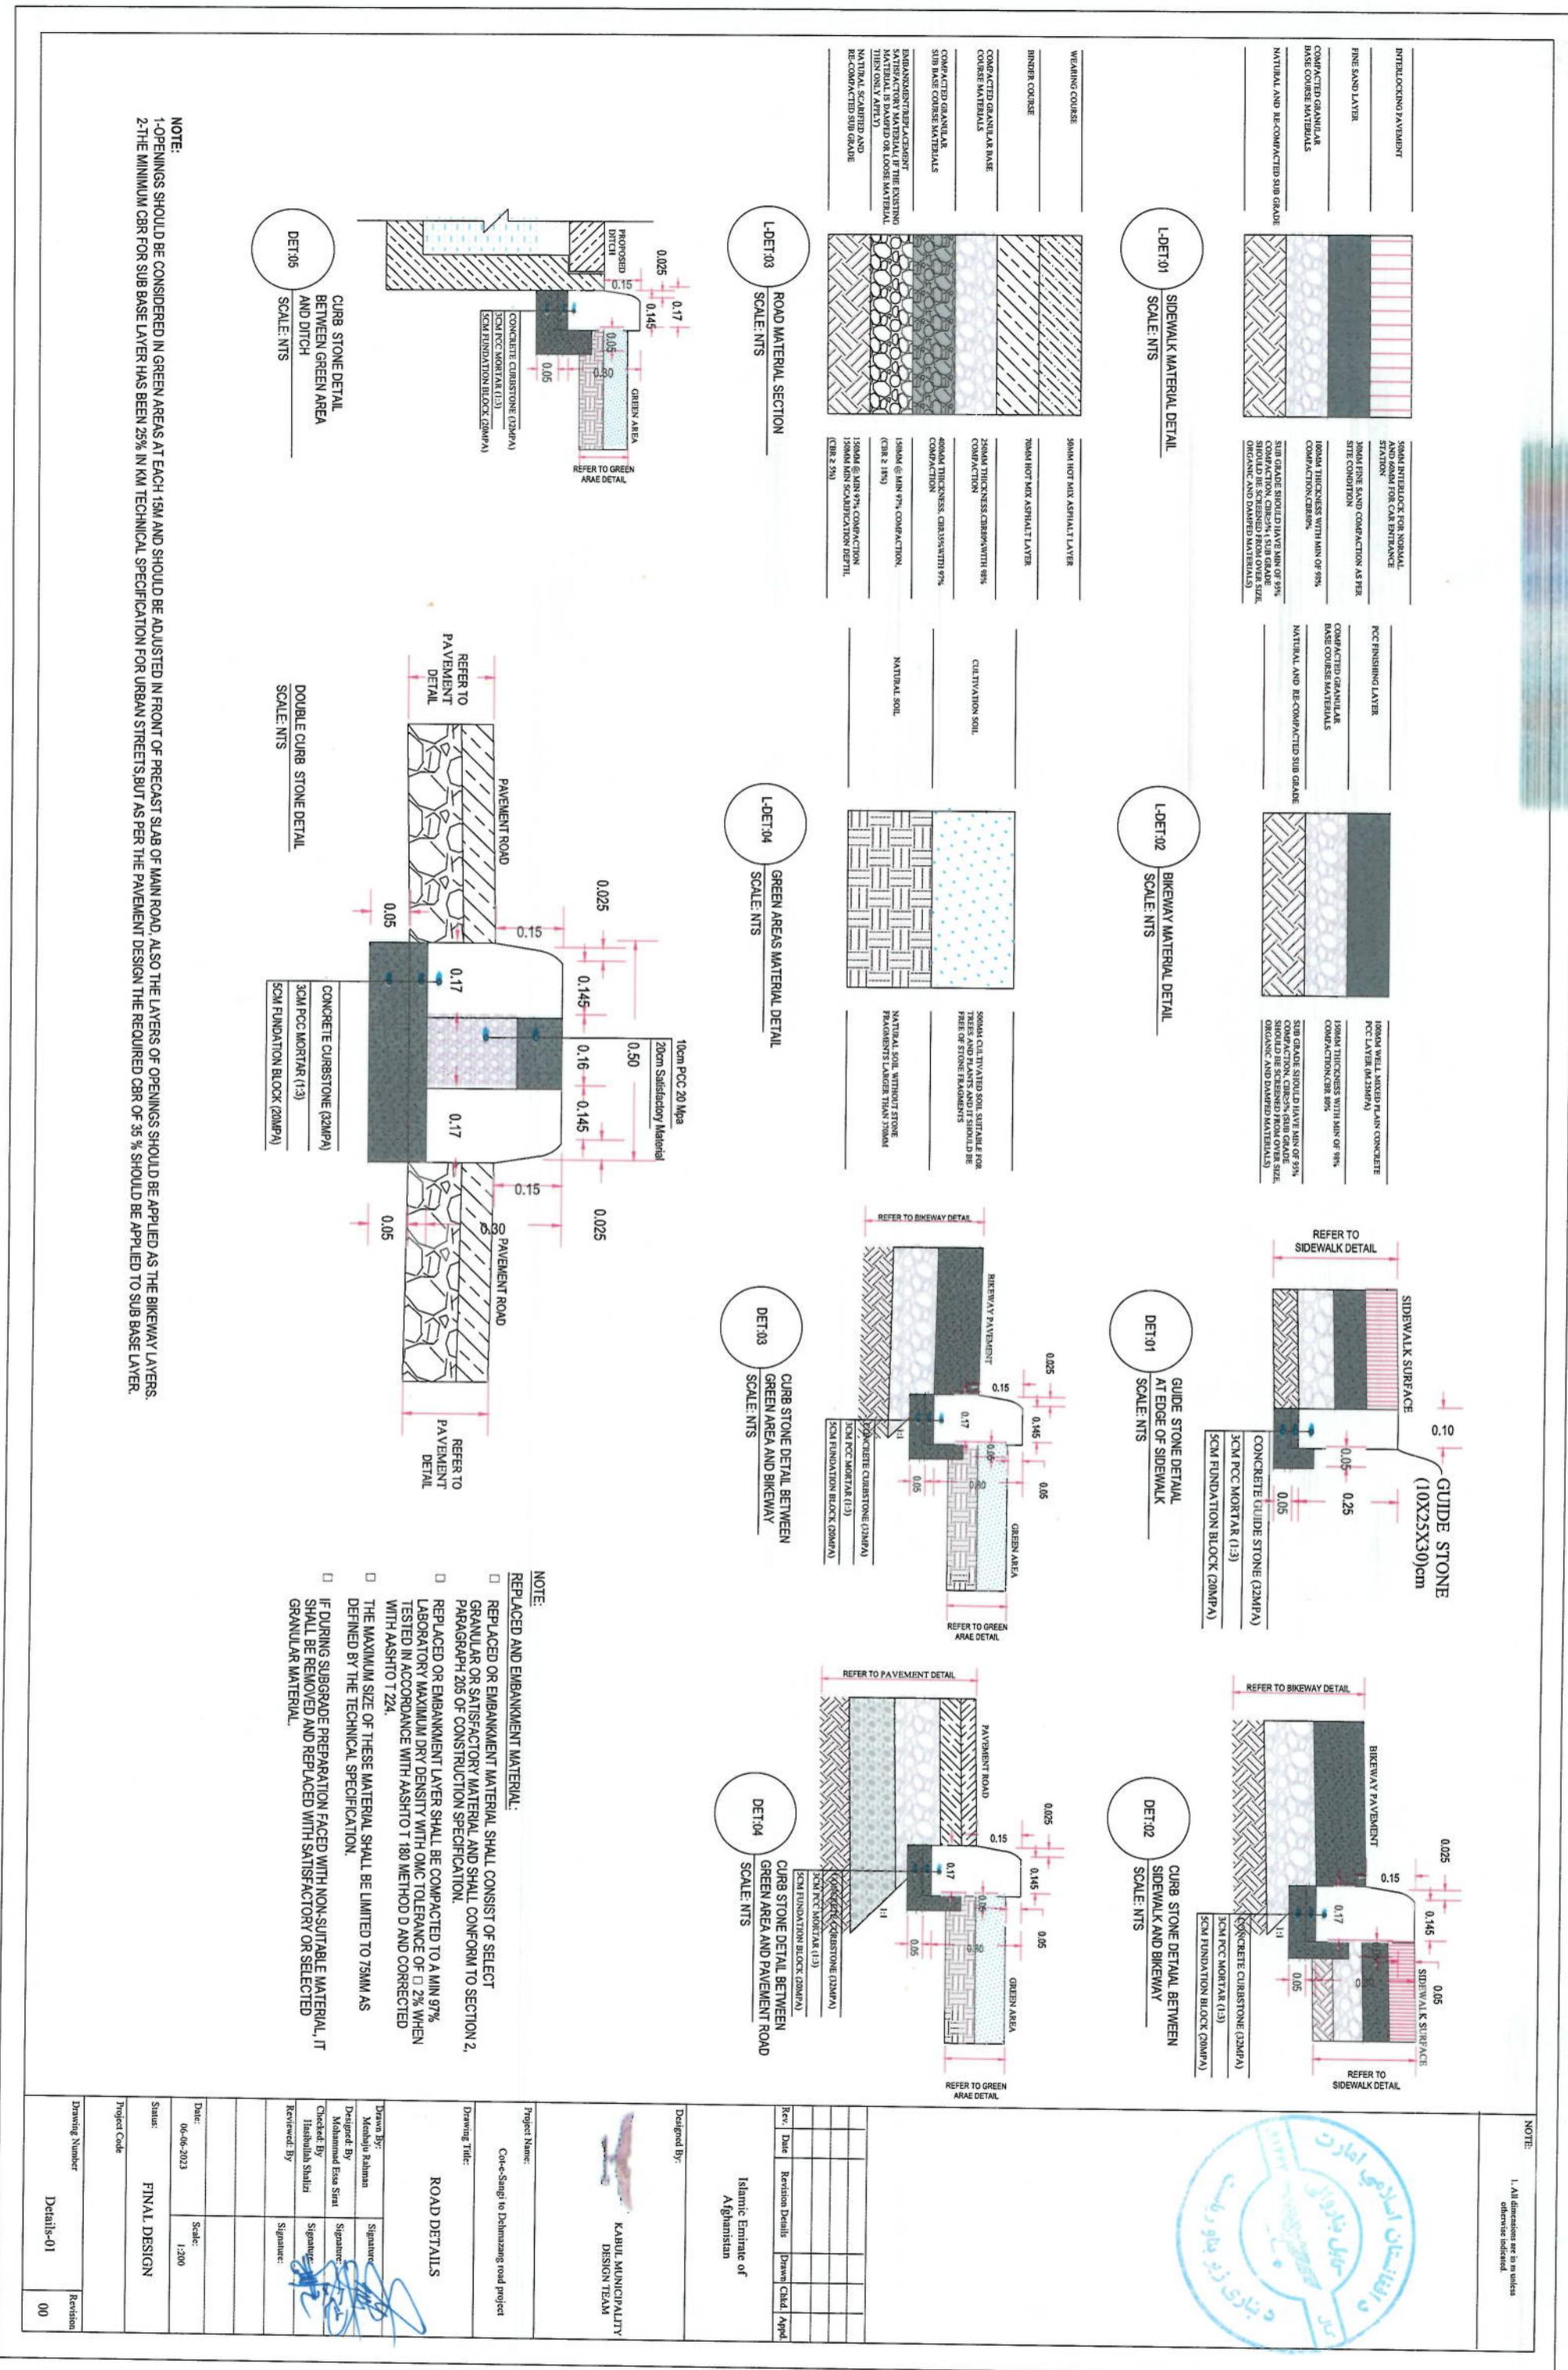
Project Code


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DRAWING & MANUFACTURING

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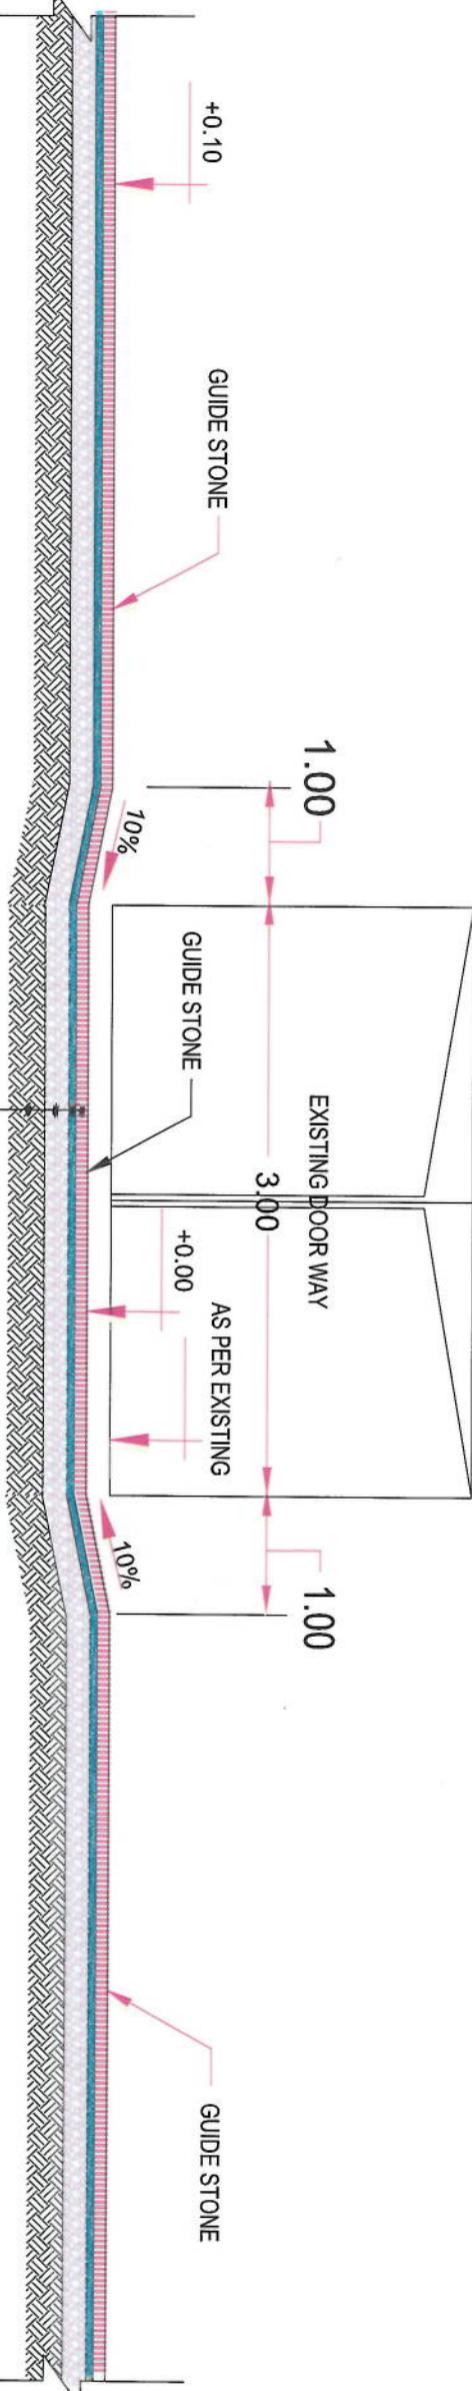
NOTE:

1. All dimensions are in m unless otherwise indicated.

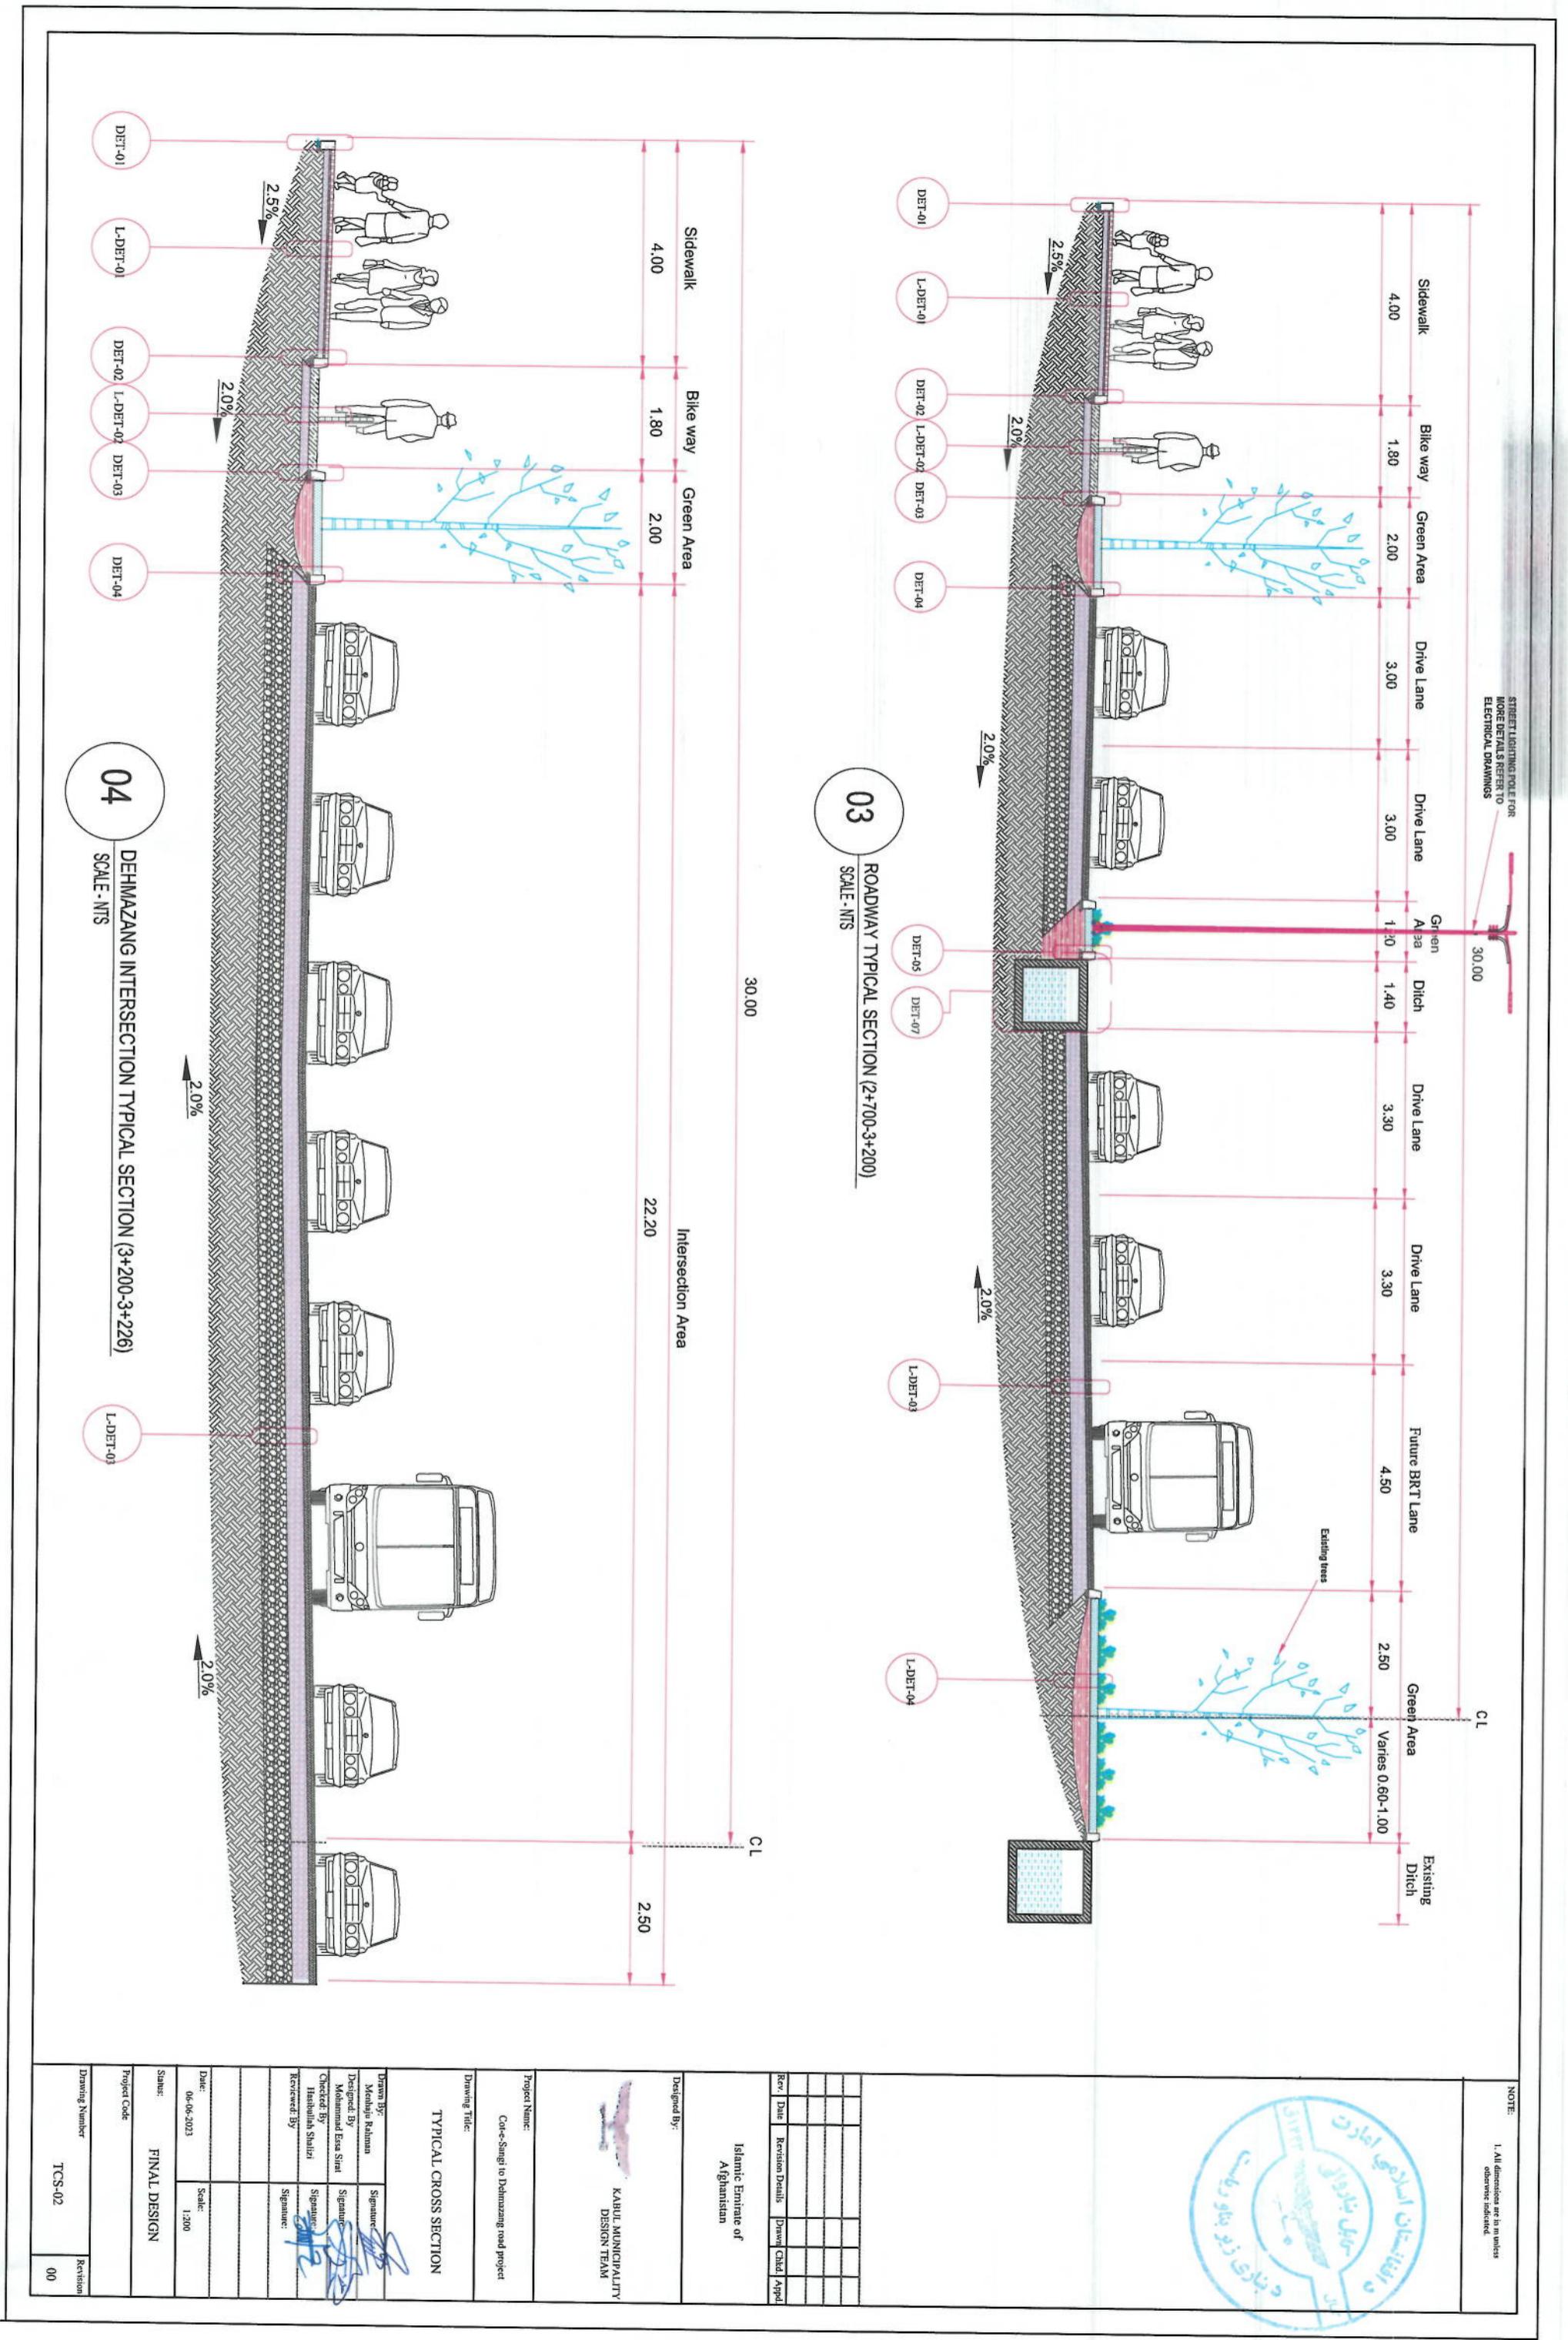

60mm Interlock
30mm Fine Sand layer
100mm Compacted Granular Base Course Materials
Well Compacted Sub grade (Sub grade should be screened from over size, damped and organic materials)

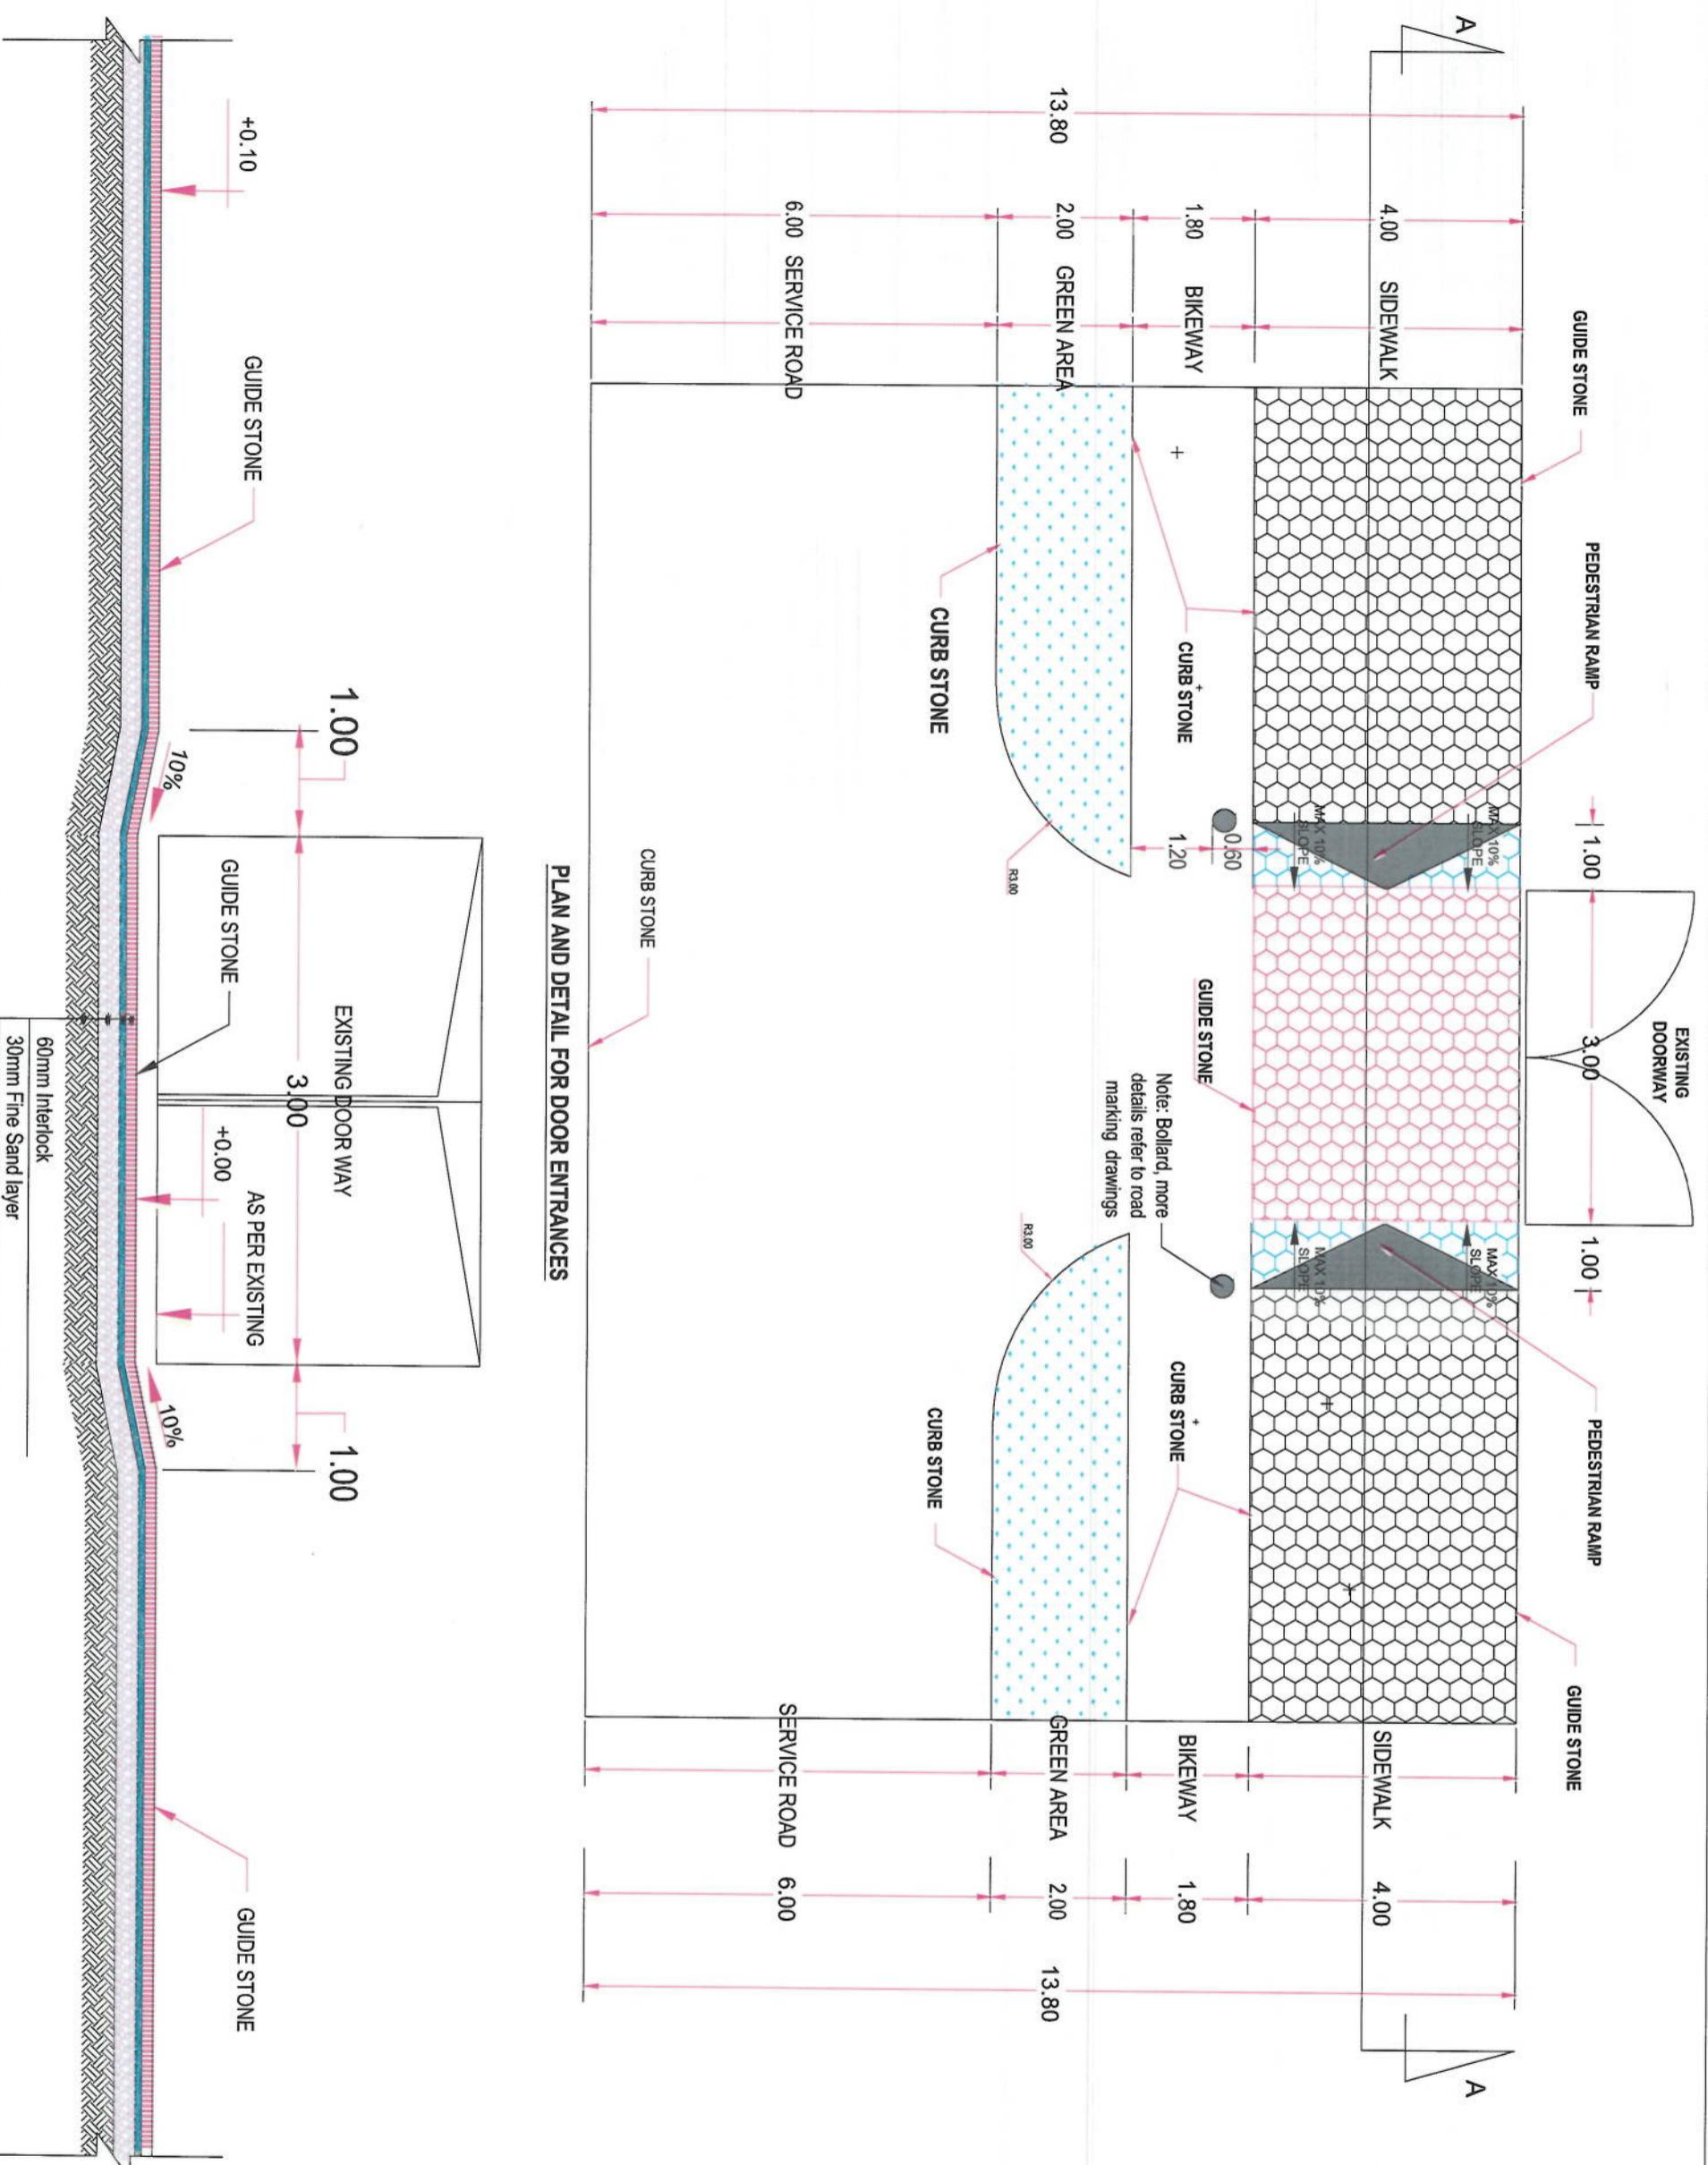SECTION A-A FOR DOOR ENTRANCES



Project Name:
Cot-e-Sang to Dehuzang road project

Drawing Title:

Entrance Detail-01

Drawn: _____ Signature: _____
Mehajir Rahim

Designed: _____ Signature: _____
Mohammad Eesa Sirat

Checked: _____ Signature: _____
Hashimullah Shalizi


ISLAMIC EMIRATE OF
AFGHANISTAN

Designed By:

KABUL MUNICIPALITY
DESIGN TEAM

Rev.	Date	Revision Details	Drawn	Chkd.	Apvd

Project Code: FINAL DESIGN
SHEET NO.: Entrance Detail-01
Status: 01
Date: 06/06/2023 Scale: 1:75
Revision:

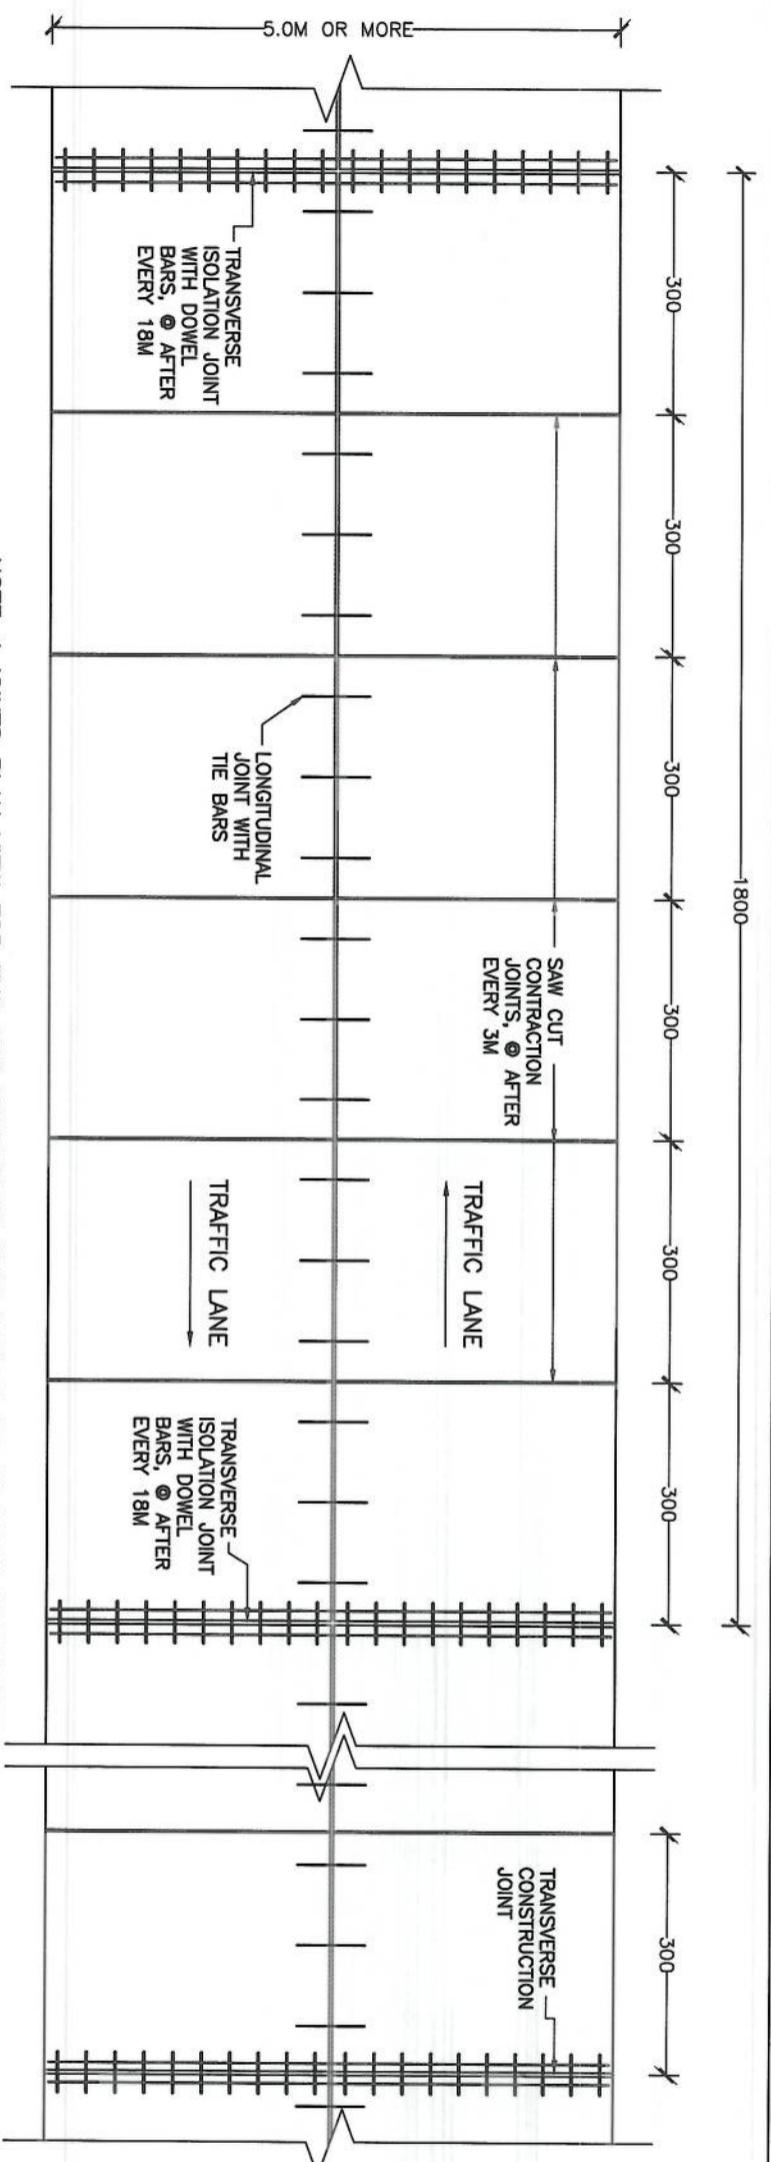


NOTE:

1. All dimensions are in meters unless otherwise indicated.


02 ISOLATION JOINT REINFORCEMENT SCALE- AS SHOWN

SCALE- AS SHOWN

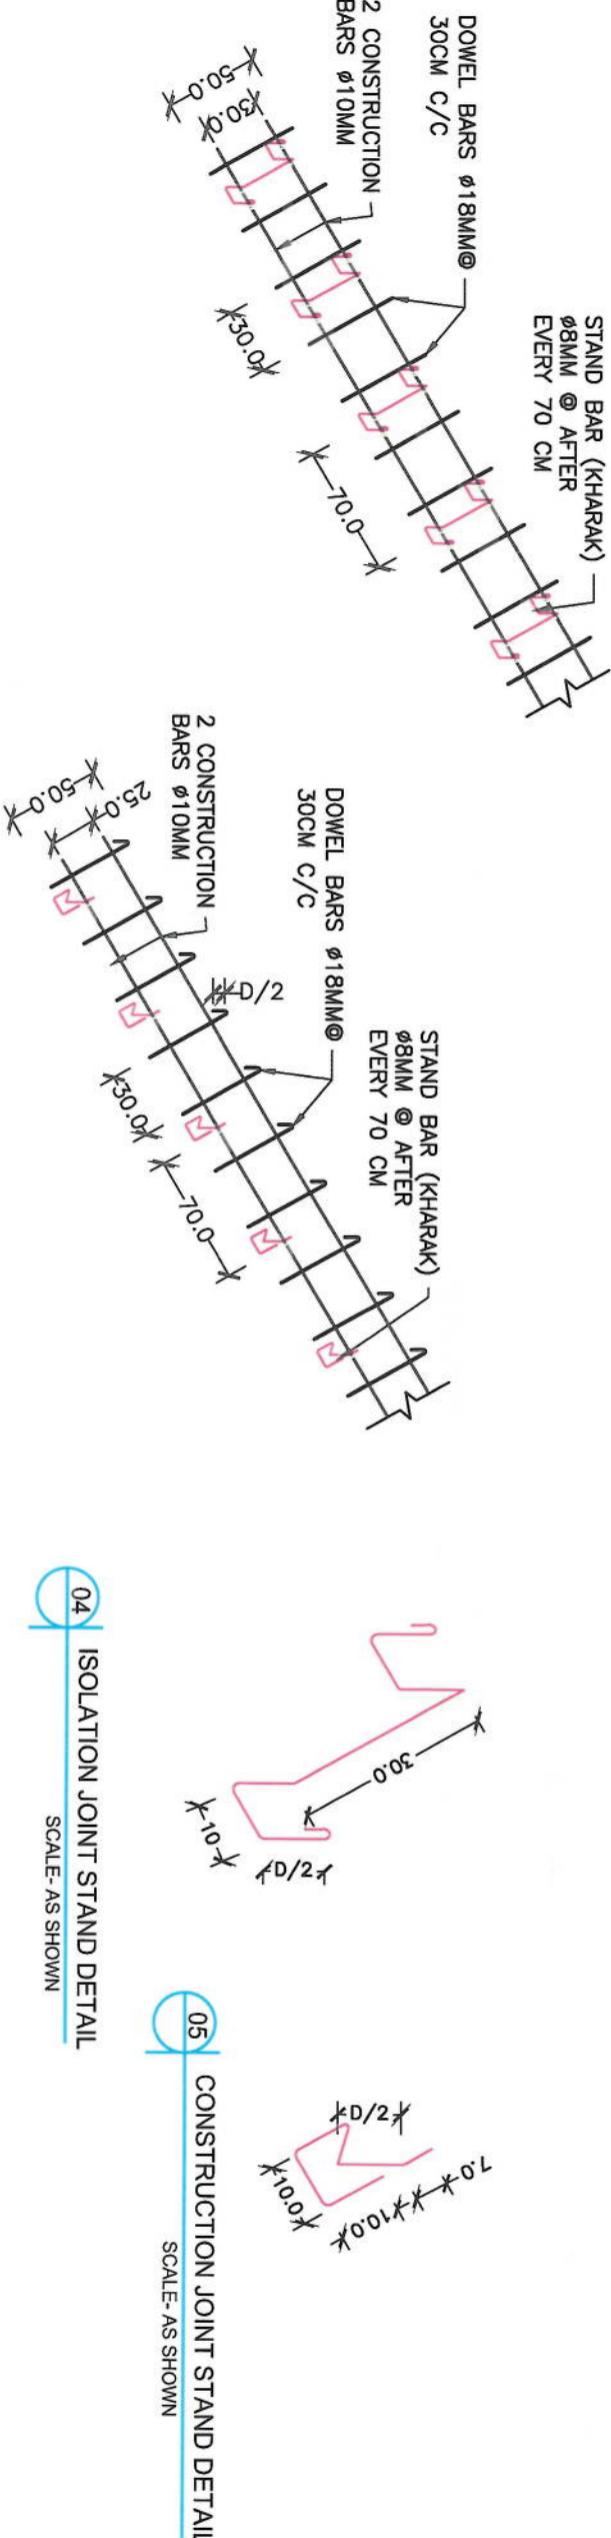

03 CONSTRUCTION JOINT REINFORCEMENT

NT REINFORCEMENT AS SHOWN

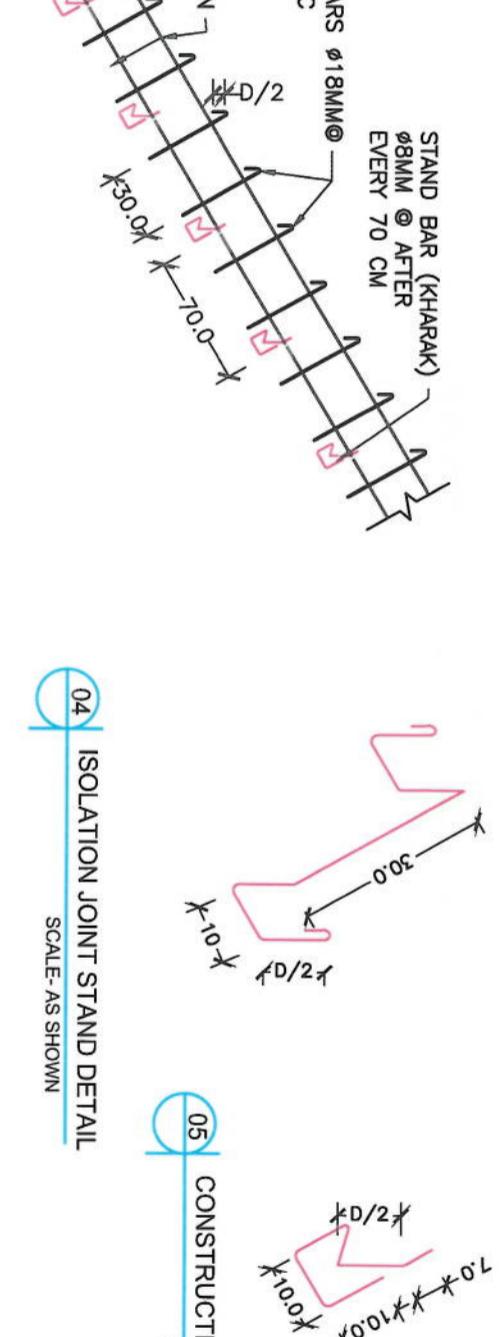

NOTE:
1) FOR MORE DETAILS PLEASE SEE PCC PAVEMENT JOINTS SECTION DETAILS.
2) TRANSVERSE JOINTS LENGTH MUST BE ACCORDING TO PAVEMENT CROSS WIDTH


- 1) FOR MORE DETAILS PLEASE SEE PCC PAVEMENT JOINTS SECTION DETAILS.
- 2) TRANSVERSE JOINTS LENGTH MUST BE ACCORDING TO PAVEMENT CROSS WIDTH.

- 1) FOR MORE DETAILS PLEASE SEE PCC PAVEMENT JOINTS SECTION DETAILS.
 - 2) TRANSVERSE JOINTS LENGTH MUST BE ACCORDING TO PAVEMENT CROSS WIDTH.
 - 3) REMOVE WOODEN PANEL, ONE SIDE CONSTRUCTION BAR AND STAND (KHARAK) FROM CONSTRUCTION JOINT.
 - 4) ALL UNITS ARE IN CM.

ISLAMIC EMIRATE OF
AFGHANISTAN


KABUL MUNICIPALITY
 DESIGN TEAM

JOINT DETAIL	
Date:	Mentaju Rahman
Designed:	Mohammad Esa Sint
Checked:	Hasibullah Shalizi
Reviewed:	
Date:	06/06/2023
Scale:	
Status:	FINAL DESIGN
Project Code	
SHEET NO.	
Revision	


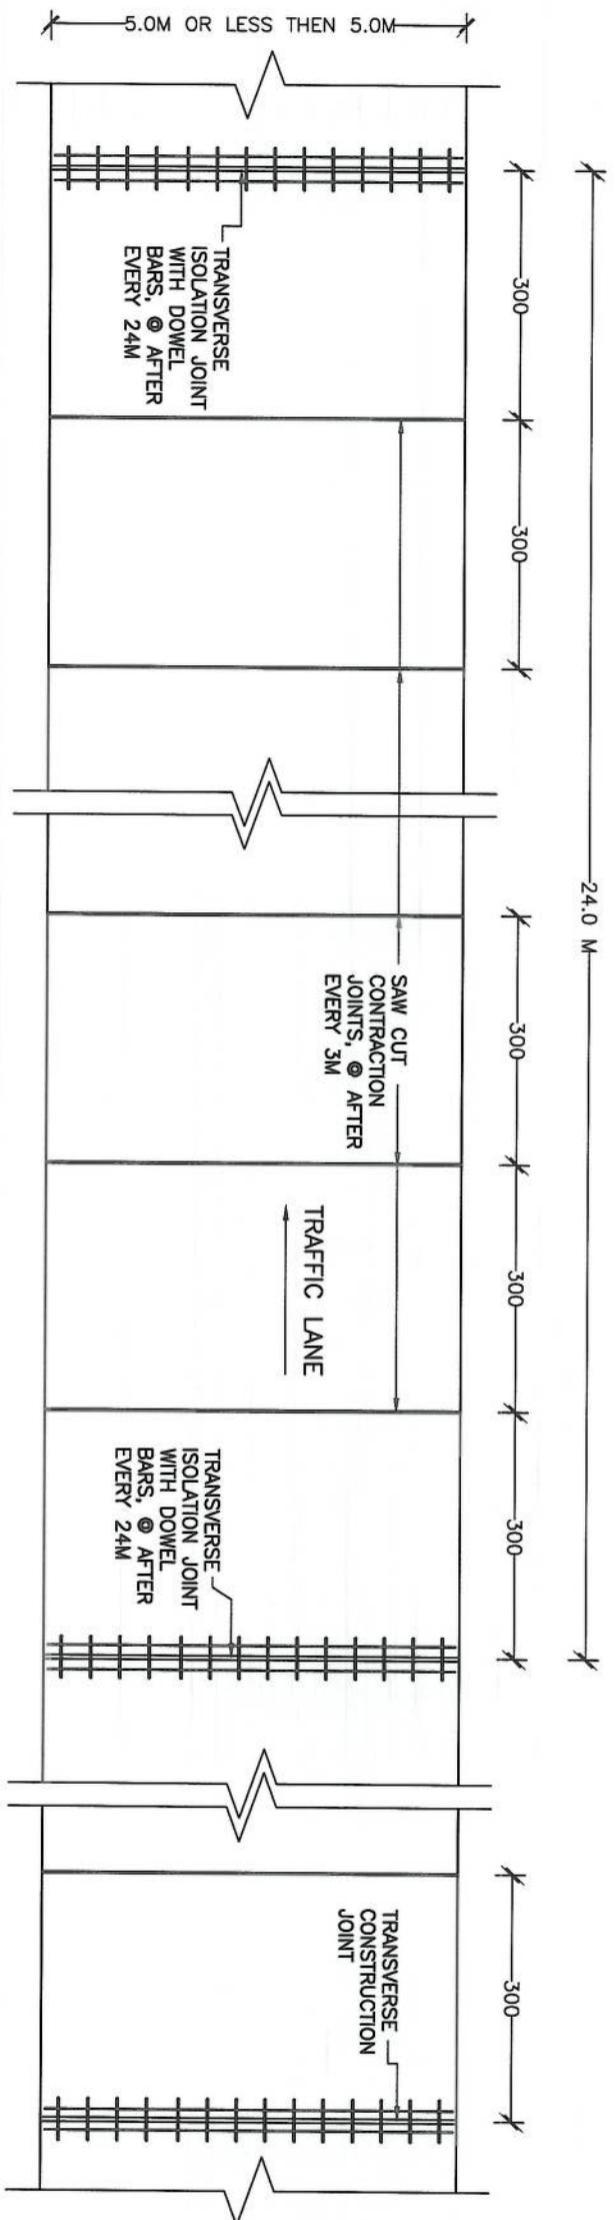


01 BIKEWAY PLAN VIEW

SCALE: AS SHOWN

DOWEL BARS Ø18MM@ 30CM C/C
2 CONSTRUCTION BARS Ø10MM

STAND BAR (KHARAK)
Ø8MM @ AFTER
EVERY 70 CM

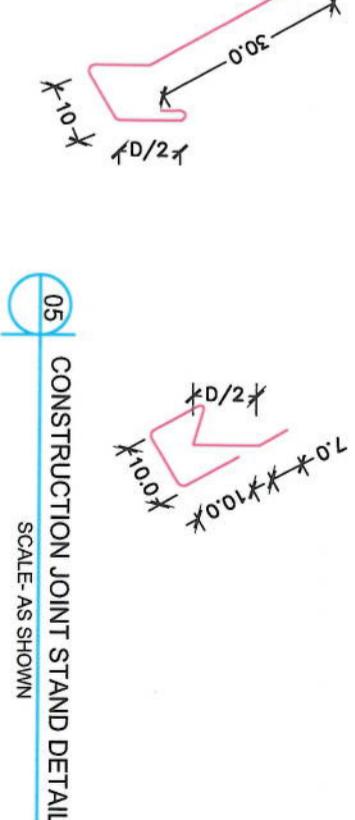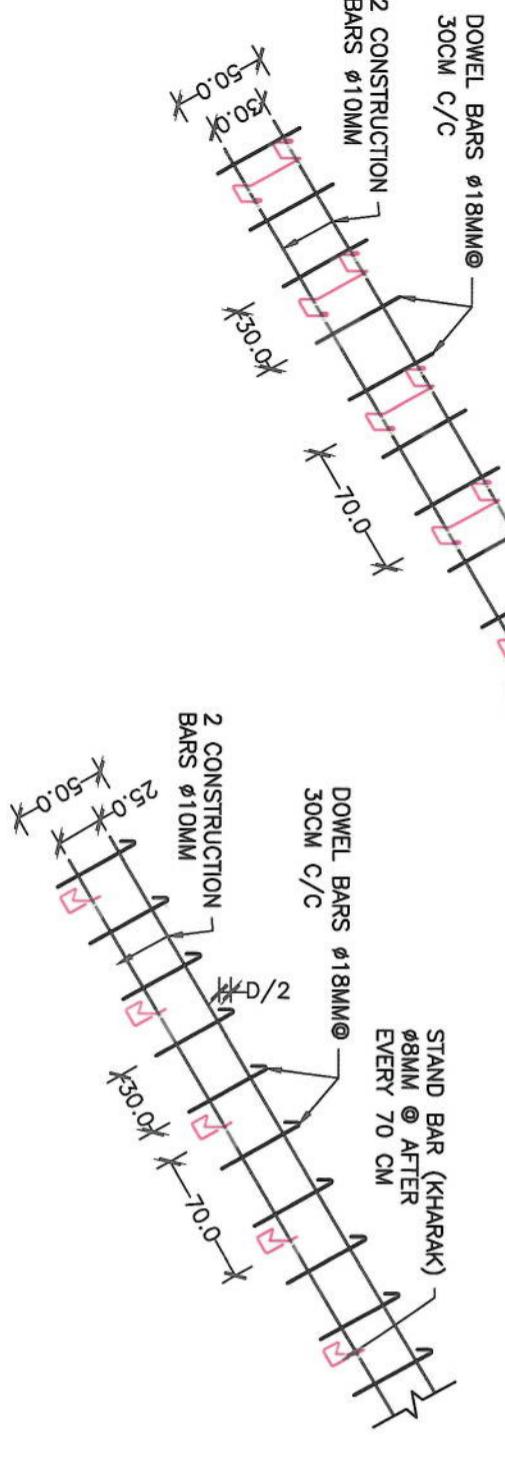

Drawn:	Signature:
Mehajju Rahman	
Designed:	Signature:
Mohammad Eisa Sial	
Checked:	Signature:
Heshilah Shabani	
Reviewed:	Signature:

02 ISOLATION JOINT REINFORCEMENT

SCALE: AS SHOWN

DOWEL BARS Ø18MM@ 30CM C/C
2 CONSTRUCTION BARS Ø10MM

STAND BAR (KHARAK)
Ø8MM @ AFTER
EVERY 70 CM




- NOTE:
- FOR MORE DETAILS PLEASE SEE PCC PAVEMENT JOINTS SECTION DETAILS.
 - TRANSVERSE JOINTS LENGTH MUST BE ACCORDING TO PAVEMENT CROSS WIDTH.
 - REMOVE WOODEN PANEL, ONE SIDE CONSTRUCTION BAR AND STAND (KHARAK) FROM CONSTRUCTION JOINT.
 - ALL UNITS ARE IN CM.

NOTE:
1. All dimensions are in meters unless otherwise indicated



NOTE:
1. All dimensions are in meters unless
otherwise indicated.

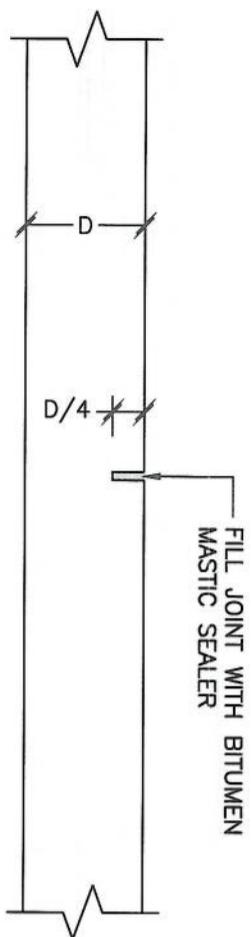


01 TRANSVERSE CONTRACTION JOINT DETAIL

SCALE- N.T.S

NOTE-1:

- 1) FORM JOINTS BY SAW CUTTING
- 2) SPACING OF CONTRACTION JOINTS @ AFTER EVERY 3 METER
- 3) FILL JOINTS WITH BITUMEN MASTIC SEALER TO PREVENT WATER PENETRATION IN TO PAVEMENTS
- 4) JOINT WIDTH = 0.5–1.0 CM

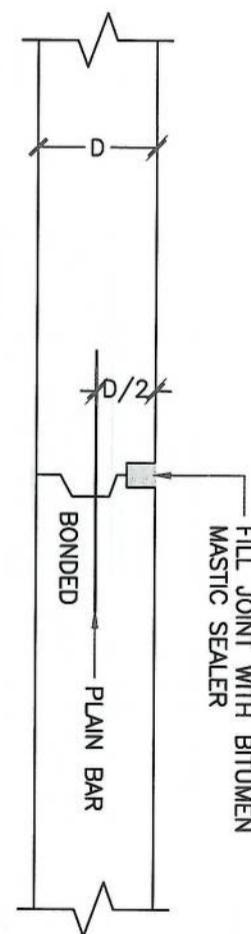


02 TRANSVERSE EXPANSION CONSTRUCTION JOINT DETAIL

SCALE- N.T.S

NOTE-2:

- 1) FORM JOINT WITH WOODEN PANEL, AND REMOVED IT AFTER JOINT FORMED.
- 2) USE DOWEL BARS $\phi 18\text{MM}$, @30CM C/C & 50 CM LONG
- 3) PROVIDE CONSTRUCTION JOINT @ THE END OF EVERY DAILY WORK AND WHEN THE WORK STOP FOR ONE HOUR OR MORE BECAUSE' OF SOME.
- 4) FILL JOINTS WITH BITUMEN MASTIC SEALER TO PREVENT WATER PENETRATION IN TO PAVEMENTS.
- 5) JOINT WIDTH = 3MM–6MM

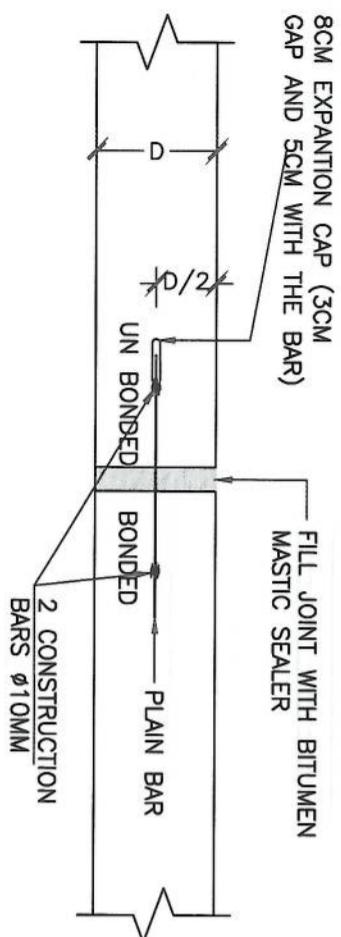

03 TRANSVERSE EXPANSION ISOLATION JOINT DETAIL

SCALE- N.T.S

NOTE-3:

- 1) FORM JOINT WITH POLYSTYRENE PANEL, AND REMOVED IT AFTER JOINT FORMED.
- 2) USE DOWEL BARS $\phi 18\text{MM}$, @30CM C/C & 50 CM LONG
- 3) SPACING MUST BE ACCORDING TO RELATED JOINTS PLAN VIEW.
- 4) FILL JOINTS WITH BITUMEN MASTIC SEALER TO PREVENT WATER PENETRATION IN TO PAVEMENTS.
- 5) JOINT WIDTH = 2.0CM–2.5CM
- 6) FROM THE MIDDLE POINT OF DOWEL BAR ONE SIDE SHOULD BE BONDED WITH PCC, BUT THE OTHER ONE SHOULD BE COATED WITH GREASE & WRAPPED WITH PLASTIC TO MAKE UN BONDED WITH PCC,

Rev.	Date	Revision Details	Drawn	Chkd	Apcd

ISLAMIC EMIRATE OF
AFGHANISTAN

Designed By:



Project Name:
Cave-Sangi to Delmazang road project


Drawing Title:

JOINT DETAIL


Drawn:	Mohajir Rahman	Signature:
Designed:	Mohammad Ehsan Sharif	Signature:
Checked:	Habibullah Shahzai	Signature:
Rechecked:		Signature:
Date:	06/06/2023	Seal:
Status:	FINAL DESIGN	
Project Code:		
SHEET NO.		
Revision No.	01	

NOTE:



1. All dimensions are in mm unless otherwise indicated

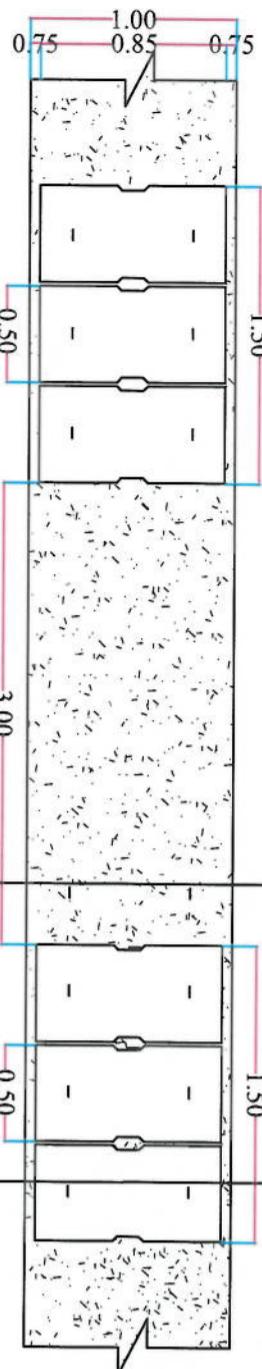

PLAN OF SIDE DITCH (1.0X1.0M)

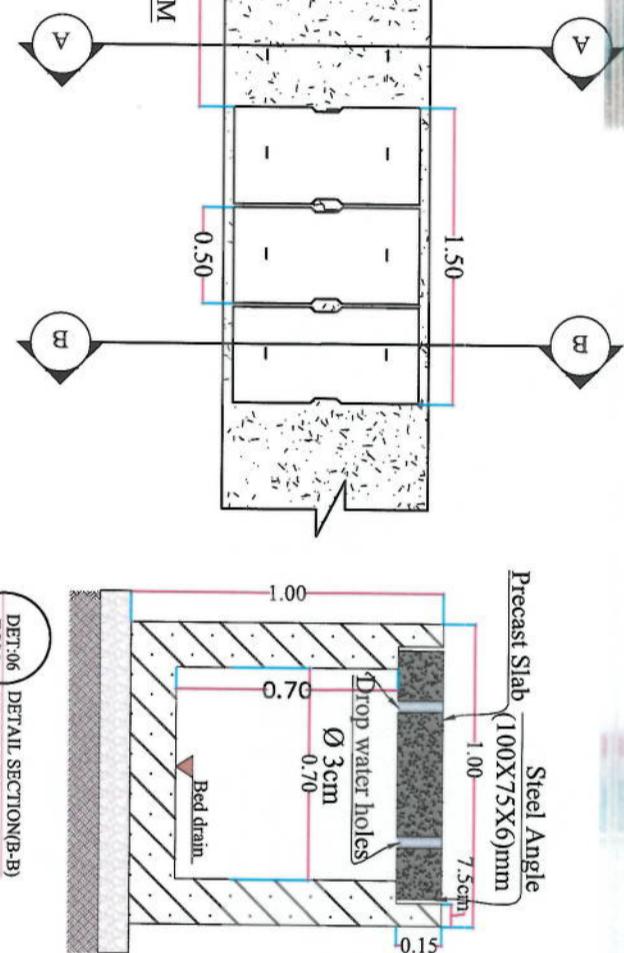DET-06 DETAIL SECTION(B-B)
TCS0 SCALE: NTSDET-06 DETAIL SECTION(A-A)
TCS0 SCALE: NTS

RCC 15 CM (25MPA)
10CM GRANULAR AGGREGATE SUB BASE
MATERIAL WITH 98% COMPACTION
(RE-COMPACTED SOIL
(COMPACTION-97%)

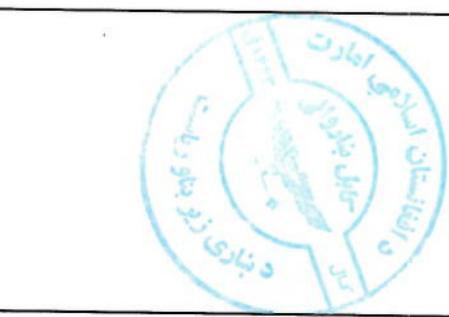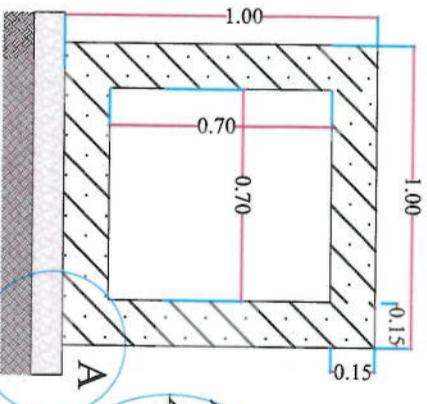








BUTCH (100X100) CM REINFORCEMENT SCHEDULE

Bar No	Bar Shape	\varnothing (mm)	Spacing (mm)	Remark
As1	[Bar shape]	12	160	
As2	[Bar shape]	12	160	
As3	[Bar shape]	12	160	
As4	[Bar shape]	12	160	
As5	[Bar shape]	10	150	
As6	[Bar shape]	10	150	
As7	[Bar shape]	12	150	
As8	[Bar shape]	12	150	
As9	[Bar shape]	8	200	

ISLAMIC EMARATE OF
AFGHANISTAN

Drawn By:	Design By:	Date:	Rev.	Date:	Revision Details:	Drawn Child:	Appl
Nawzakai Nasir	KABUL MUNICIPALITY DESIGN TEAM						
Designed By: Abdul Shokou Mansour	Signature: [Signature]						
Checked By: Hashimullah Sulzi	Signature: [Signature]						
Reviewed By:	Signature:						
Date: 02/06/2023	Scale:						
Status: FINAL DESIGN	Project Code:						
Drawing Number: S-D-01	Revision: 00						

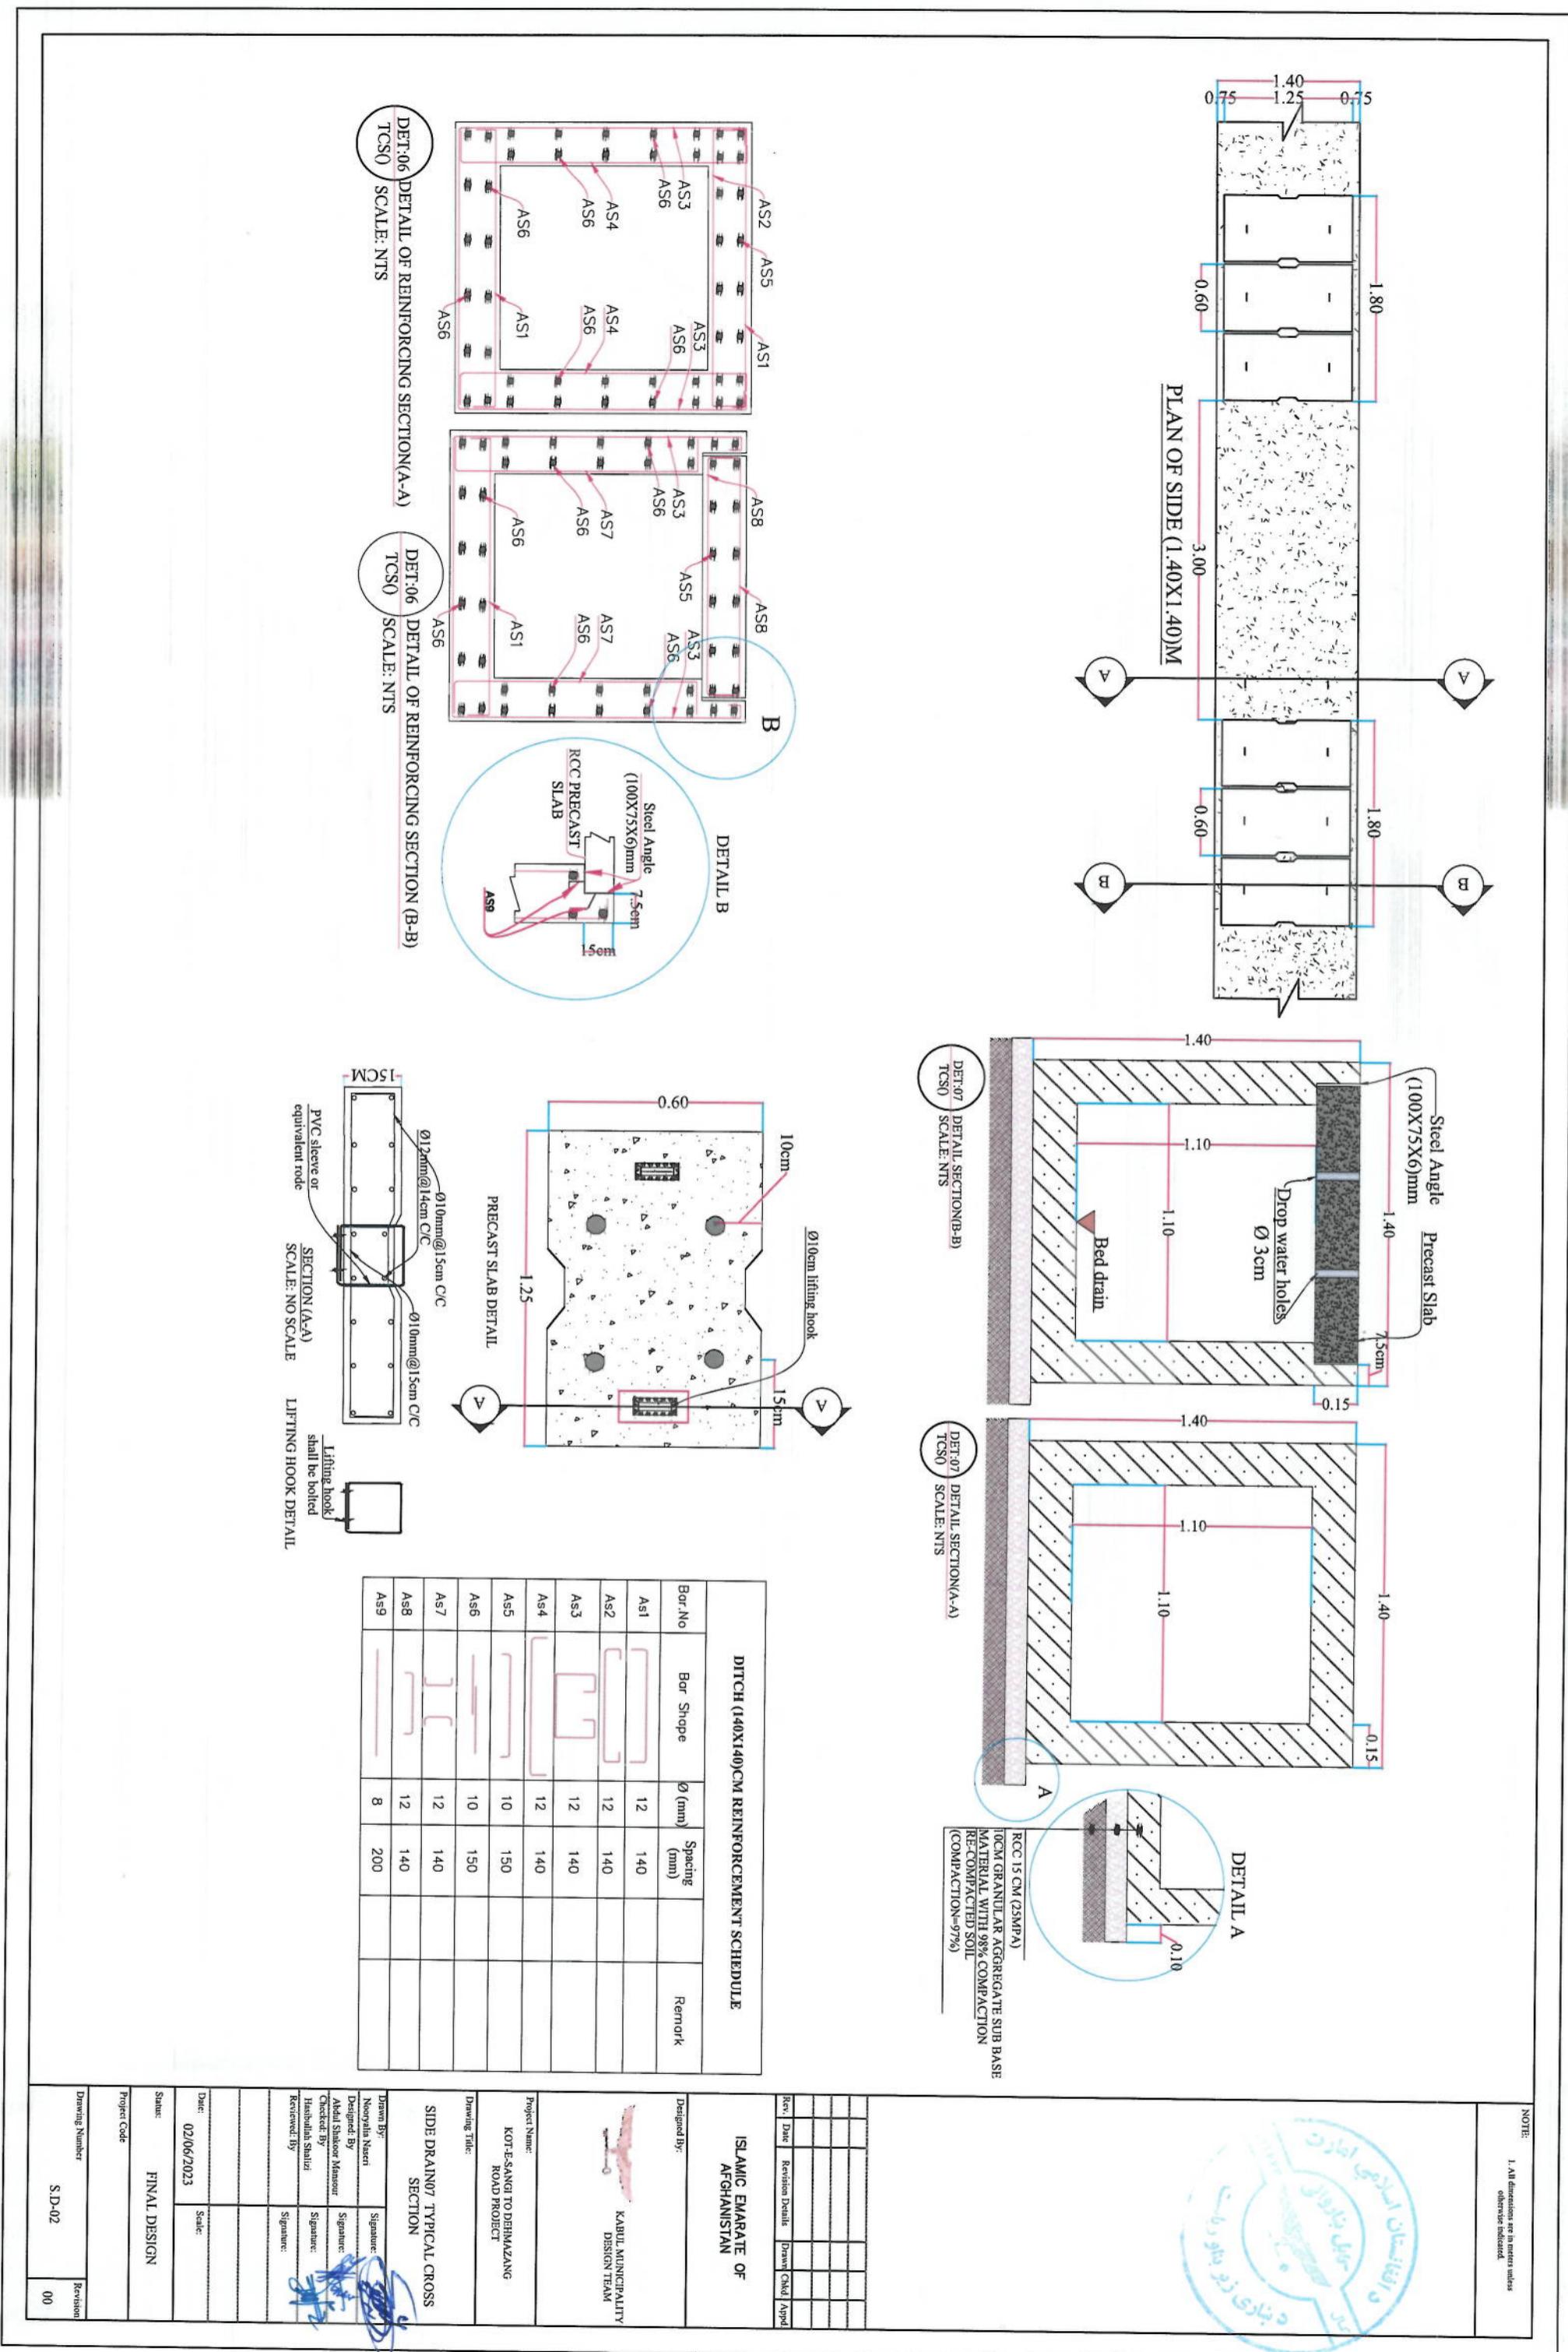

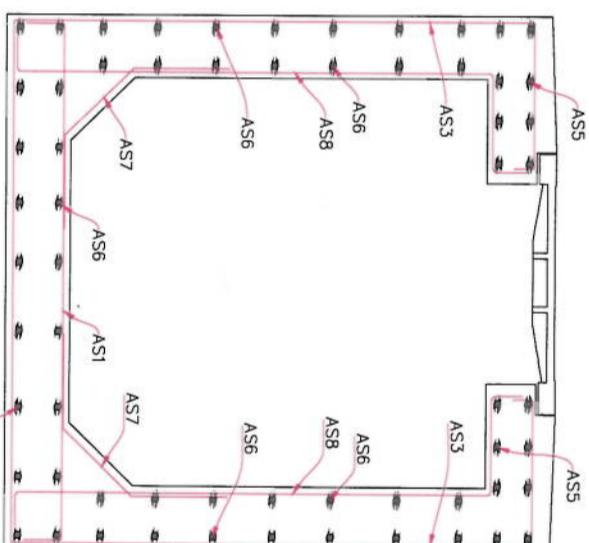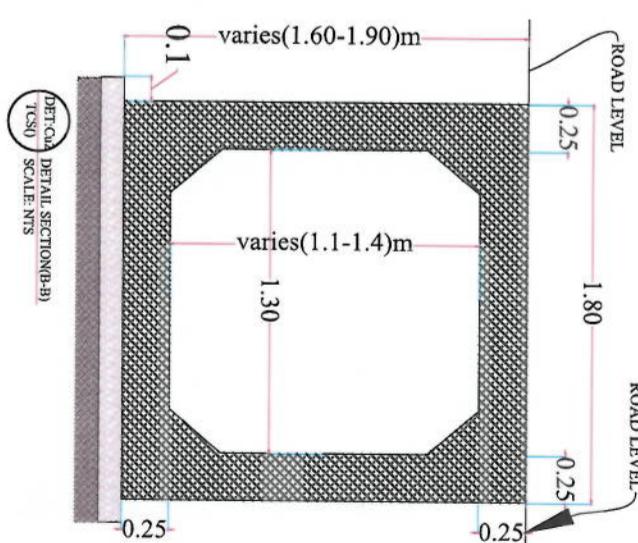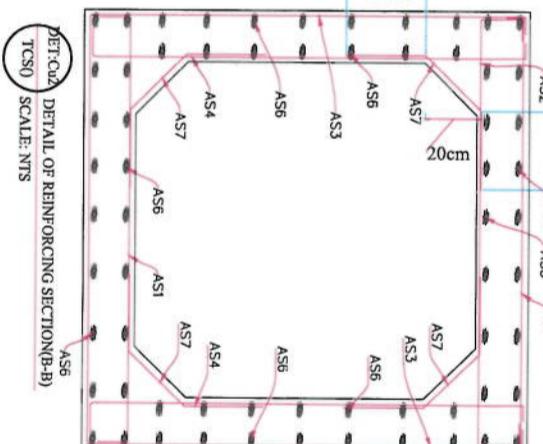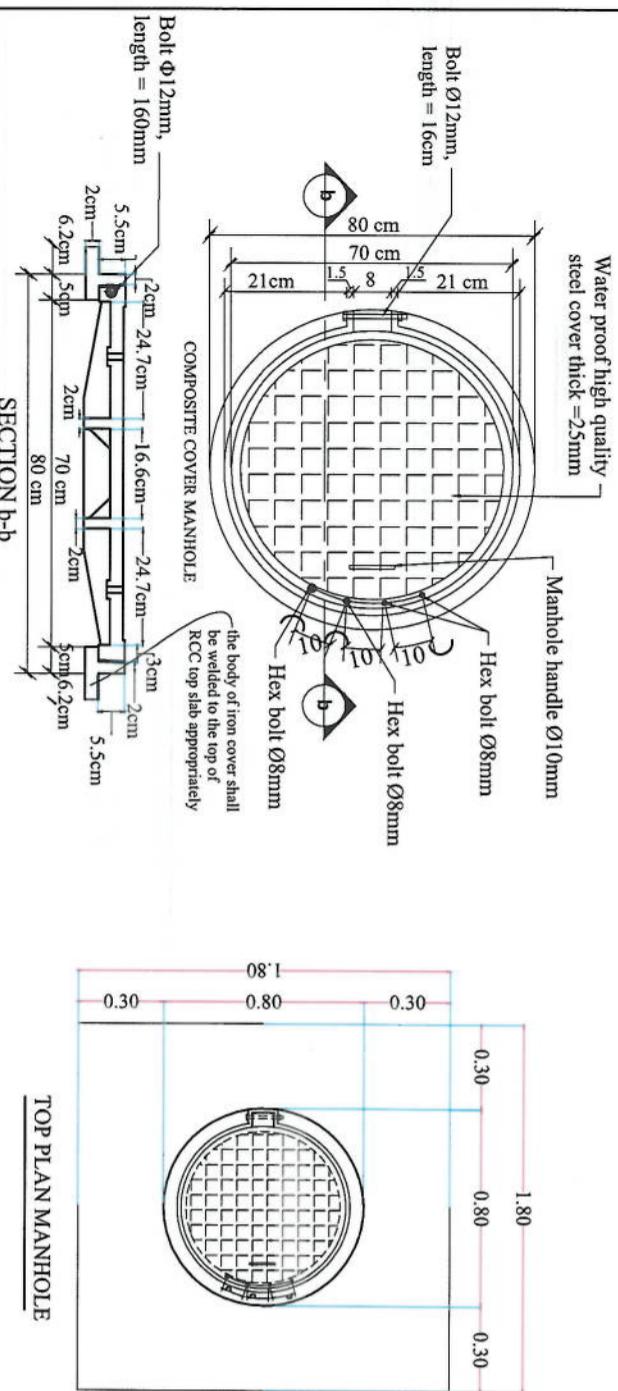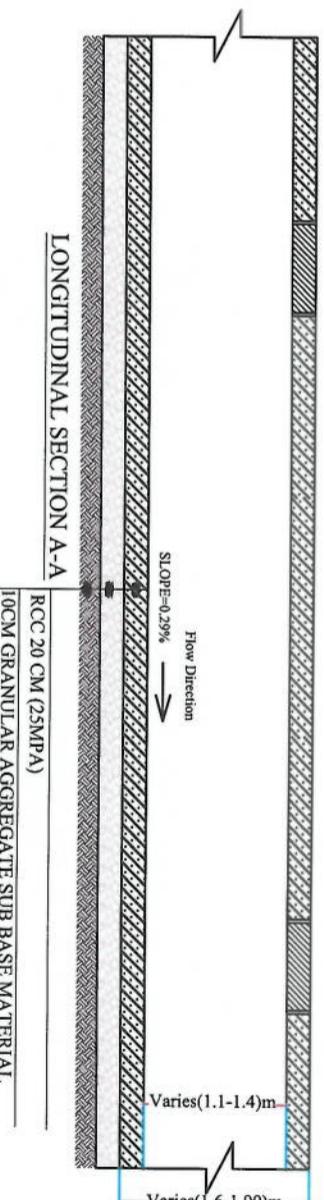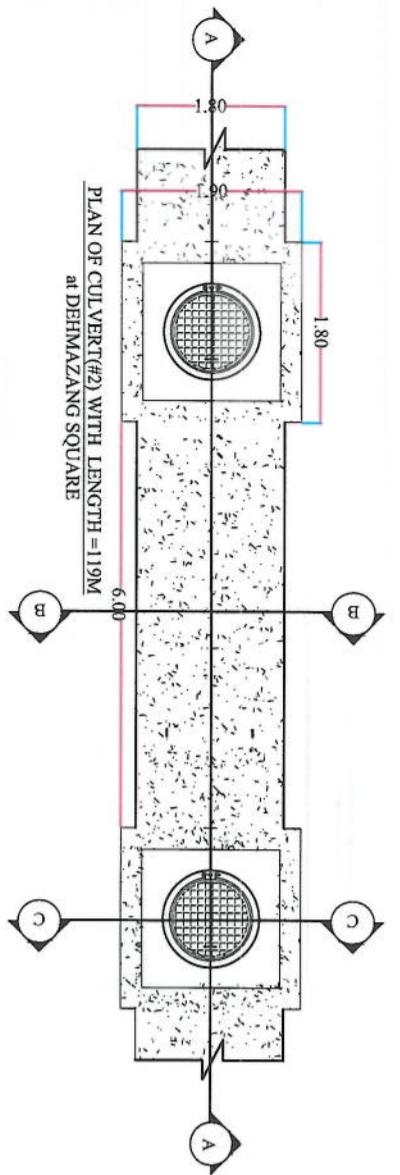


DITCH & MANHOLE REINFORCEMENT SCHEDULE				
Bar. No	Bar Shape	Ø (mm)	Spacing (mm)	Remark
AS1		16	150	
AS2		16	150	
AS3		16	150	
AS4		16	150	
AS5		12	150	
AS6		12	150	
AS7		12	300	
AS8		16	150	

LINK ROAD DITCH TABLE


NUMBER OF LINK ROAD	LINK DITCH TYPE	LOCATION OF LINK DITCH
1	A	BOTH SIDE
2	B	BOTH SIDE
3	B	BOTH SIDE
4	B	ONE SIDE
5	C	BOTH SIDE
6	A	BOTH SIDE
7	D	BOTH SIDE
8	C	BOTH SIDE
9	A	ONE SIDE
10	A	ONE SIDE
11	D	ONE SIDE
12	D	ONE SIDE
13	D	BOTH SIDE

B

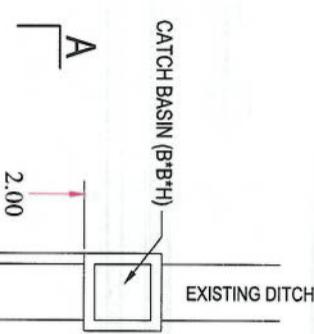


3 NO PRECAST RCC
SLAB @ 3M DISTANCE

C

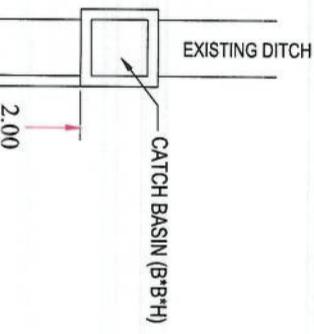

3 NO PRECAST RCC
SLAB @ 3M DISTANCE

NOTE:
1. All dimensions are in m unless otherwise indicated.

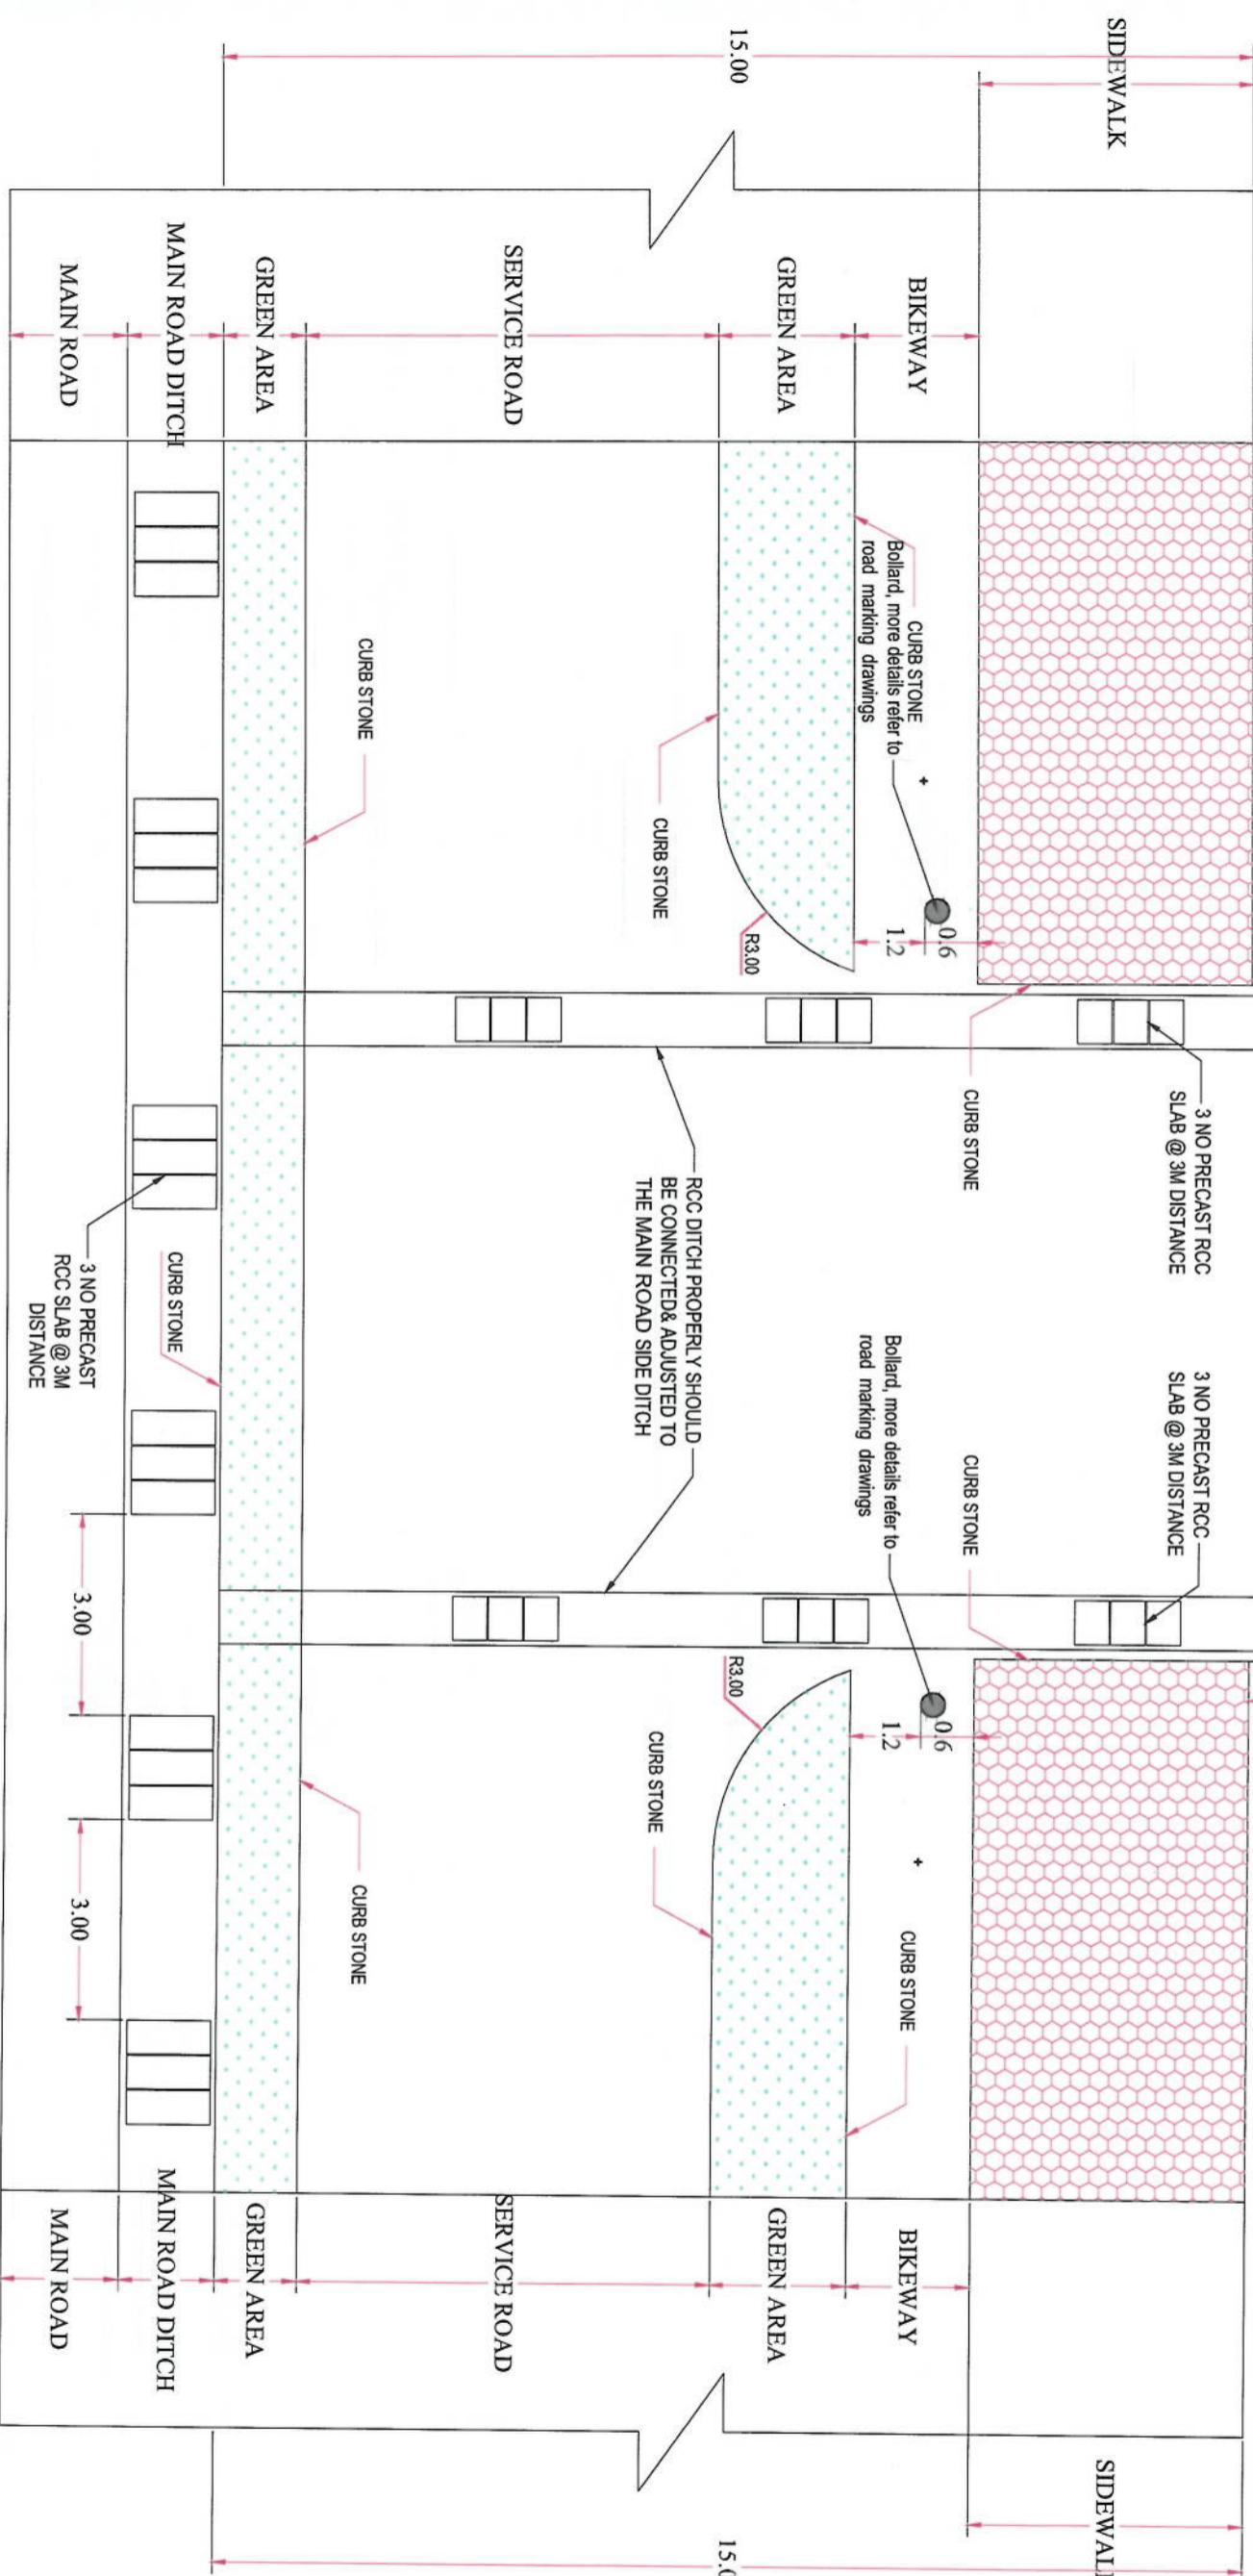


B

C


B

NOTE:

1. All dimensions are in m unless otherwise indicated

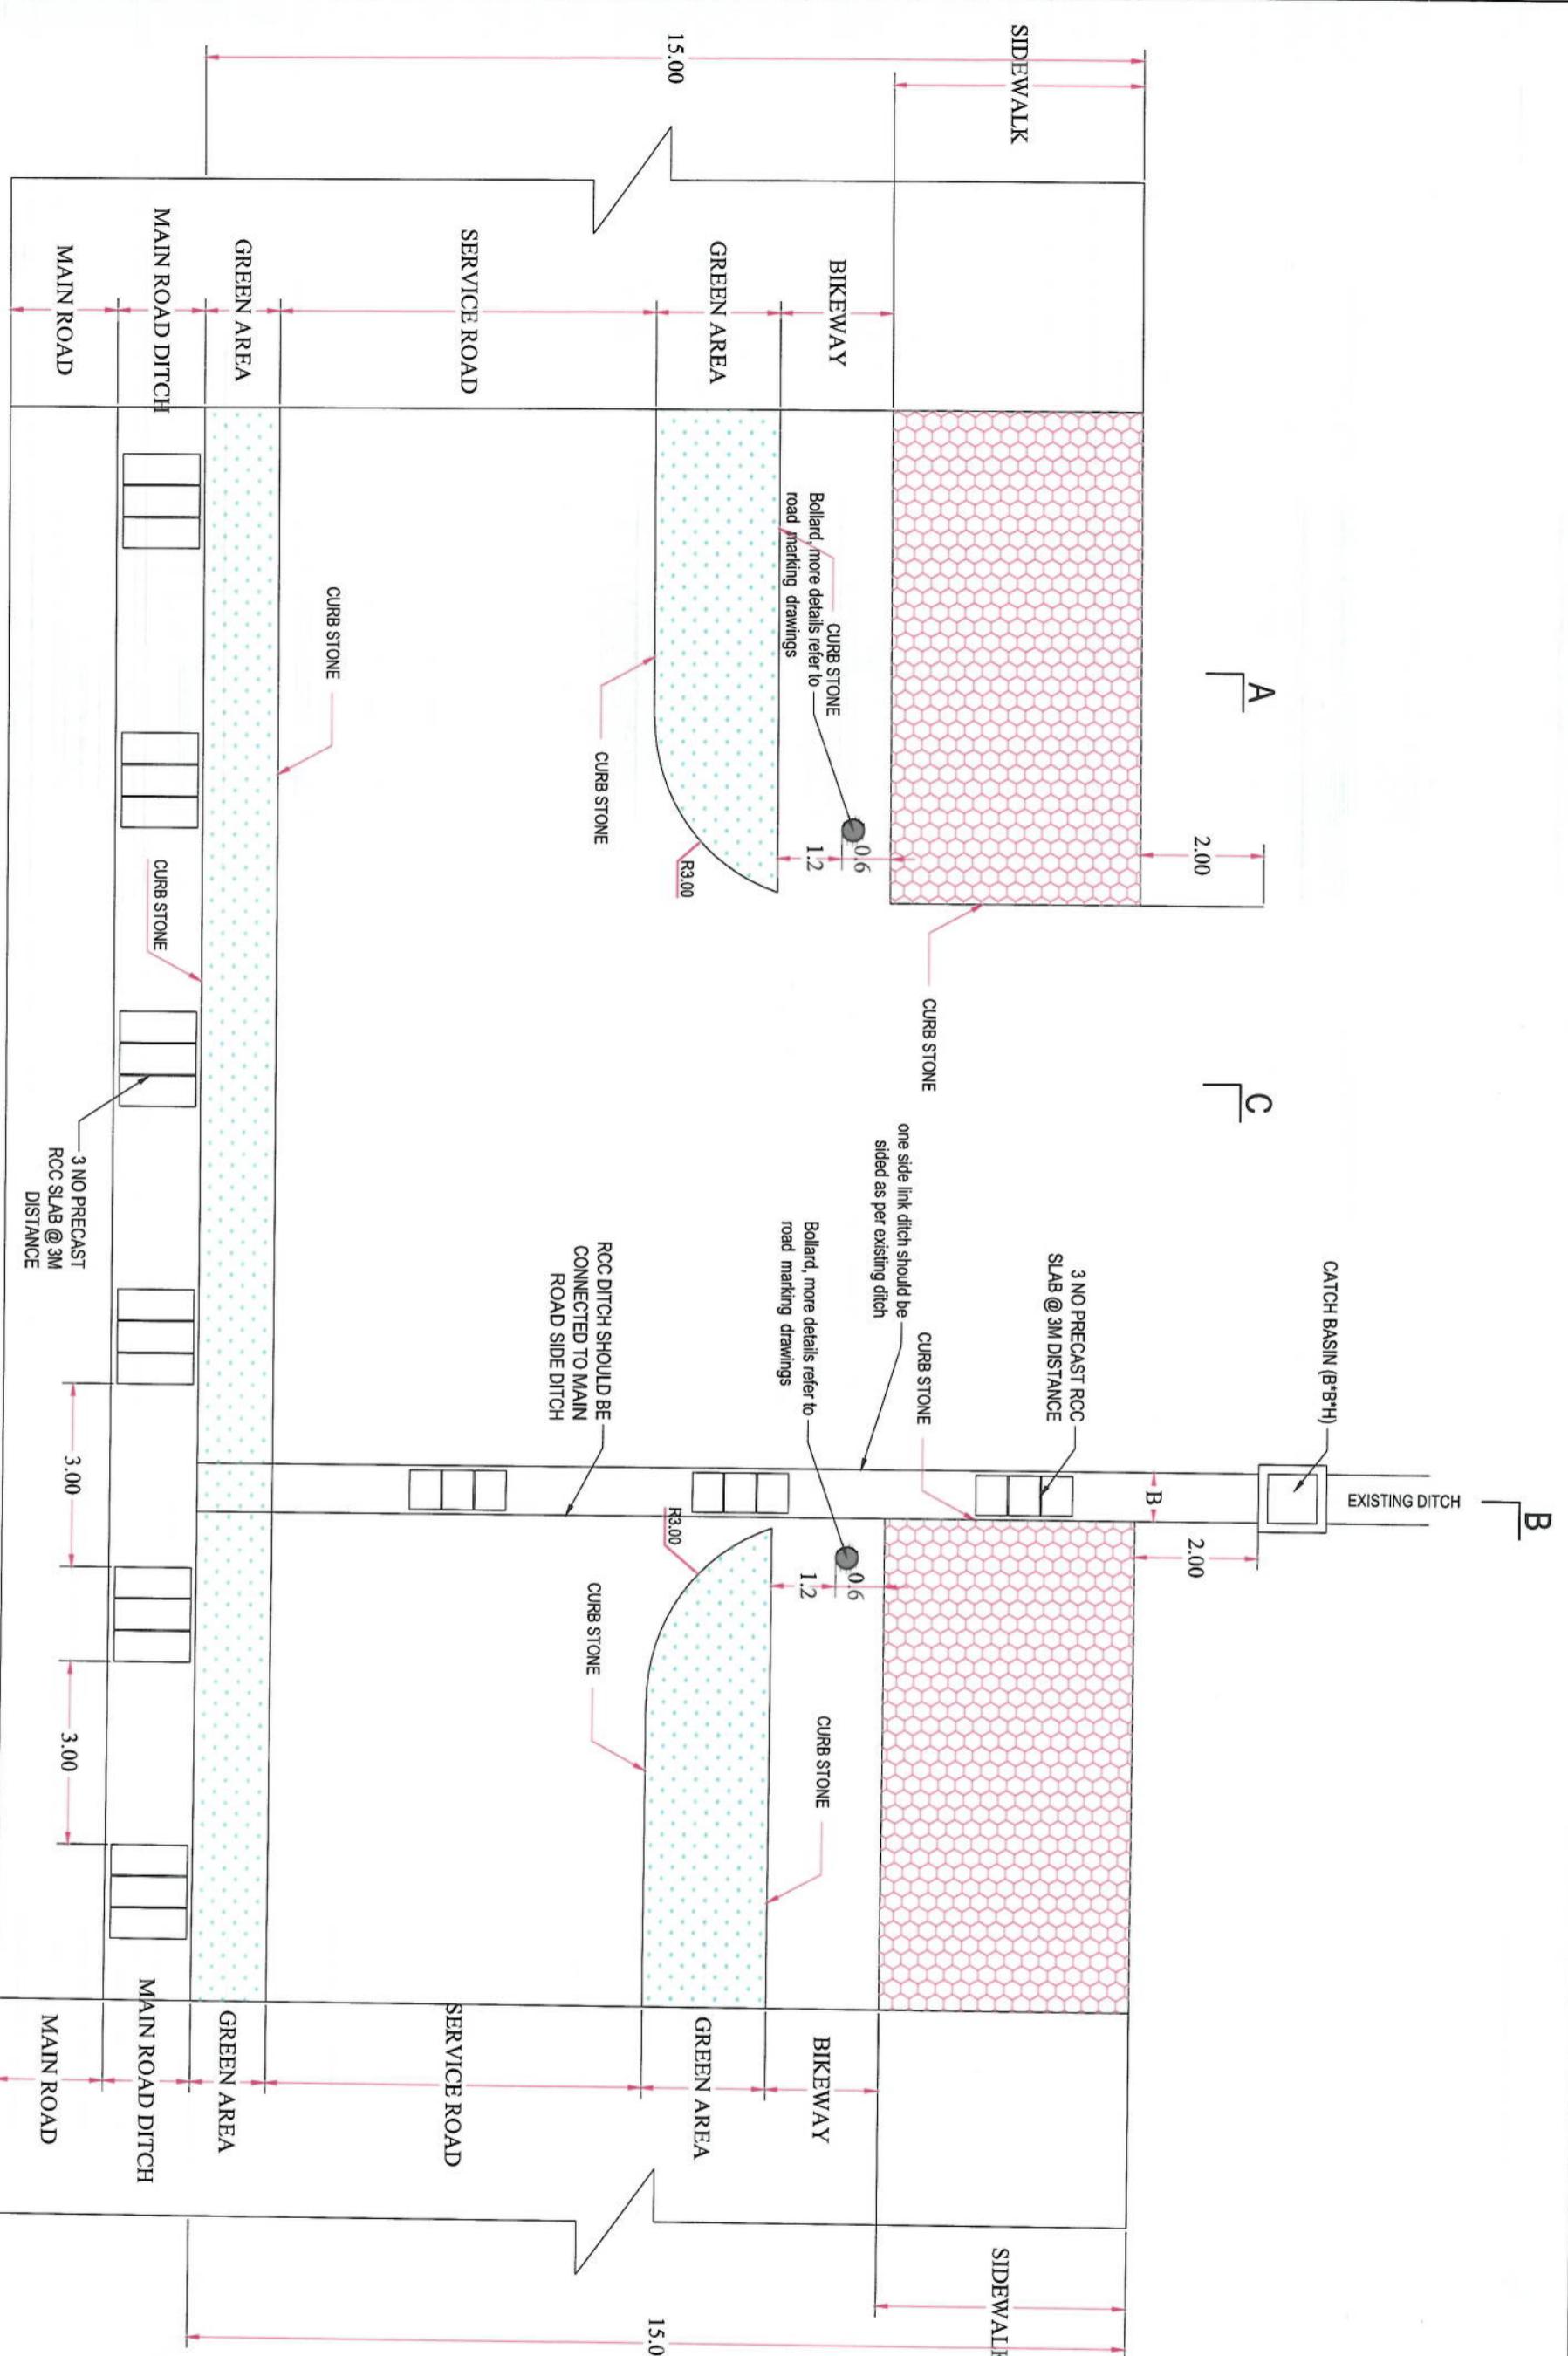


LINK ROAD-One side	
Drawn: Muhammad Rahman Signature:	Signature:
Designed: M. Esa Sial Checked: Hasbullah Shafiqi Signature:	Signature:
Drawing Title: KOTE-SANGI TO DEHMIZANG ROAD PROJECT	
Project Name: ISLAMIC EMIRATE OF AFGHANISTAN KABUL MUNICIPALITY DESIGN TEAM	
SHEET NO.: ED DETAIL-02	
Revision 01	
Date: 02/06/2023	Scale: 1:75
Status: FINAL DESIGN	
Project Code:	

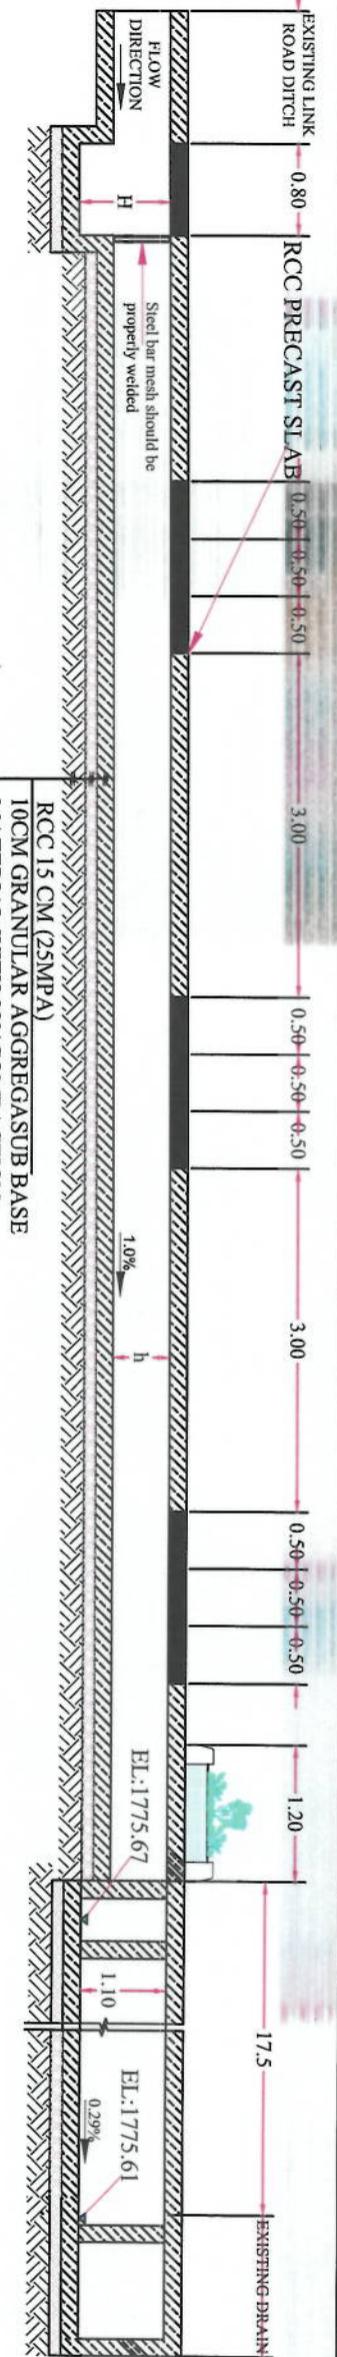

RCC 15 CM (25MPA)
10CM GRANULAR AGGREGATE BASE
MATERIAL WITH 98% COMPACTION
RE-COMPACTED SOIL (COMPACTION=97%)

SECTION D-D FOR LINK ROADS

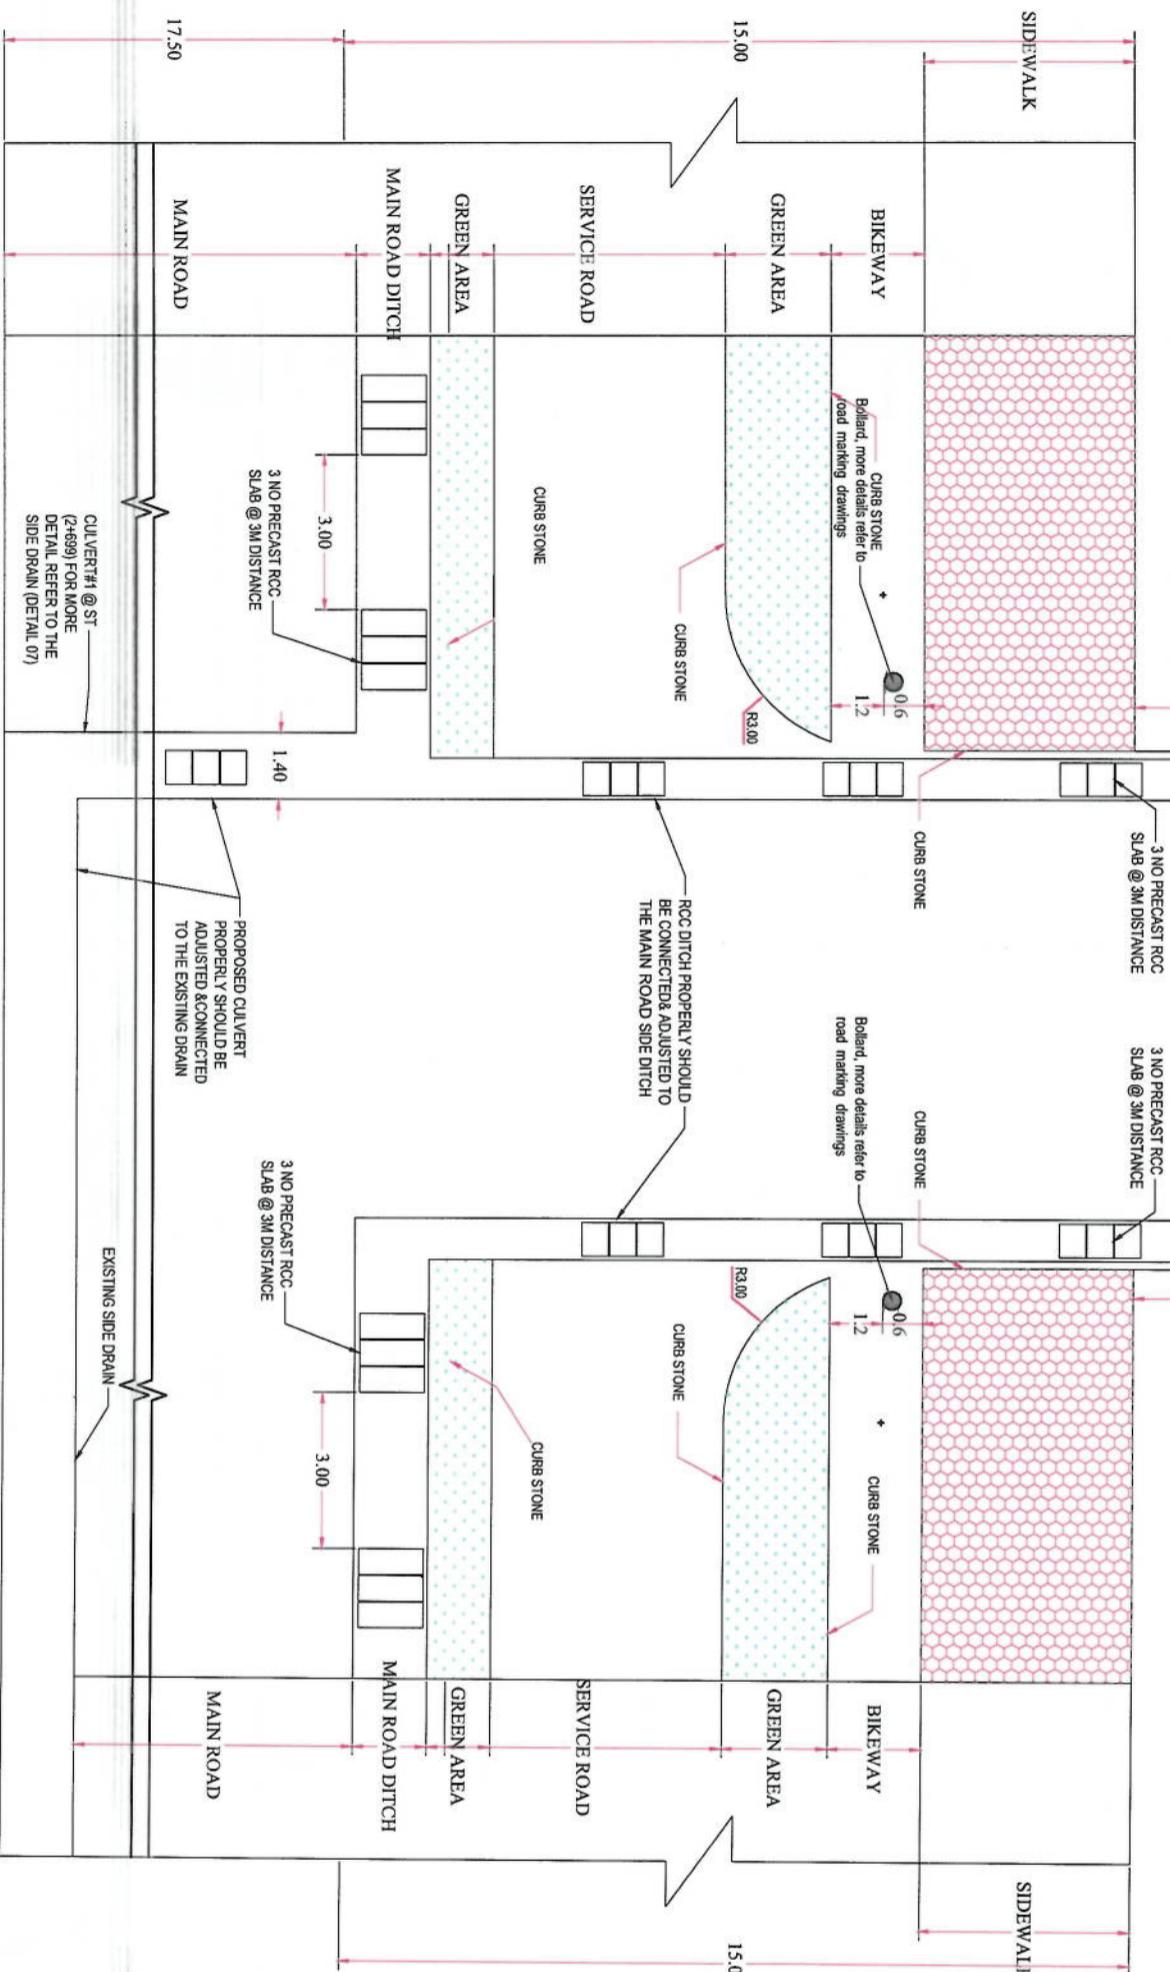

PLAN OF LINK ROADS TYPE C

NOTE:
1. All dimensions are in meters unless otherwise indicated.




Drawn:	Signature:
Mehdiu Rahim	
Designed: M. Saeed Sharif	
Checked: Hashbulan Shahzai	


Drawing Title:
**LINK ROAD Both side
WITH CULVERT #1**

Date: 02/06/2023 Scale: 1:500
Status: FINEL DESIGN
Project Code: ED DETAIL-03 Revision: 01

NOTE:
1. All dimensions are in m unless
otherwise indicated.

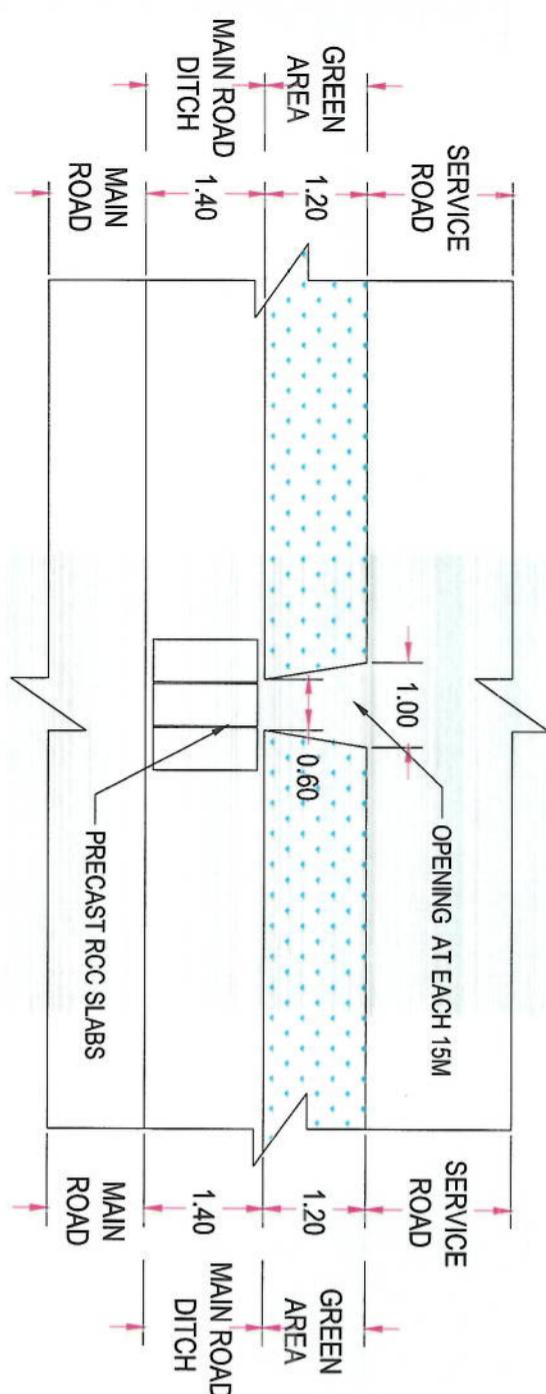

OPENING DETAIL IN MEDIUM
SCALE: NTS

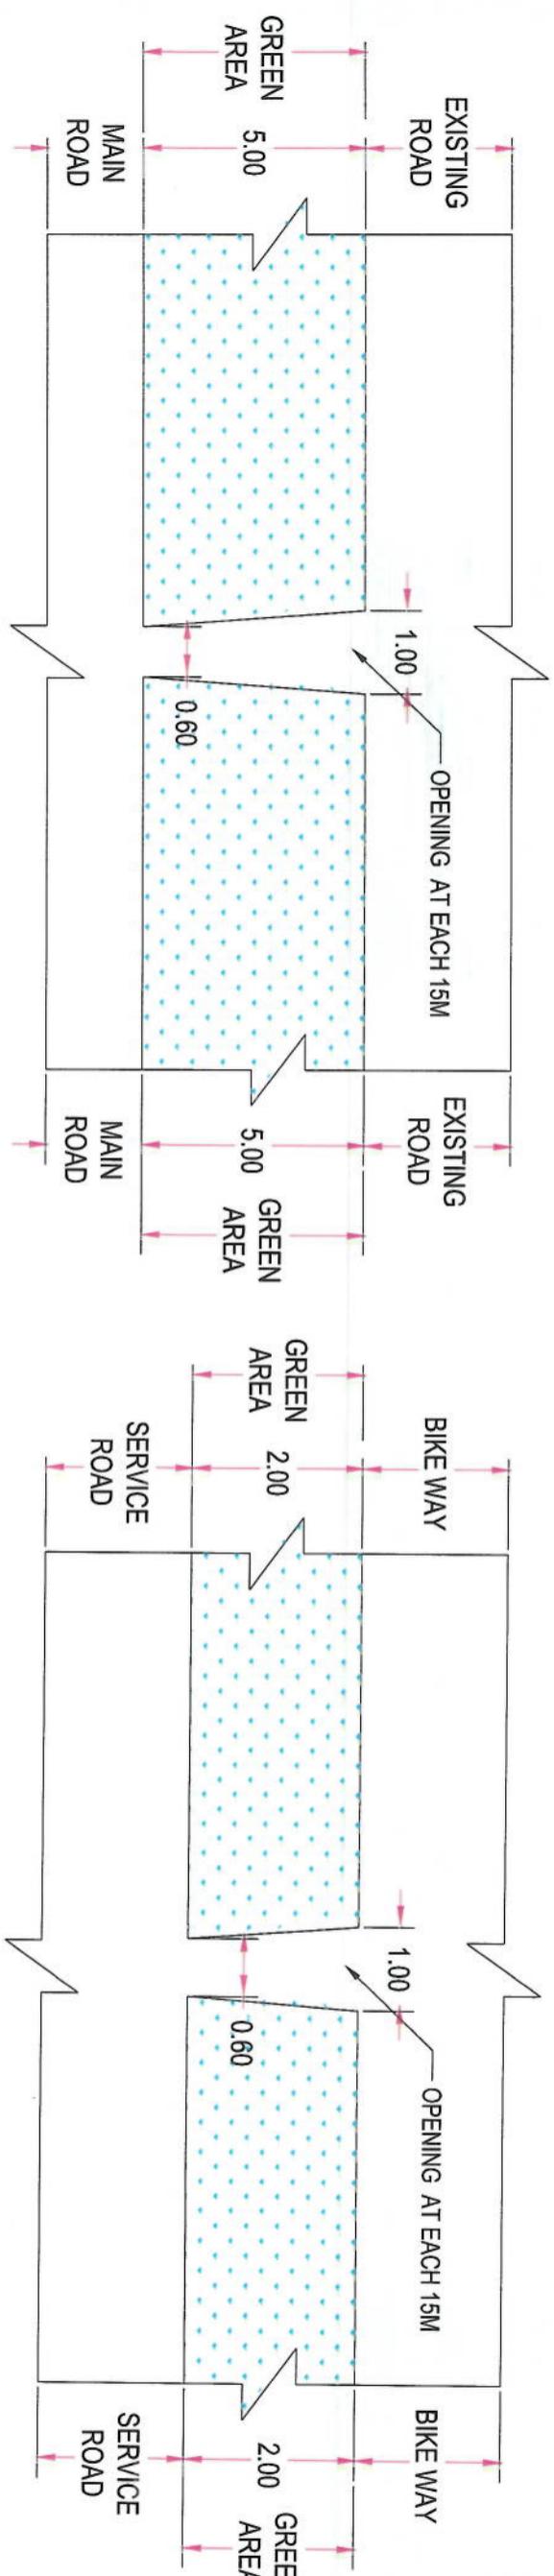

OPENING DETAIL IN RIGHT SIDE GREEN AREA
SCALE: NTS

OPENING DETAIL IN LEFT SIDE GREEN AREA
SCALE: NTS

Rev.	Date	Revision Details	Drawn/Chkd/Avpd

Designed By:

ISLAMIC EMIRATE OF
AFGHANISTAN

Project Name: KARUL MUNICIPALITY
DESIGN TEAM

Drawing Title: Cole-Sangi to Demazang road project

Green areas opening detail


Drawn: Mehmaju Rahman	Signature:
Designed: Mohammad Eisa Sani	Signature:
Checked: Hasibullah Shabizi	Signature:

Date: 06/06/2023 Seal: 1:75

Status: FINAL DESIGN

Project Code:

SHEET NO. Green areas opening detail Revision 01

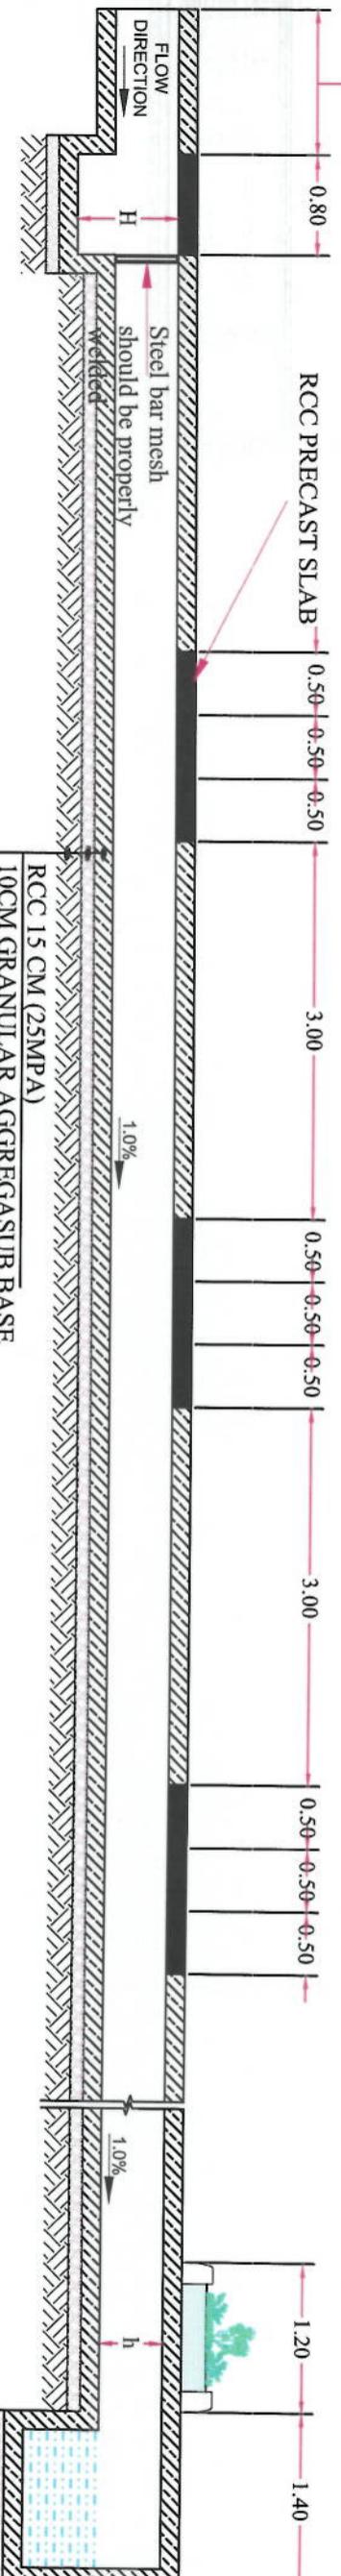


RCC 15 CM (25MPA)
10CM GRANULAR AGGREGATE BASE
MATERIAL WITH 98% COMPACTION
RE-COMPACTED SOIL
(COMPACTION=97%)

SECTION B-B FOR LINK ROADS


Ø10mm@5cm

Ø10mm@5cm


- Note:
 1-All linking roads should connected and adjusted properly to the new designed road as per site
 2- the location of RCC ditch should be followed the existing ditch in each link road and should be properly adjusted.

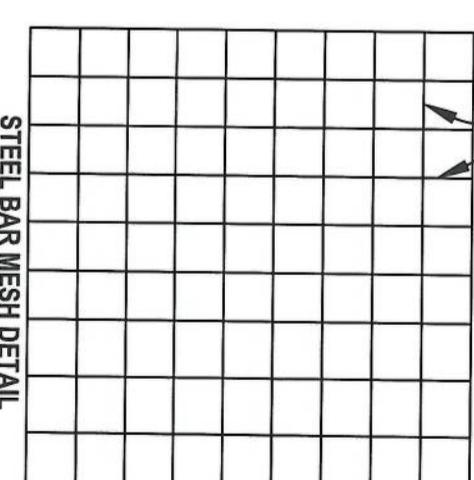

STEEL BAR MESH DETAIL

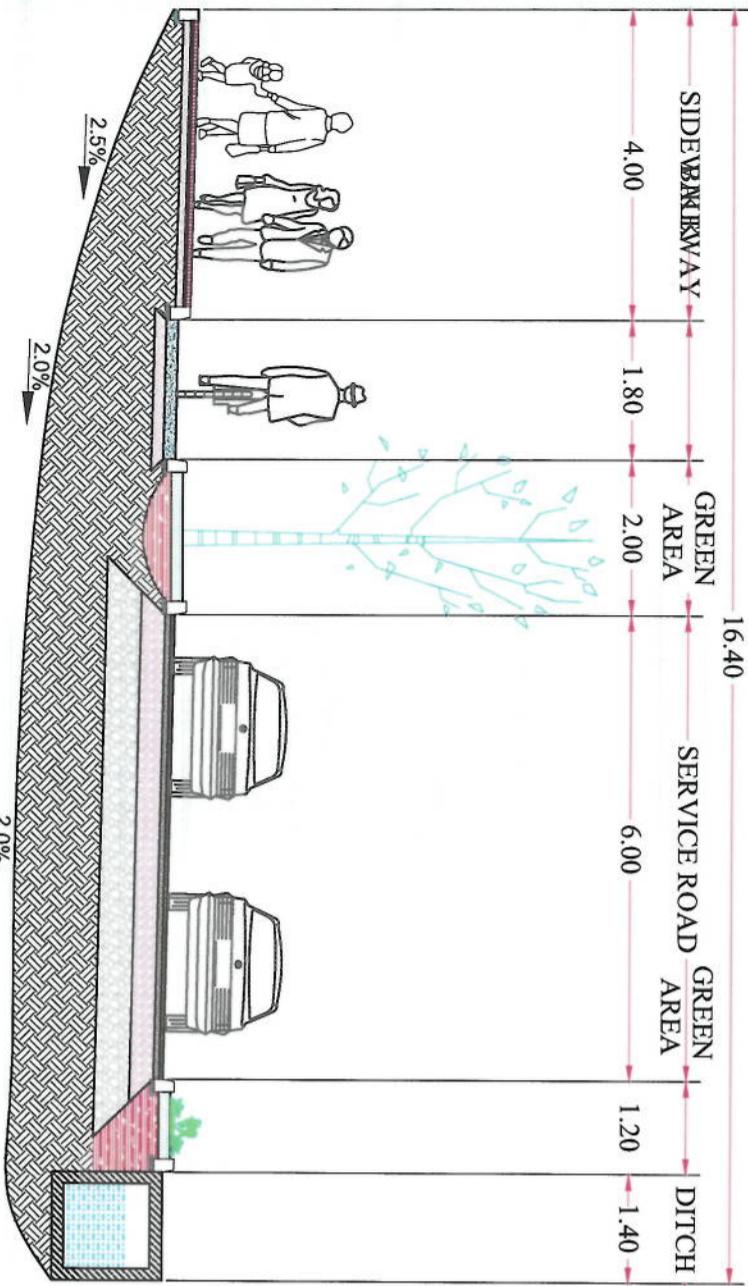

SECTION A-A FOR LINK ROADS

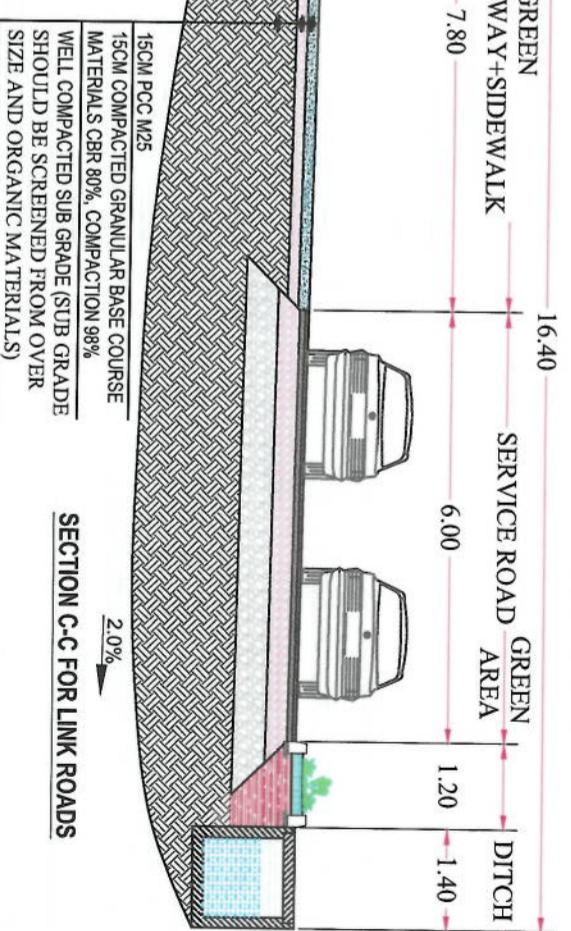

SECTION C-C FOR LINK ROADS


15CM PCC M25
15CM COMPACTED GRANULAR BASE COURSE
MATERIALS CBR 80%, COMPACTION 98%
WELL COMPACTED SUB GRADE (SUB GRADE
SHOULD BE SCREENED FROM OVER
SIZE AND ORGANIC MATERIALS)




NOTE: 1. All dimensions are in m unless otherwise indicated.

Project Name: KOT-E-SANG TO DEMAZANG ROAD PROJECT
Designed Link Road: Signature: M. Eesa Sharif
Designed Link Ditch: Signature: Abdul Shakoor Mansour
Checked: Hashibullah Shabizi
Status:


Project Code:	SHEET NO.
EID DETAIL-01	Revision 01

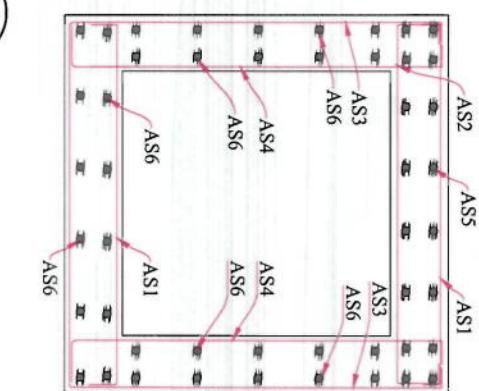


DET: LRD(A)
DETAIL OF REINFORCING SECTION(A-A)
SCALE: NTS

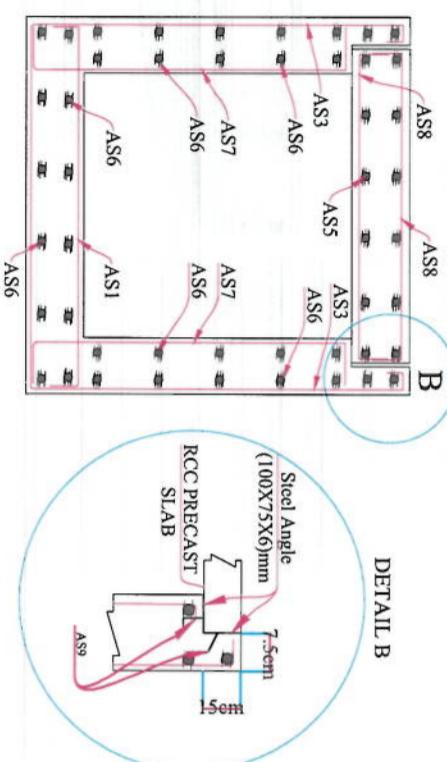


DET: LRD(A)
DETAIL OF REINFORCING SECTION (B-B)
SCALE: NTS

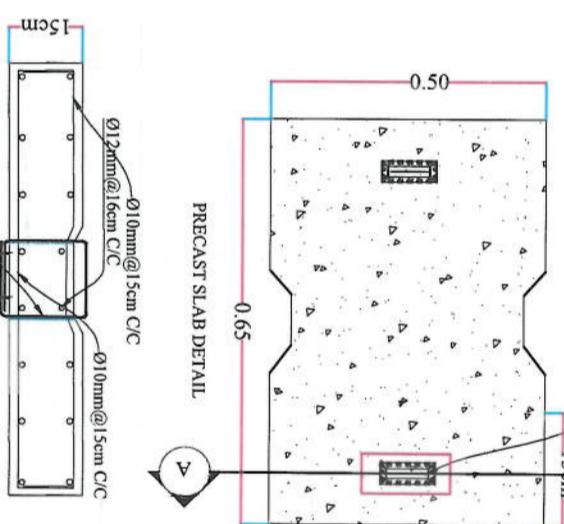


SECTION (A-A)
SCALE: NO SCALE
LIFTING HOOK DETAIL

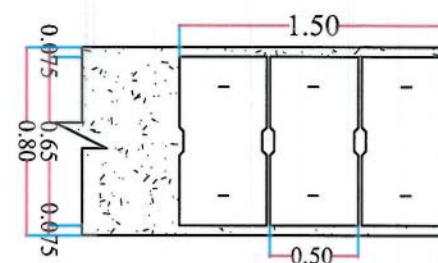


LINK ROAD DITCH PLAN TYPE (A)

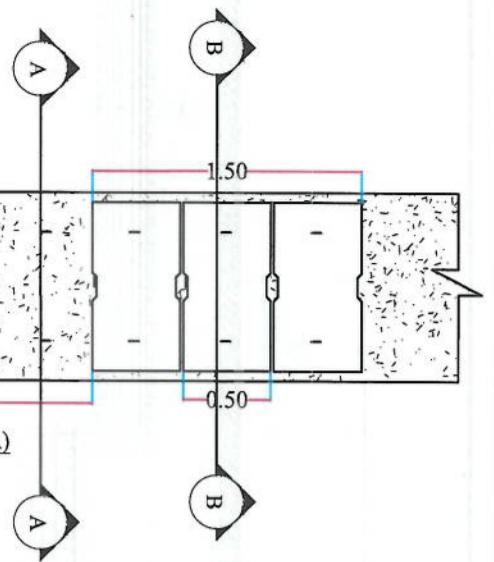

DET: LRD(A)
DETAIL SECTION(B-B)
SCALE: NTS

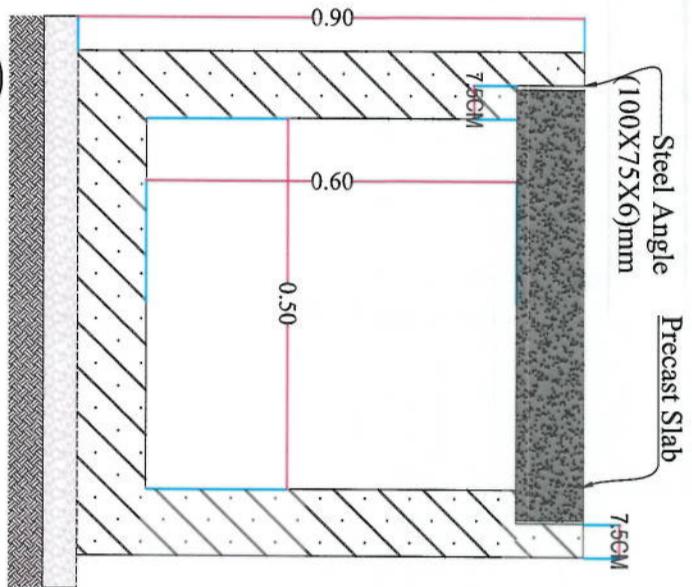

DET: LRD(A)
DETAIL SECTION(A-A)
SCALE: NTS

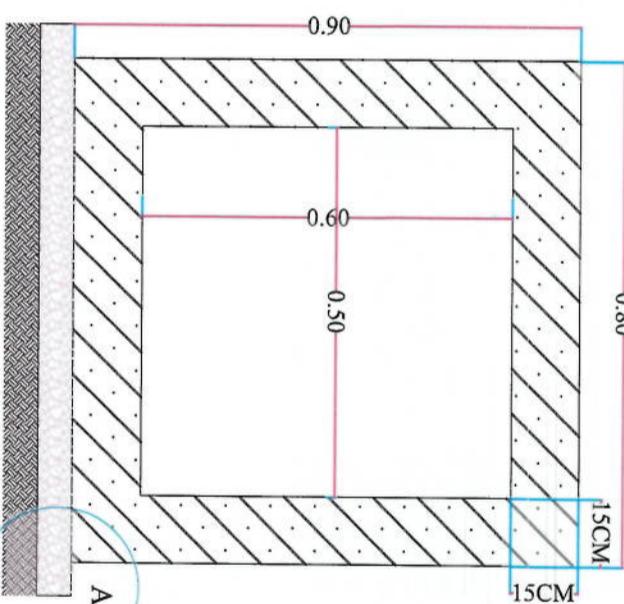

RCC 15 CM (25MPA)
10CM GRANULAR AGGREGATE SUB BASE
MATERIAL WITH 98% COMPACTION
RE-COMPACTED SOIL
(COMPACTION=97%)



DITCH (80X90)CM REINFORCEMENT SCHEDULE

Bar No.	Bar Shape	\varnothing (mm)	Spacing (mm)	Remark
As1		12	160	
As2		12	160	
As3		12	160	
As4		12	160	
As5		10	150	
As6		10	150	
As7		12	160	
As8		12	160	
As9		8	200	

NOTE:




- All dimensions are in meters unless otherwise indicated.

Date: 02/06/2023 Scale:
Status: FINEL DESIGN
Project Code:

SHEET NO. LRD(1) Revision 01

NOTE:





1. All dimensions are in meters unless otherwise indicated.

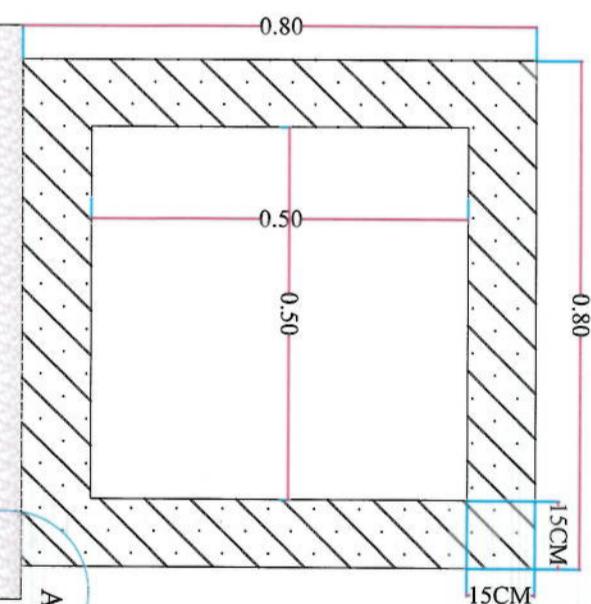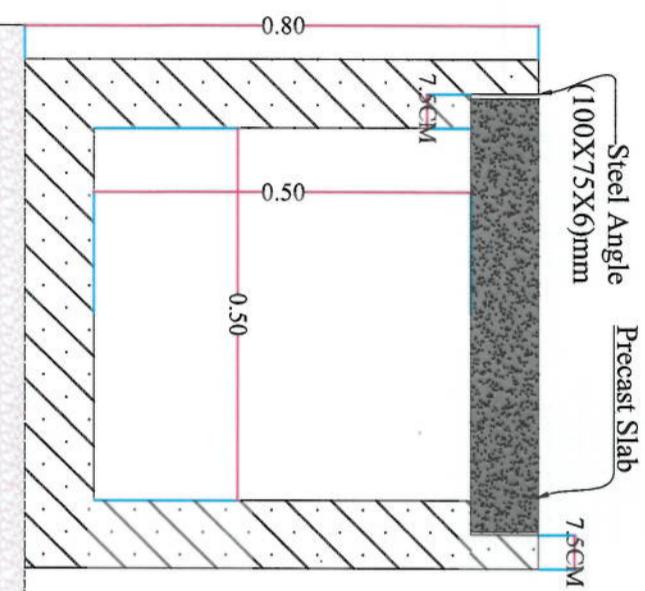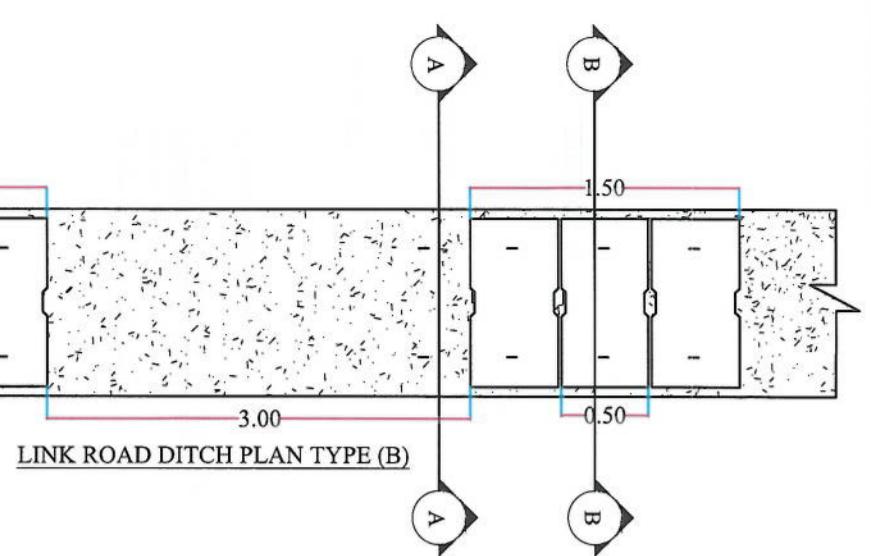

RCC 15 CM (25MPA)
10CM GRANULAR AGGREGATE SUB BASE
MATERIAL WITH 98% COMPACTION
RE-COMPACTED SOIL
(COMPACTION=97%)

DITCH (80X30) CM REINFORCEMENT SCHEDULE

Bar No	Bar Shape	\varnothing (mm)	Spacing (mm)	Remark
A1		12	160	
A2		12	160	
A3		12	160	
A4		12	160	
A5		10	150	
A6		10	150	
A7		12	160	
A8		12	160	
A9		8	200	

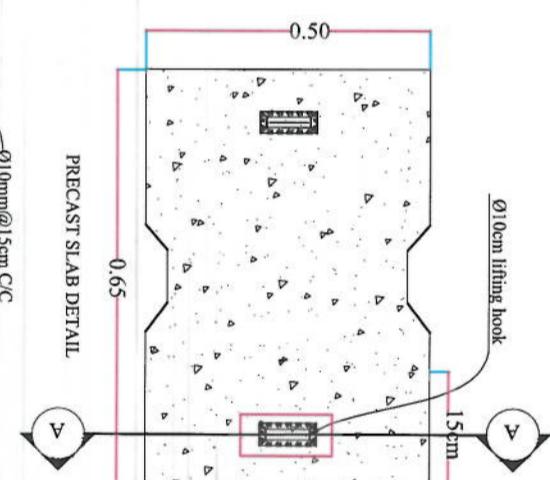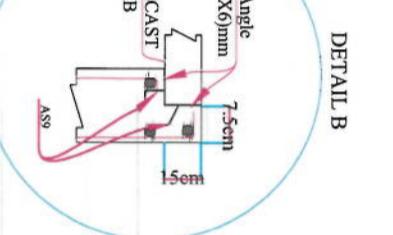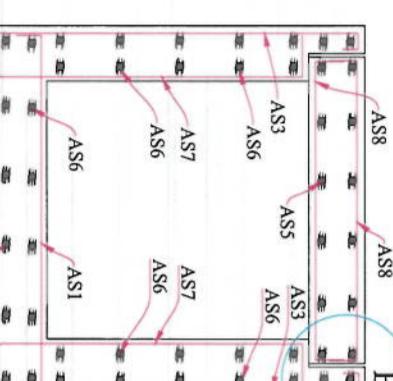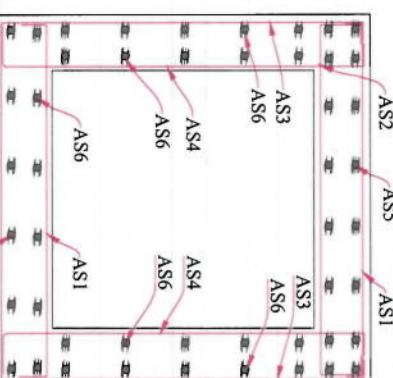

LINK ROADS DRAIN TYPICAL CROSS SECTION TYPE(B)				
Project Name:	KOT-E-SANGI TO DEMAWANG ROAD PROJECT			
Drawing Title:				
Drawn:	Nasrollah Nasri	Signature:		
Designed:	Abdul Shakoor Mansour	Signature:		
Checked:	Habibullah Sulzai	Signature:		
Date:	02/06/2023	Seal:		

KABUL MUNICIPALITY
DESIGN TEAM

ISLAMIC EMIRATE OF
AFGHANISTAN




DET: DETAIL OF REINFORCING SECTION(A-A)
SCALE: NTS
LRDT(B)

DET: DETAIL SECTION(B-B)
SCALE: NTS
LRDT(B)

PVC sleeve or
equivalent rod
SECTION (A-A)
SCALE: NO SCALE
LIFTING HOOK DETAIL

Status: FINEL DESIGN
Project Code:
SHEET NO. LRD(2) Revision 01

NOTE:
1. All dimensions are in meters unless otherwise indicated.

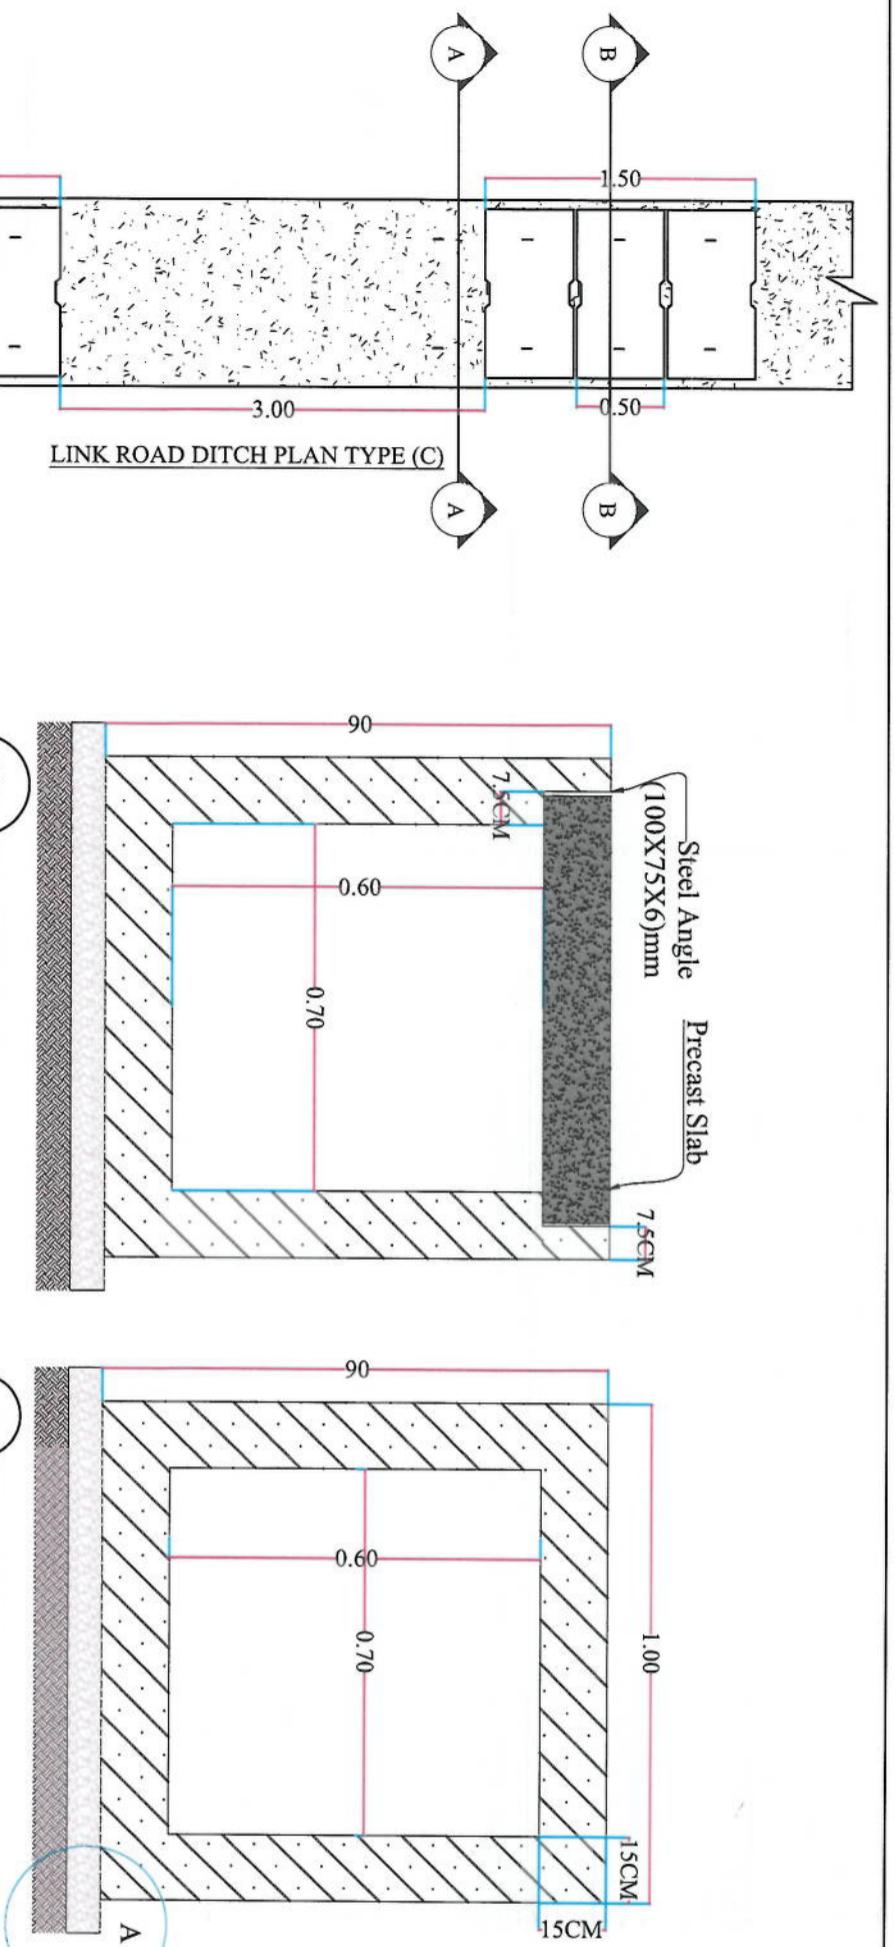


LINK ROAD DITCH PLAN TYPE (C)


DET: LRDTC
SCALE: NTS

DET: LRDTC
SCALE: NTS

RCC 15 CM (25MPA)
10CM GRANULAR AGGREGATE SUB BASE
MATERIAL WITH 98% COMPACTION
(RE-COMPACTED SOIL)
(COMPACTION=97%)

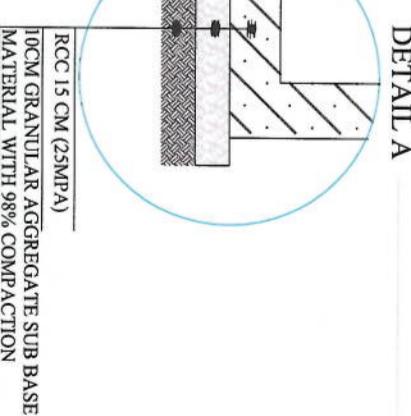

DETAIL A

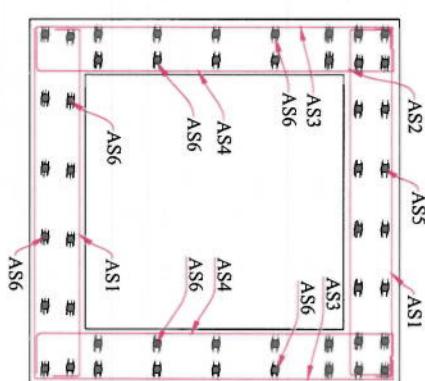

DITCH (100X90)CM REINFORCEMENT SCHEDULE

Bar No. Bar Shape Ø (mm) Spacing (mm) Remark

A51 L 12 145

A52 C 12 145

A53 C 12 145

A54 C 12 145

A55 C 10 150

A56 C 10 145

A57 C 12 145

A58 C 12 145

A59 C 8 200

KABUL MUNICIPALITY
DESIGN TEAM

ISLAMIC EMIRATE OF
AFGHANISTAN

LINK ROADS DRAIN TYPICAL CROSS
SECTION TYPE(C)

Drawing Title:


LINK ROADS DRAIN TYPICAL CROSS
SECTION TYPE(C)

Drawn: Nasirul Nasir Signature: _____
Designed: Abdul Shakoor Mansour Signature: _____
Checked: Hamidullah Shaiqi Signature: _____


Date: 02/06/2023 Scale: _____

Status: FINEL DESIGN
Project Code: _____


SHEET NO. LRD(3) Revision 01

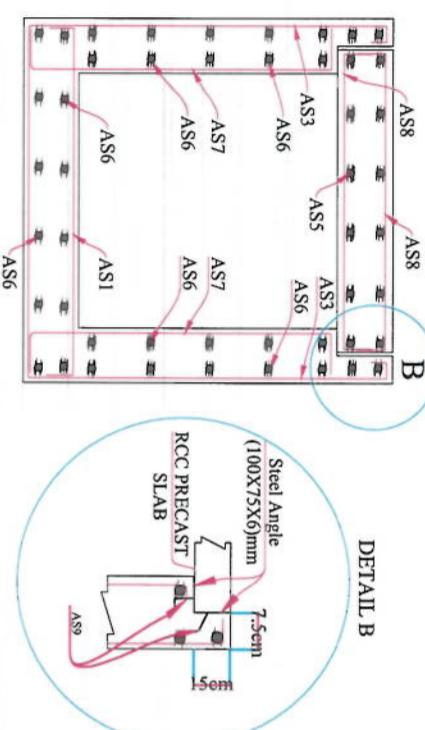

DETAIL B

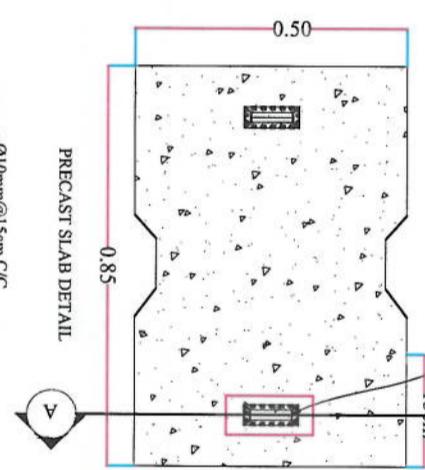

DETAIL A-A

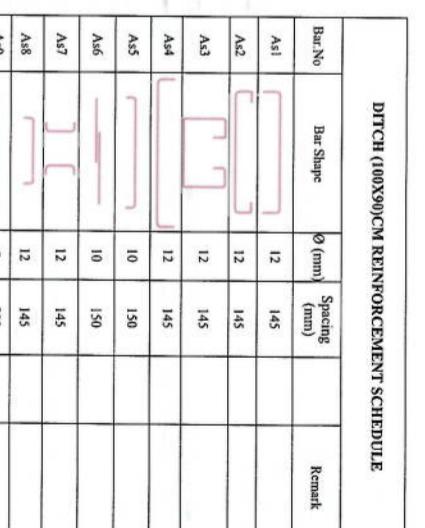

DITCH (100X90)CM REINFORCEMENT SCHEDULE

Bar No. Bar Shape Ø (mm) Spacing (mm) Remark

A51 L 12 145

A52 C 12 145

A53 C 12 145

A54 C 12 145

A55 C 10 150

A56 C 10 145

A57 C 12 145

A58 C 12 145

A59 C 8 200

KABUL MUNICIPALITY
DESIGN TEAM

ISLAMIC EMIRATE OF
AFGHANISTAN

LINK ROADS DRAIN TYPICAL CROSS
SECTION TYPE(C)

Drawing Title:


LINK ROADS DRAIN TYPICAL CROSS
SECTION TYPE(C)

Drawn: Nasirul Nasir Signature: _____
Designed: Abdul Shakoor Mansour Signature: _____
Checked: Hamidullah Shaiqi Signature: _____


Date: 02/06/2023 Scale: _____

Status: FINEL DESIGN
Project Code: _____


SHEET NO. LRD(3) Revision 01

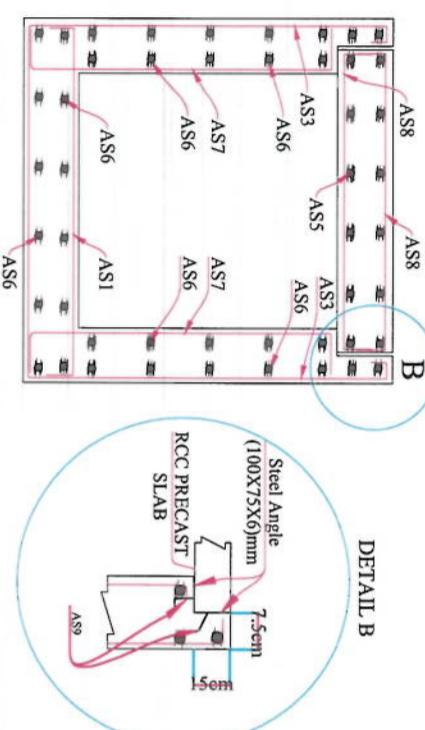

DETAIL B

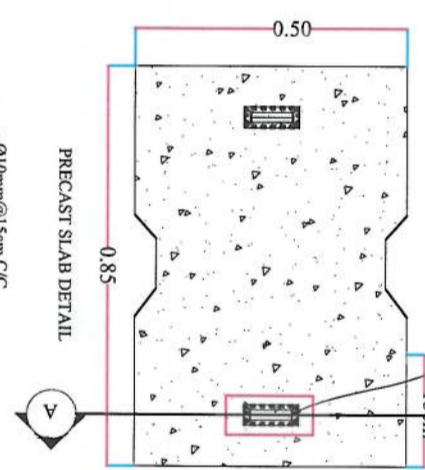

DETAIL A-A

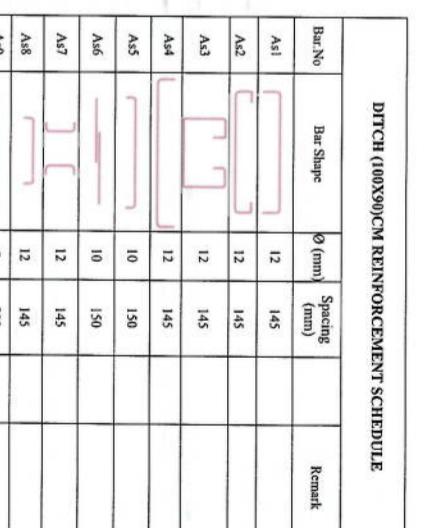

DITCH (100X90)CM REINFORCEMENT SCHEDULE

Bar No. Bar Shape Ø (mm) Spacing (mm) Remark

A51 L 12 145

A52 C 12 145

A53 C 12 145

A54 C 12 145

A55 C 10 150

A56 C 10 145

A57 C 12 145

A58 C 12 145

A59 C 8 200

KABUL MUNICIPALITY
DESIGN TEAM

ISLAMIC EMIRATE OF
AFGHANISTAN

LINK ROADS DRAIN TYPICAL CROSS
SECTION TYPE(C)

Drawing Title:


LINK ROADS DRAIN TYPICAL CROSS
SECTION TYPE(C)

Drawn: Nasirul Nasir Signature: _____
Designed: Abdul Shakoor Mansour Signature: _____
Checked: Hamidullah Shaiqi Signature: _____


Date: 02/06/2023 Scale: _____

Status: FINEL DESIGN
Project Code: _____


SHEET NO. LRD(3) Revision 01

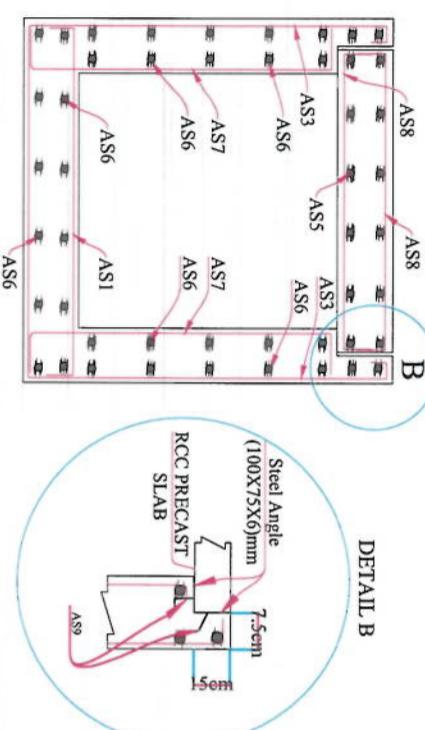

DETAIL B

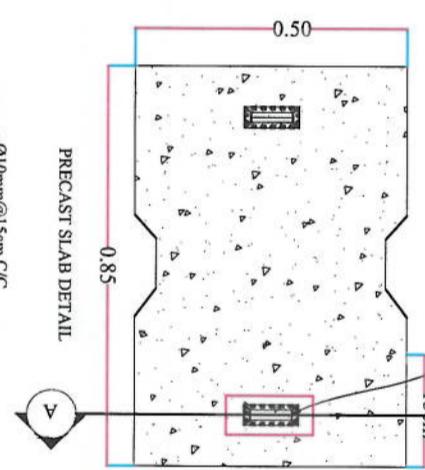

DETAIL A-A

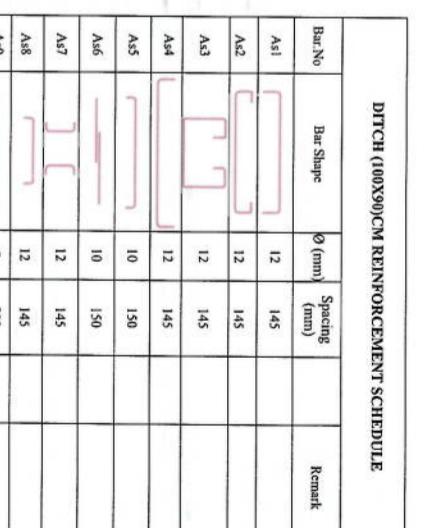

DITCH (100X90)CM REINFORCEMENT SCHEDULE

Bar No. Bar Shape Ø (mm) Spacing (mm) Remark

A51 L 12 145

A52 C 12 145

A53 C 12 145

A54 C 12 145

A55 C 10 150

A56 C 10 145

A57 C 12 145

A58 C 12 145

A59 C 8 200

KABUL MUNICIPALITY
DESIGN TEAM

ISLAMIC EMIRATE OF
AFGHANISTAN

LINK ROADS DRAIN TYPICAL CROSS
SECTION TYPE(C)

Drawing Title:


LINK ROADS DRAIN TYPICAL CROSS
SECTION TYPE(C)

Drawn: Nasirul Nasir Signature: _____
Designed: Abdul Shakoor Mansour Signature: _____
Checked: Hamidullah Shaiqi Signature: _____


Date: 02/06/2023 Scale: _____

Status: FINEL DESIGN
Project Code: _____


SHEET NO. LRD(3) Revision 01

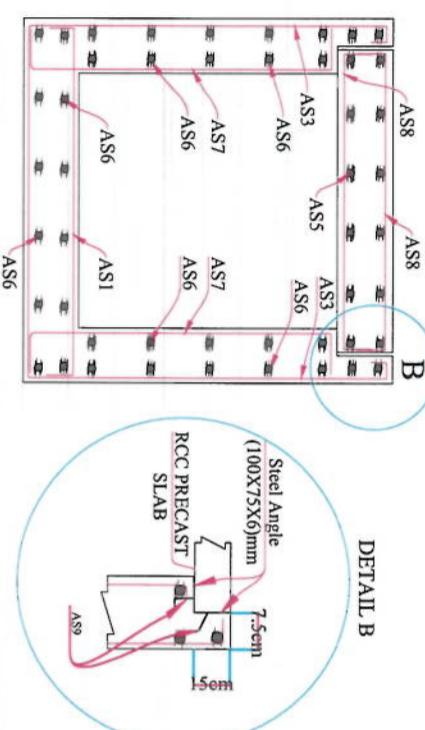

DETAIL B

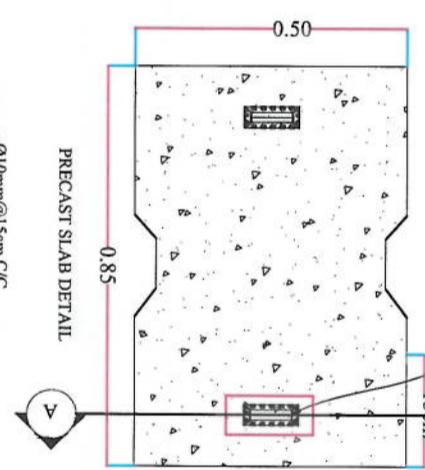

DETAIL A-A

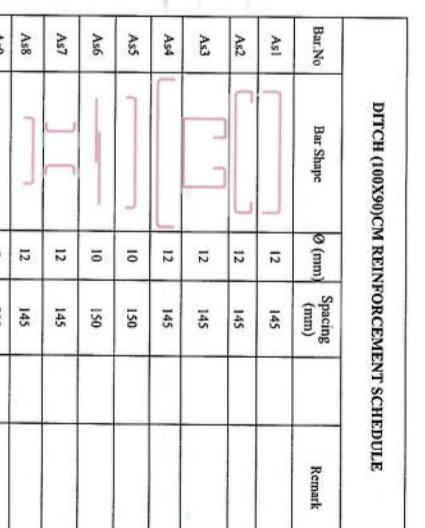

DITCH (100X90)CM REINFORCEMENT SCHEDULE

Bar No. Bar Shape Ø (mm) Spacing (mm) Remark

A51 L 12 145

A52 C 12 145

A53 C 12 145

A54 C 12 145

A55 C 10 150

A56 C 10 145

A57 C 12 145

A58 C 12 145

A59 C 8 200

KABUL MUNICIPALITY
DESIGN TEAM

ISLAMIC EMIRATE OF
AFGHANISTAN

LINK ROADS DRAIN TYPICAL CROSS
SECTION TYPE(C)

Drawing Title:


LINK ROADS DRAIN TYPICAL CROSS
SECTION TYPE(C)

Drawn: Nasirul Nasir Signature: _____
Designed: Abdul Shakoor Mansour Signature: _____
Checked: Hamidullah Shaiqi Signature: _____


Date: 02/06/2023 Scale: _____

Status: FINEL DESIGN
Project Code: _____


SHEET NO. LRD(3) Revision 01

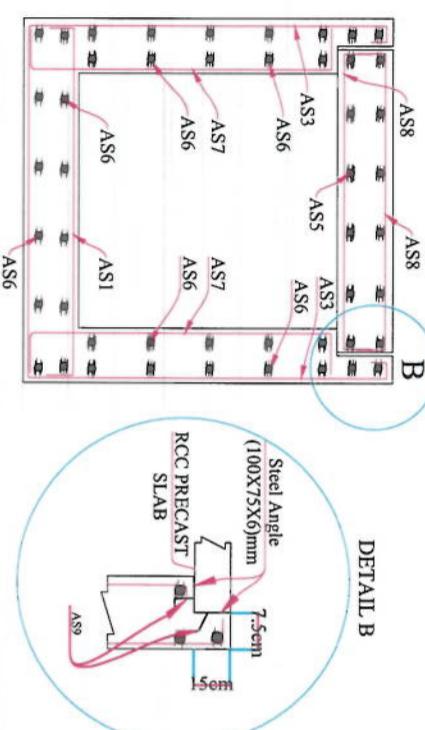

DETAIL B

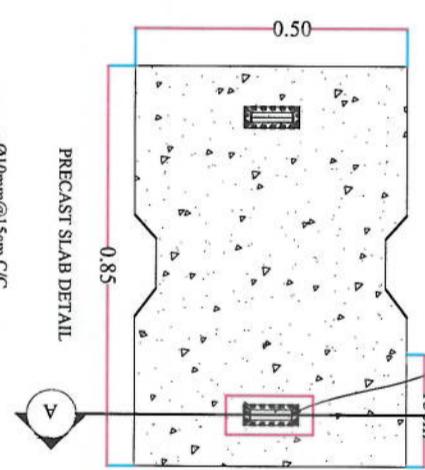

DETAIL A-A

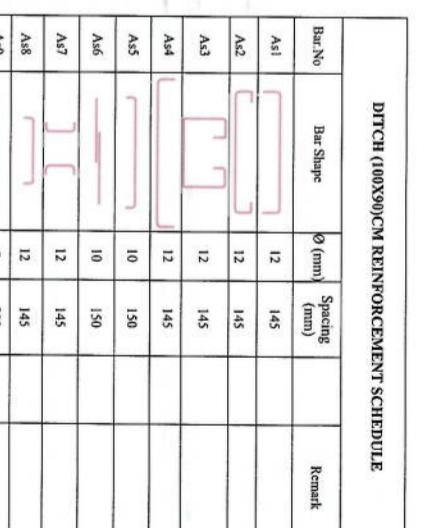

DITCH (100X90)CM REINFORCEMENT SCHEDULE

Bar No. Bar Shape Ø (mm) Spacing (mm) Remark

A51 L 12 145




A52 C 12 145

A53 C 12 145

A54 C 12 145

NOTE:

1. All dimensions are in meter unless
otherwise indicated.

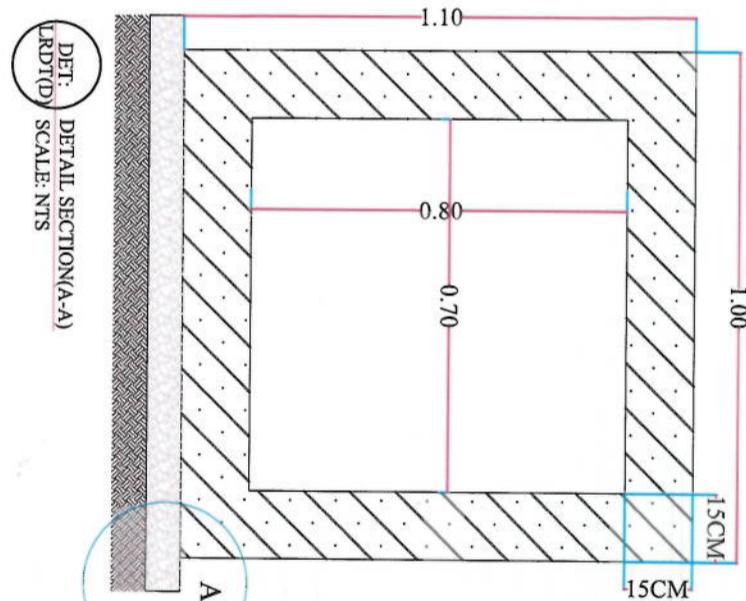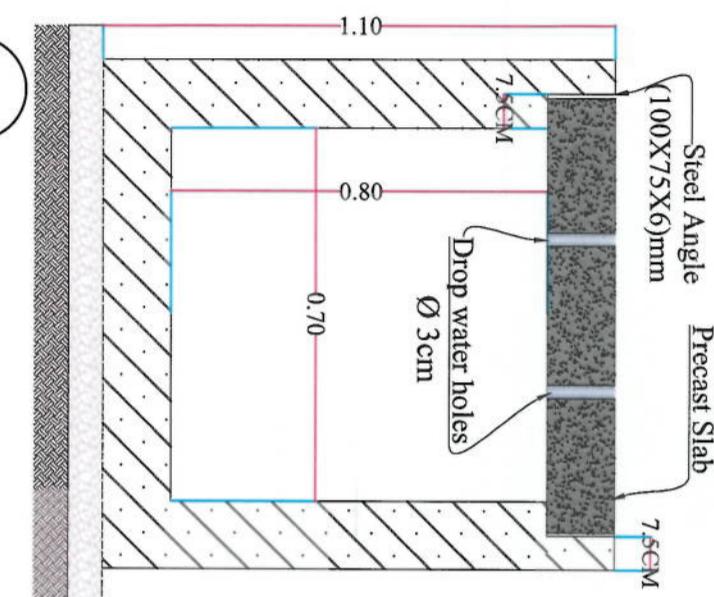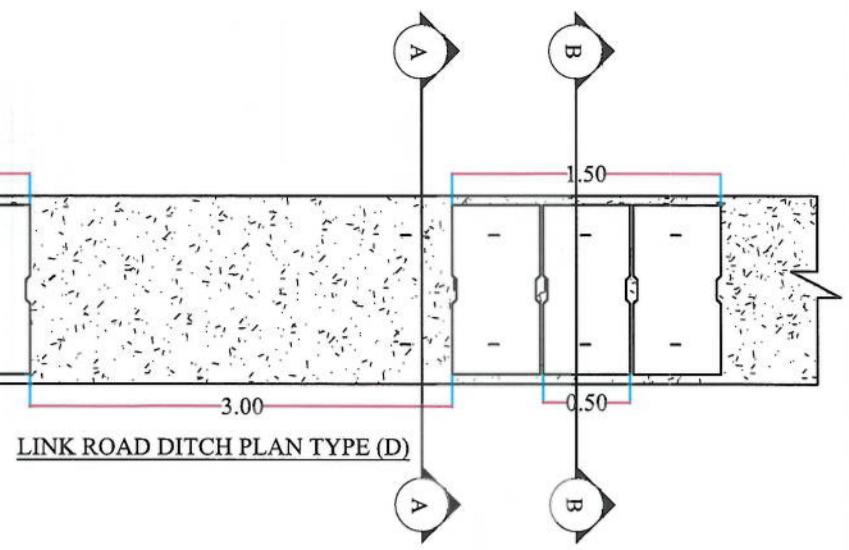

RCC 15 CM (25MPA)
10CM GRANULAR AGGREGATE SUB BASE
MATERIAL WITH 98% COMPACTION
RE-COMPACTED SOIL
(COMPACTION=97%)



DITCH (100X10)CM REINFORCEMENT SCHEDULE

Bar No.	Bar Shape	\varnothing (mm)	Spacing (mm)	Remark
A1	[L-shaped]	12	145	
A2	[L-shaped]	12	145	
A3	[L-shaped]	12	145	
A4	[L-shaped]	12	145	
A5	[L-shaped]	10	150	
A6	[L-shaped]	10	150	
A7	[L-shaped]	12	145	
A8	[L-shaped]	12	145	
A9	[L-shaped]	8	200	

Drawn:	Nasirullah Nasir	Signature:
Designed:	Abdul Shakoor Munawar	Signature:
Checked:	Hassanullah Shahzai	Signature:
Date:	02/06/2023	Scale:


DET: DETAIL OF REINFORCING SECTION(A-A)
LRDT(D) SCALE: NTS

DET: DETAIL SECTION(B-B)
LRDT(D) SCALE: NTS

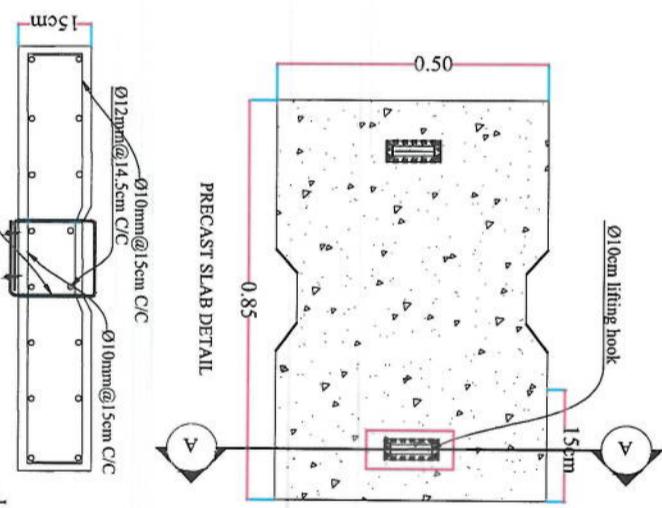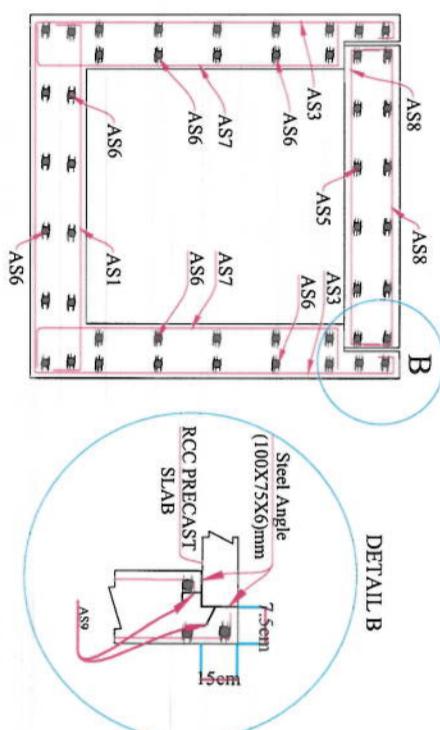

DET: DETAIL OF REINFORCING SECTION (A-A)
LRDT(D) SCALE: NTS

DET: DETAIL SECTION(B-B)
LRDT(D) SCALE: NTS

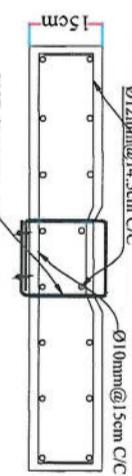


PVC sleeve or equivalent rod	$\varnothing 12\text{mmf} @ 14.5\text{cm C/C}$	$\varnothing 10\text{mm} @ 15\text{cm C/C}$	$\varnothing 10\text{mm} @ 15\text{cm C/C}$
SECTION (A-A)	0.50	0.85	1.5cm

Lifting hook detail	A	15cm
shall be bolted		

SHEET NO. LRD(4) Revision 01

Status: FINEL DESIGN
Project Code:

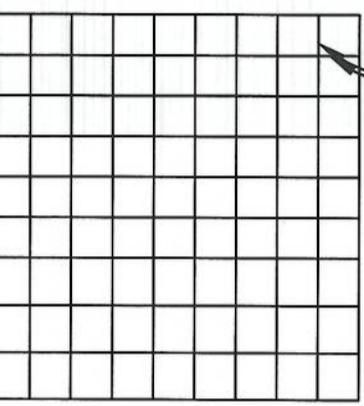

DITCH (100X110) CM REINFORCEMENT SCHEDULE

DET: LRDCA(A) DETAIL SECTION(B-B)

SCALE: NTS

SECTION (A-A)

SCALE: NO SCALE

KABUL MUNICIPALITY
DESIGN TEAM

ISLAMIC EMIRATE OF
AFGHANISTAN

Designed By:

Project Name:
KOT-E-SANGI TO DEHMAZANG
ROAD PROJECT

Drawing Title:

CATCH BASIN DETAIL
TYPE(A)

Drawn: Nasrullah Nasri Signature:

Designed: Abdul Shakoor Mansour Signature:

Checked: Haibullah Shazai Signature:

Date: 02/06/2023 Scale: 1:500





Status: FINEL DESIGN

Project Code:

SHEET NO. CBD(1) Revision 01

NOTE:

1. All dimensions are in meters unless otherwise indicated.

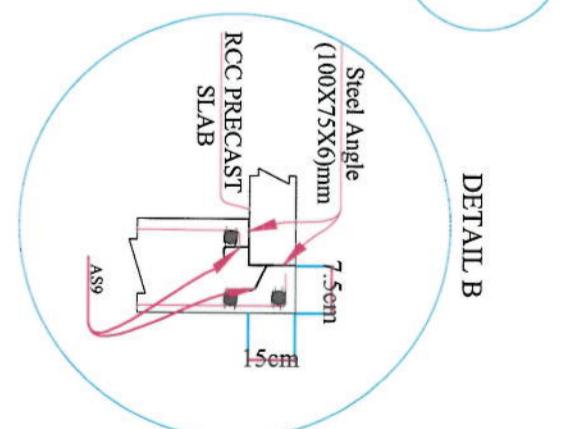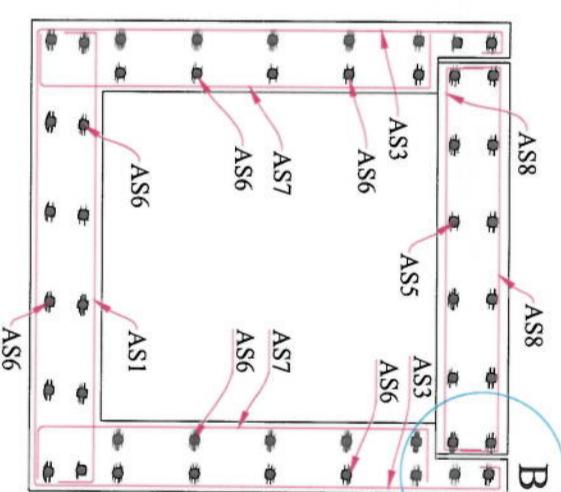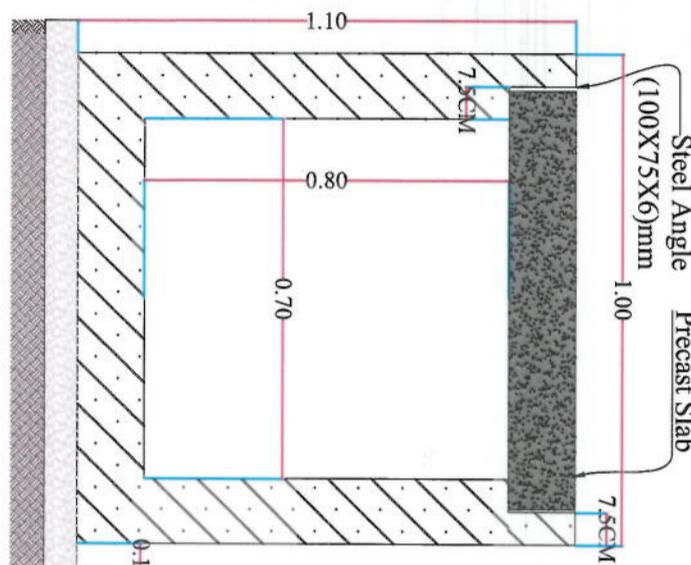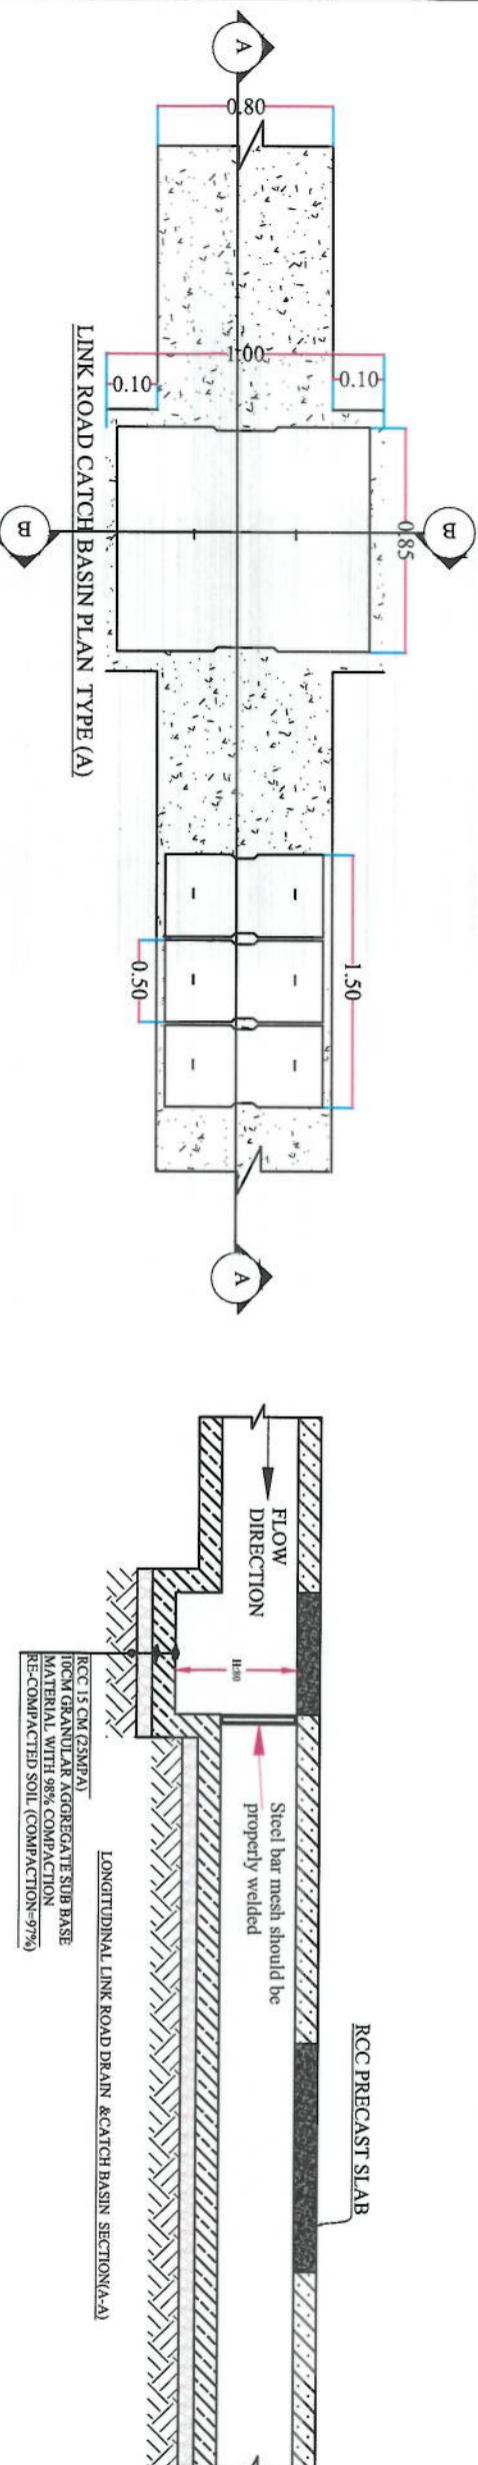

KABUL MUNICIPALITY
DESIGN TEAM

ISLAMIC EMIRATE OF
AFGHANISTAN

Designed By:

Project Name:
KOT-E-SANGI TO DEHMAZANG
ROAD PROJECT

Drawing Title:

CATCH BASIN DETAIL
TYPE(A)

Drawn: Nasrullah Nasri Signature:

Designed: Abdul Shakoor Mansour Signature:


Checked: Haibullah Shazai Signature:

Date: 02/06/2023 Scale: 1:500




Status: FINEL DESIGN

Project Code:

SHEET NO. CBD(1) Revision 01

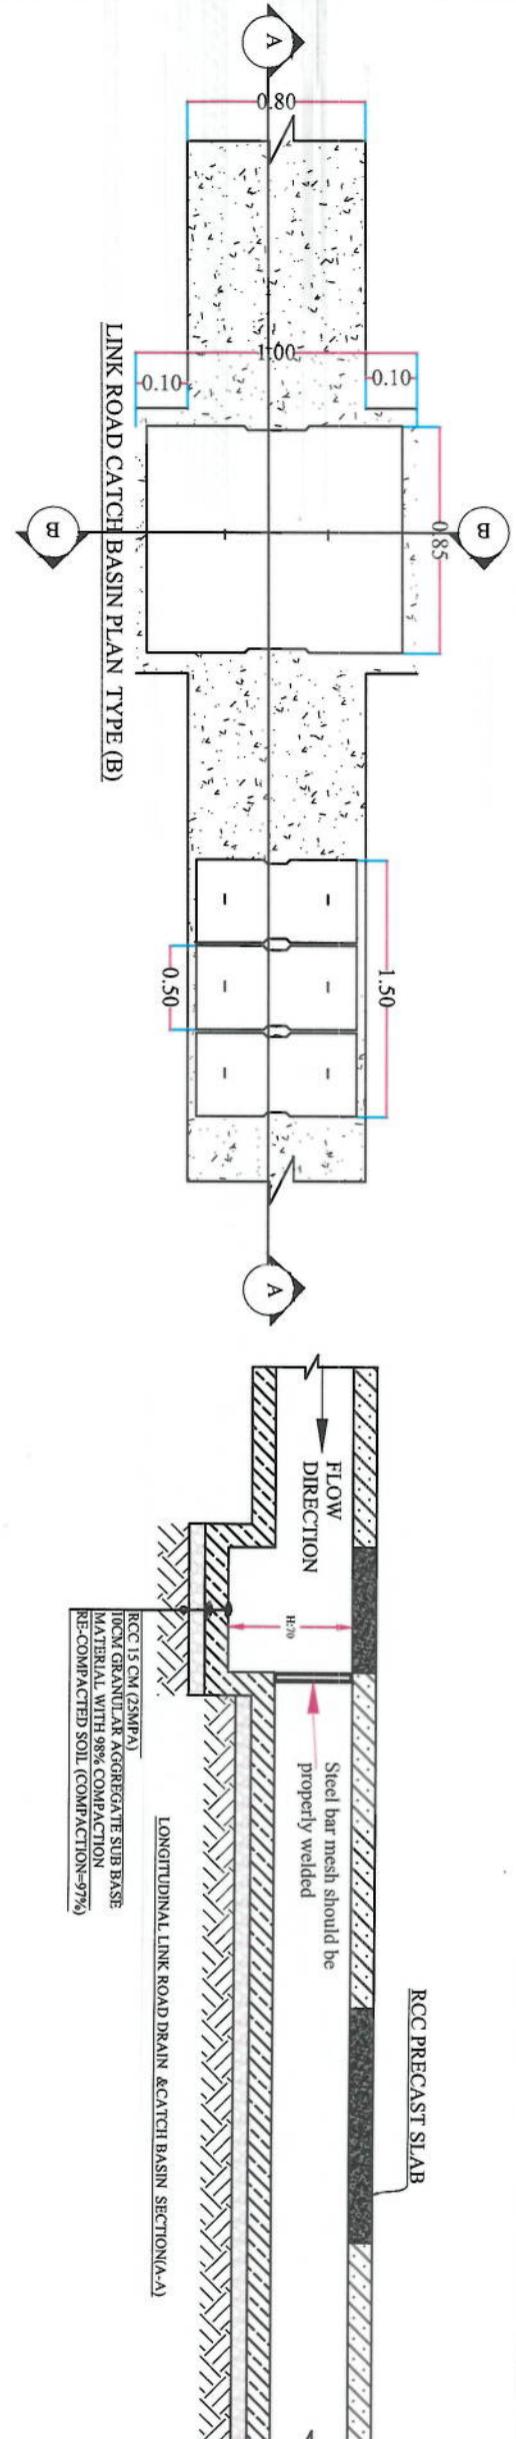

LINK ROAD CATCH BASIN PLAN TYPE (B)

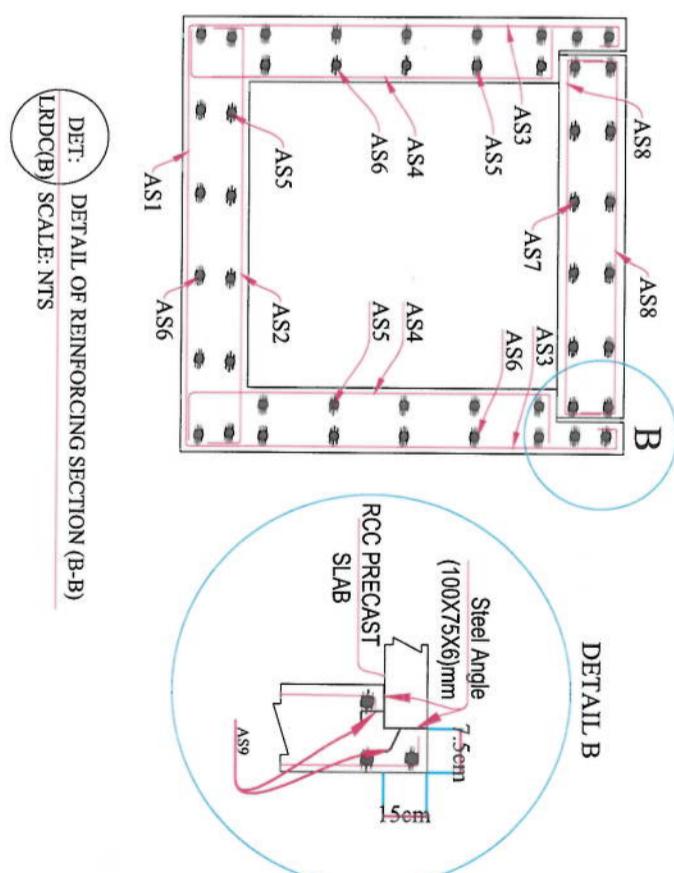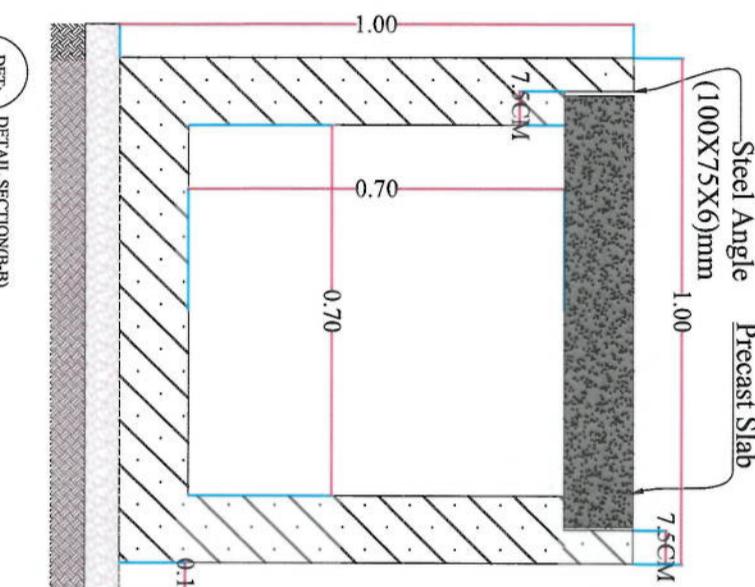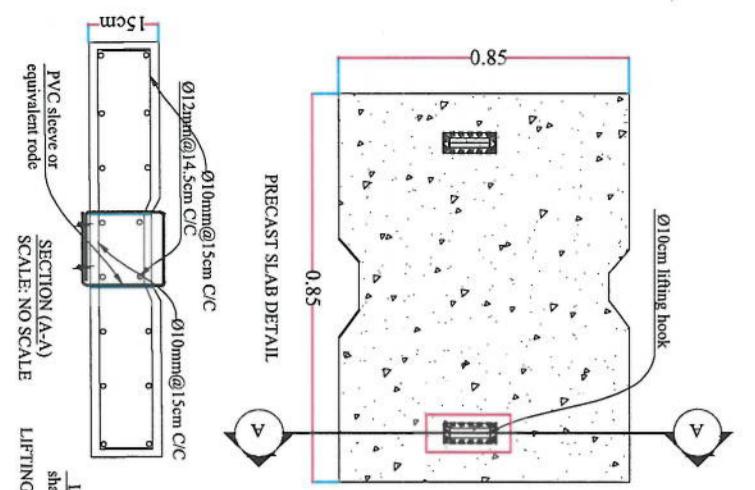


DET: DETAIL OF REINFORCING SECTION (B-B)
[LRDC(B)]
SCALE: NTS

ISLAMIC EMIRATE OF
AFGHANISTAN
KABUL MUNICIPALITY
DESIGN TEAM
Project Name:
KOTE-SANGI TO DEMAZANG
ROAD PROJECT
Drawing Title:

CATCH BASIN DETAIL
TYPE (B)

Drawn: *[Signature]* Signature: *[Signature]*
Designed: *[Signature]* Signature: *[Signature]*
Checked: *[Signature]* Signature: *[Signature]*

Date: 02/06/2023 Scale: 1:500
Status: FINEL DESIGN
Project Code: CBDQ1
Sheet No: 01
Revision:

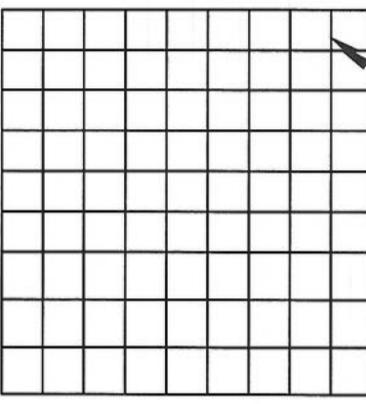



STEEL BAR MESH DETAIL

DITCH (100X100)CM REINFORCEMENT SCHEDULE

Bar No.	Bar Size	Ø (mm)	Spanning (mm)	Remark
A1		12	145	
A2		12	145	
A3		12	145	
A4		12	145	
A5		10	190	
A6		10	190	
A7		12	145	
A8		12	145	
A9		8	200	

NOTE:
1. All dimensions are in meters unless otherwise indicated.


LINK ROAD CATCH BASIN PLAN TYPE (A)

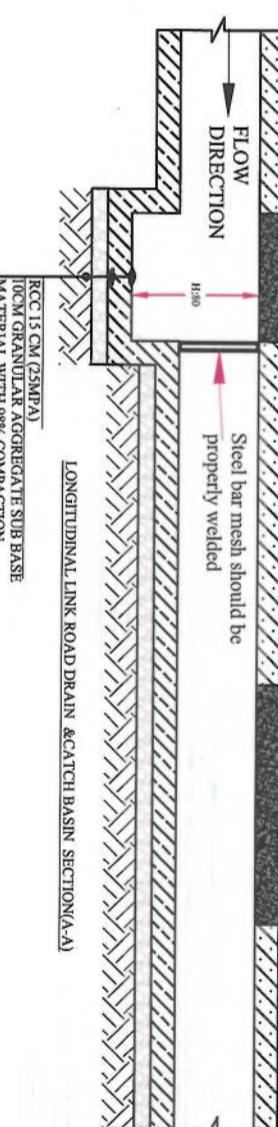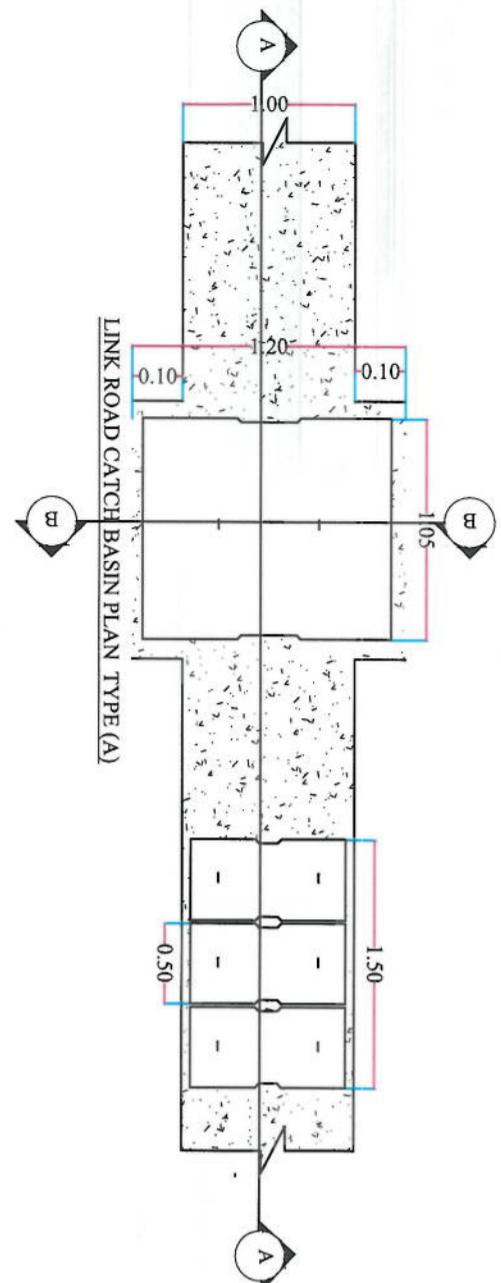

Ø10cm Lifting hook

Steel Angle
(100X75X6)mm
Precast Slab
7.5cm
1.20
7.5cm


DETAIL B

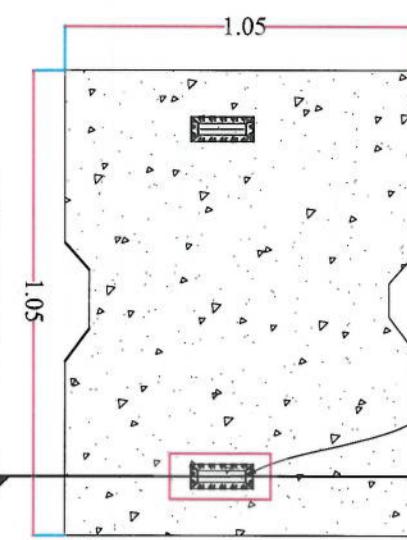

PRECAST SLAB DETAIL

A

A

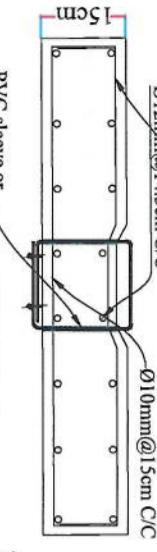

PVC sleeve or
equivalent rod

SECTION (A-A)

LIFTING HOOK DETAIL

Ø10mm@5cm


Ø10mm@15cm C/C
Ø10mm@15cm C/C

15cm

DET: LRDCC
DETAIL SECTION(B-B)
SCALE: NTS

DET: LRDCC
DETAIL SECTION(B-B)
SCALE: NTS

DET: LRDCC
DETAIL SECTION(B-B)
SCALE: NTS

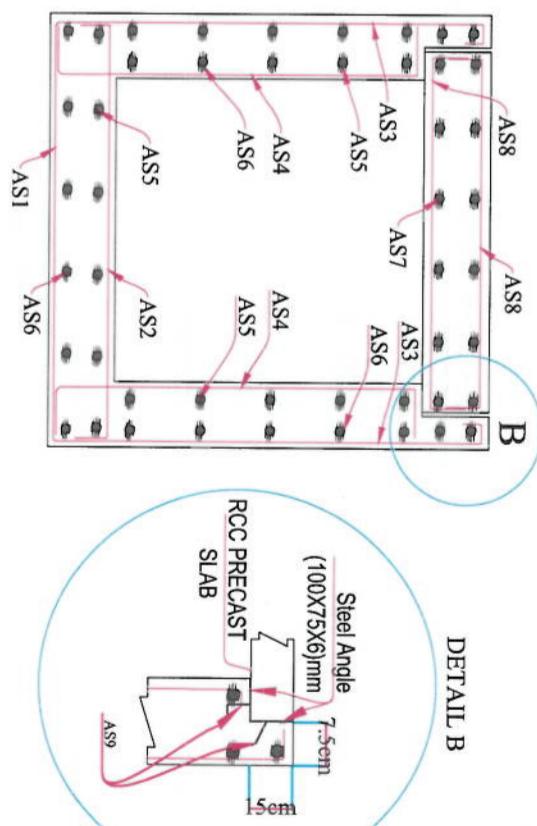

ISLAMIC EMPIRE OF
AFGHANISTAN
KABUL MUNICIPALITY
DESIGN TEAM
KOFE-SANGI TO DEMHAWZANG
ROAD PROJECT

Designed By:

Project Name:
KOFE-SANGI TO DEMHAWZANG
ROAD PROJECT

Drawing Title:

CATCH BASIN DETAIL
TYPE (C)

Drawn:

Nasirullah Nasir

Signature:

Designated:

Abdul Shakoor Mansour

Signature:

Checked:

Hanbulah Shafiq

Signature:

Approved:

Date:

02/06/2023

Scale:

1:500

Status:

FINAL DESIGN

Project Code:

SHEET NO:

CRD(3)


Revision:

01



NOTE:

- All dimensions are in meters unless otherwise indicated.

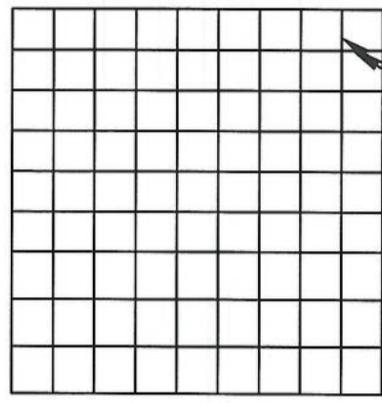

STEEL BAR MESH DETAIL

DITCH (120X110)CM REINFORCEMENT SCHEDULE:


Bar No.	Bar Shape	Ø (mm)	Spacing (mm)	Remark
A1		12	145	
A2		12	145	
A3		12	145	
A4		12	145	
A5		10	150	
A6		10	150	
A7		12	145	
A8		12	145	
A9		8	200	

Note:
 1- where ever the level of design profile is upper than existing road edge it is recommended to follow the existing road edge as control level.
 2- where ever the design profile is lower than existing road edge, then right side curb stone of center median should follow the design profile as the control level.



3- In case of changing in typical cross section type all components should be adjusted properly.
 4- All bed levels of new ditches should be adjusted to the existing paved roads both at start and at the end property.

NOTE:
 1- The lengths of all new side ditches have shown on the plan.
 2- The finished level of new roads should be adjusted to the existing paved roads both at start and at the end property.
 3- In case of changing in typical cross section type all components should be adjusted properly.
 4- All bed levels of new ditches should be adjusted to the existing paved roads both at start and at the end property.
 5- Because of residential area on the site, the survey design has done based on the survey with less accuracy and it is necessary to re-survey the area after the demolition of houses.

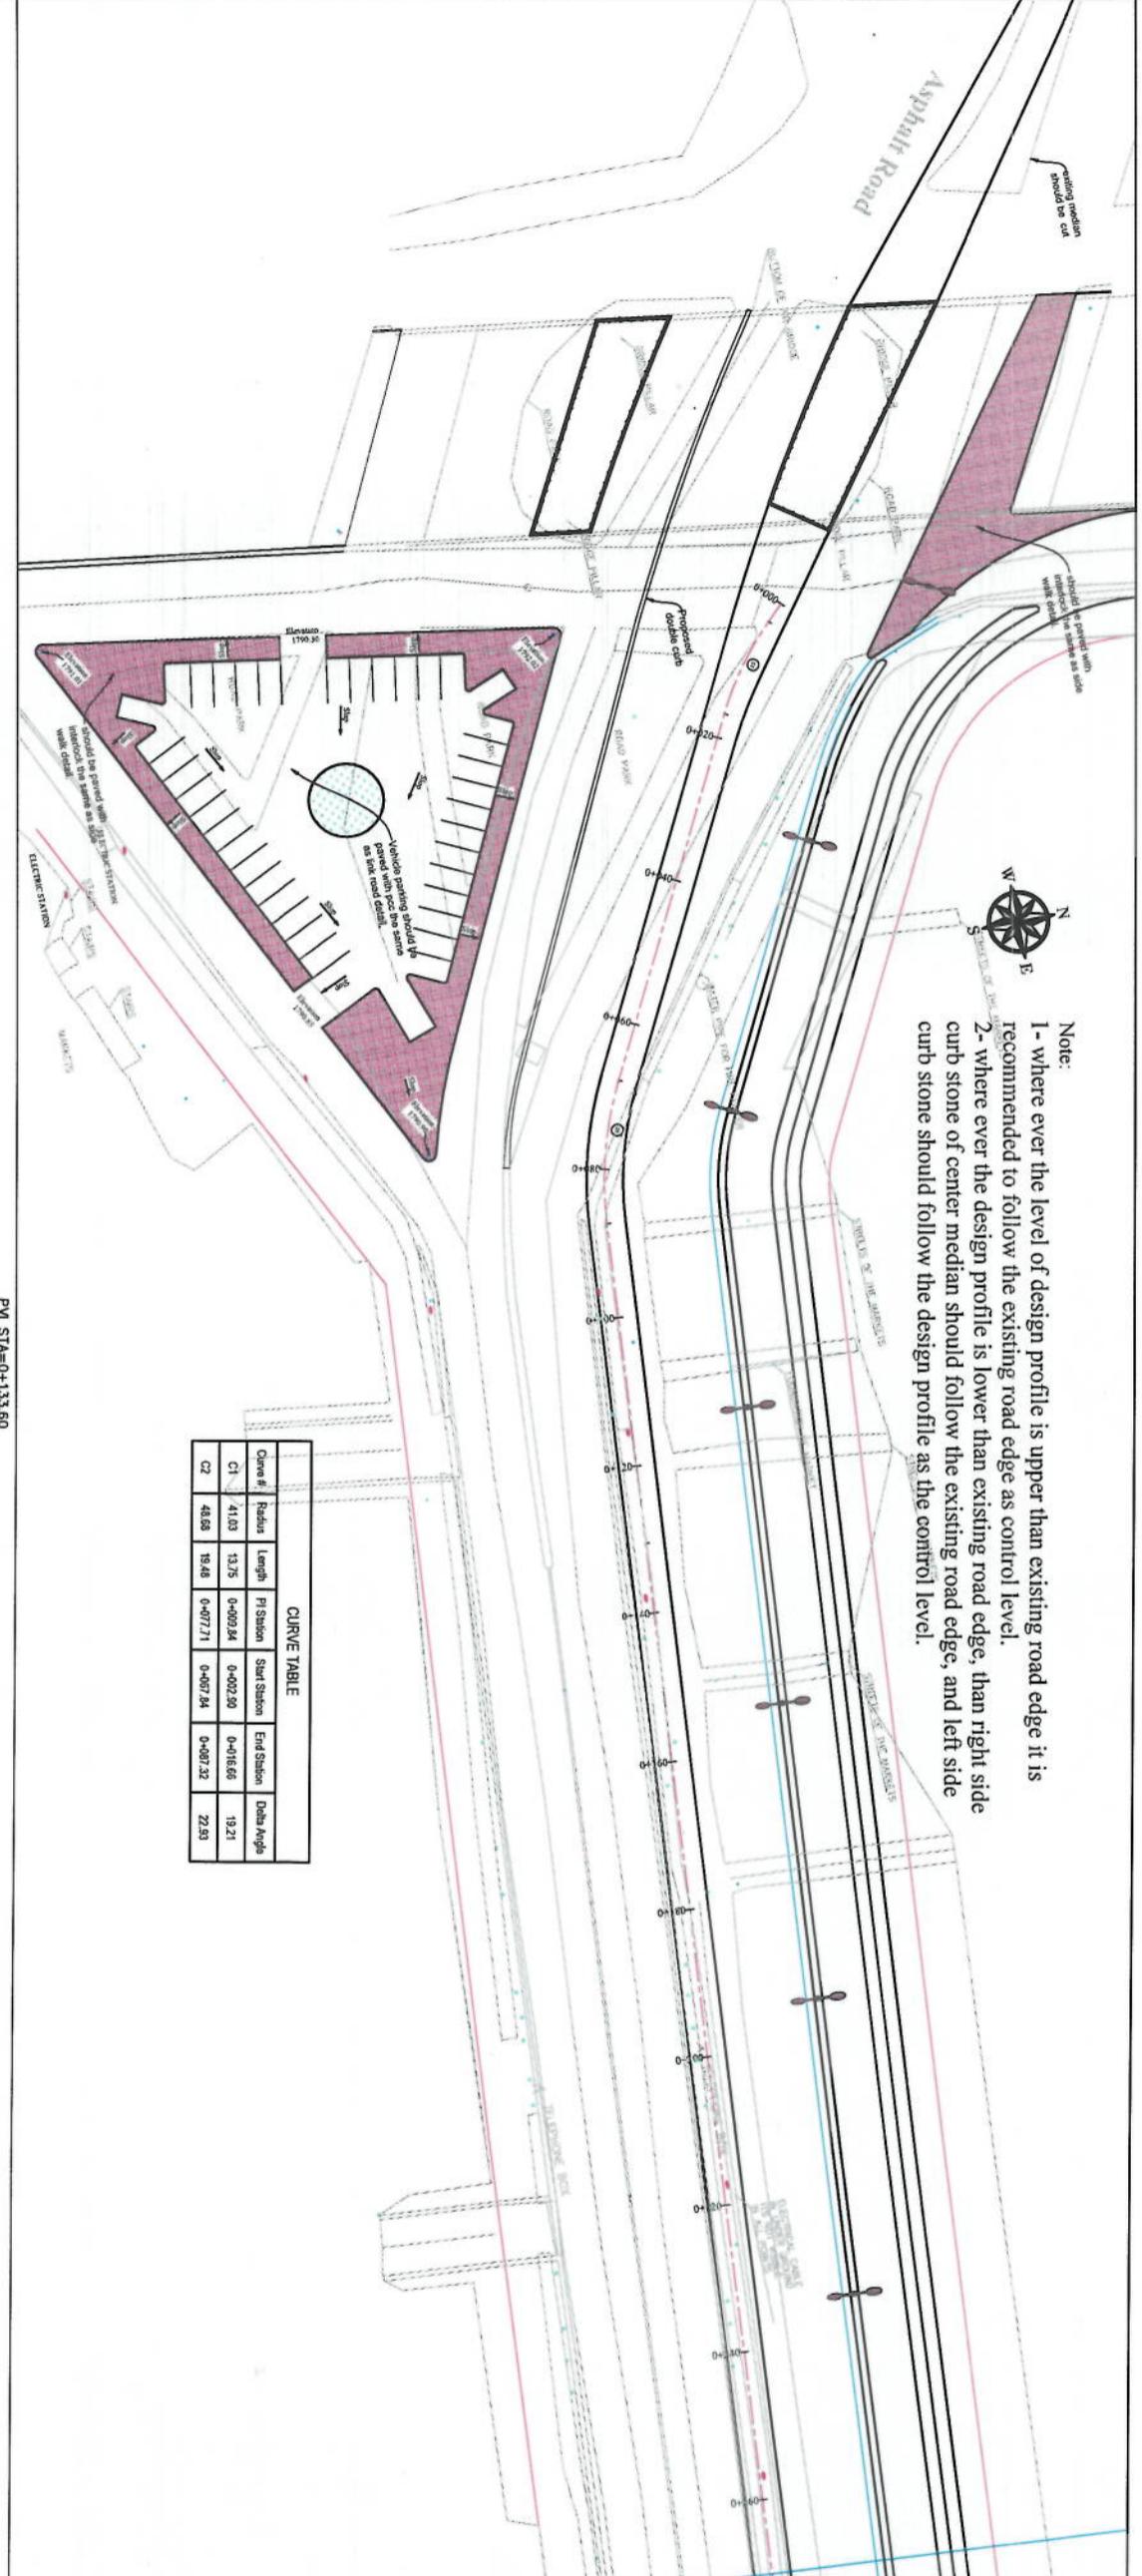

CURVE TABLE					
Curve #	Radius	Length	Pt Station	Start Station	End Station
C1	41.03	13.75	0+09.34	0+02.50	0+16.65
C2	48.68	18.48	0+07.71	0+07.84	0+07.32

PVI STA=0+133.60
PVI ELEV=789.95
LVC=94.19
K=278.47

ISLAMIC EMIRATE OF
AFGHANISTAN
KABUL MUNICIPALITY

Client:

KABUL MUNICIPALITY

Designed by:

KABUL MUNICIPALITY

Project Name:

Gore-Sangi To Dehmazang

Road Project

Drawing Title:

PLAN & PROFILE

Designed by:

Mohammad Eesa Sharif

Signature:

Drawn by:

Mohammad Eesa Sharif

Signature:

Checked by:

Ihsanullah Sharifi

Signature:

Date:

6/10/2023

Scale:

1:1000

Sheet No:


PP-1

Project Code:

FINAL DESIGN

Drawing Number:




00

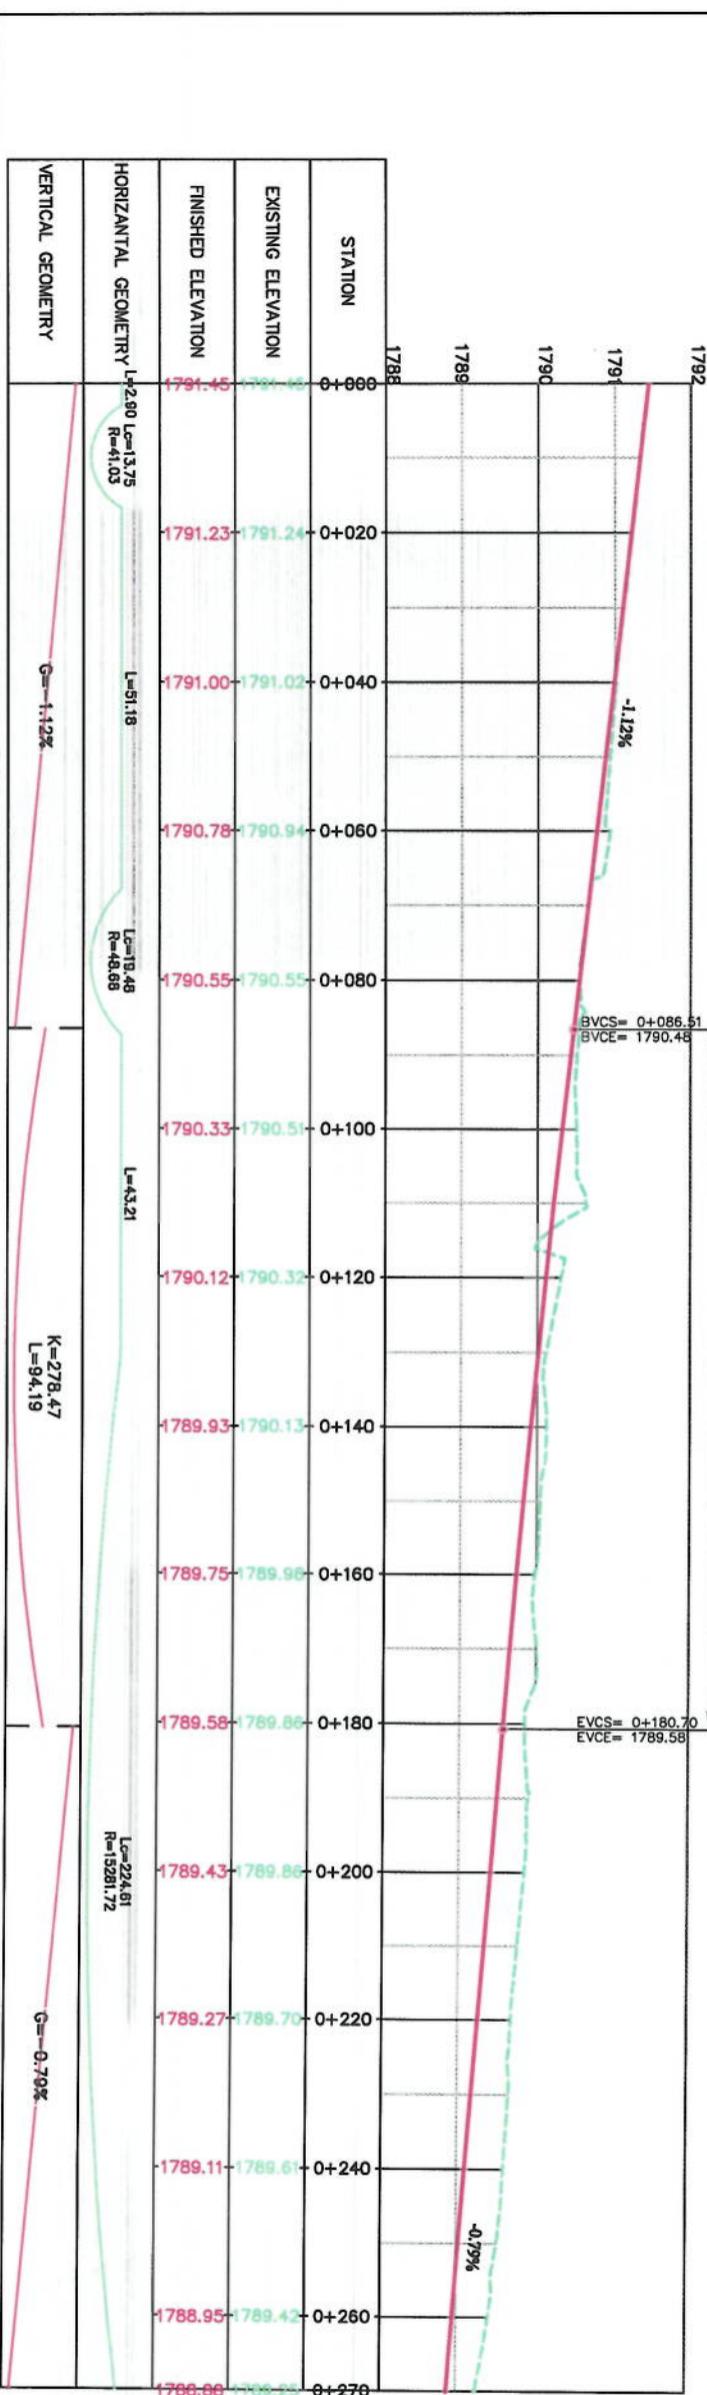



Note:
 1- where ever the level of design profile is upper than existing road edge it is recommended to follow the existing road edge as control level.
 2- where ever the design profile is lower than existing road edge, than right side curb stone of center median should follow the design profile as the control level.

NOTE:
 1- The heights of all new side ditches have shown on the plan.
 2- The finished level of new roads should be adjusted to the existing paved roads both at start and at the end properly.
 3- In case of changing in optical cross section type all components should be adjusted properly.
 4- All Bed levels of new ditches should be adjusted to the existing ditch bed levels to reflect survey works properly.
 5- Because of residential area on the site, the survey team was not allowed to enter the houses; therefore, the design has been based on the survey with less accuracy and it is necessary to re-survey the area after the demolition of houses.

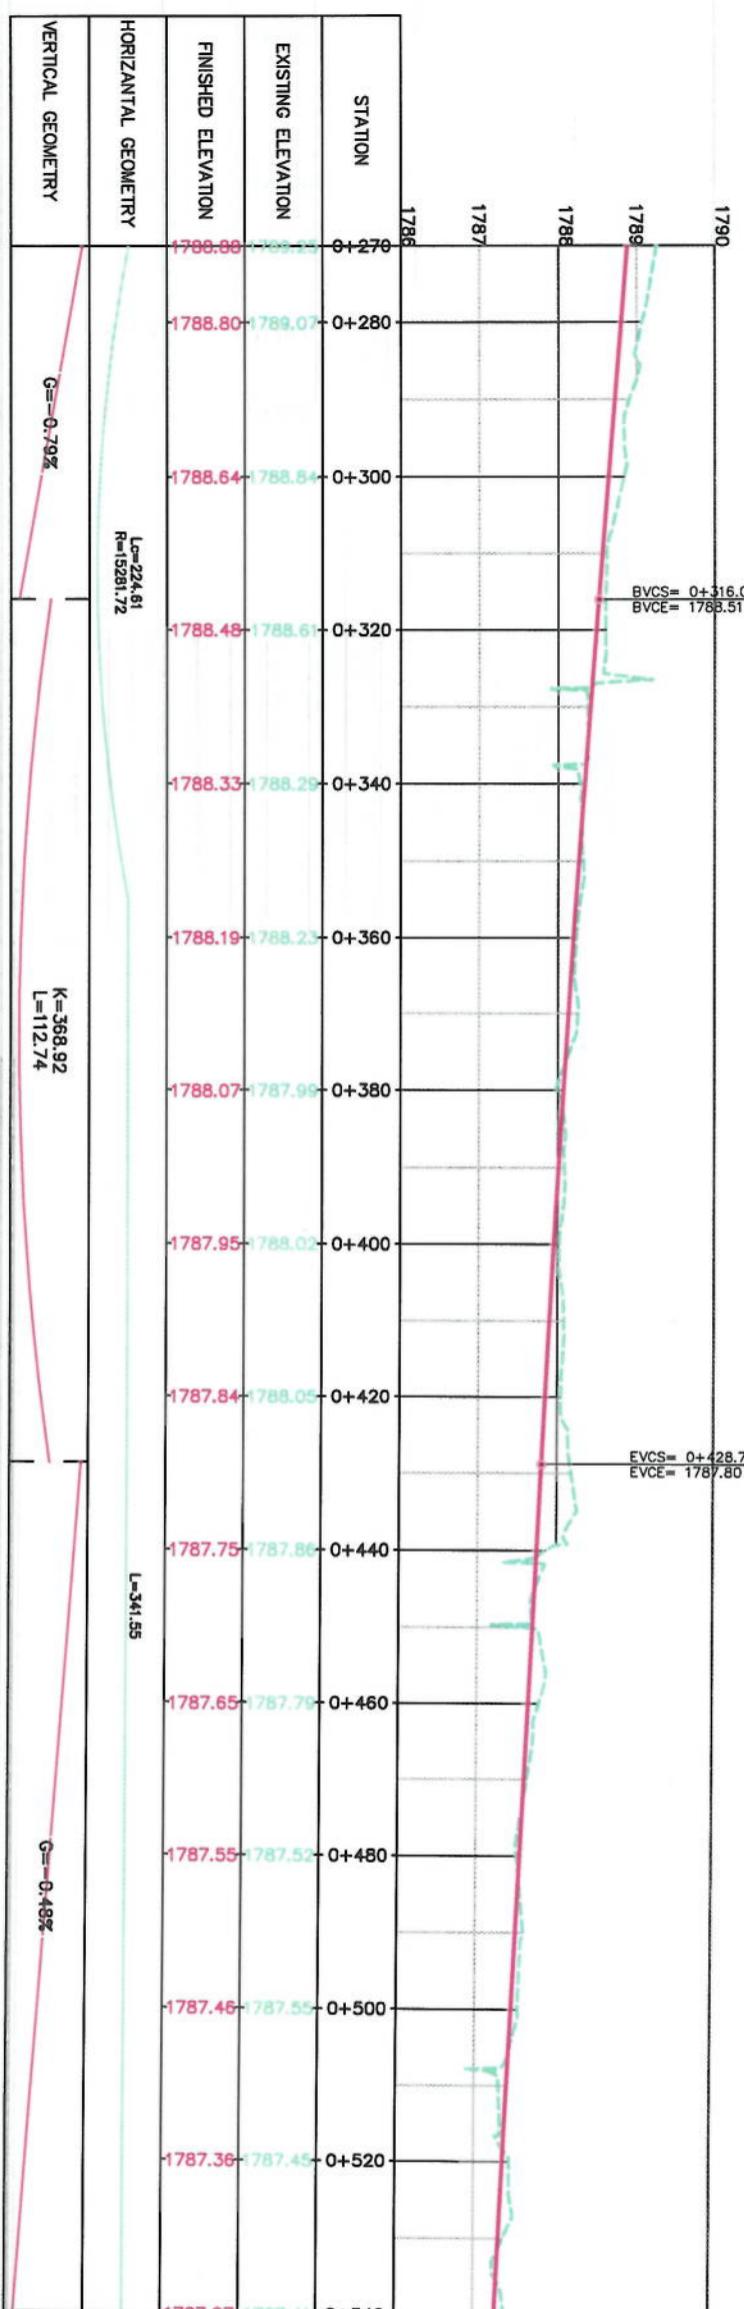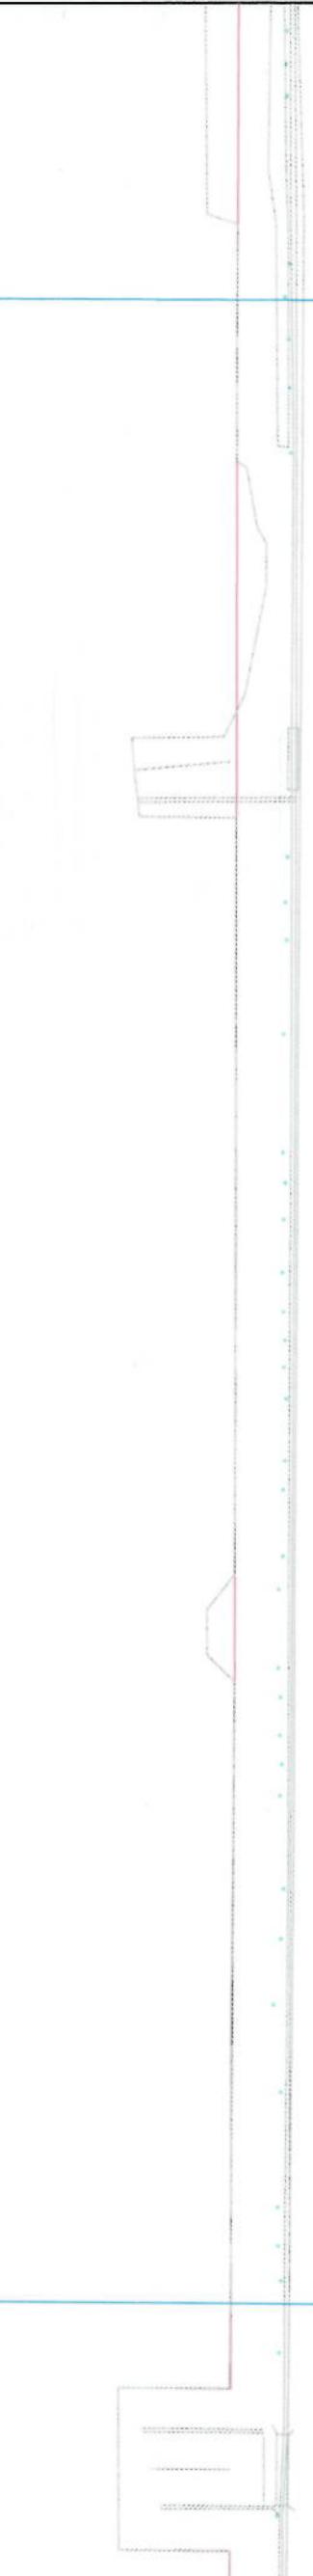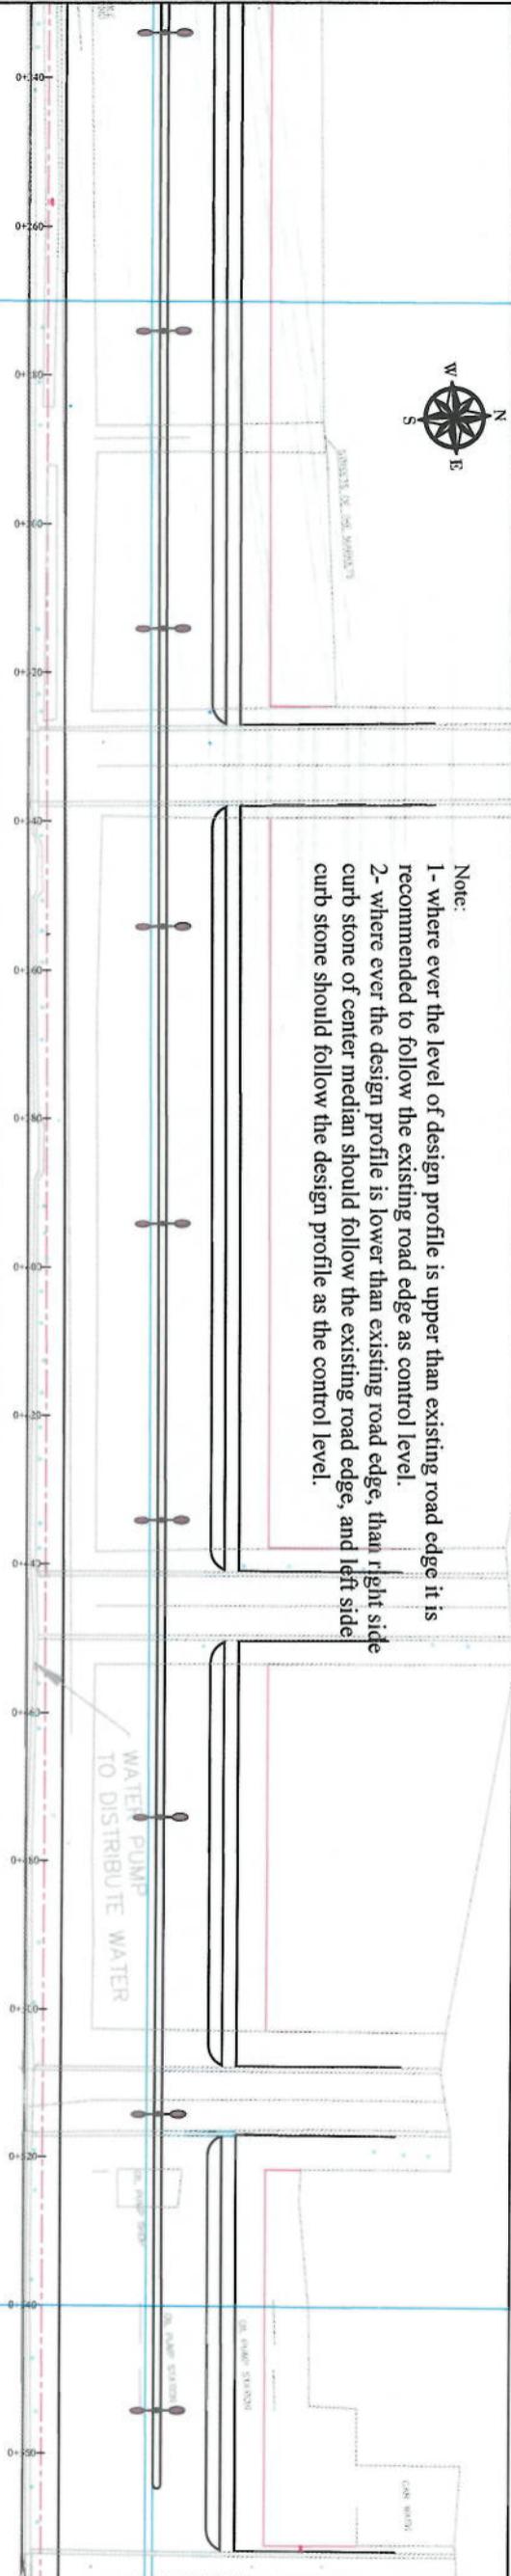

PLAN & PROFILE

Designed by: Mohammad Fisa Sial
Drawn by: Mohammad Fisa Sial
Checked by: Hanbulha Sial


Project Name: Core-Sang To Demazang Road Project
Drawing Title:

KABUL MUNICIPALITY DESIGN TEAM

Signature: Signature: Signature:

Date: 6/10/2023 Scale: 1:1000 Status: FINAL DESIGN

Project Code: Drawing Number: PP-2 Revision: 00


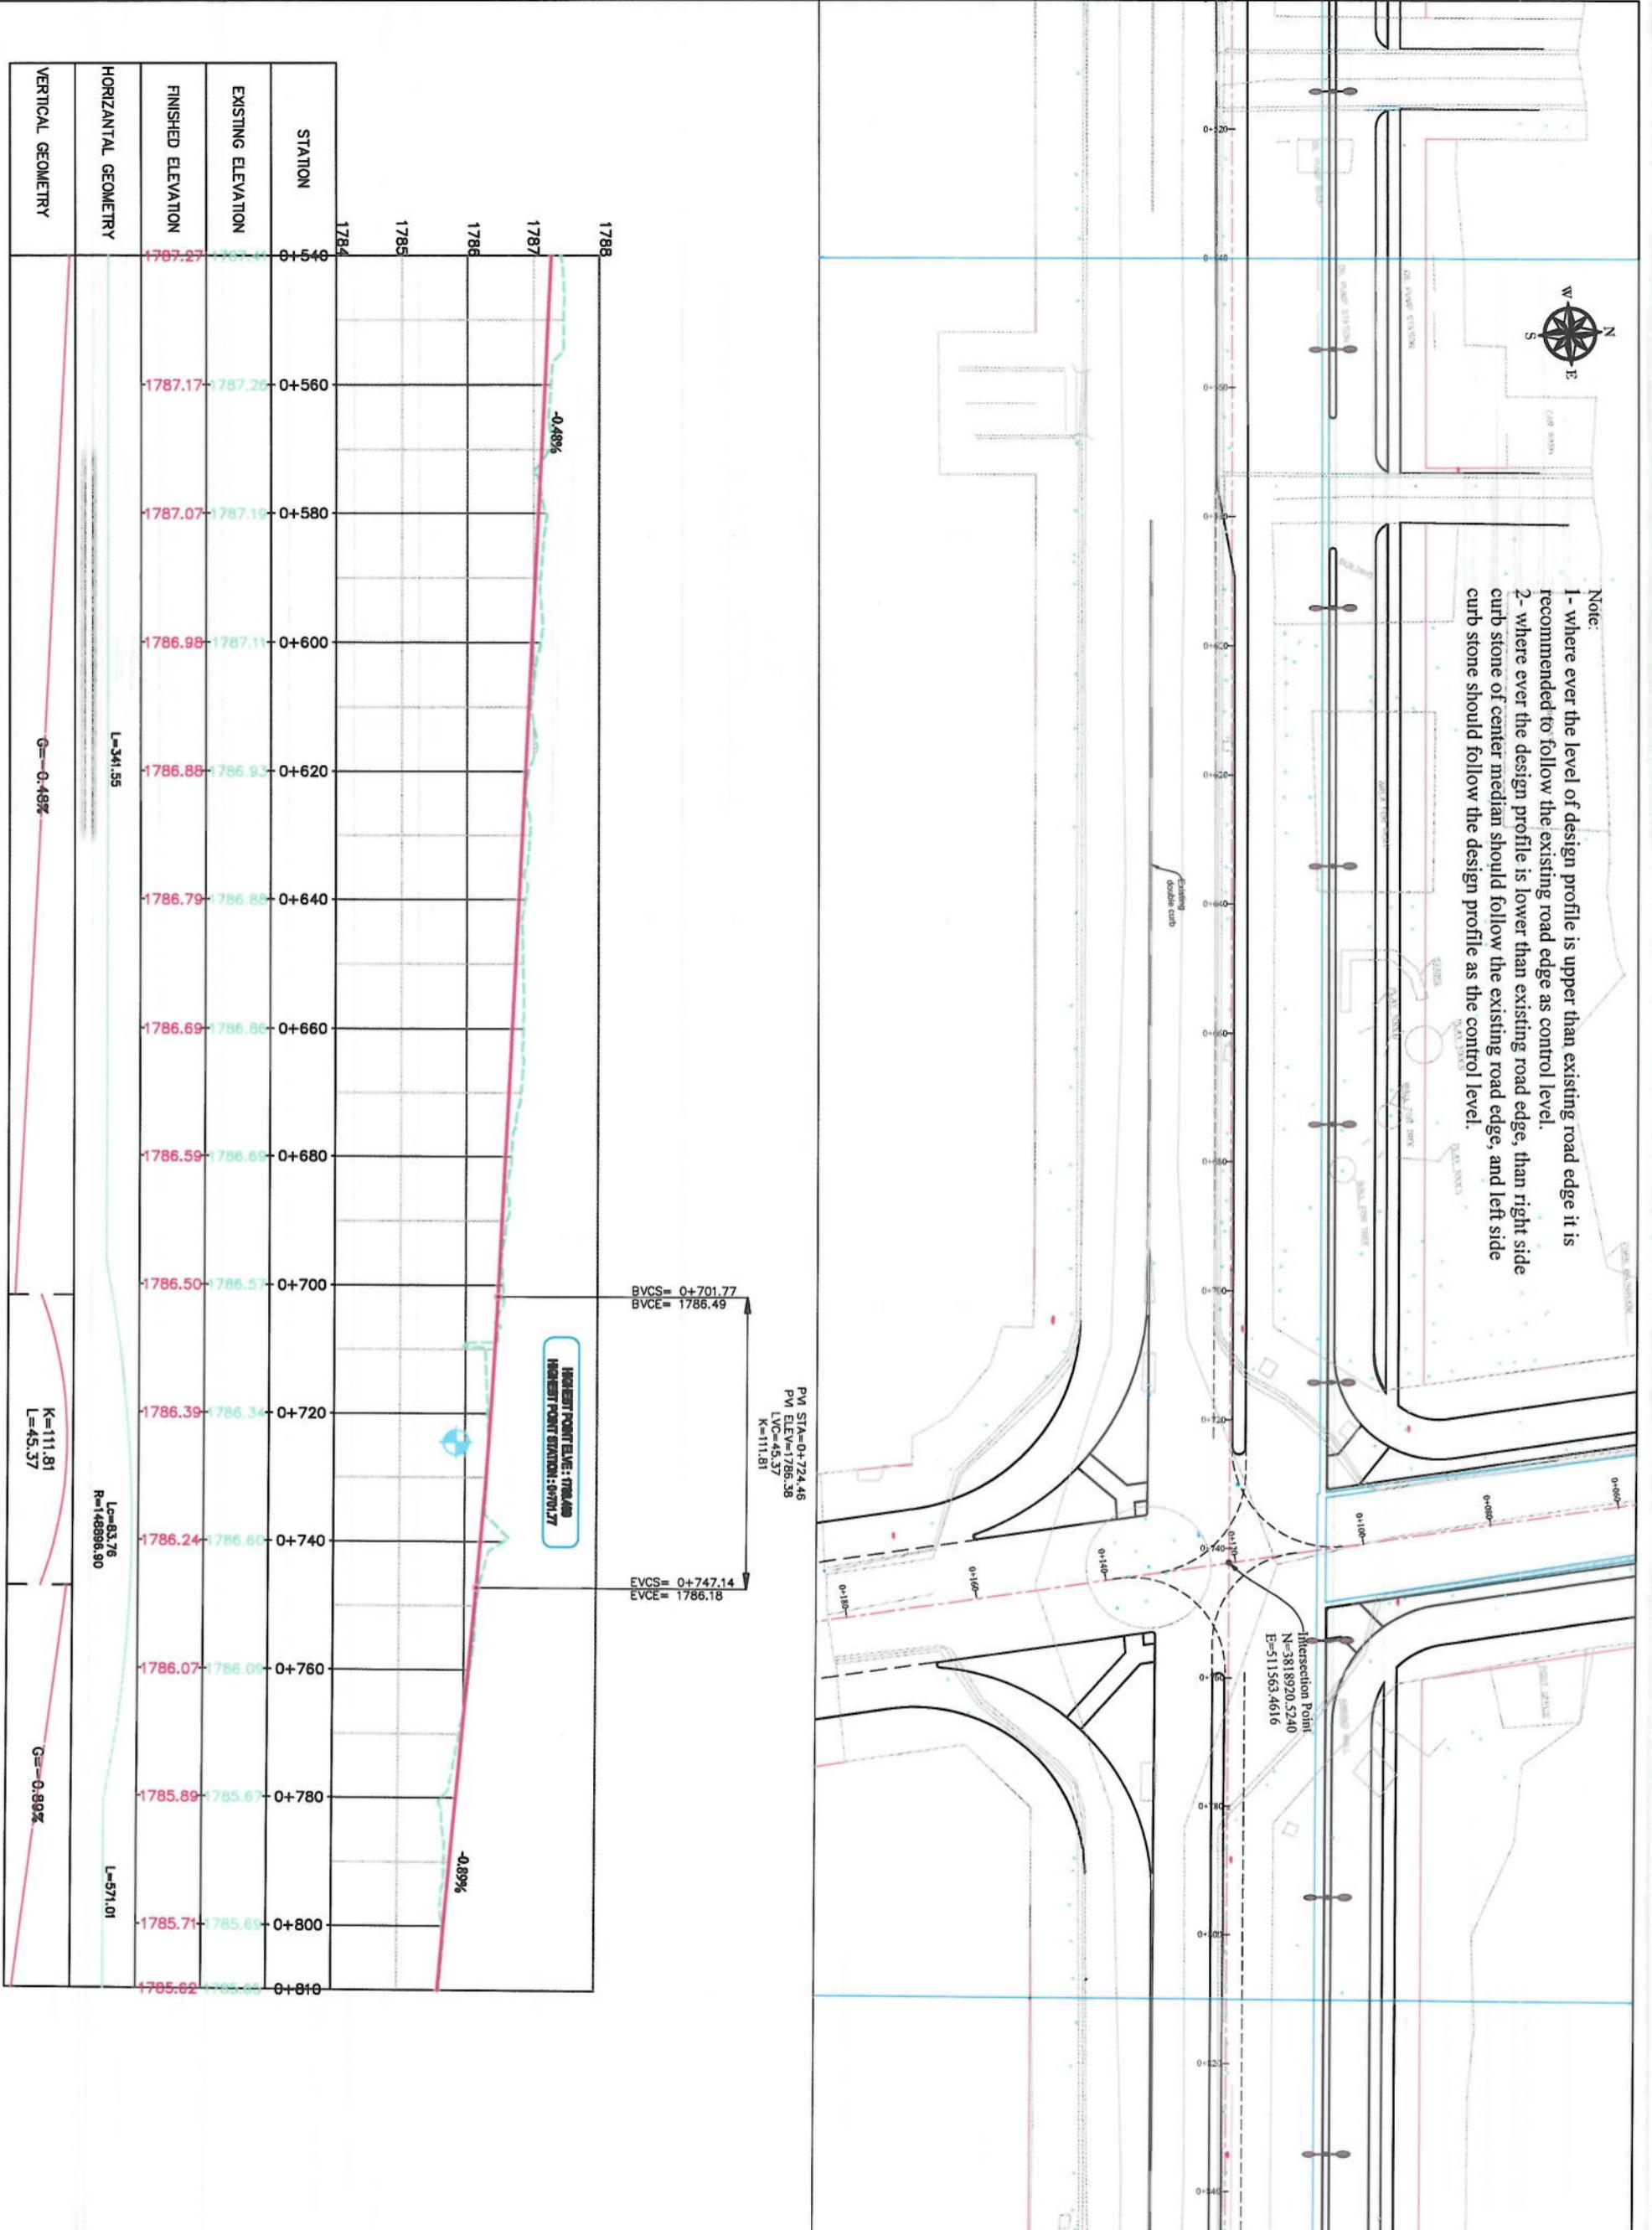


NOTE

- 1- The lengths of all new side ditches have shown on the plan.
 - 2- The finished level of new roads should be exhausted to the existing paved roads both at start and at its end property.
 - 3- In case of changing in typical cross section type all components should be adjusted property.
 - 4- All Bed levels of new ditches should be exhausted to the existing ditches bed levels to direct surface water property.
 - 5- Because of residential area on the site, the survey team has been allowed to enter the houses, therefore, the design has done based on the survey with less accuracy and it is necessary to re-survey the area after the demolition of houses.



Note:
 1- where ever the level of design profile is upper than existing road edge it is recommended to follow the existing road edge as control level.
 2- where ever the design profile is lower than existing road edge, than right side curb stone of center median should follow the existing road edge, and left side curb stone should follow the design profile as the control level.

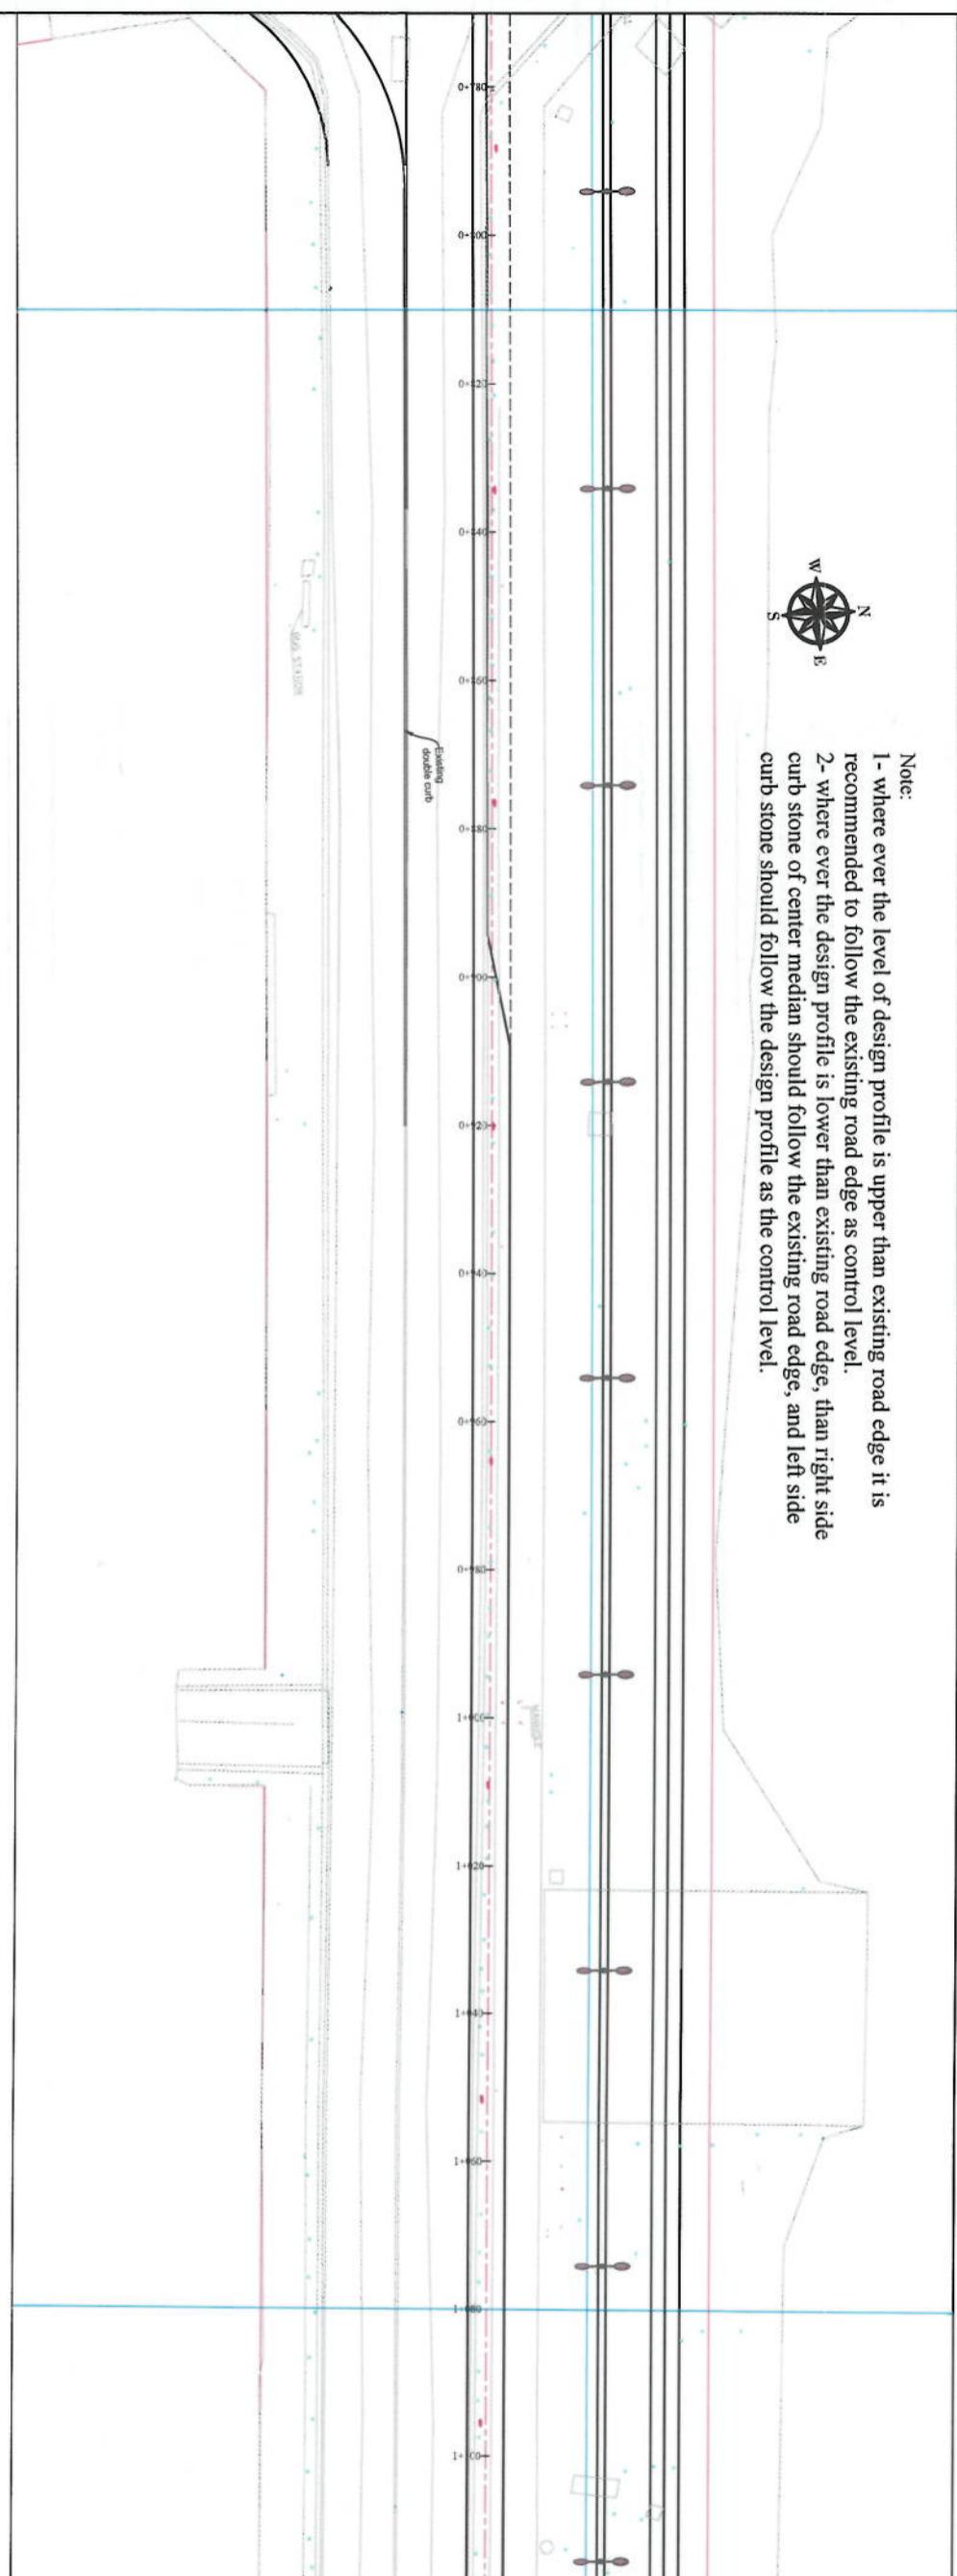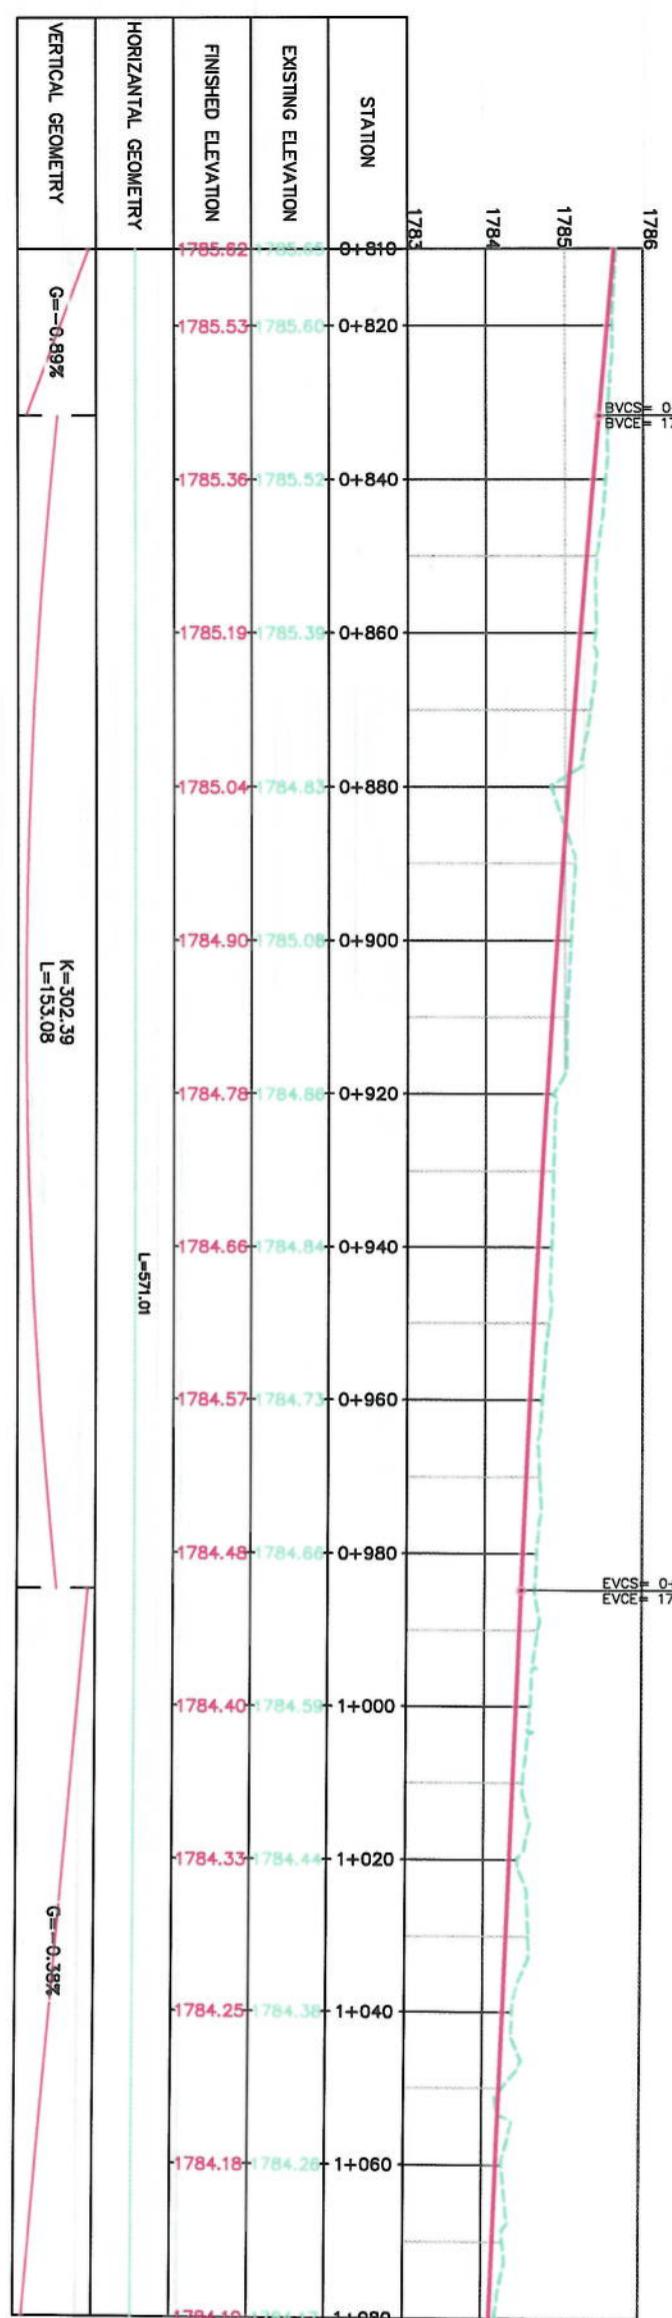


NOTE:

- The lengths of all new side ditches have shown on the plan.
- The finished level of new roads should be adjusted to the existing paved roads both at start and at the end properly.
- In case of shaping in optical cross section type all components should be adjusted properly.
- All bed levels of new ditches should be adjusted to the existing ditch bed levels to detect surface water properly.
- Because of residential area on the site, the survey item was not allowed to enter the houses, therefore no design has done based on the survey which its accuracy and is necessary to re-survey the area after the demolition of houses.

Designed by:	KABUL MUNICIPALITY DESIGN TEAM
Drawn by:	Mohammad Eisa Stat
Checked by:	Hassanullah Shahzai
Date:	6/10/2023
Scale:	1:1000
Status:	FINAL DESIGN
Project Code:	PP-4
Drawing Number:	00
Revision:	



Note:
 1- where ever the level of design profile is upper than existing road edge it is recommended to follow the existing road edge as control level.
 2- where ever the design profile is lower than existing road edge, than right side curb stone of center median should follow the existing road edge, and left side curb stone should follow the design profile as the control level.

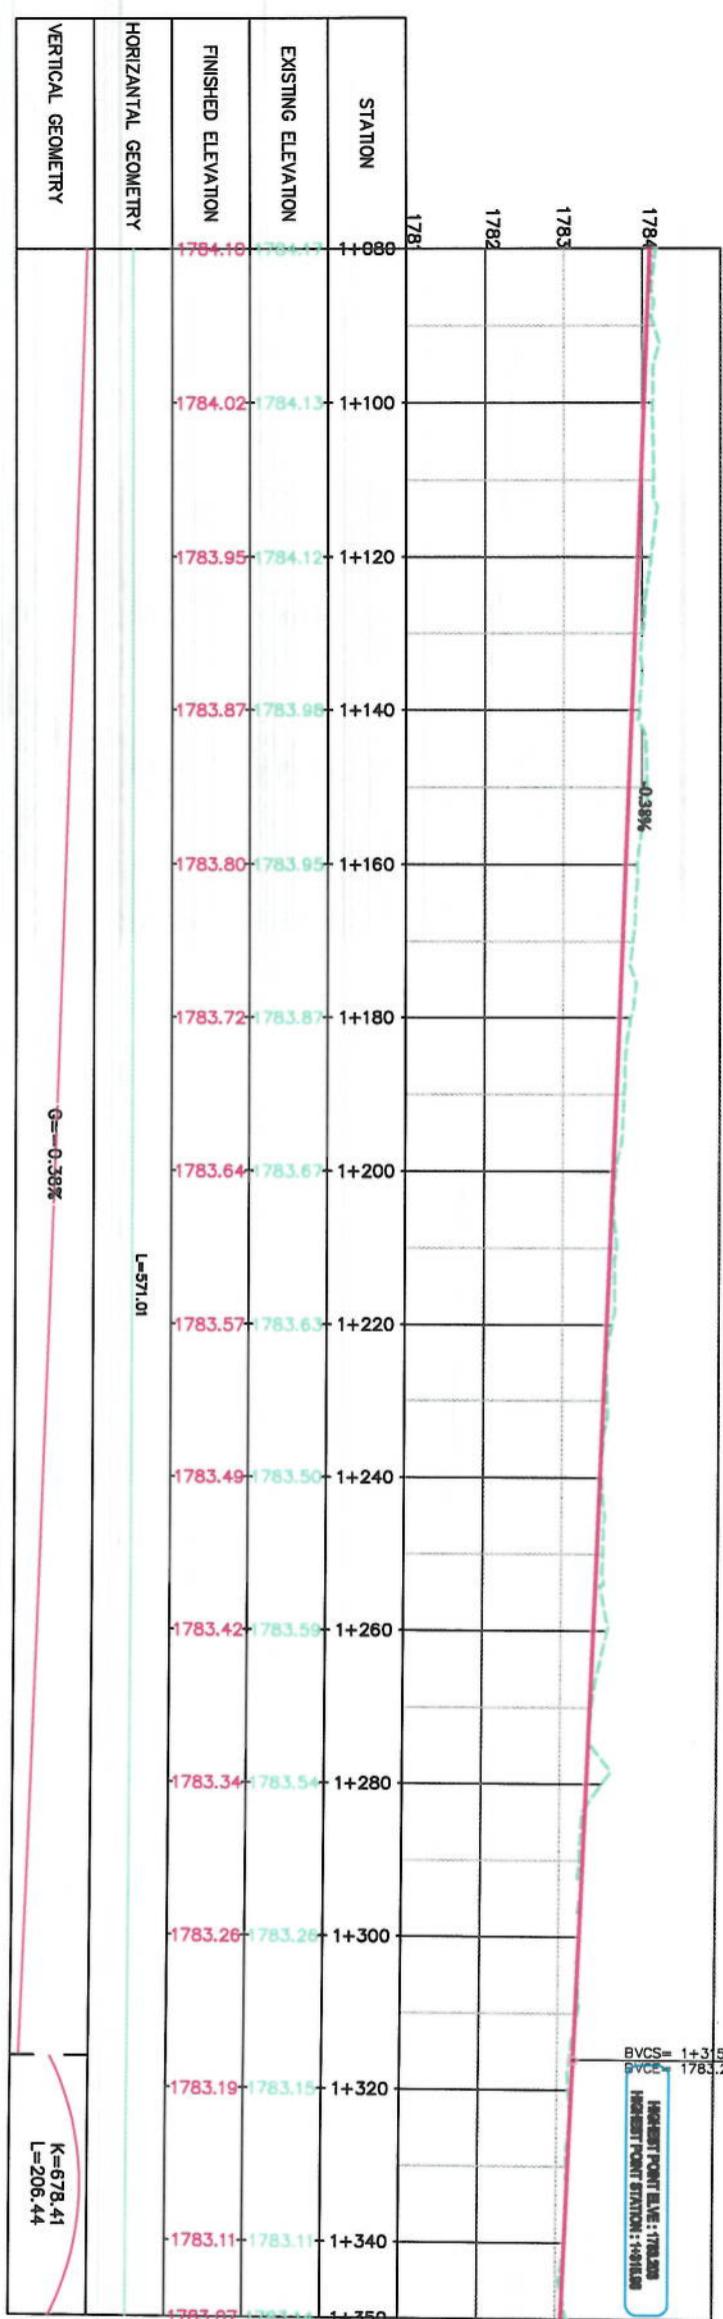



Note:

- 1- where ever the level of design profile is upper than existing road edge it is recommended to follow the existing road edge as control level.
- 2- where ever the design profile is lower than existing road edge, than right side curb stone of center median should follow the existing road edge, and left side curb stone should follow the design profile as the control level.

NOTE:
 1- The lengths of all new side ditches have shown on the plan.
 2- The finished level of new roads should be adjusted to the existing paved roads both at start and at the end of the property.
 3- In case of changing in typical cross section type all components should be adjusted properly.
 4- All Bed levels of new ditches should be adjusted to the existing ditches and levels to reflect surface with property.
 5- Because of residential area on the site, the survey was not allowed to enter the houses, therefore, the design was done based on the survey with less accuracy and it is necessary to re-survey the area after the demolition of houses.



LEGENDS
 CENTER-LINE
 EXISTING SURFACE
 EXISTING SIDE DITCH

ISLAMIC EMIRATE OF
AFGHANISTAN

KABUL MUNICIPALITY
(Signature)

Mohammad Eesa Sini
(Signature)

Mohammad Eesa Sini
(Signature)

Hassanullah Shabizi
(Signature)

Project Name:
Cot-e-Sang To Dzhimzang
Road Project

Drawing Title:
PLAN & PROFILE

Designed by:
KABUL MUNICIPALITY
DESIGN TEAM

Drawn by:
Mohammad Eesa Sini
(Signature)

Checked by:
Hassanullah Shabizi
(Signature)

Date: 6/10/2023 Scale: 1:1000

HORIZONTAL GEOMETRY	L=571.01	R=42857.12	I=3.77%	G=-0.68%
			K=232.18	K=196.84

Vertical Geometry

K=678.41

L=208.44

L=1703.52

1782.25

1782.12

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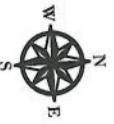
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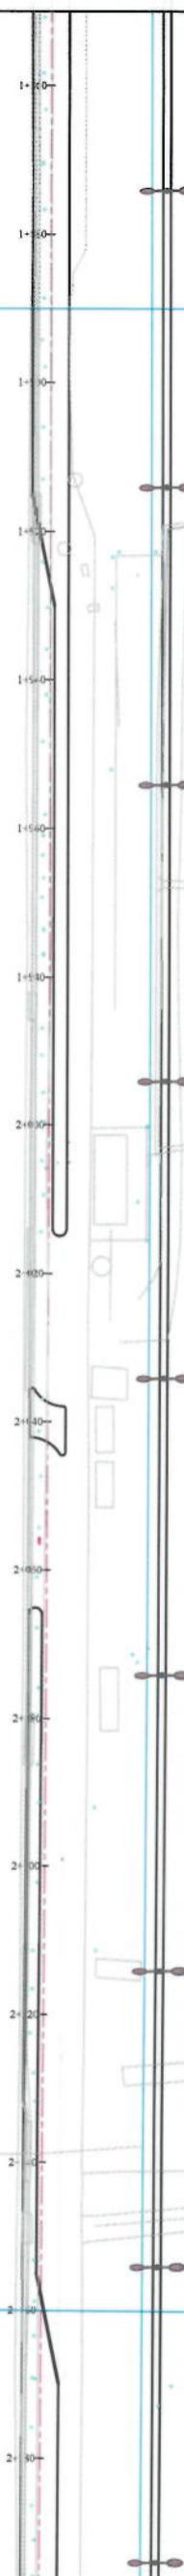
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Note:

- 1- where ever the level of design profile is upper than existing road edge it is recommended to follow the existing road edge as control level.
- 2- where ever the design profile is lower than existing road edge, than right side curb stone of center gredian should follow the existing road edge, and left side curb stone should follow the design profile as the control level.

SURVEY THIS ARE




LEGENDS	
	CENTERLINE
	EXISTING SURFACE
	EXISTING SIDE DITCH



NOTE:

- 1- The lengths of all new side ditches have shown on the plan.
- 2- The finished level of new roads should be adjusted to the existing paved roads both at start and at the end properly.
- 3- In case of changing in typical cross section type all components should be adjusted properly.
- 4- All Bed levels of new ditches should be adjusted to the existing ditches bed levels to direct surface water properly.
- 5- Because of residential area on the site, the survey team was not allowed to enter the houses; therefore, the design has done based on the survey with less accuracy and it is necessary to re-survey this area after the demolition of houses.

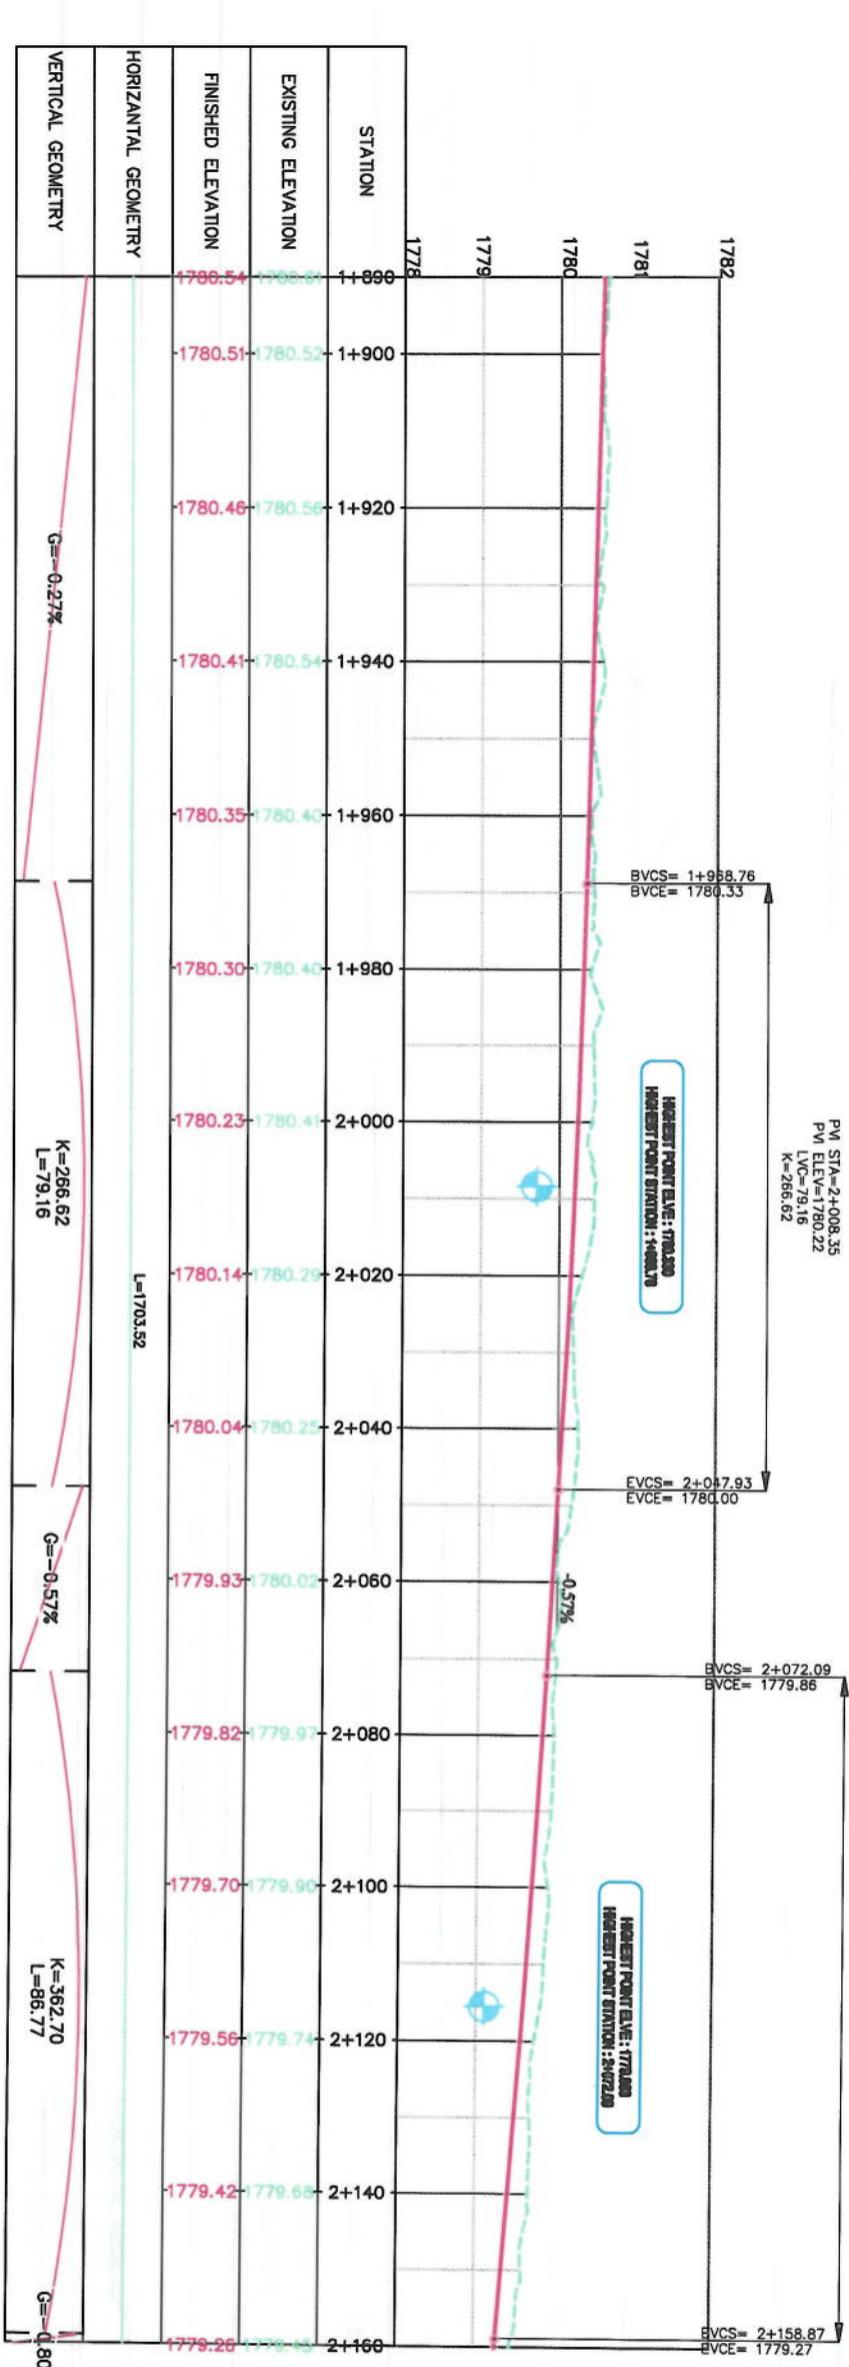


Designed by:	KABUL MUNICIPALITY DESIGN TEAM
Project Name:	Co-Sangi To Deshmanzai Road Project
Drawing Title:	PLAN & PROFILE
Signature:	

Date:	Scale:
6/10/2023	1:1000
Status:	FINAL DESIGN
Project Code:	
Drawing Number	PP-8
Revision	00



Note:
 1- where ever the level of design profile is upper than existing road edge it is recommended to follow the existing road edge as control level.
 2- where ever the design profile is lower than existing road edge, than right side curb stone of center median should follow the existing road edge, and left side curb stone should follow the design profile as the control level.


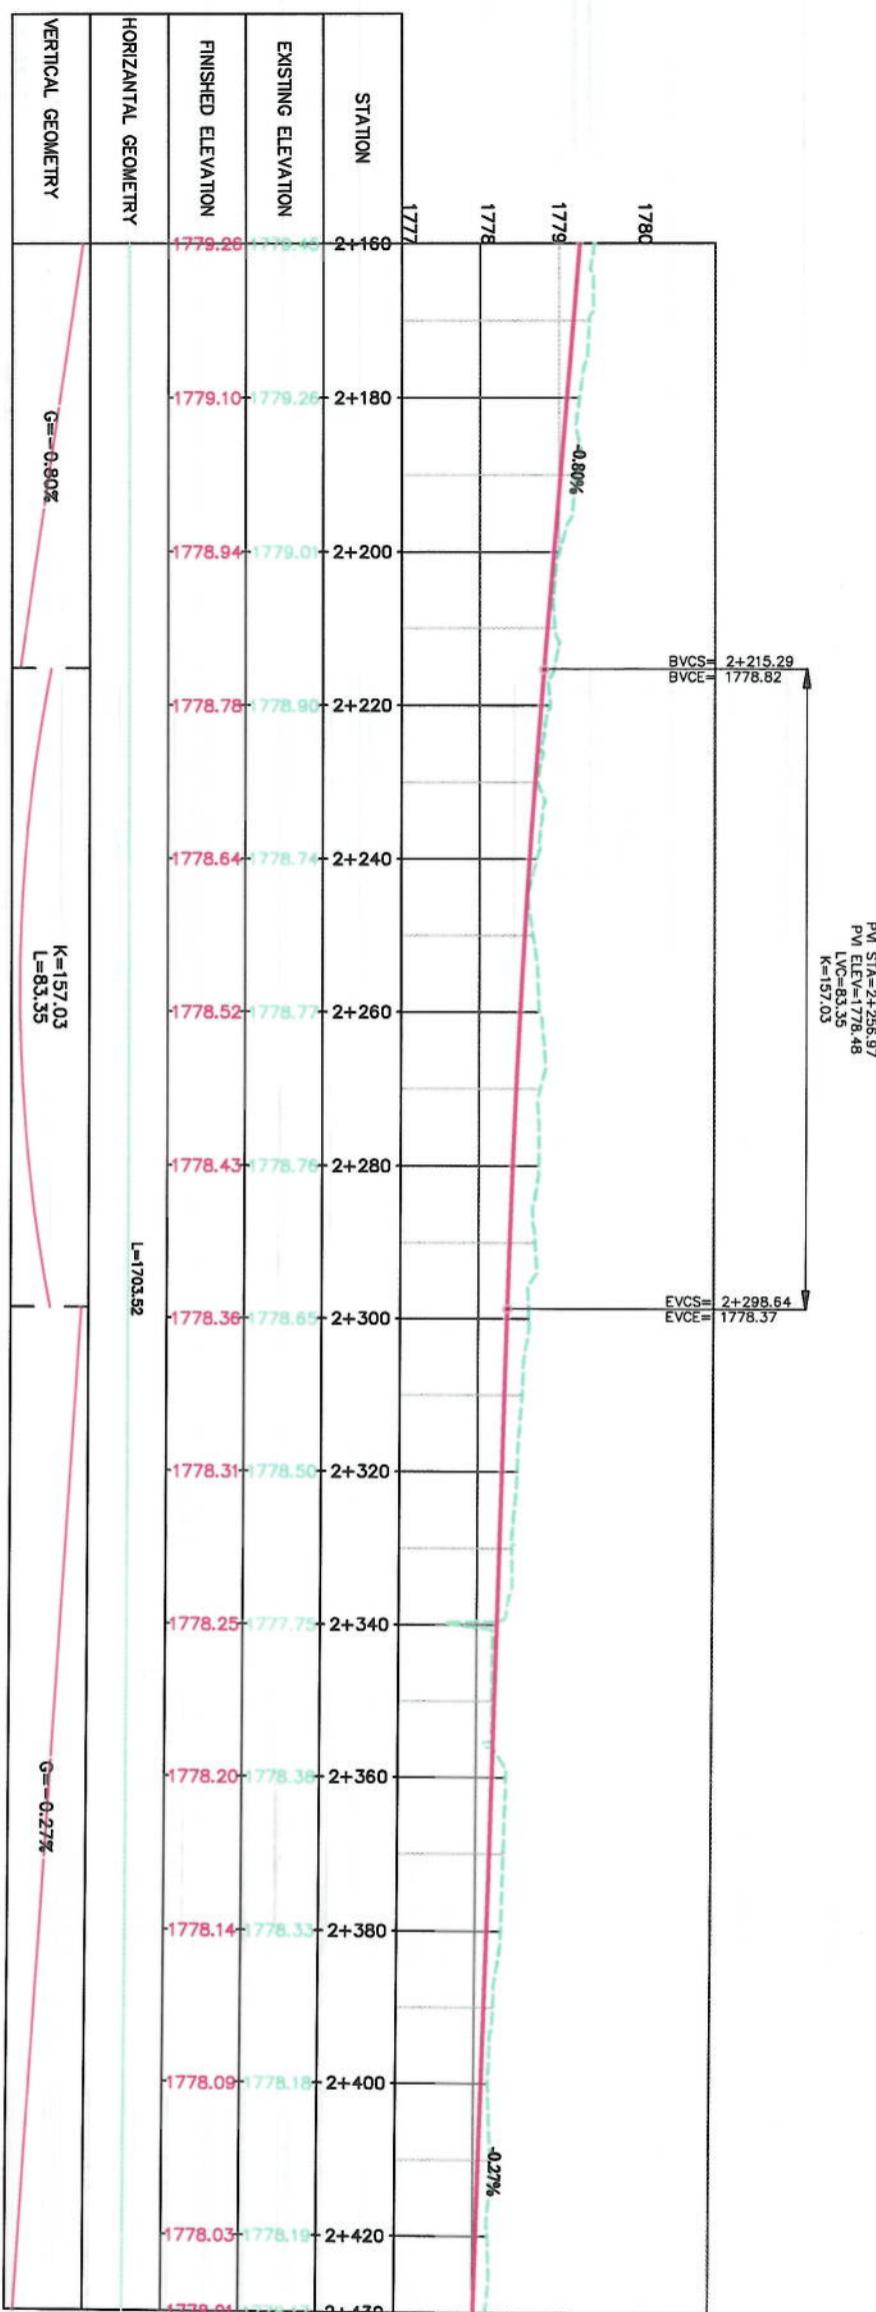


PLAN & PROFILE		
Designed by:	Signature:	
Mohammed Eissa Sharif		
Drawn by:	Signature:	
Mohammed Eissa Sharif		
Checked by:	Signature:	
Habibullah Shahzai		
Drawing Title		
Project Name	Co-e-Sang! To Demazang Road Project	
Date:	6/10/2023	Scale:
Status:	FINAL DESIGN	
Drawing Number	PP-9	Revision
	00	

NOTE:		
1- The lengths of all new side ditches have shown on the plan.		
2- The finished level of new roads should be adjusted to the existing paved roads both at start and at the end properly.		
3- In case of changing in typical cross section type all components should be adjusted properly.		
4- All Bed levels of new ditches should be adjusted to the existing ditches bed levels to direct surface water properly.		
5- Because of residential area on the site, the survey team was not allowed to enter the houses, therefore the design has done based on the survey with best accuracy and is necessary to resurvey the area after the demolition of houses.		



Note:
 1- where ever the level of design profile is upper than existing road edge it is recommended to follow the existing road edge as control level.
 2- where ever the design profile is lower than existing road edge, than right side curb stone of center median should follow the design profile as the control level.

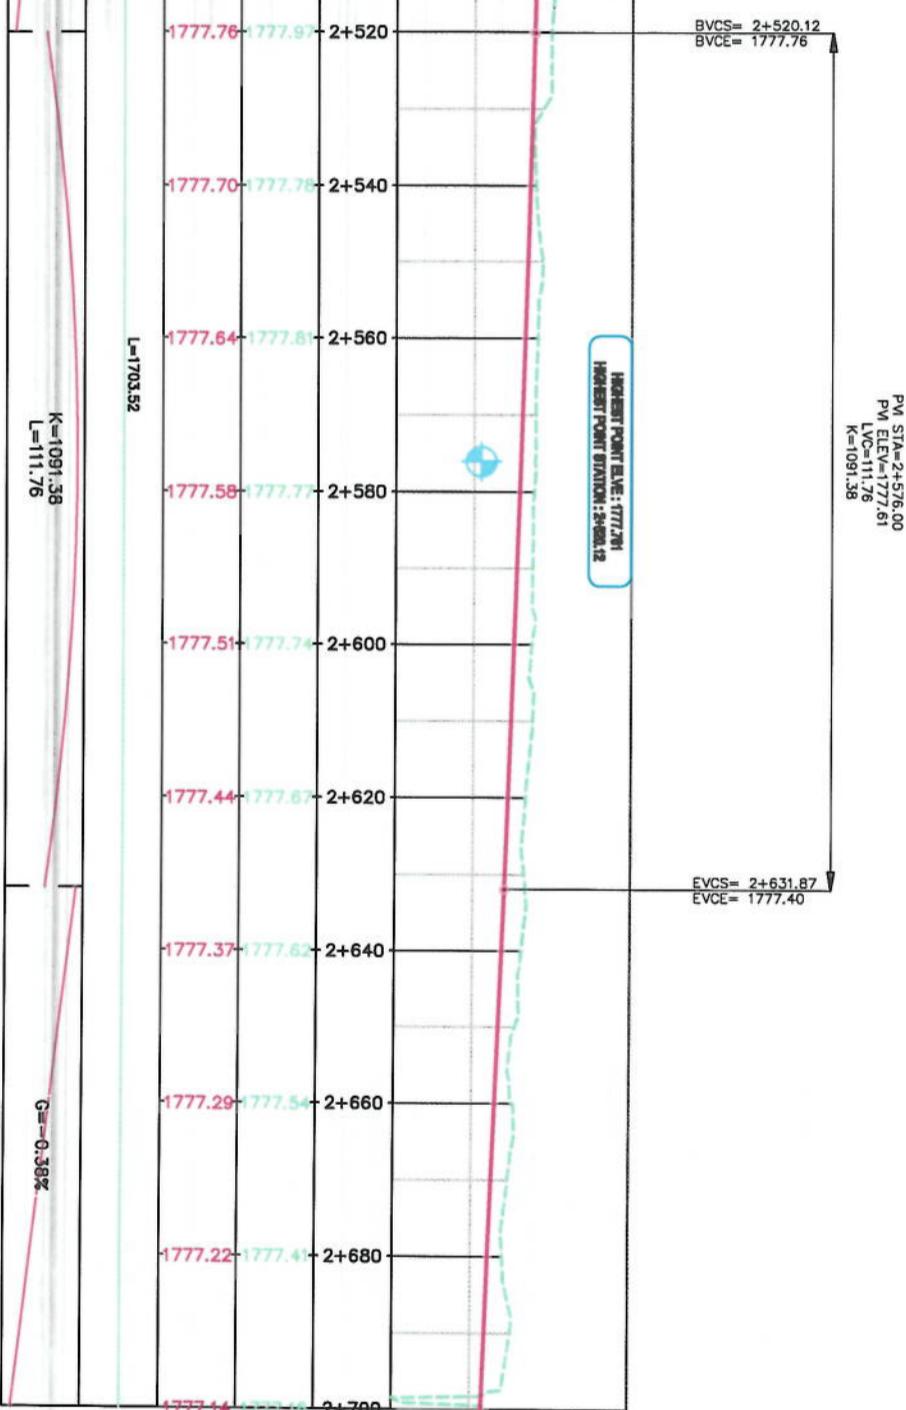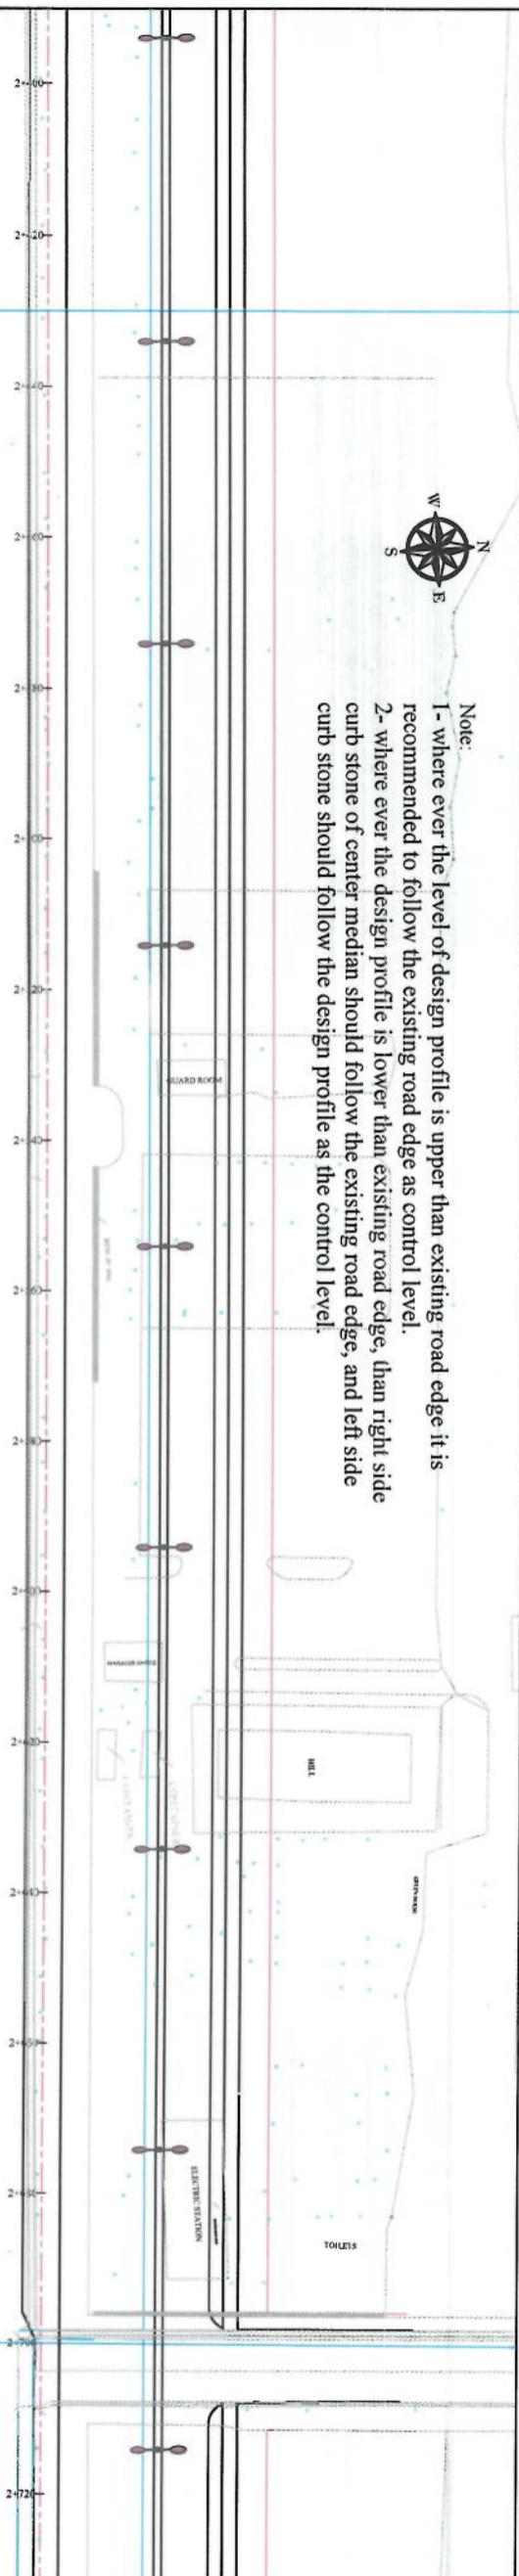

KABUL MUNICIPALITY
DESIGN TEAM

Designed by:
 Mohammad Easa Sait
 Signature:

Drawn by:
 Mohammad Easa Sait
 Signature:

Checked by:
 Hamidullah Shahri
 Signature:

Drawing Title:
 Core-Sang To Delamzang
 Road Project

PLAN & PROFILE

Project Name:
 Core-Sang To Delamzang
 Road Project

Date: 6/10/2023
 Scale: 1:1000

Status: FINAL DESIGN

Project Code: PP-10
 Drawing Number: 00
 Revision:




NOTE:
 1- The lengths of all new side ditches have shown on the plan.
 2- The finished level of new roads should be adjusted to the existing paved roads both at start and at the end property.
 3- In case of changing in optical cross section type all components should be adjusted property.
 4- All Bed levels of new ditches should be adjusted to the existing ditch's bed levels to direct surface water property.
 5- Because of residential area or the site, the survey team was not allowed to enter the houses, therefore, the design has not been based on the survey with less accuracy and it is necessary to re-survey this area after the demolition of houses.



Note:

- where ever the level of design profile is upper than existing road edge it is recommended to follow the ~~existing road edge~~ as control level.
- where ever the design profile is lower than ~~existing road edge~~, the right side curb stone of center median should follow the existing road edge, and left side curb stone should follow the design profile as the control level.

NOTE:
 1. The lengths of all new side ditches have shown on the plan.
 2. The finished level of new roads should be adjusted to the existing paved roads both at start and at the end property.
 3. In case of changing in typical cross section types all components should be adjusted properly.
 4. All Bed levels of new ditches should be adjusted to the existing ditches bed levels to detect surface water property.
 5. Because of residential area on the site, the survey team was not allowed to enter the houses; therefore, the design has done based on the survey with less accuracy and it is necessary to re-survey this area after the demolition of houses.

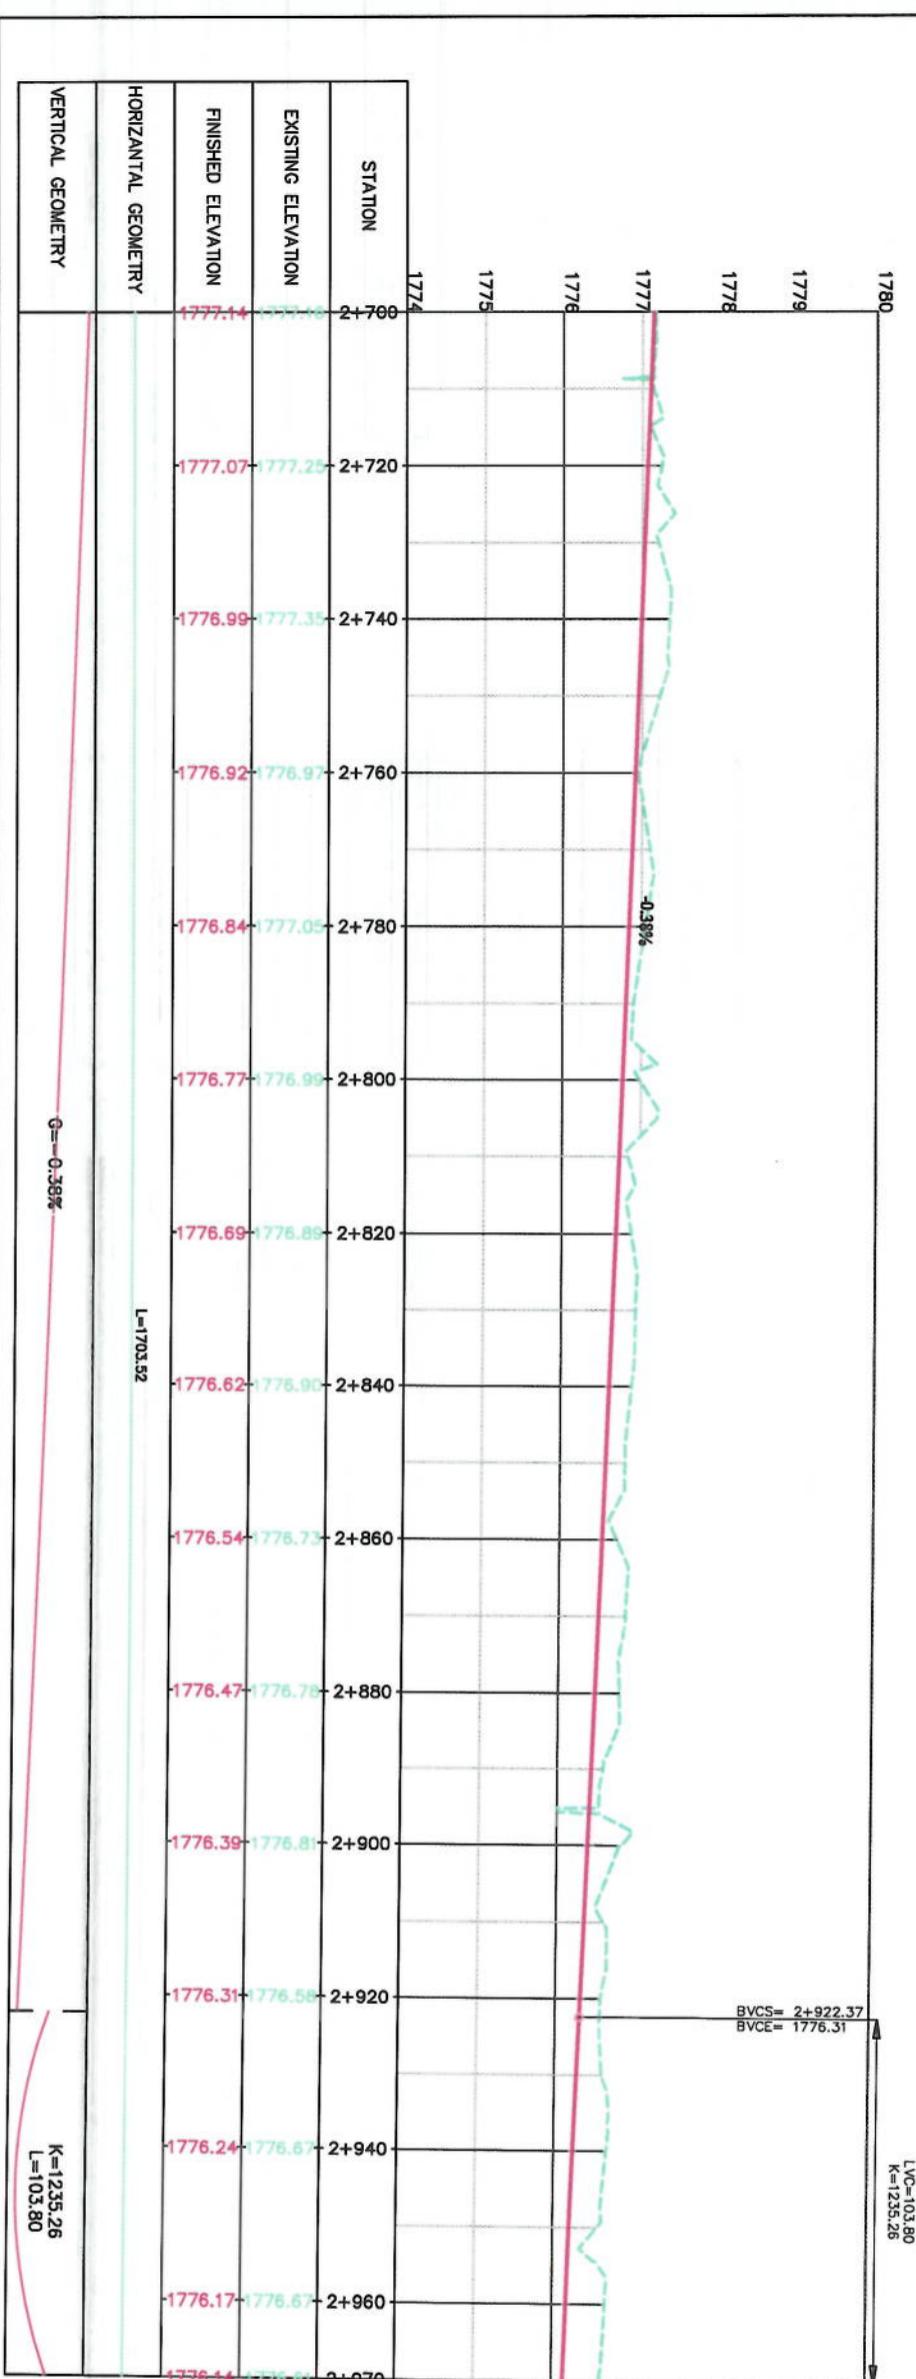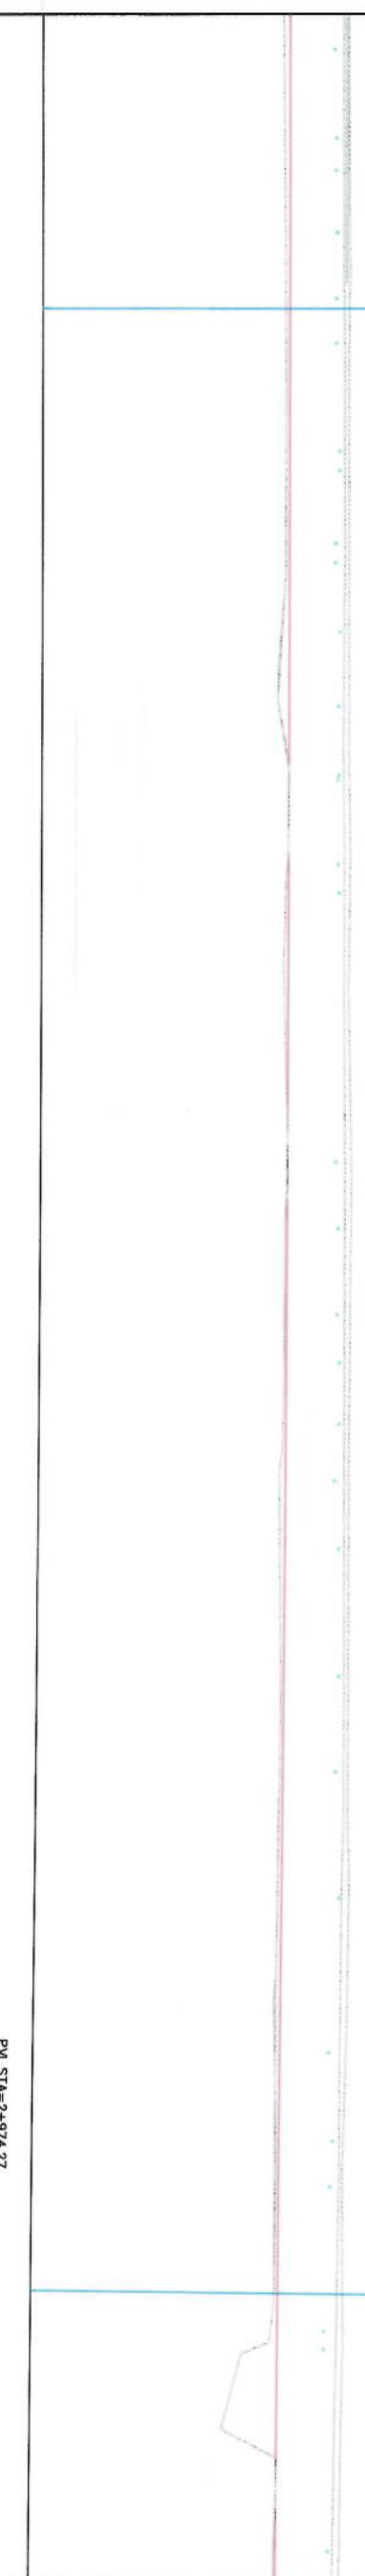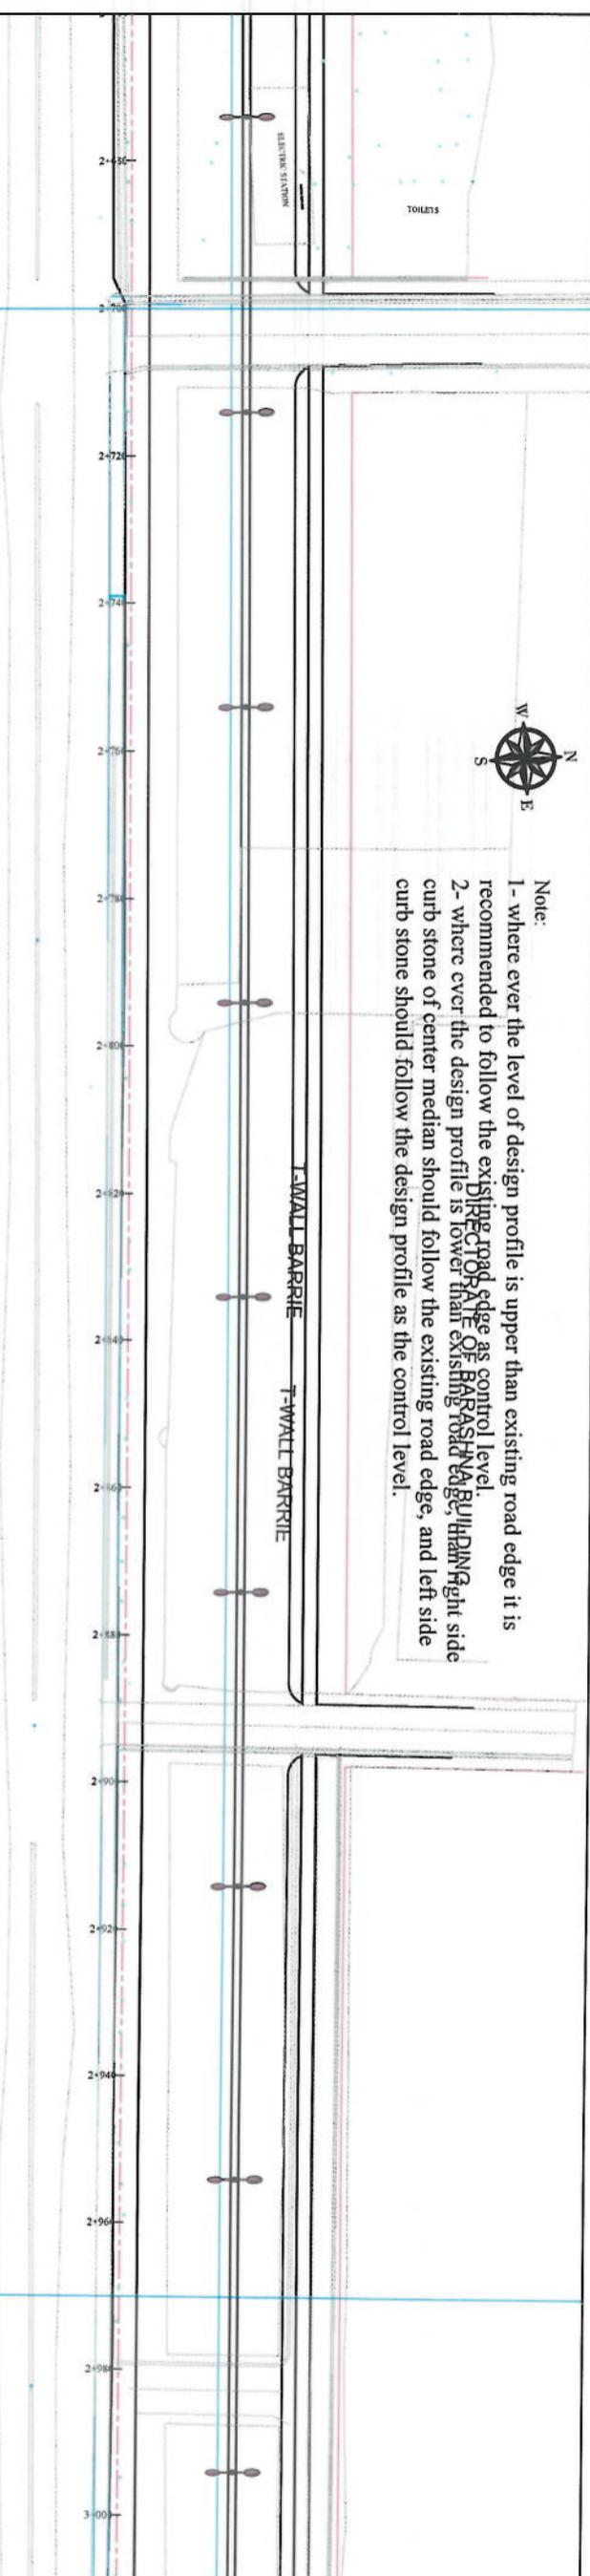


PLAN & PROFILE		
Designed by: Mohammad Fisa Sial	Signature:	
Drawn by: Mohammad Fisa Sial	Signature:	
Checked by: Hashullah Shahzai	Signature:	
Project Name: Cole-Sangi To Delamang Road Project		
Drawing Title:		
Date: 6/10/2023	Scale: 1:1000	
Status: FINAL DESIGN		
Project Code:		
Drawing Number: PP-11	Revision: 00	




Note:
 1- where ever the level of design profile is upper than existing road edge it is recommended to follow the existing road edge as control level.
 2- where ever the design profile is lower than existing road edge, than right side curb stone of center median should follow the existing road edge, and left side curb stone should follow the design profile as the control level.

DIRECTORATE OF TRAFFIC

NOTE:
 1- The lengths of all new side ditches have shown on the plan.
 2- The finished level of new roads should be adjusted to the existing paved roads both at start and at the end property.
 3- In case of changing in typical cross section type all components should be adjusted properly.
 4- All Bed levels of new ditches should be adjusted to the existing ditches bed level to direct surface water properly.
 5- Because of residential area on the site, the survey team was not allowed to enter the houses. Therefore, the design has done based on the survey with less accuracy and it is necessary to re-survey the area after the demolition of houses.

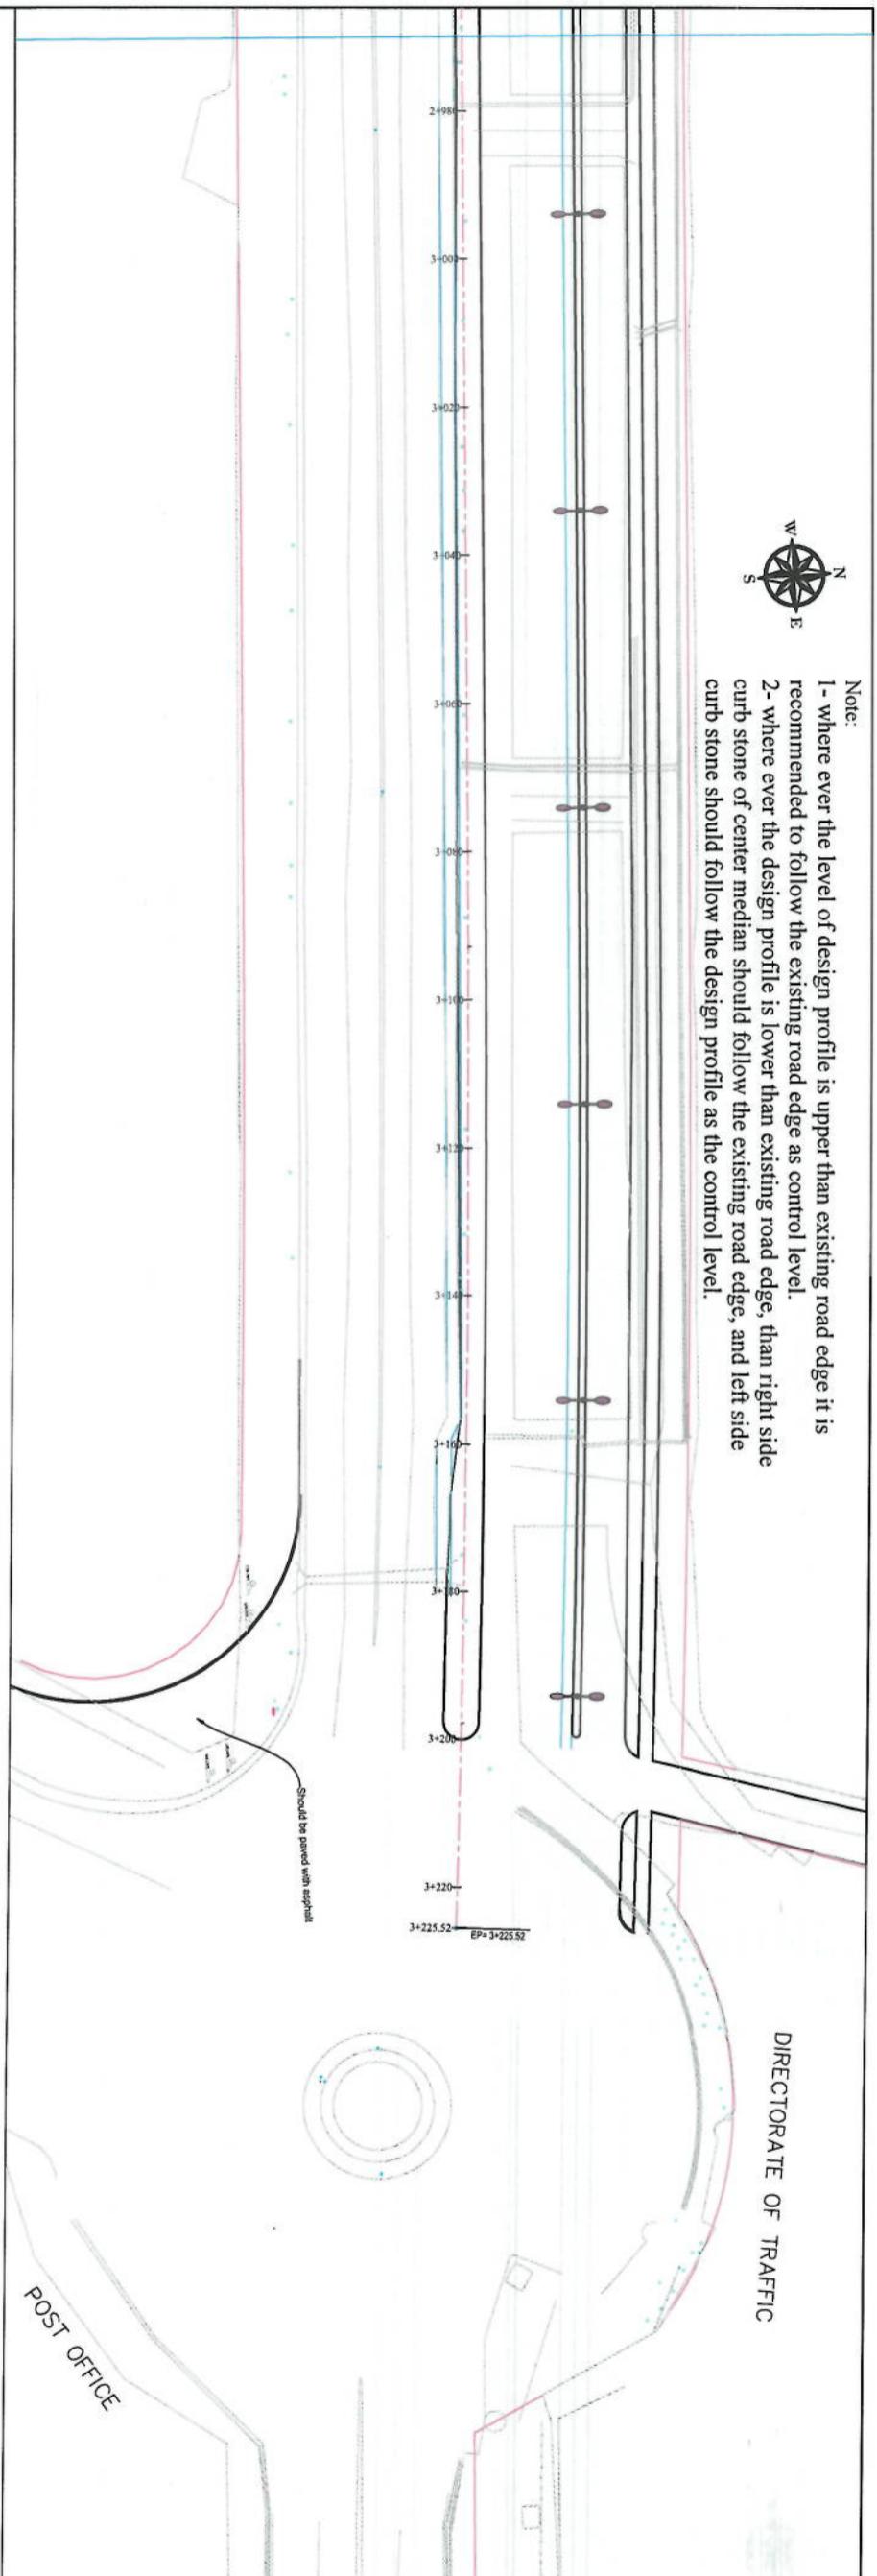

LEGENDS	
EXISTING SURFACE	EXISTING SIDE DITCH

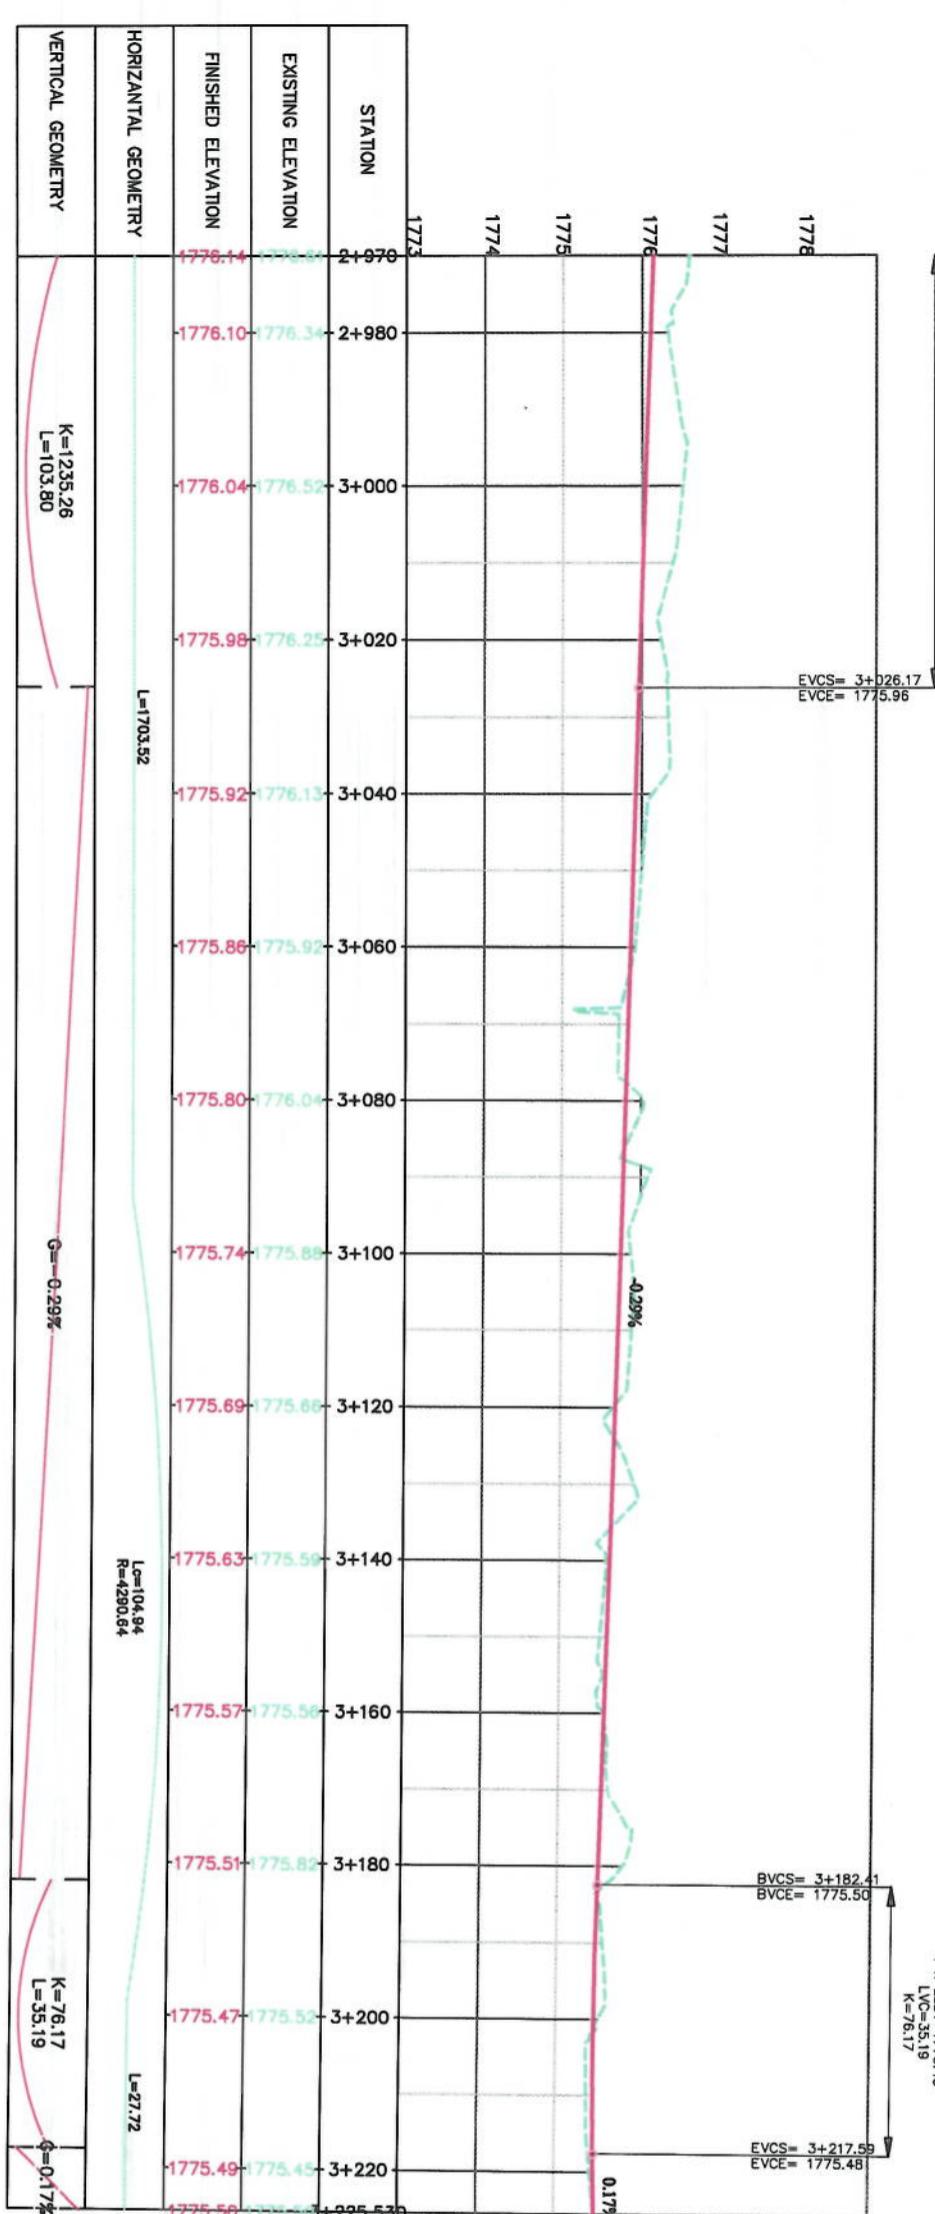

PLAN & PROFILE

Designed by:	Signature:
Mohammad Ehsa Sial	
Drawn by:	Signature:
Mohammad Ehsa Sial	
Checked by:	Signature:
Hassanullah Sialzi	
Project Name:	
Co-Op-Sang-e to Dehmanzang Road Project	
Drawing Title:	
Date:	Scale:
6/10/2023	1:1000
Status:	
FINAL DESIGN	
Project Code:	
Drawing Number:	PP-12
Revision:	00



NOTE:

- The lengths of all new side ditches have shown on the plan.
- The finished level of new roads should be adjusted to the existing paved roads both at start and at the end property.
- In case of changing in physical cross section types all components should be adjusted properly.
- All Bed levels of new ditches should be adjusted to the existing ditches bed levels to direct surface water properly.
- Because of residential area on the site, the survey team was not allowed to enter the houses; therefore, the design has done based on the survey with less accuracy and it is necessary to re-survey this area after the demolition of houses.



LEGENDS
CENTER-LINE
EXISTING SURFACE
EXISTING SIDE DITCH

ISLAMIC EMIRATE OF AFGHANISTAN

KABUL MUNICIPALITY

Client:

KABUL MUNICIPALITY

Designed by:

KABUL MUNICIPALITY DESIGN TEAM

Project Name: *Co-Sang'i To Dehkhazan*

Road Project

Drawing Title:

PLAN & PROFILE

Designed by: *Mohammad Ehsan Sial* Signature:


Drawn by: *Mohammad Ehsan Sial* Signature:



Checked by: *Habibullah Shalizi* Signature:

Date:	Scale:
6/10/2023	1:1000

Status: FINAL DESIGN

Project Code:	
Drawing Number:	PP.13
Revision:	00

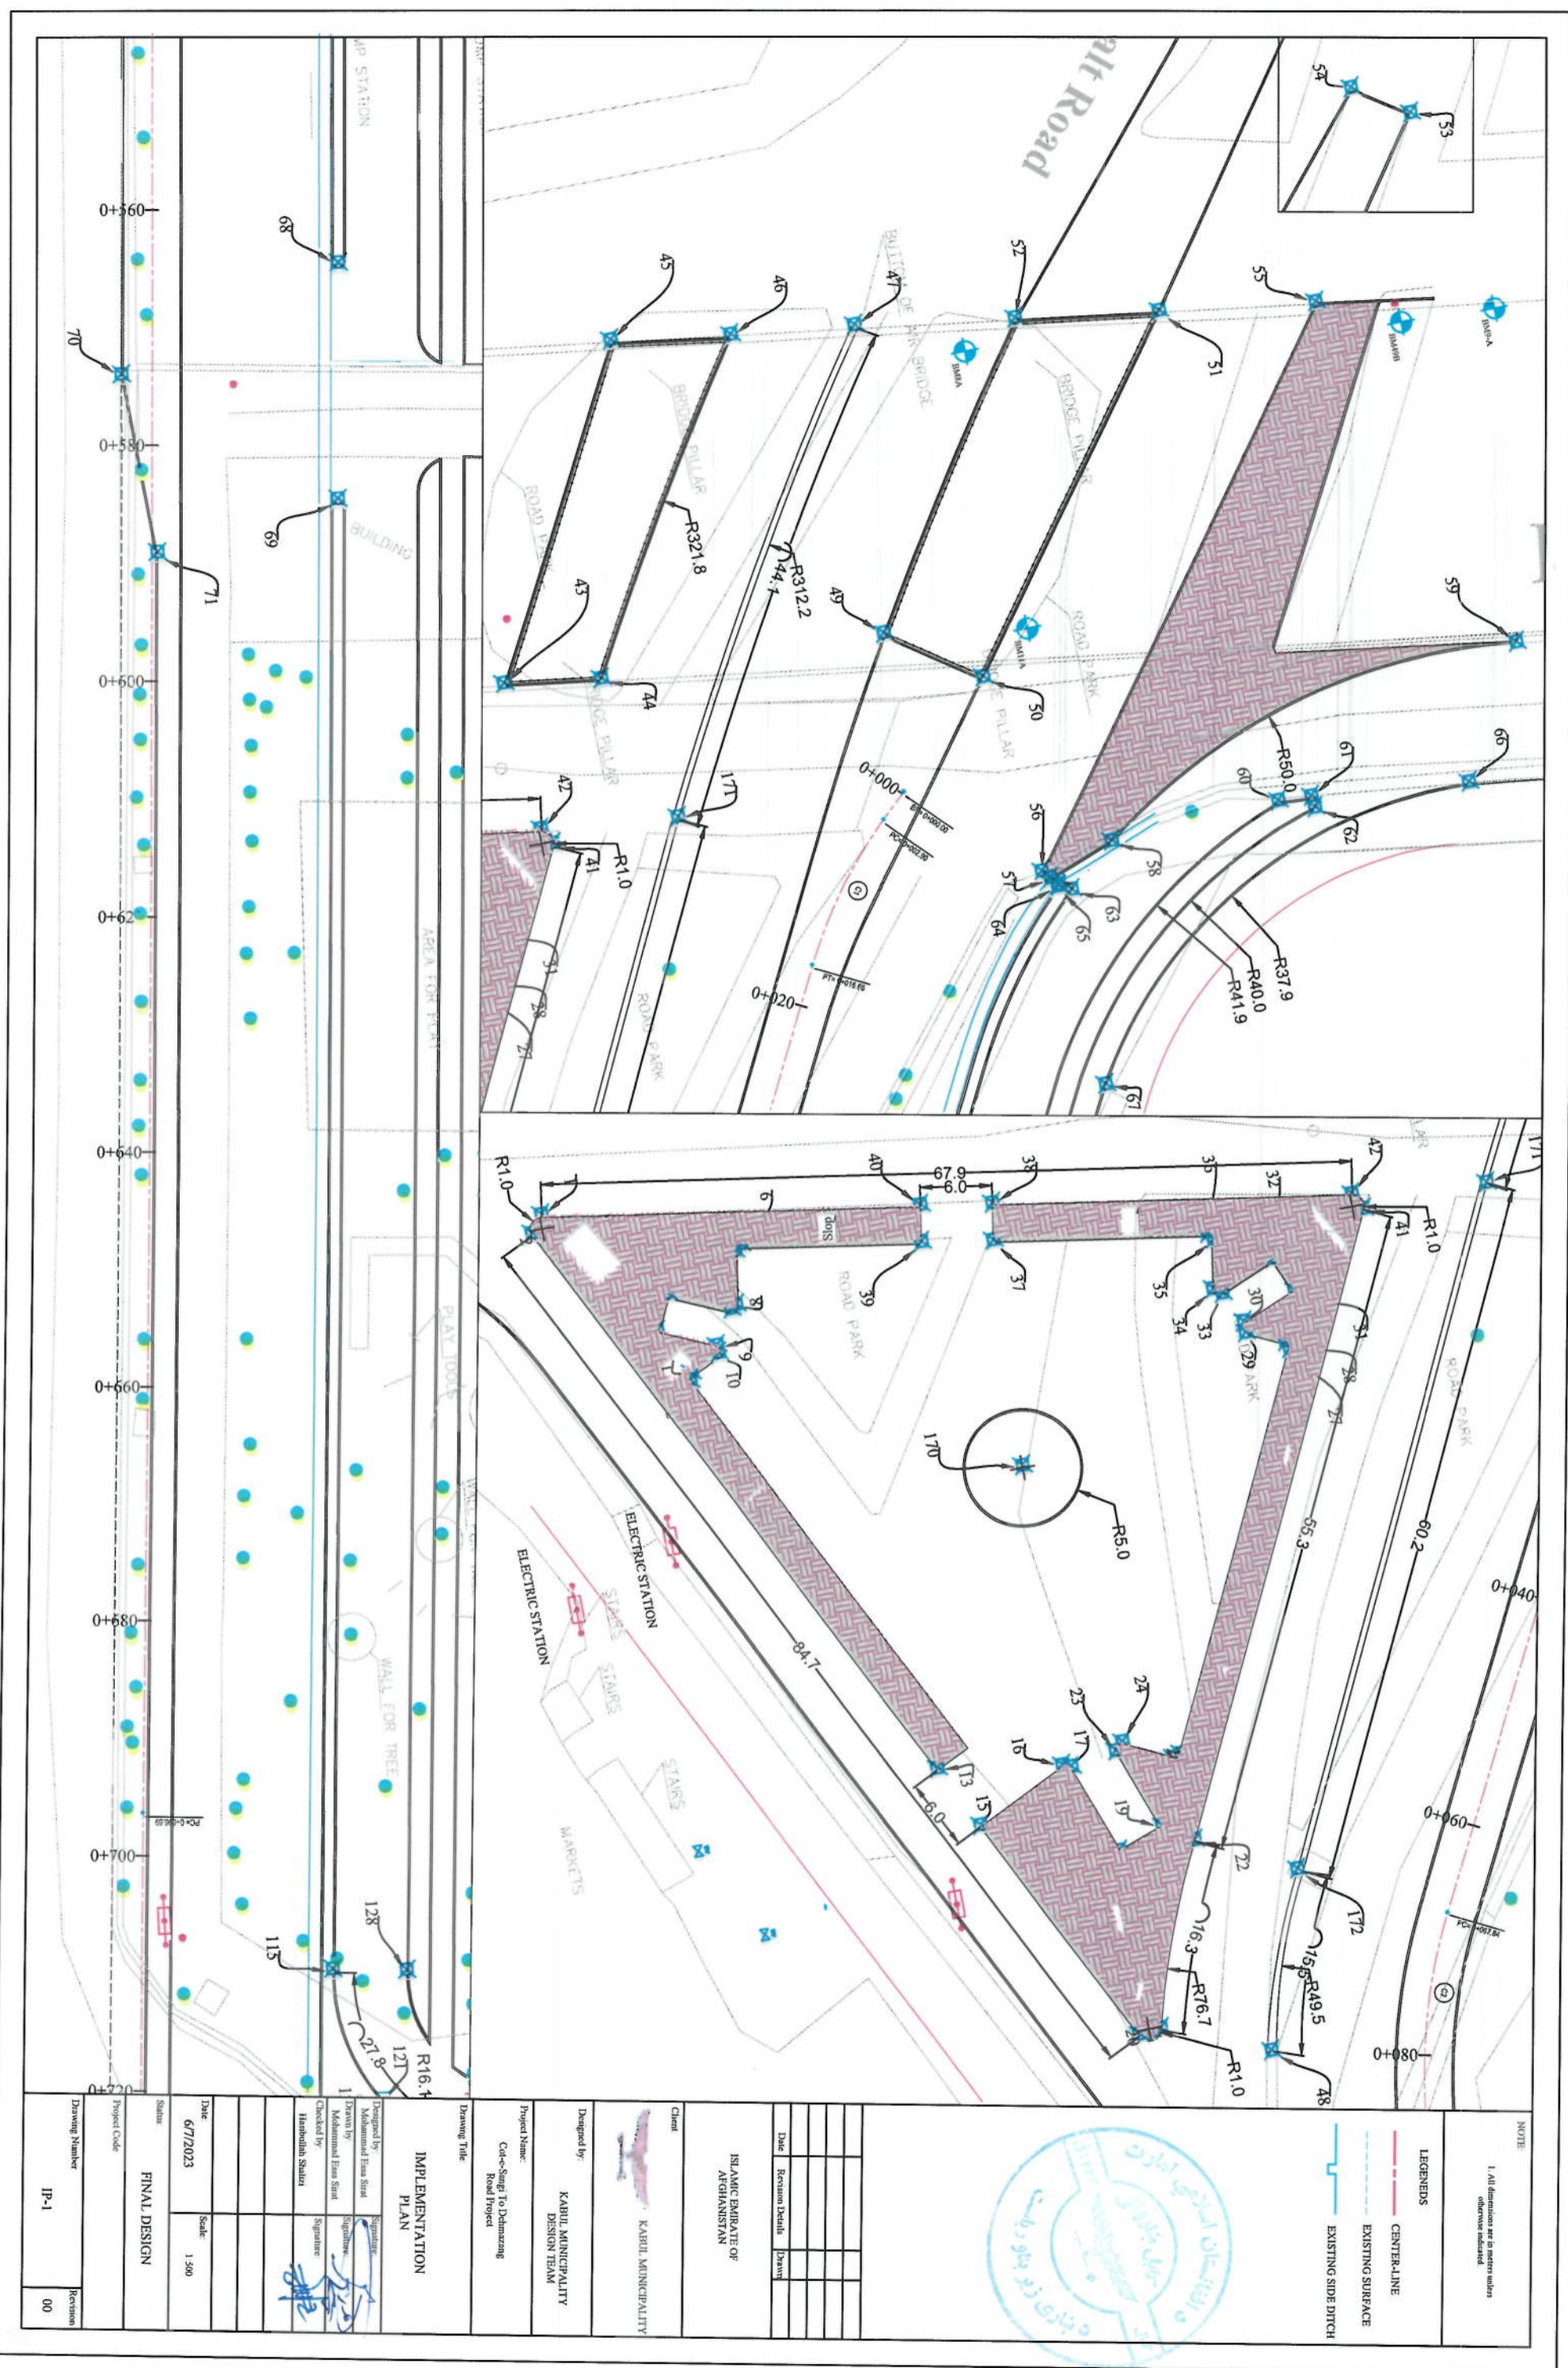

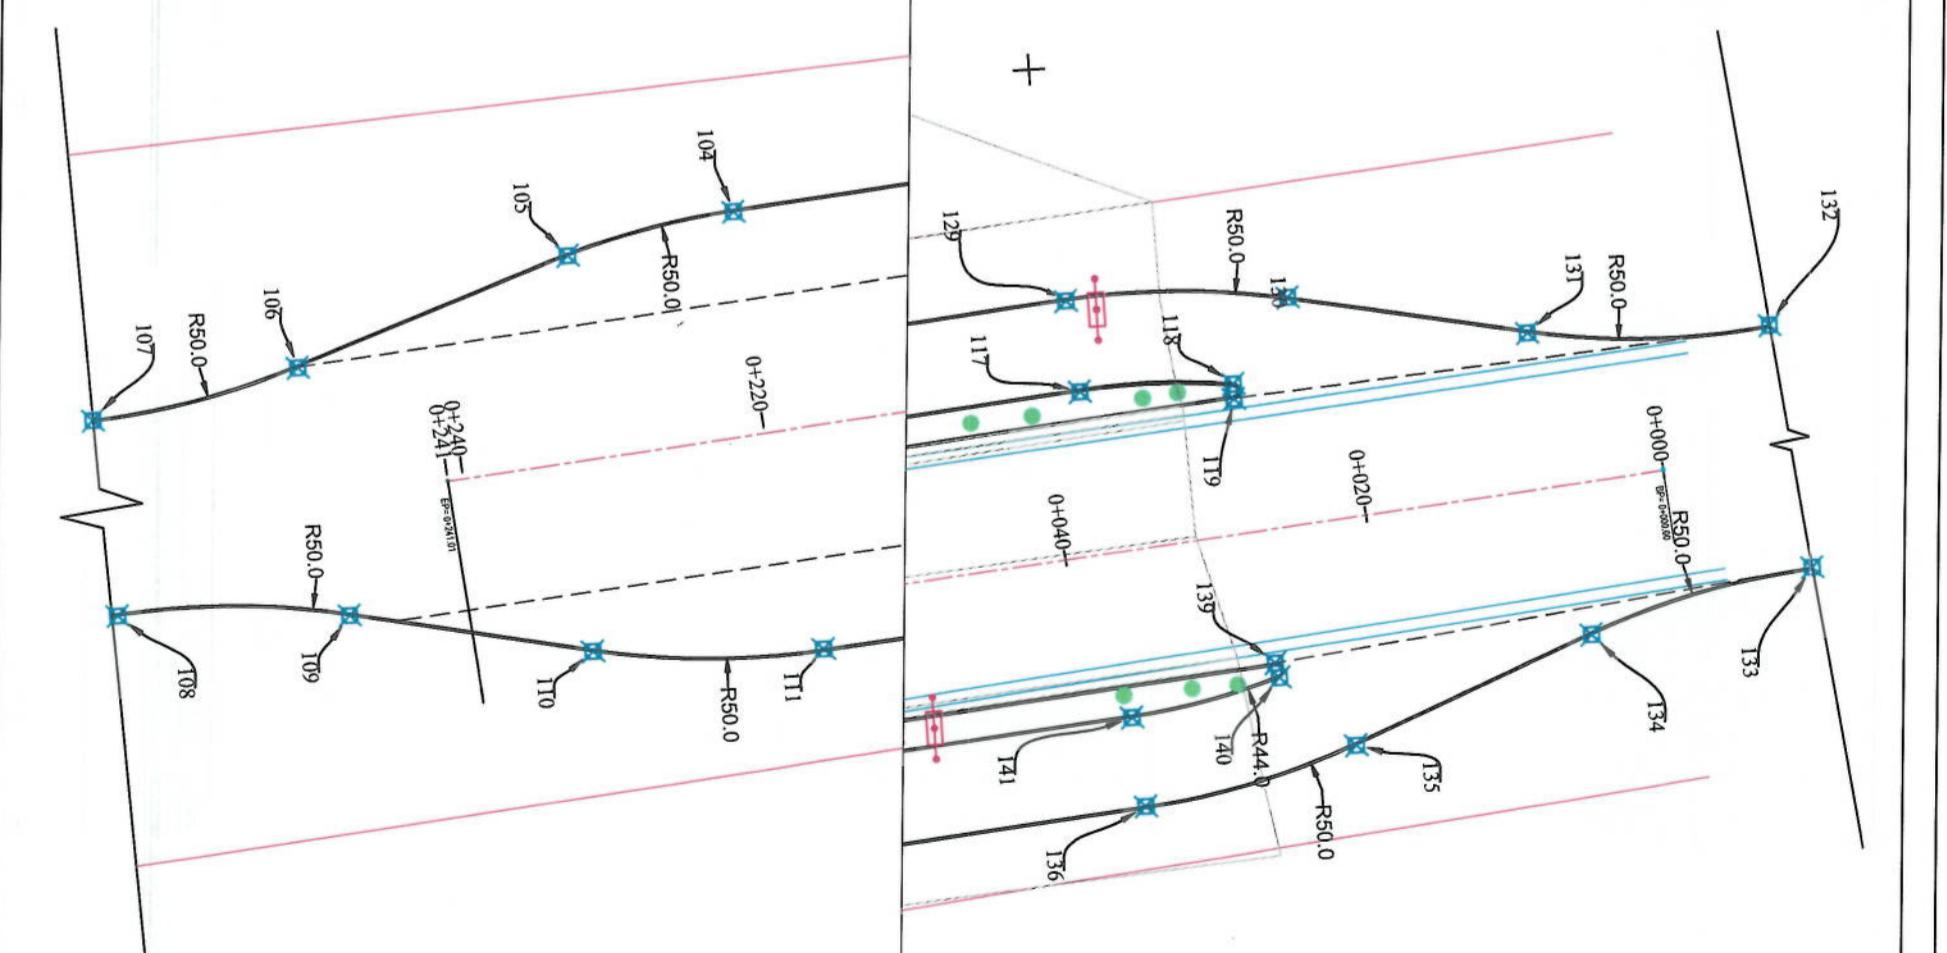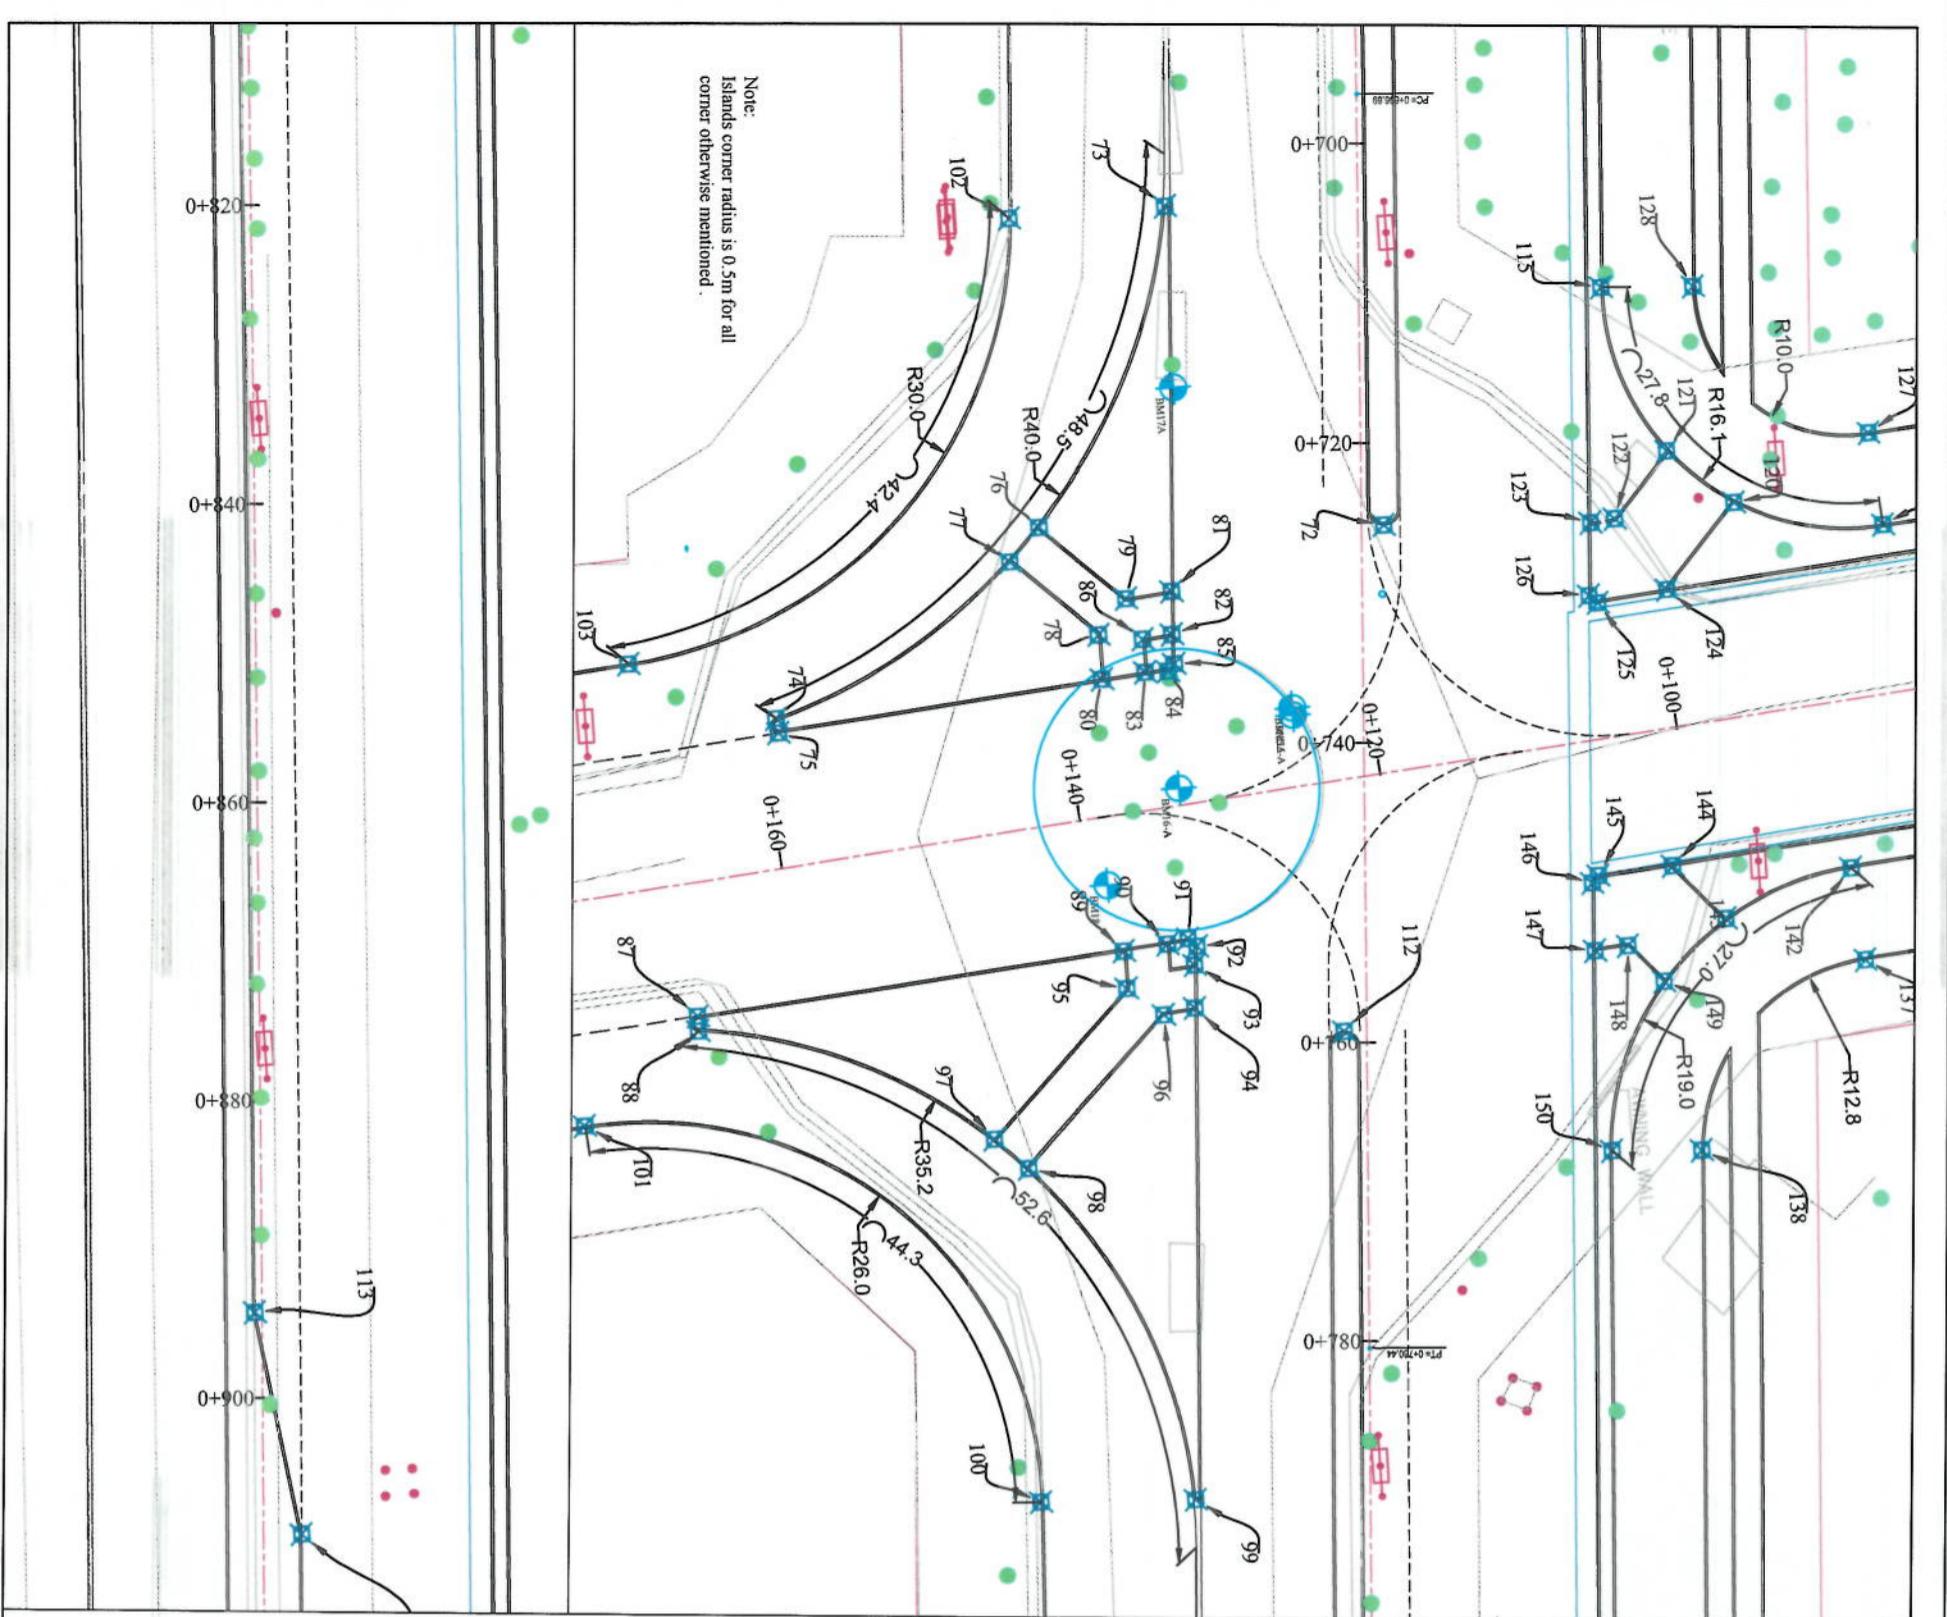


NOTE:

1. All dimensions are in meters unless otherwise indicated

LEGENDS

- CENTER-LINE** (Solid black line)
- EXISTING SURFACE** (Dashed pink line)
- EXISTING SIDE DITCH** (Blue line)

IMPLEMENTATION PLAN	
Designed by: Muhammad Eesa Sial Signature	Signature
Drawn by: Muhammad Eesa Sial Signature	Signature
Checked by: Hasbullah Shaiwi Signature	Signature
Date: 6/7/2023	Scale: 1:1000
Stamp:	
Project Code:	
IP-2	Revision 0

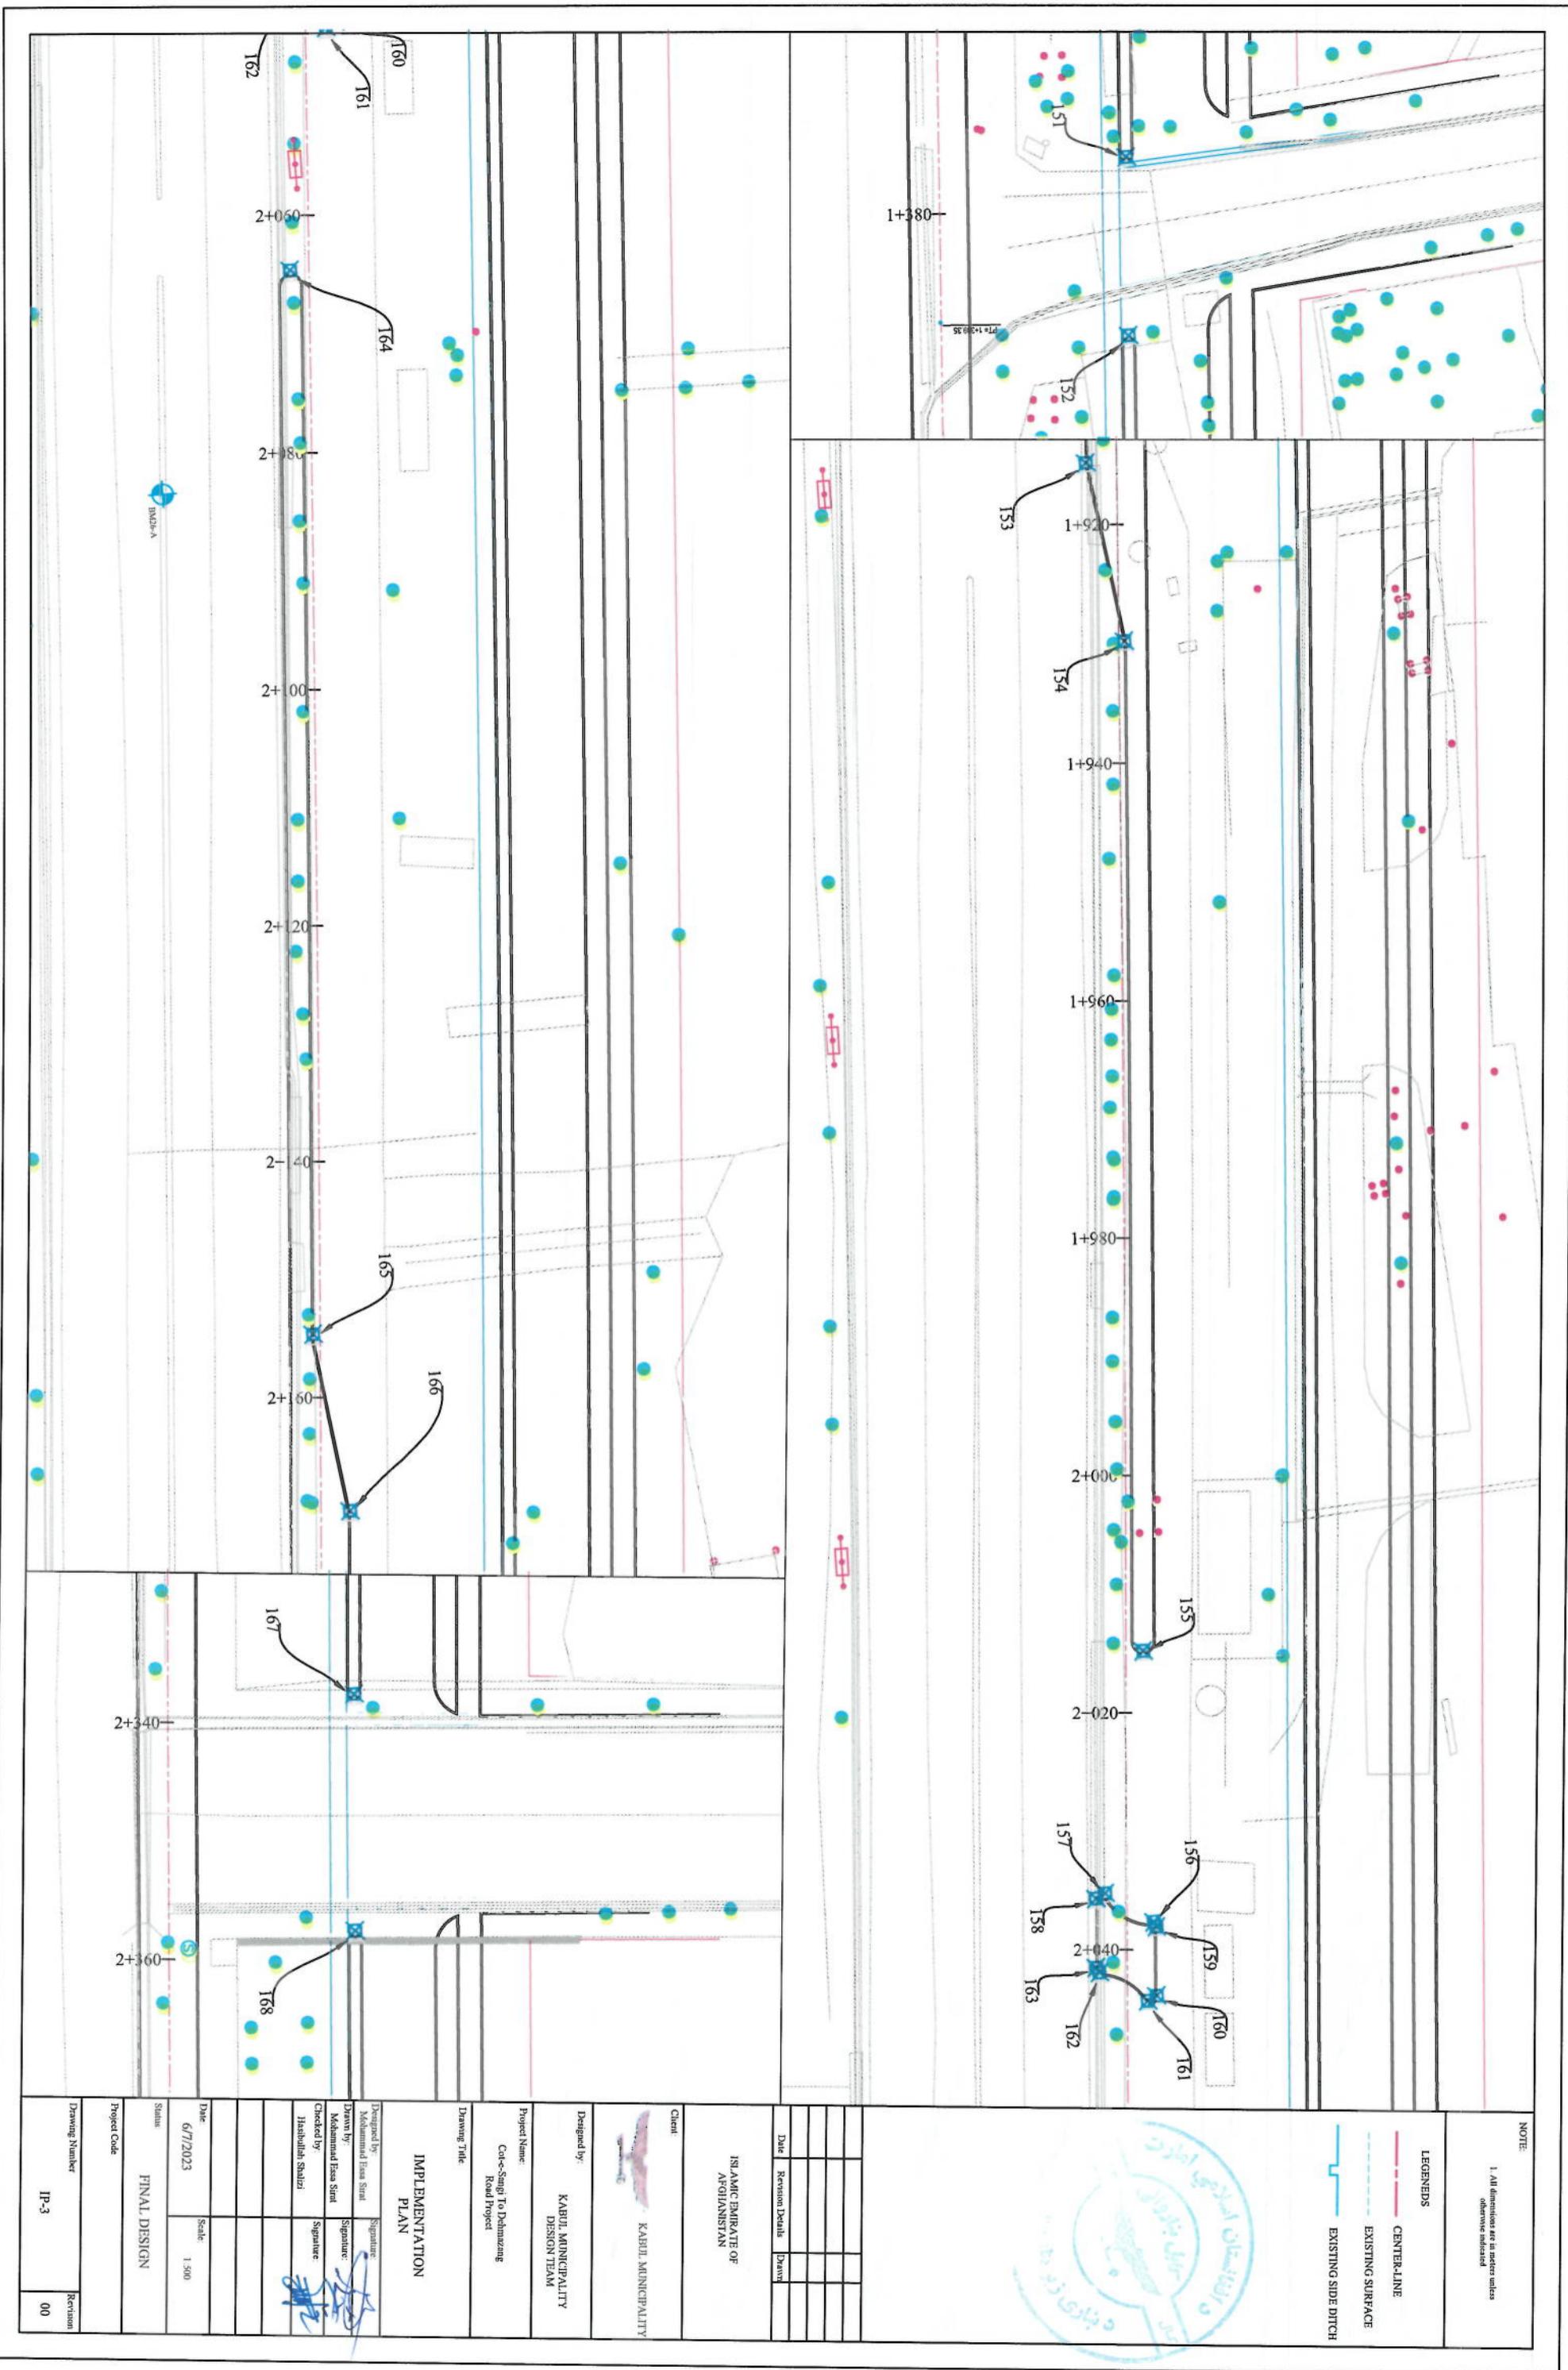

NOTE:

1. All dimensions are in meter unless otherwise indicated

LEGENDS	
	CENTER-LINE
	EXISTING SURFACE
	EXISTING SIDE DITCH



Point Table		
Point #	Northing	Eastng
1	3818901.81	510819.53
2	3818900.76	510820.95
3	3818910.83	510828.05
4	3818909.46	510831.05
5	3818917.05	510825.53
6	3818917.63	510825.12
7	3818915.83	510830.34
8	3818916.32	510830.07
9	3818914.09	510833.17
10	3818914.10	510833.80
11	3818911.57	510835.04
12	3818911.34	510835.71
13	3818925.70	510871.78
15	3818928.34	510877.16
16	3818936.05	510873.38
17	3818936.74	510873.66
18	3818939.32	510881.37
19	3818943.25	510879.97
20	3818938.09	510897.03
21	3818939.96	510898.84



Point Table		
Point #	Northing	Eastng
22	3818945.67	510881.62
23	3818940.61	510872.98
24	3818941.30	510872.36
25	3818945.24	510874.41
26	3818945.91	510874.17
27	3818961.18	510842.22
28	3818960.95	510841.56
29	3818957.76	510840.20
30	3818957.79	510839.29
31	3818962.49	510837.51
32	3818961.23	510834.46
33	3818956.43	510836.60
34	3818955.75	510836.06
35	3818956.57	510831.92
36	3818956.16	510831.34
37	3818938.49	510828.64
38	3818938.99	510825.53
39	3818932.56	510827.68
40	3818933.07	510824.53
41	3818969.51	510831.76
50	3819007.44	510824.71
51	3819027.73	510797.19
52	3819015.81	510795.53
53	3819059.01	510753.44
54	3819054.48	510750.41
55	3819040.81	510798.94
56	3819009.16	510841.74
57	3819009.76	510842.48
58	3819015.33	510840.30
59	3819052.06	510830.26
60	3819029.73	510839.59
61	3819032.54	510839.75

Point Table		
Point #	Northing	Eastng
142	3818952.43	511572.14
143	3818943.84	511574.95
144	3818940.53	511571.24
145	3818935.54	511571.55
164	3818841.75	512884.34
165	3818837.44	512974.19
166	3818839.58	512989.34
167	3818842.81	513157.79
168	3818841.52	513177.75
169	3818790.79	514018.14
170	3818937.37	510847.88
171	3818890.16	510831.52
172	3818953.75	510885.58

Point Table		
Point #	Northing	Eastng
162	3818842.35	512881.48
163	3818842.13	512861.04
164	3818840.75	512884.34
165	3818837.44	512974.19
166	3818839.58	512989.34
167	3818842.81	513157.79
168	3818841.52	513177.75
169	3818790.79	514018.14
170	3818937.37	510847.88
171	3818890.16	510831.52


BM Point Table			
Description	Elevation	Northing	Eastng
BM11A	1800.02	3819011.84	510821.46
BM8A	1800.02	3819011.15	510797.57
BM10A	1799.66	3818943.37	510812.19
BM49B	1799.79	3818047.57	510802.07
BM13A	1789.96	3818938.70	51039.05
BM12-A	1790.32	3818943.01	510970.65
BM13-A	1789.96	3818938.70	51039.05
BM15-A	1786.97	3818916.09	511559.49
BM15A	1786.97	3818916.09	511559.00
BM16-A	1787.40	3818908.23	511563.91
BM17A	1786.52	3818908.68	511537.21
BM18	1787.06	3818903.13	511570.06
BM20A	1784.46	3818925.46	511266.81
BM16-A	1787.40	3818908.23	511563.91
BM19A	1784.99	3818893.97	511819.84
BM21A	1783.43	3818873.51	512168.46
BM22-A	1783.18	3818868.63	512248.86
BM23-A	1782.01	3818856.51	512452.11
BM27-A	1778.76	3818815.91	513141.55
BM28-A	1778.57	3818812.54	513190.90
BM25-A	1777.38	3818788.47	51303.12
BM26-A	1776.85	3818782.53	513709.73
BM24-A	1781.39	3818850.24	512560.79
BM25-A	1780.96	3818840.42	512726.51
BM26-A	1780.28	3818829.76	512902.45
BM29-A	1775.75	3818766.61	513979.86
BM30-A	1775.94	3818761.68	514058.54
BM45-A	1794.36	3819244.24	510494.53
BM6-A	1793.36	3819193.18	510583.92
BM31-A	1776.00	3818761.17	514075.48
BM32-A	1775.98	3818753.86	514061.99
BM32-A	1775.95	3818754.39	514062.59



IMPLEMENTATION PLAN		
Designed by:	Signature:	Date:
Mohammad Esa Sial		6/7/2023
Mohammed Ishaq Sial		Sale: 1-500
Checkered by:	Signature:	Status: FINAL DESIGN
Ibrahim Shatila		Project Code:

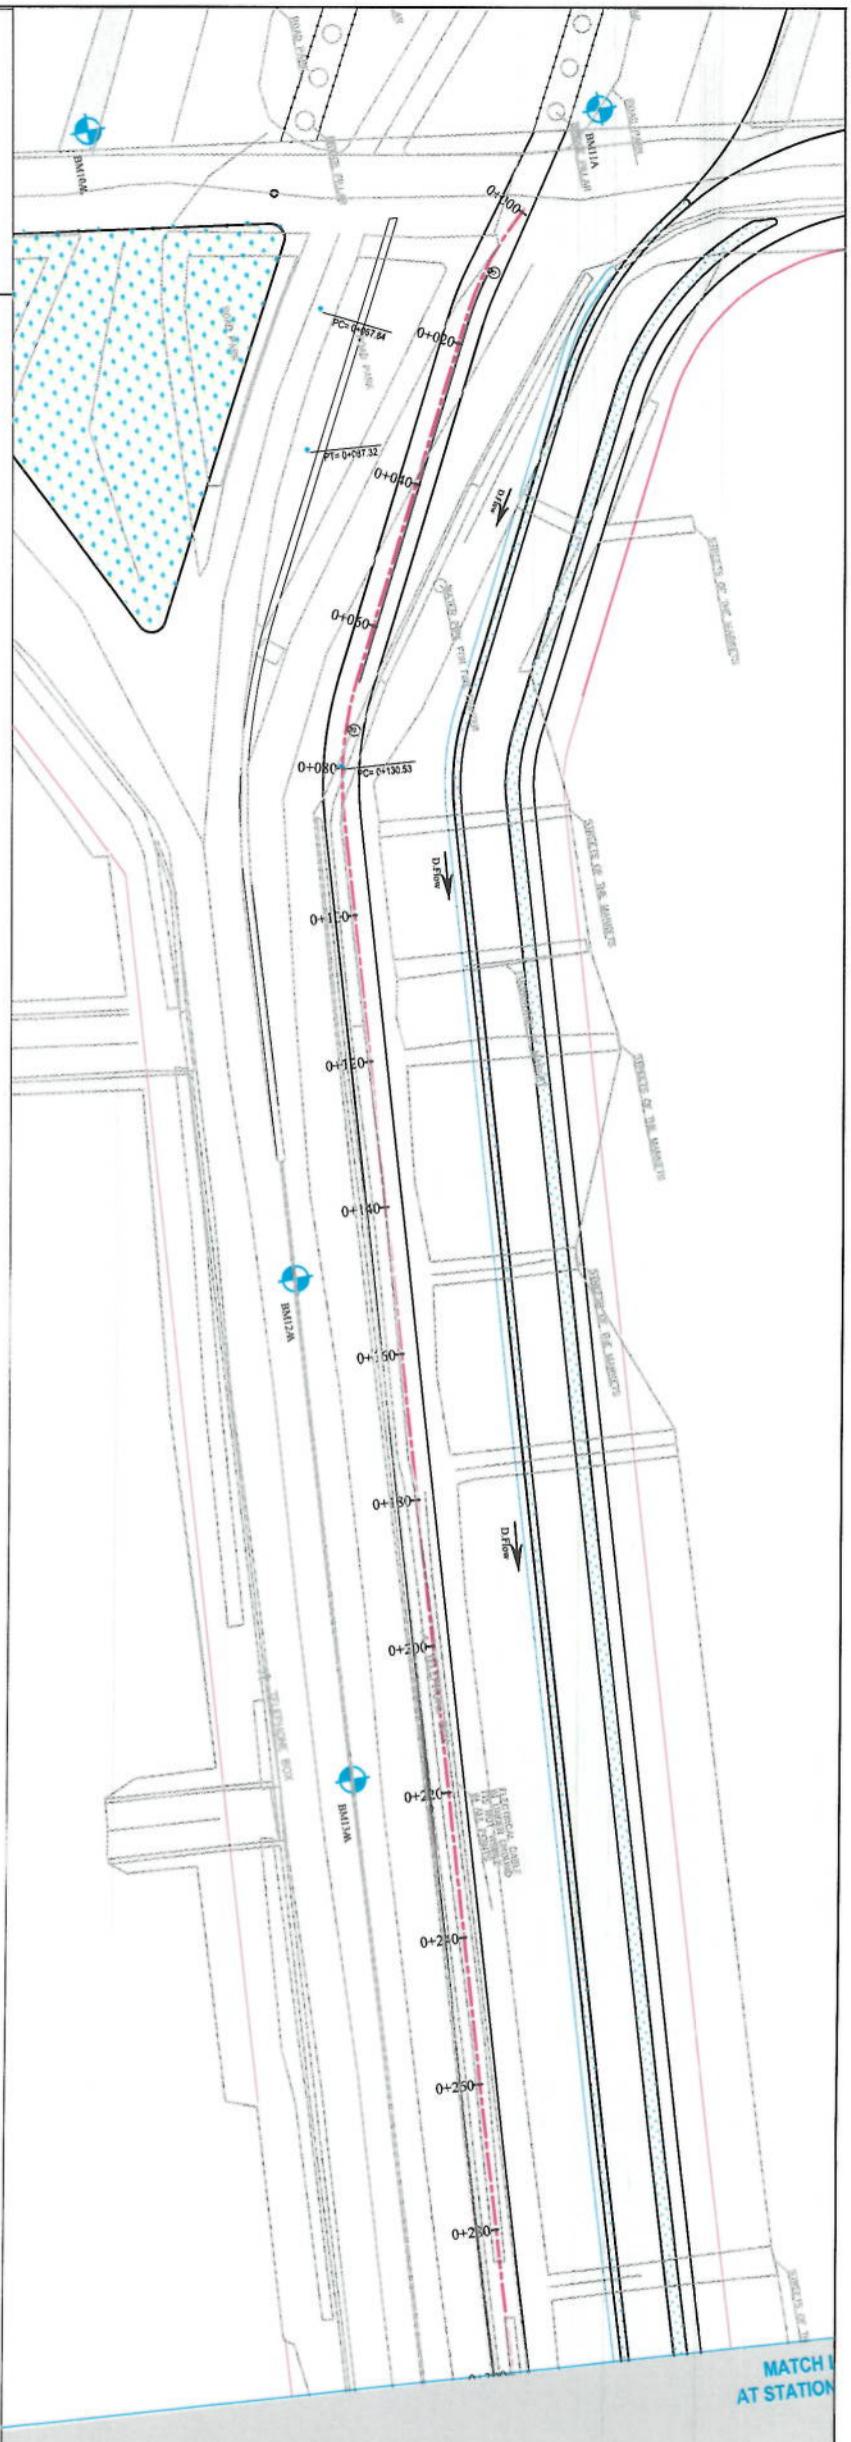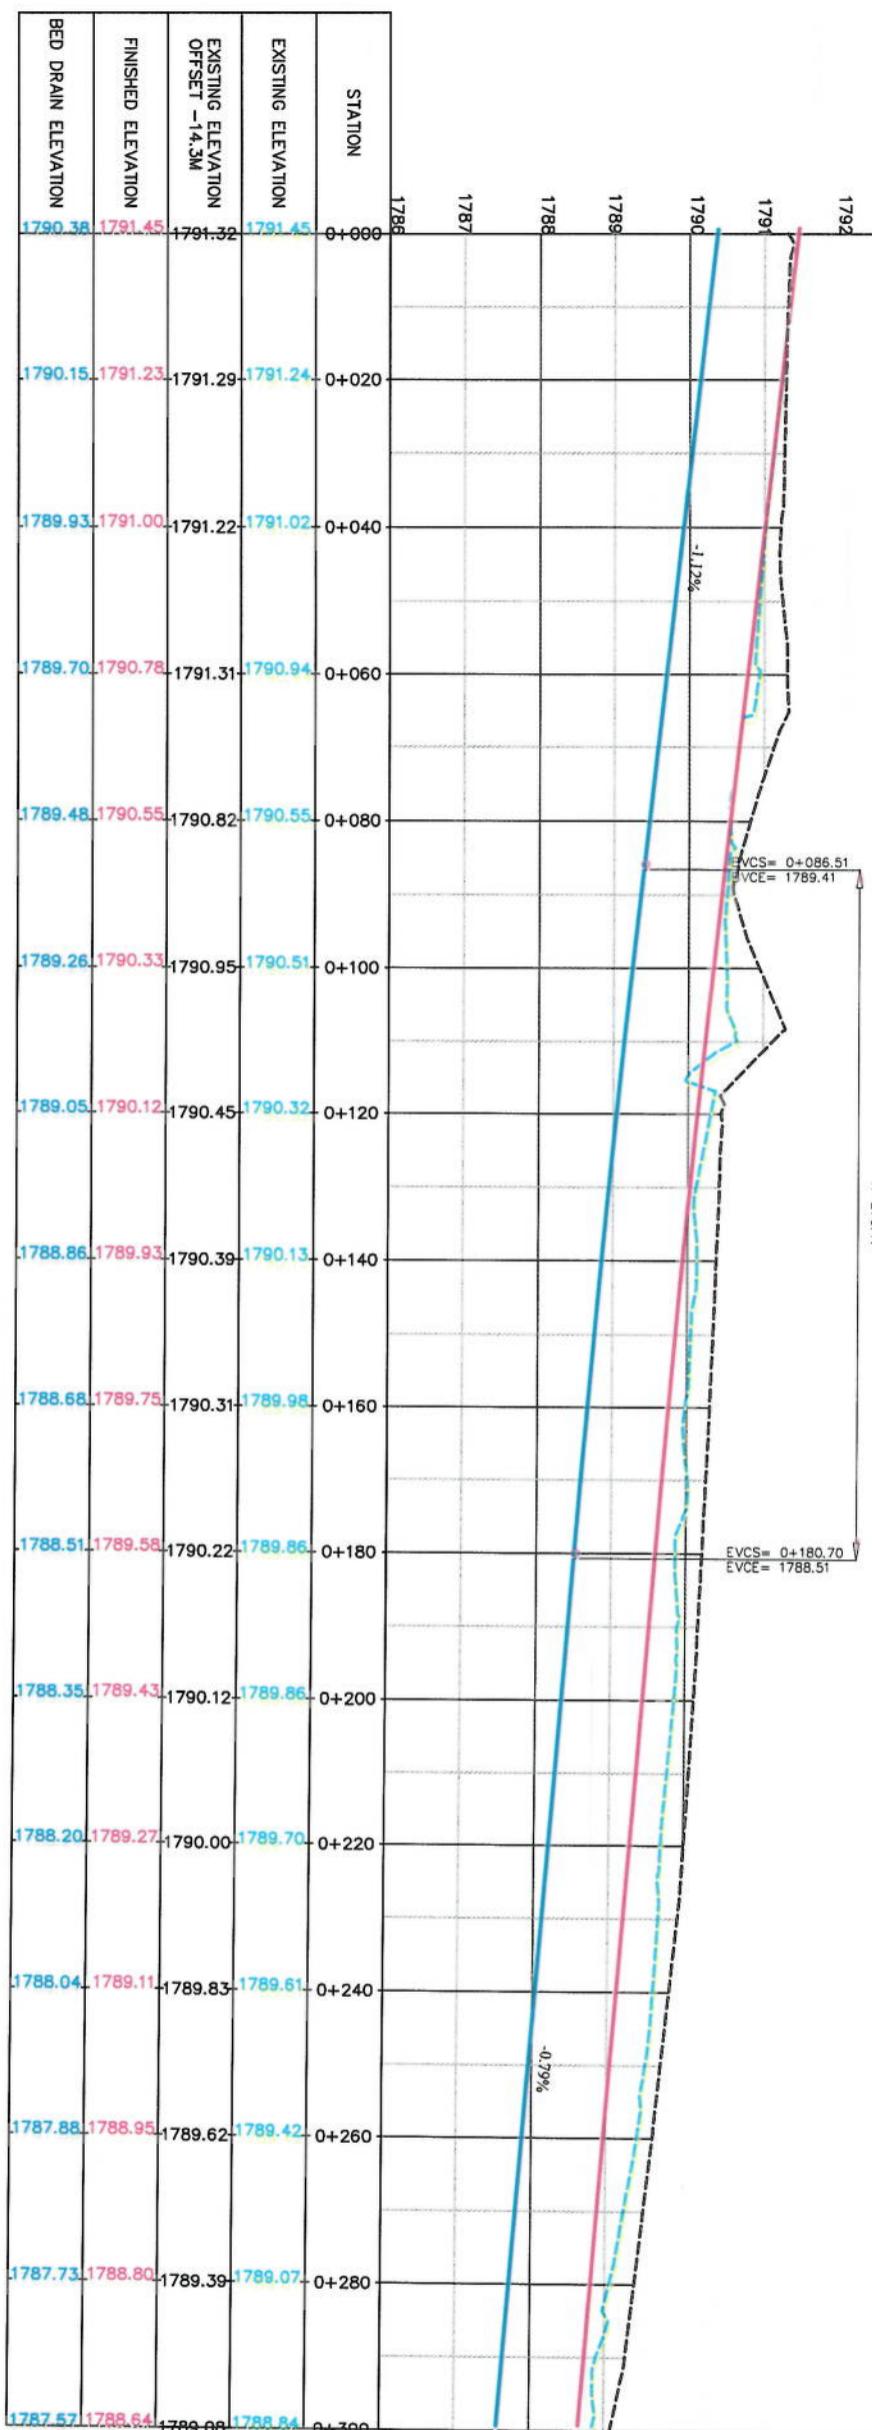




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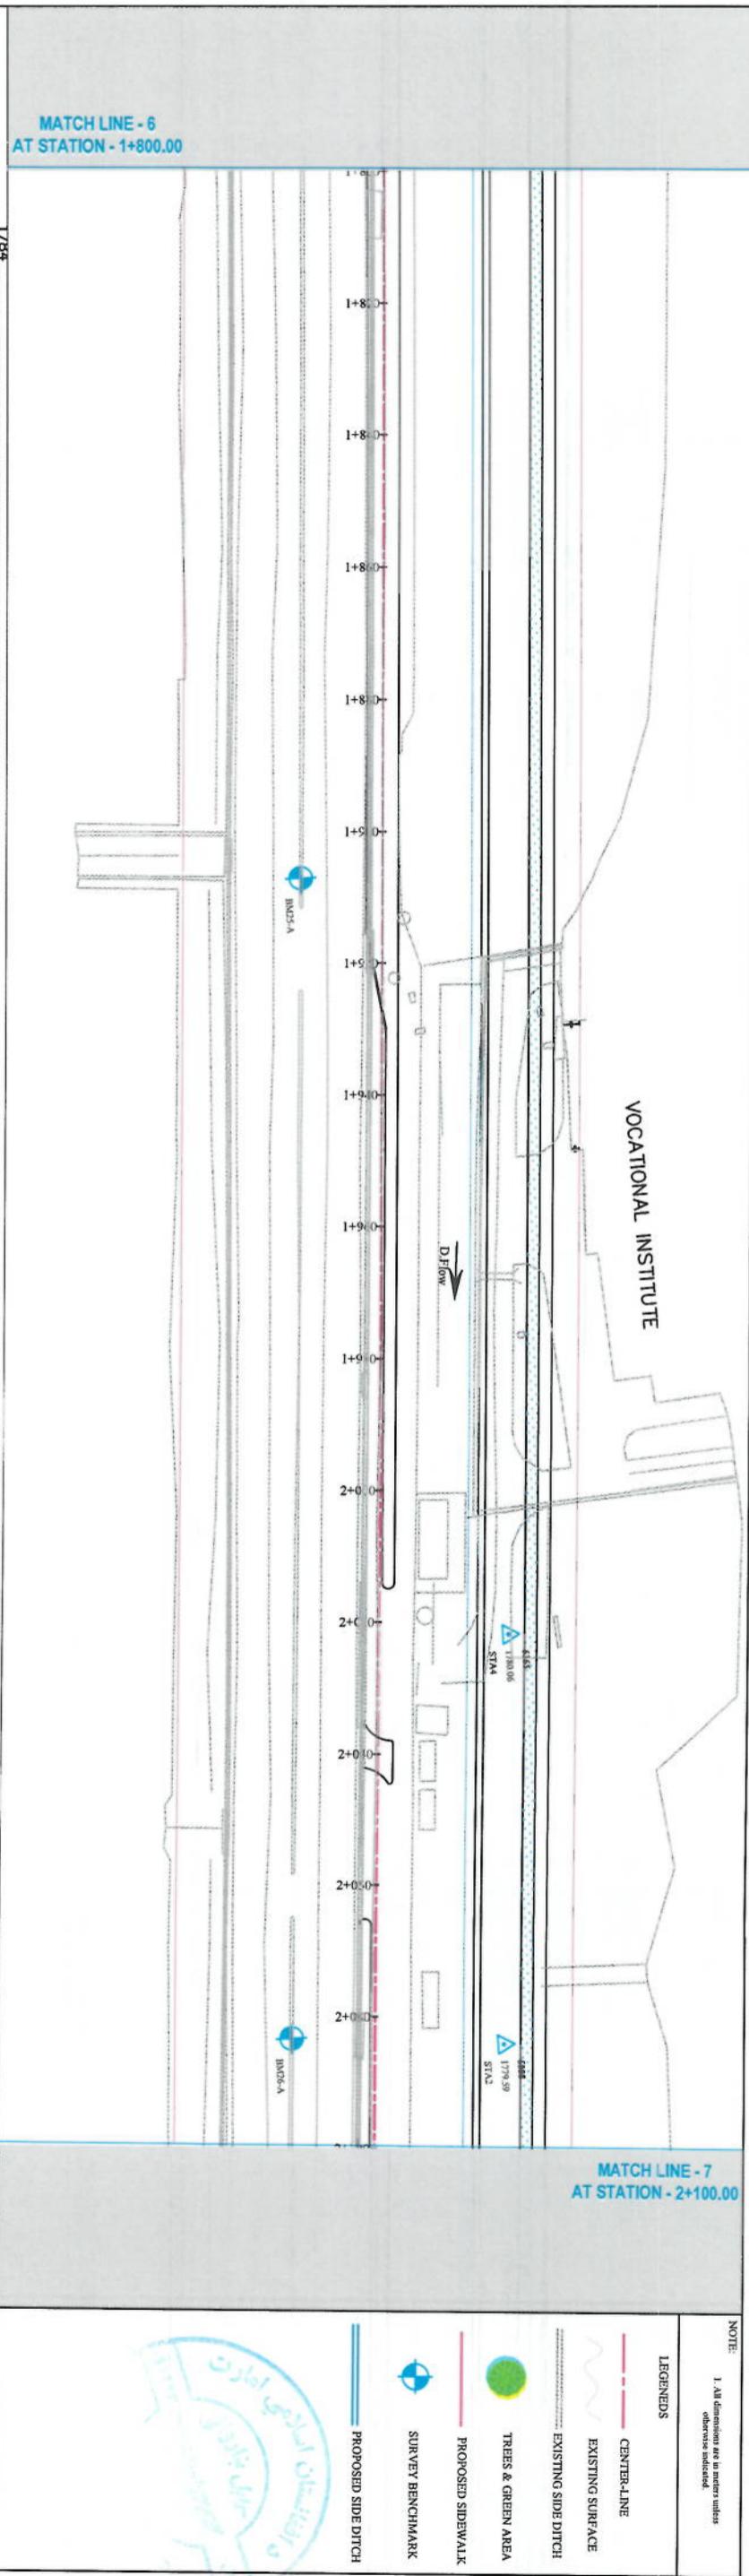
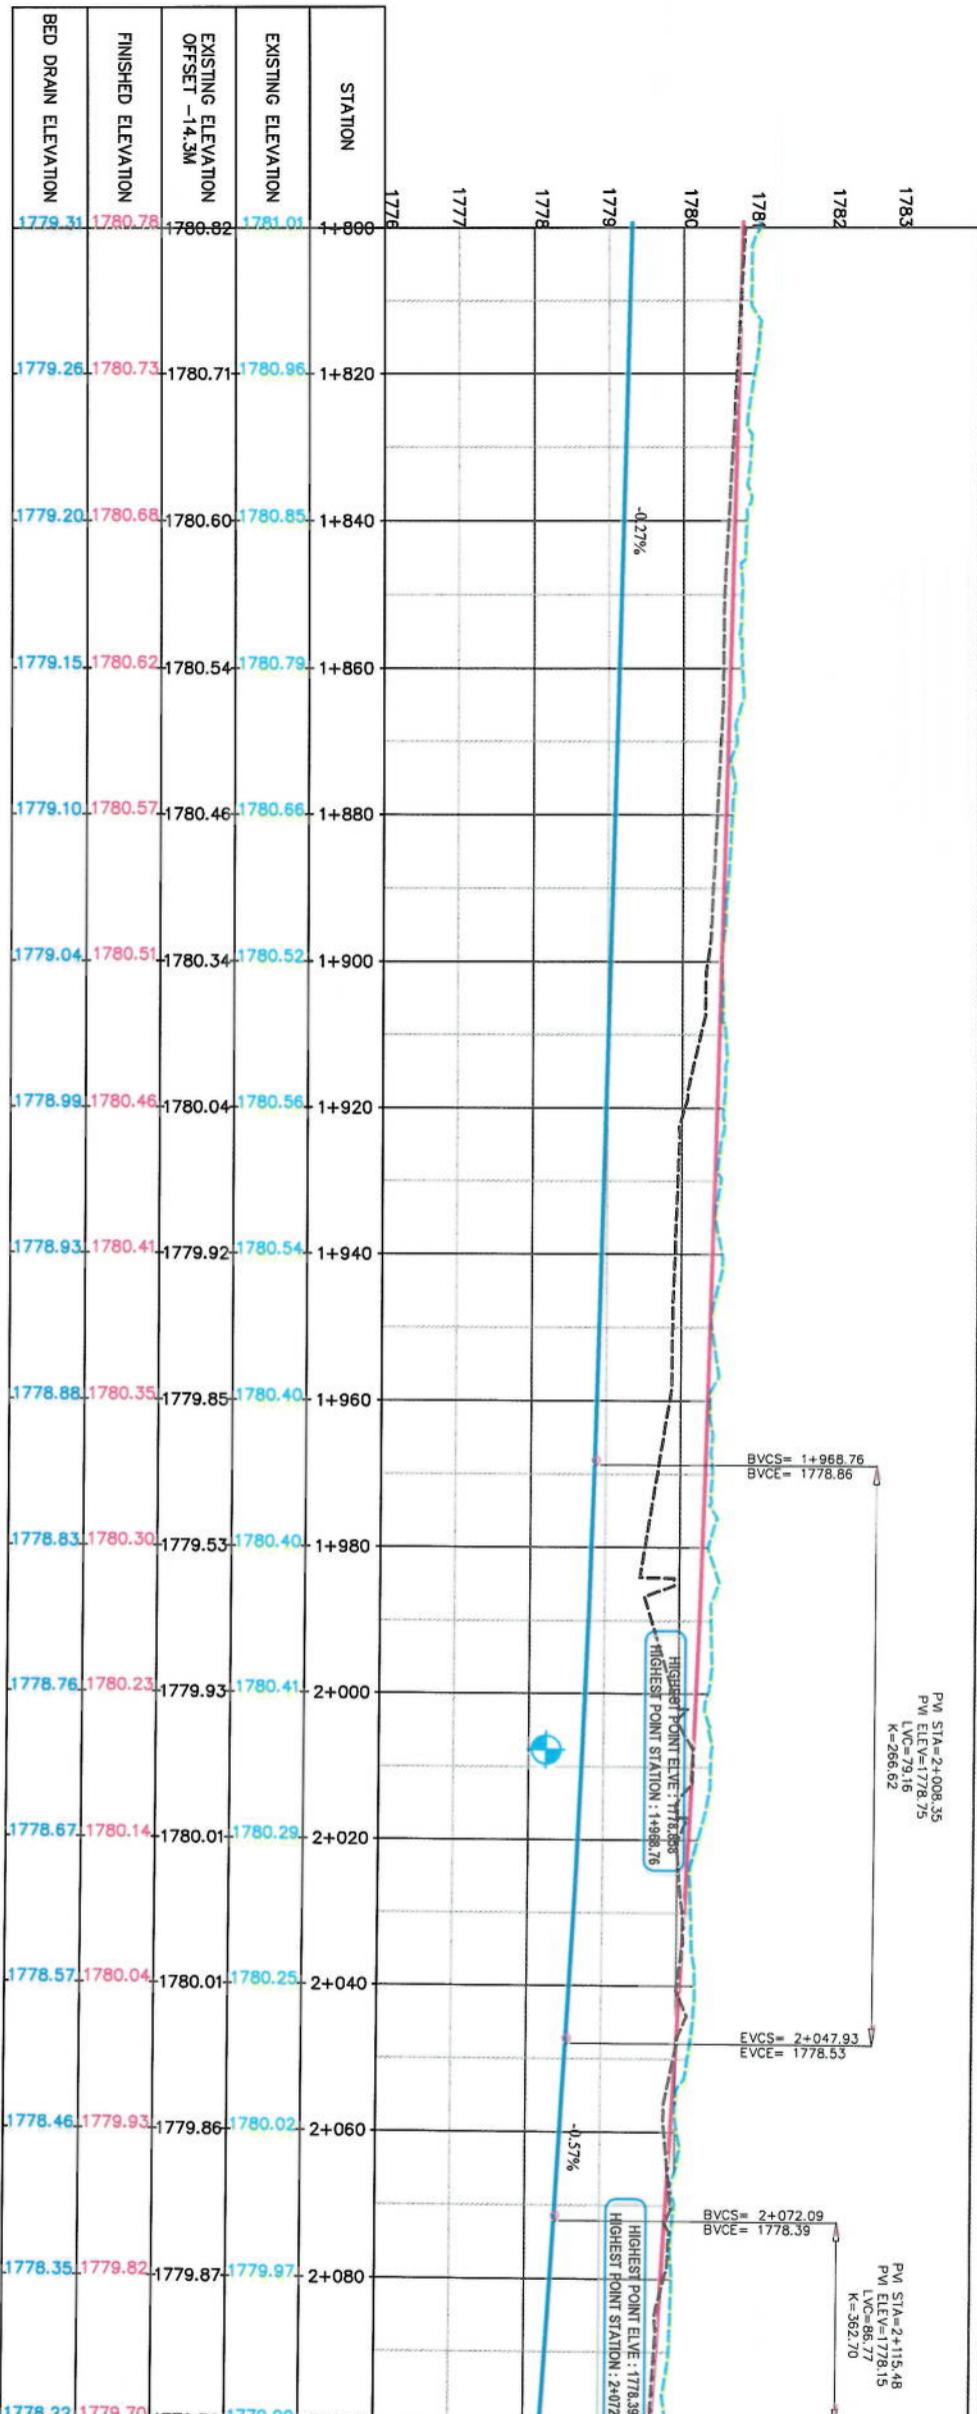
1. All dimensions are in meters unless otherwise indicated.





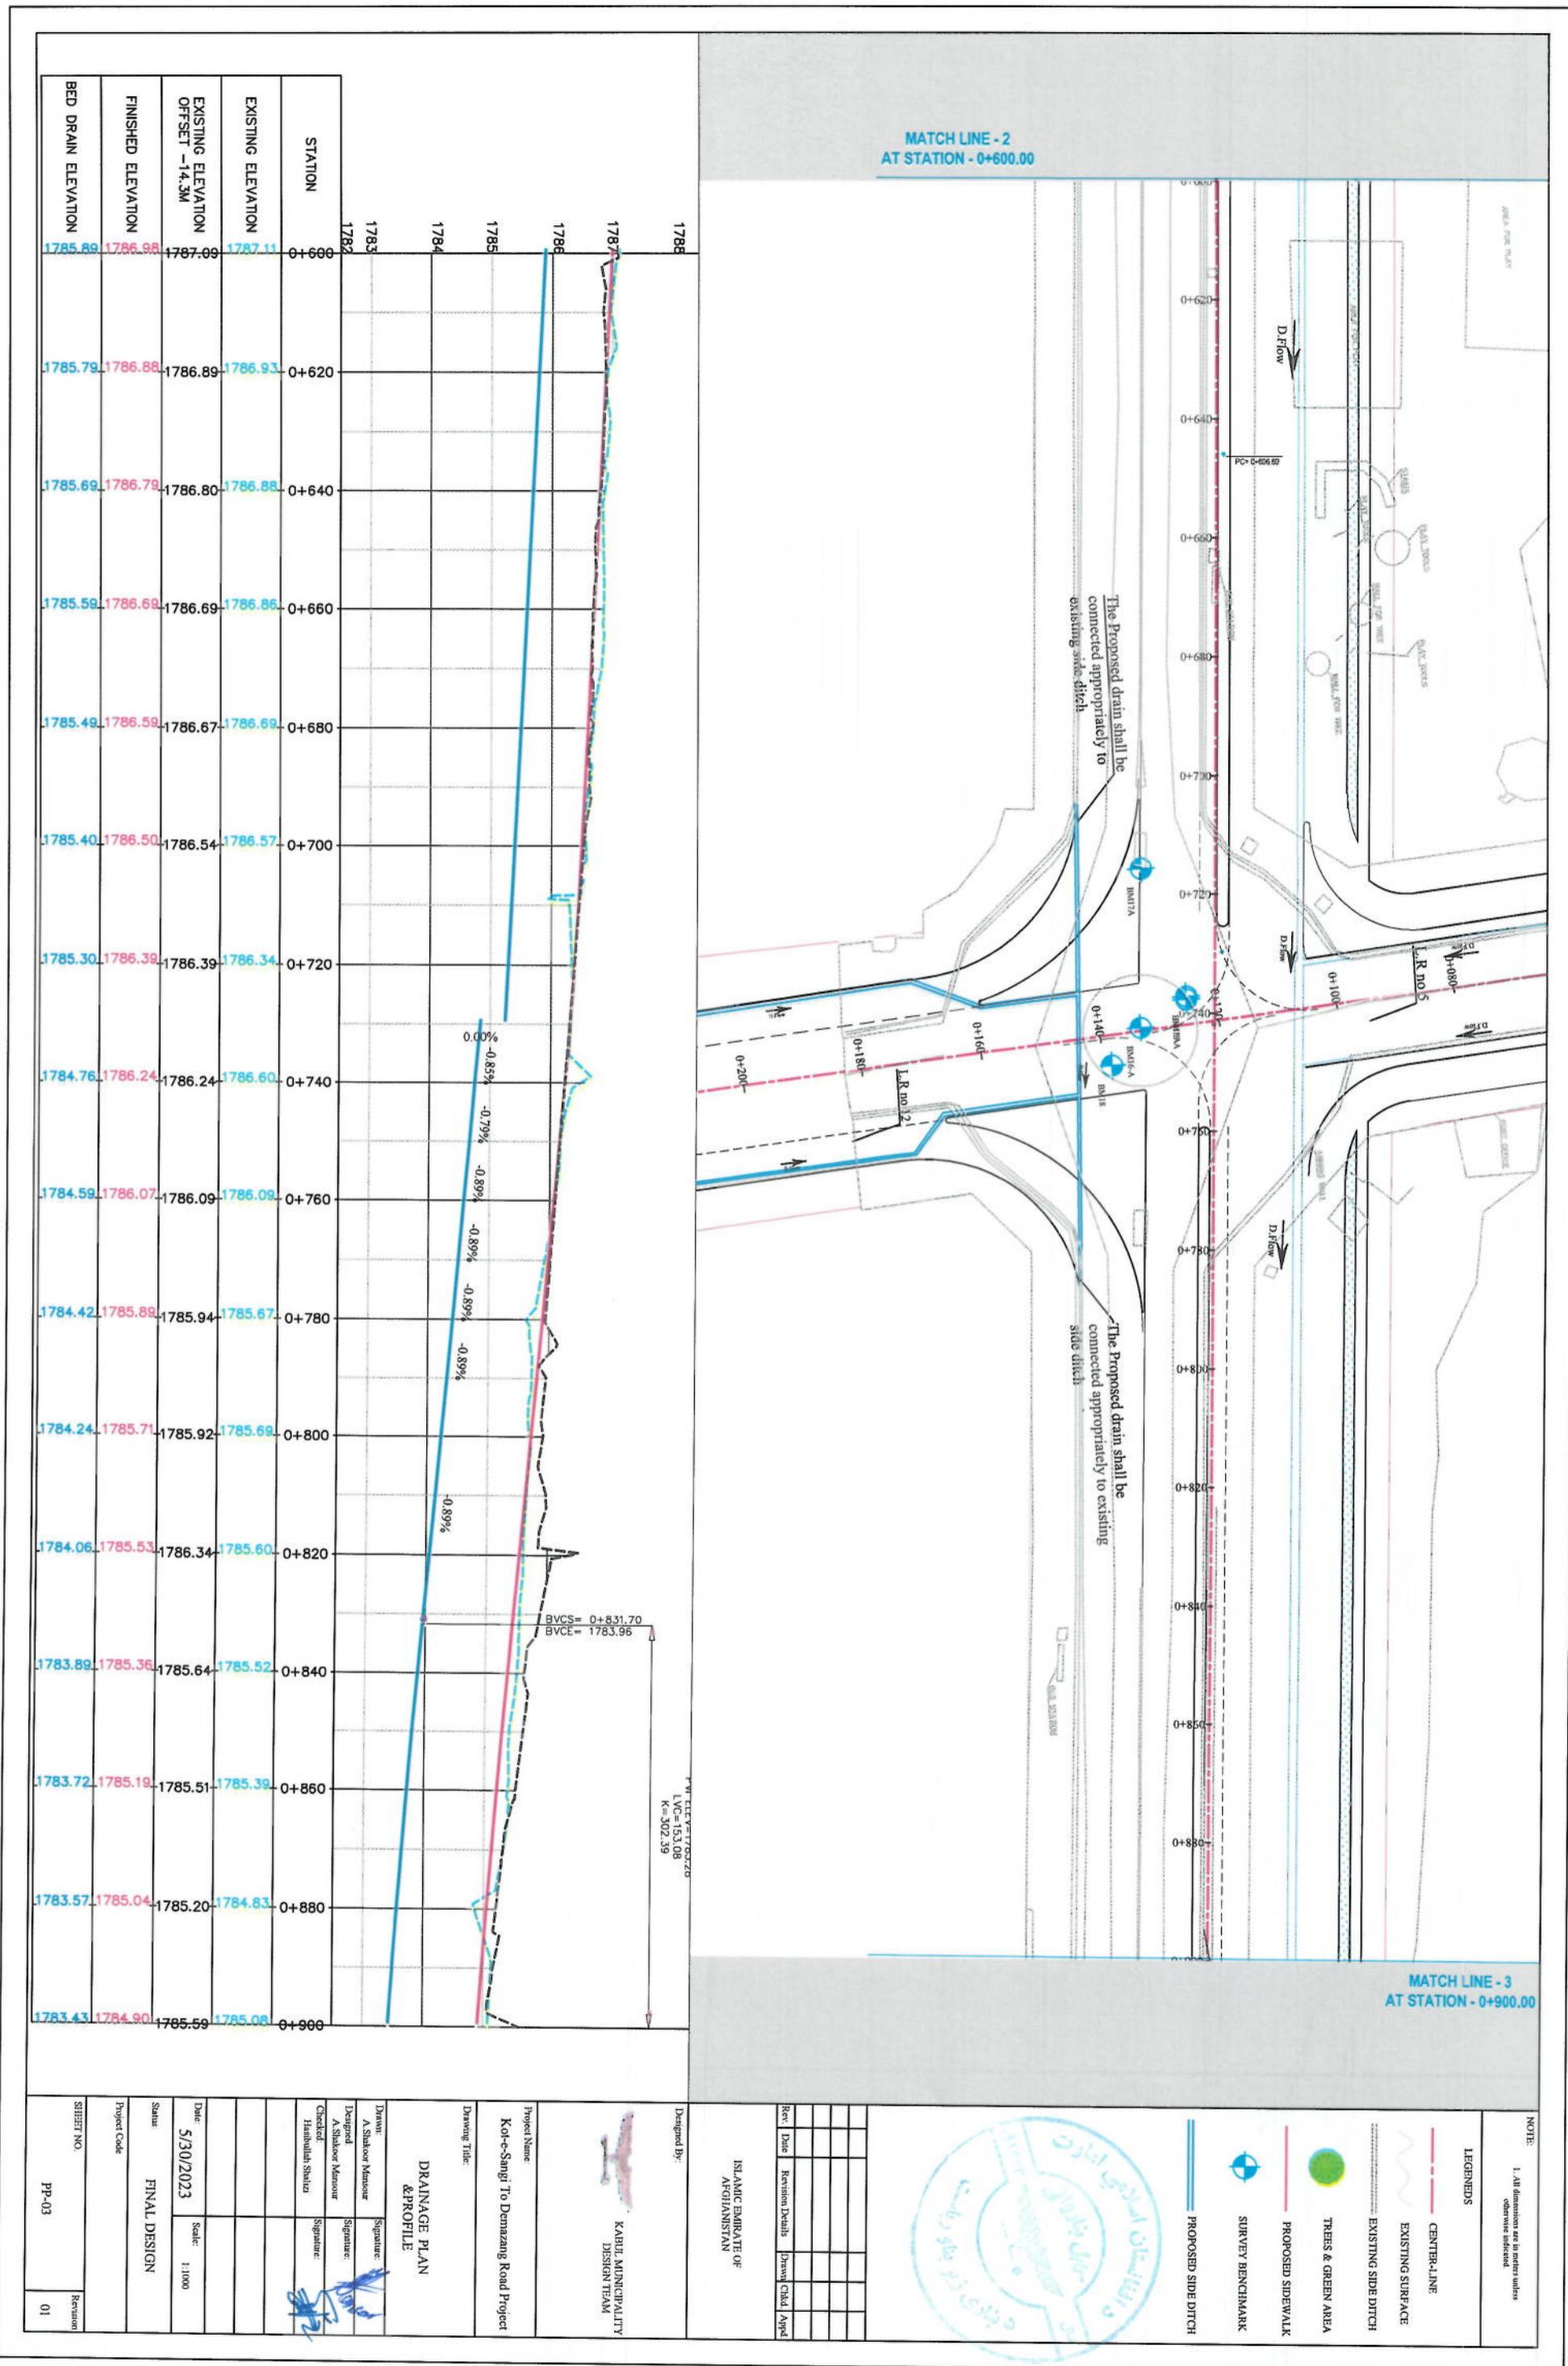

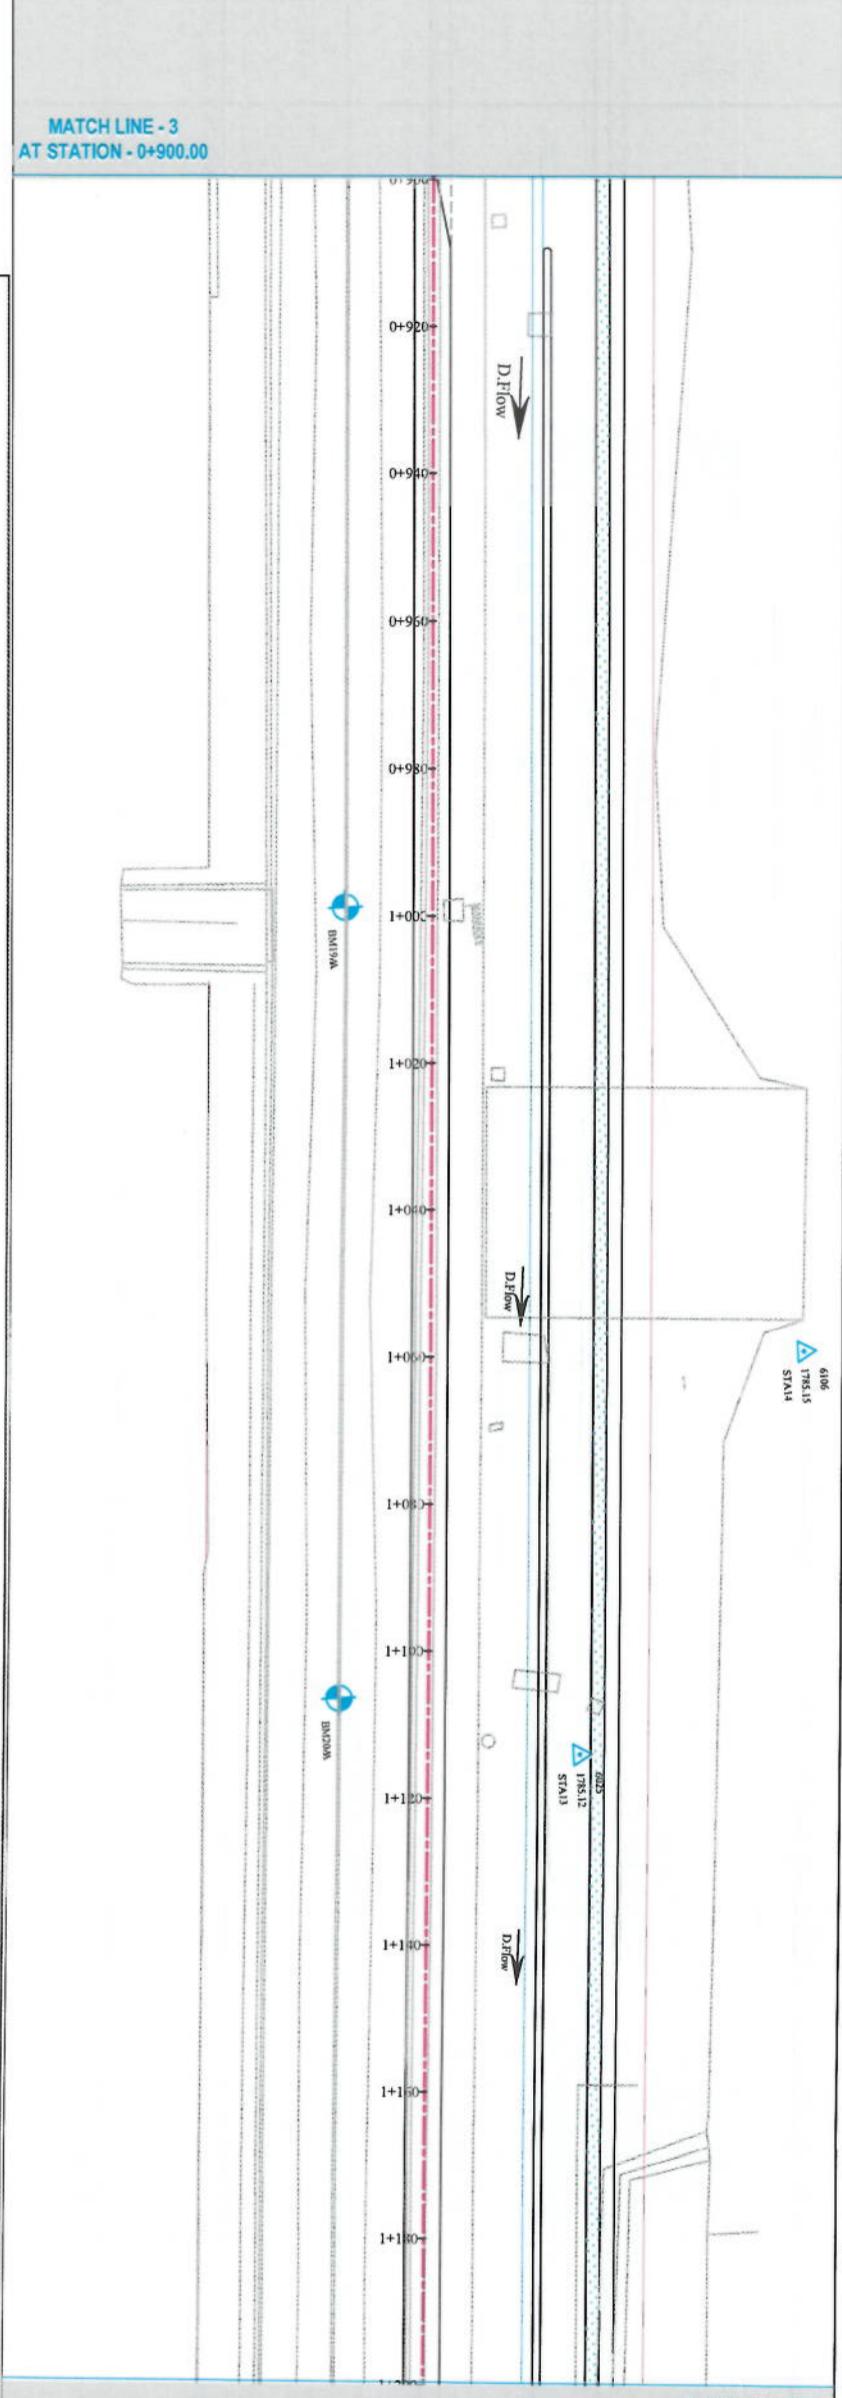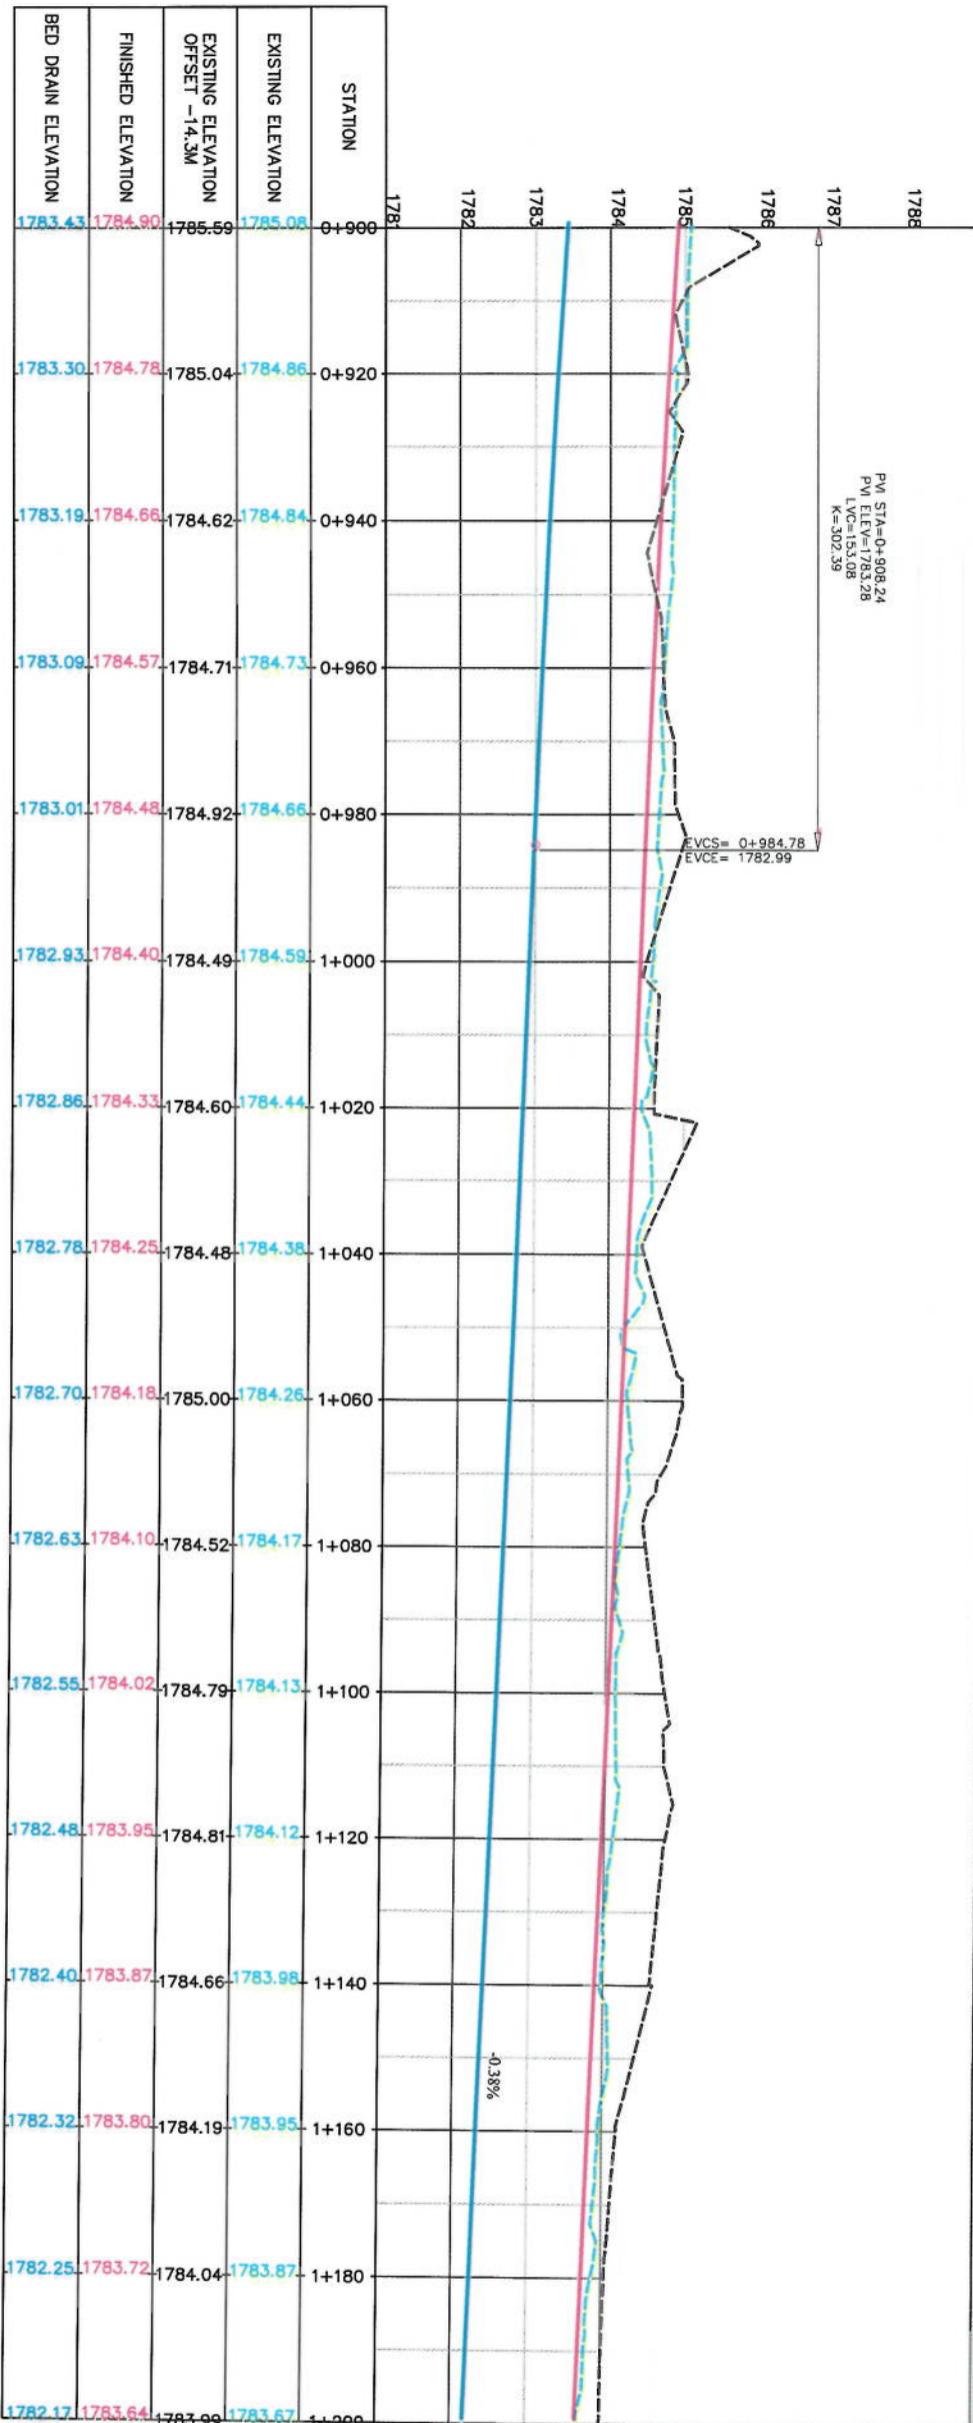

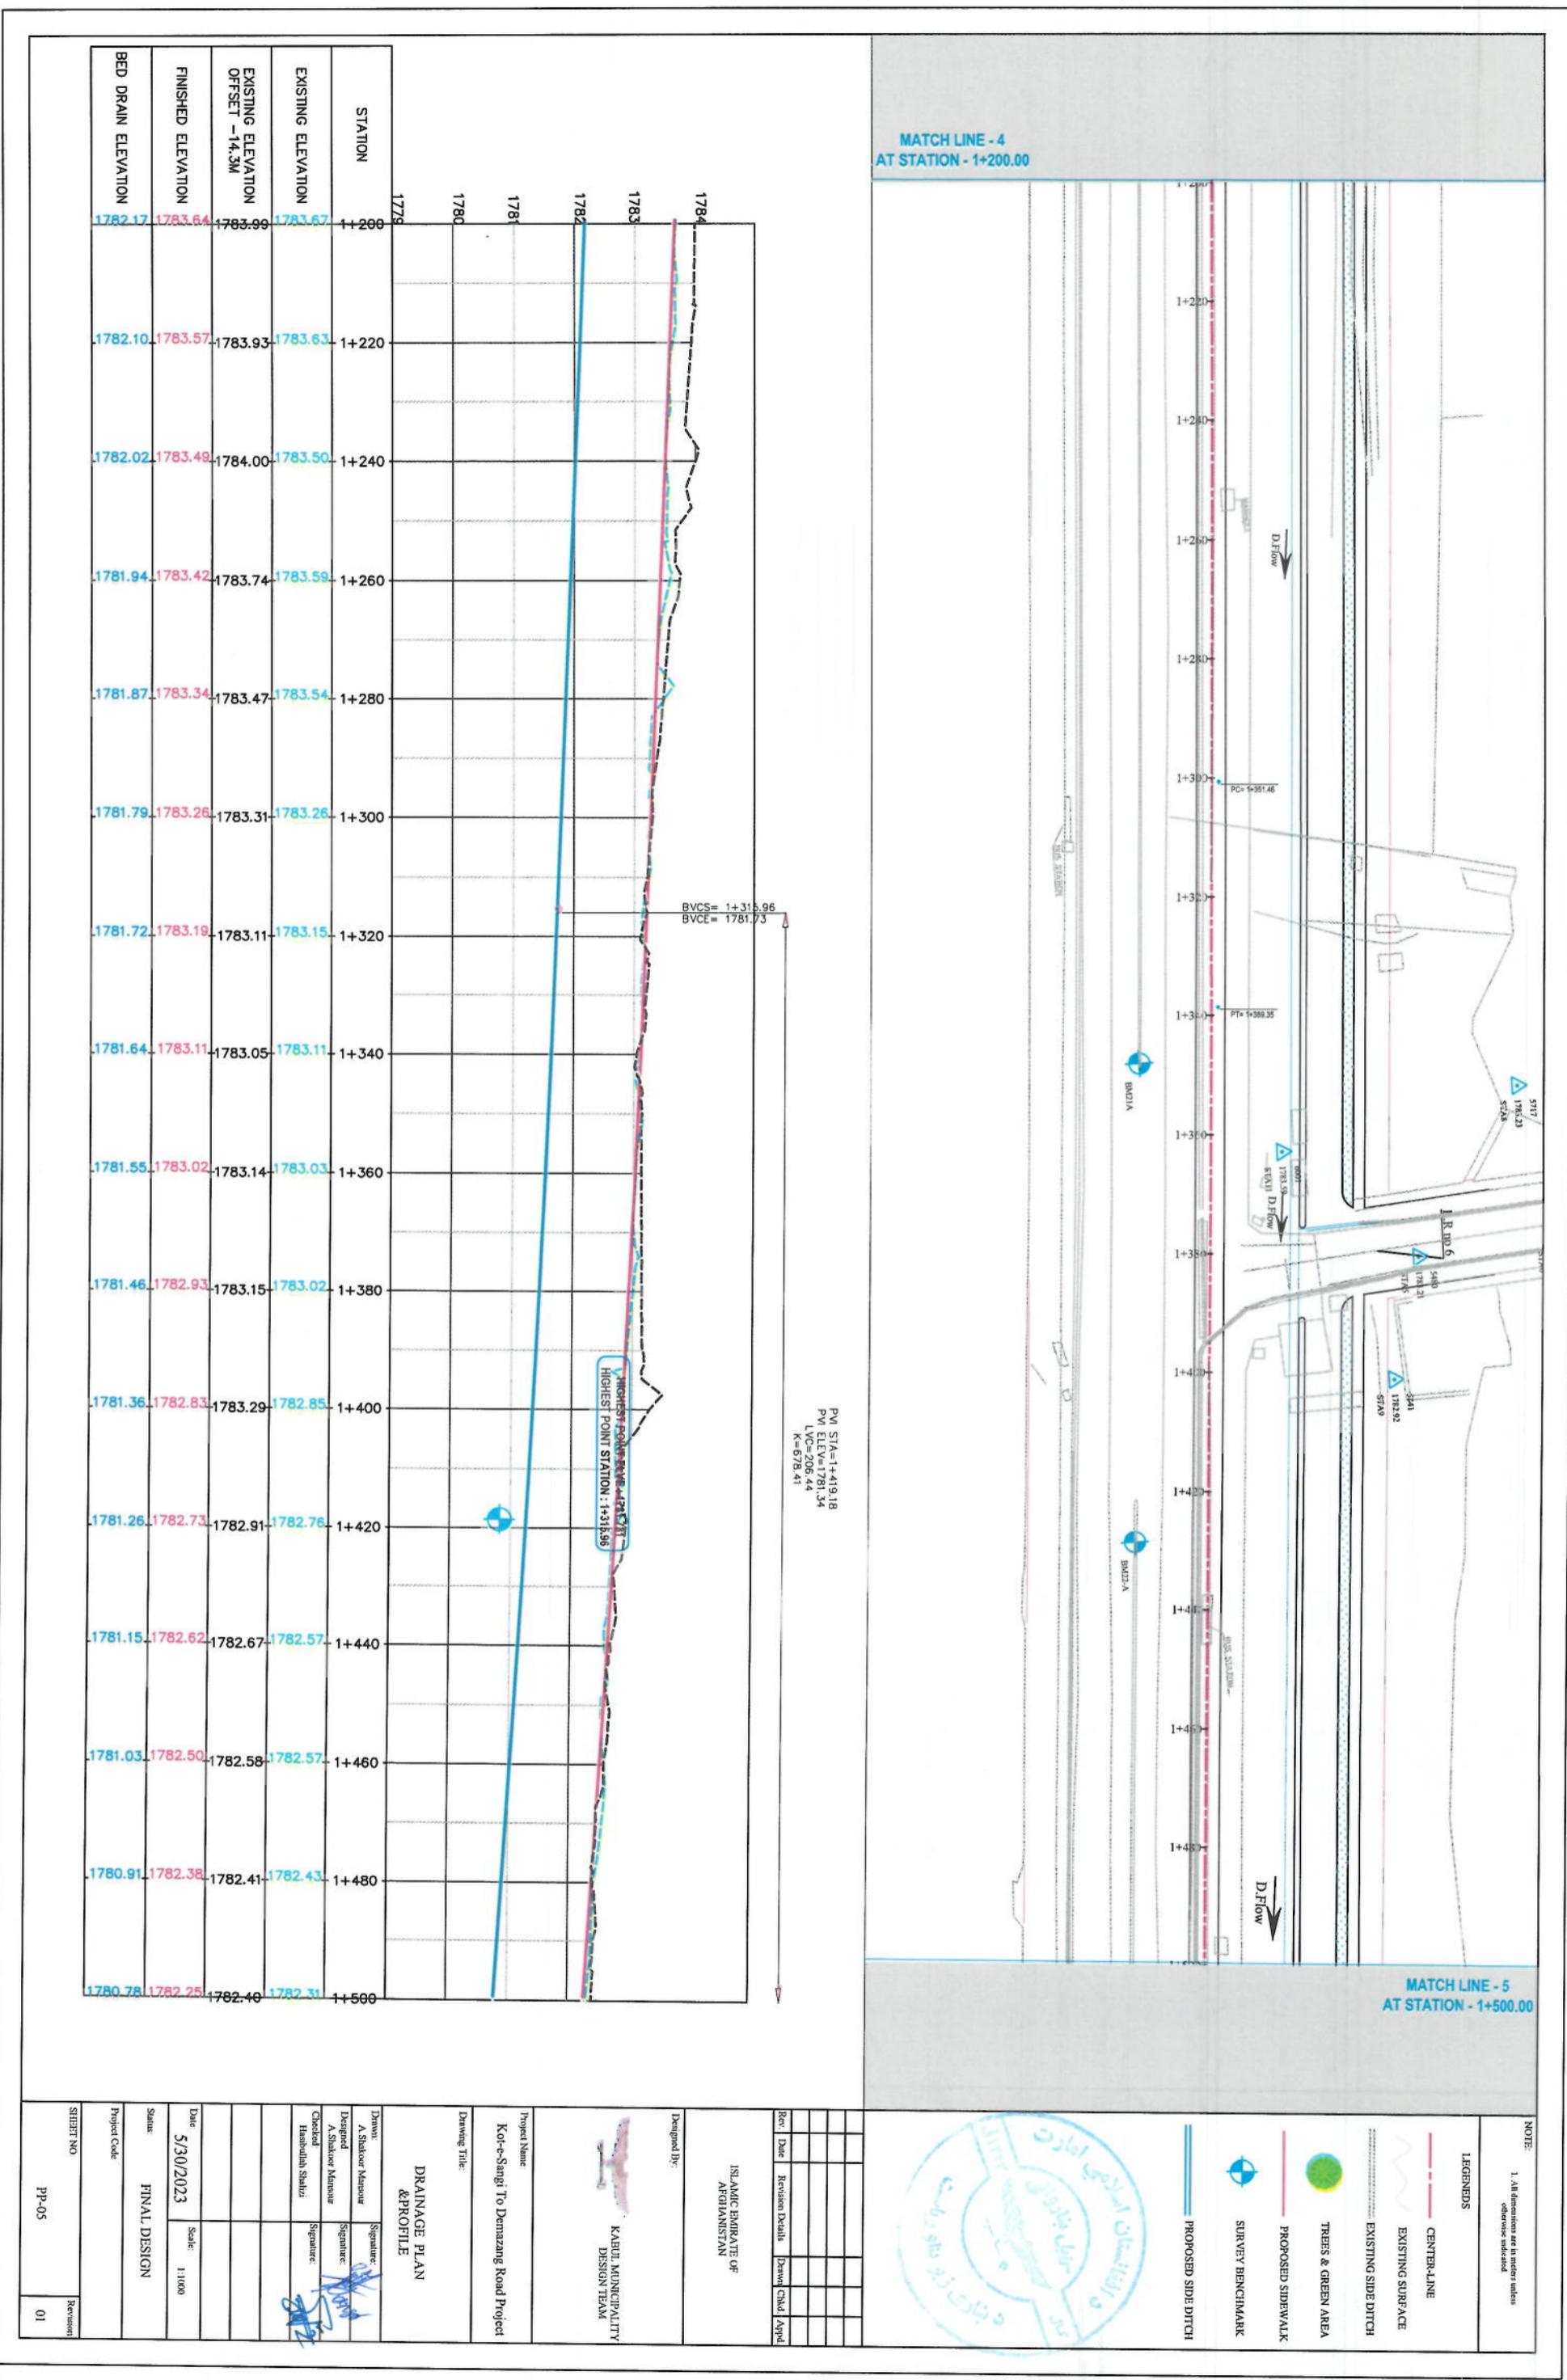

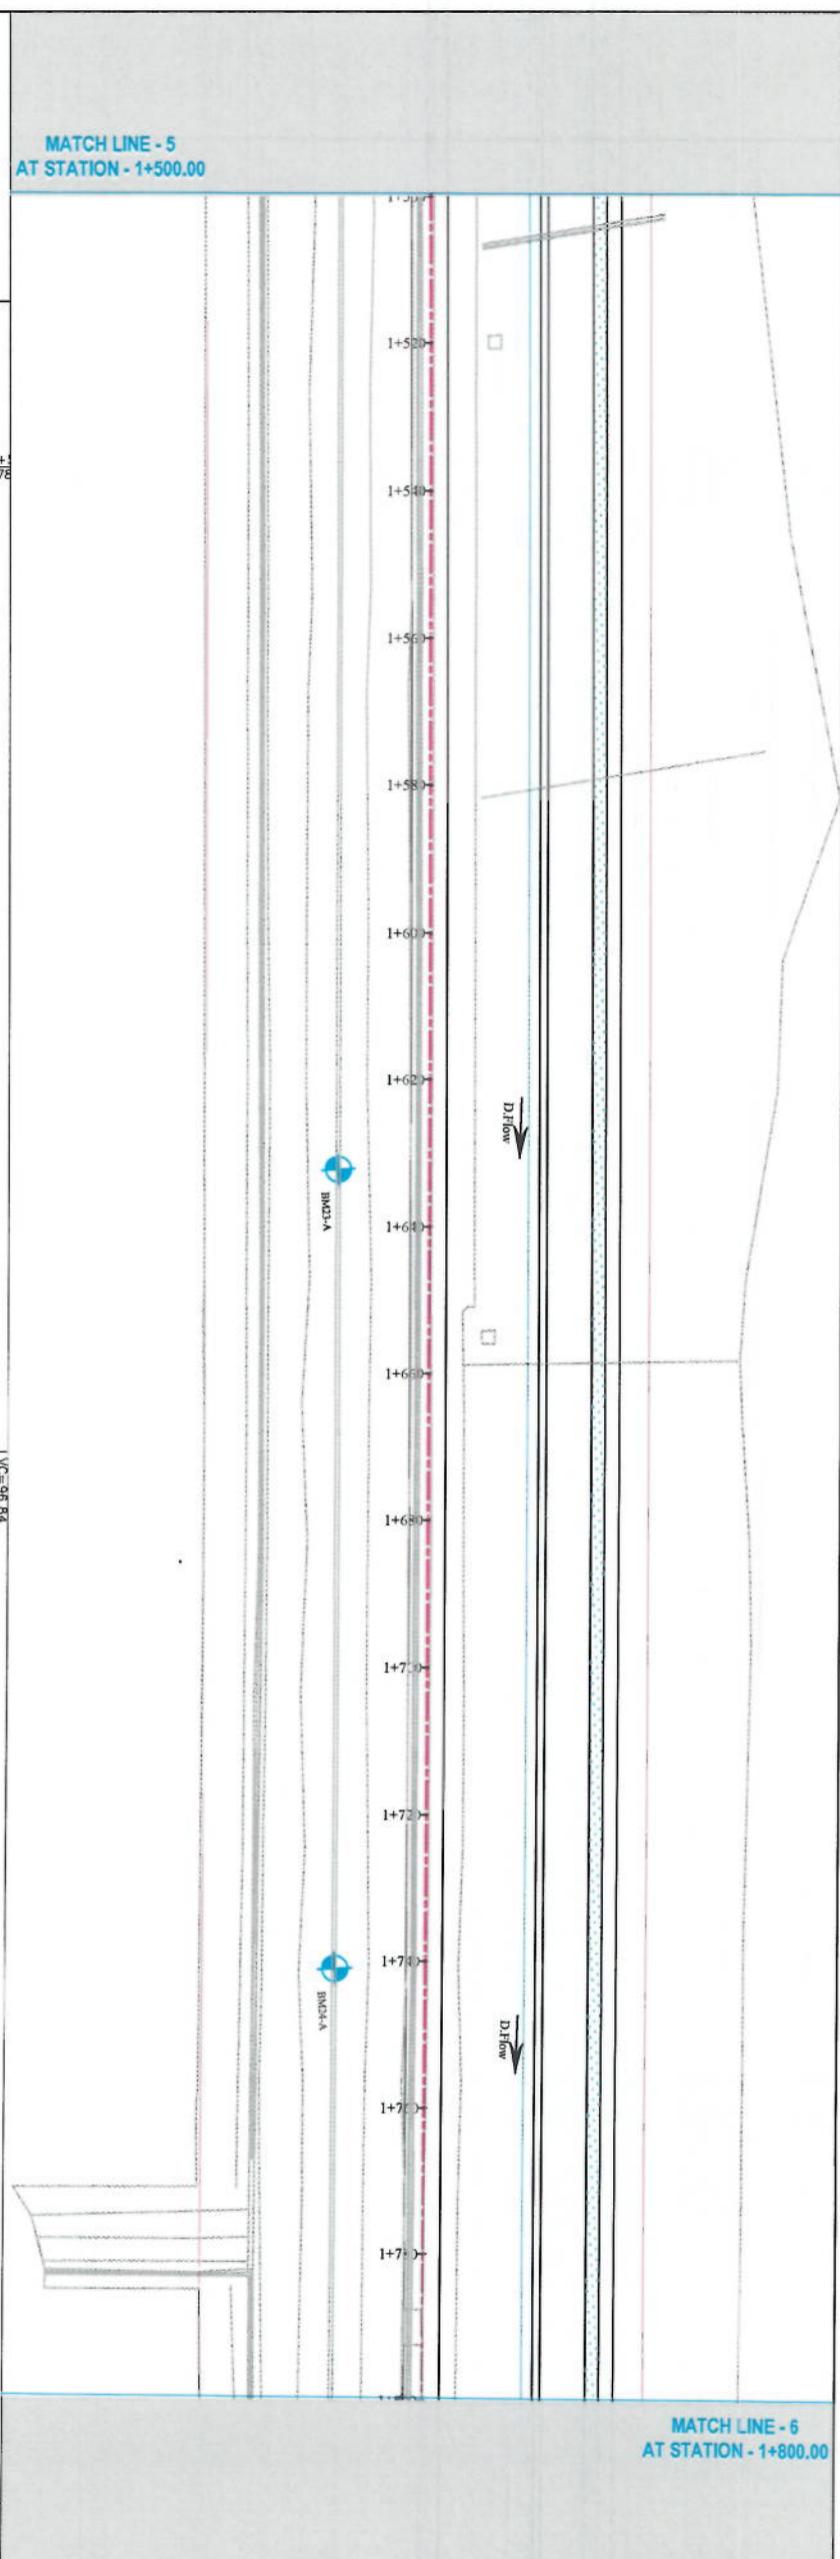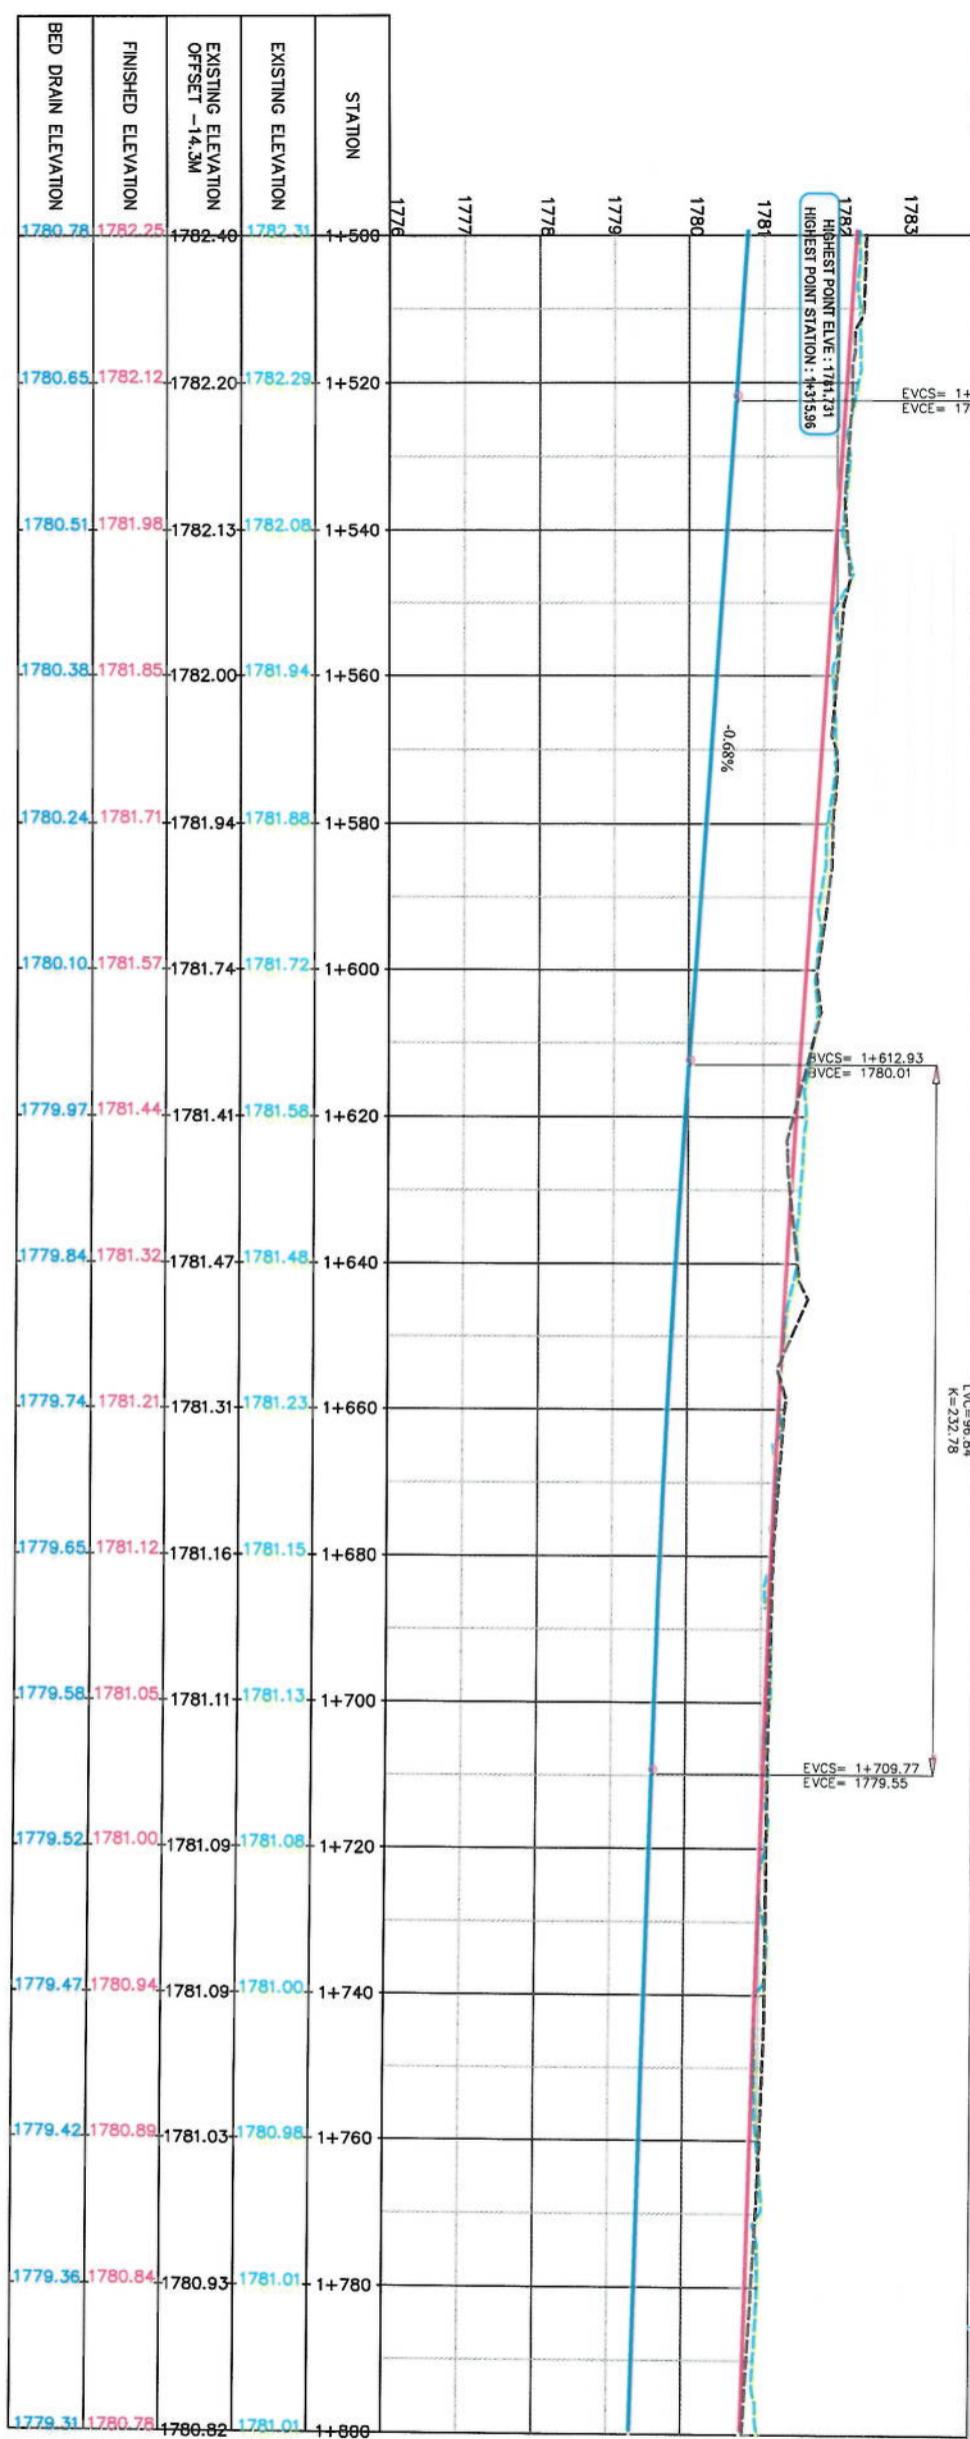

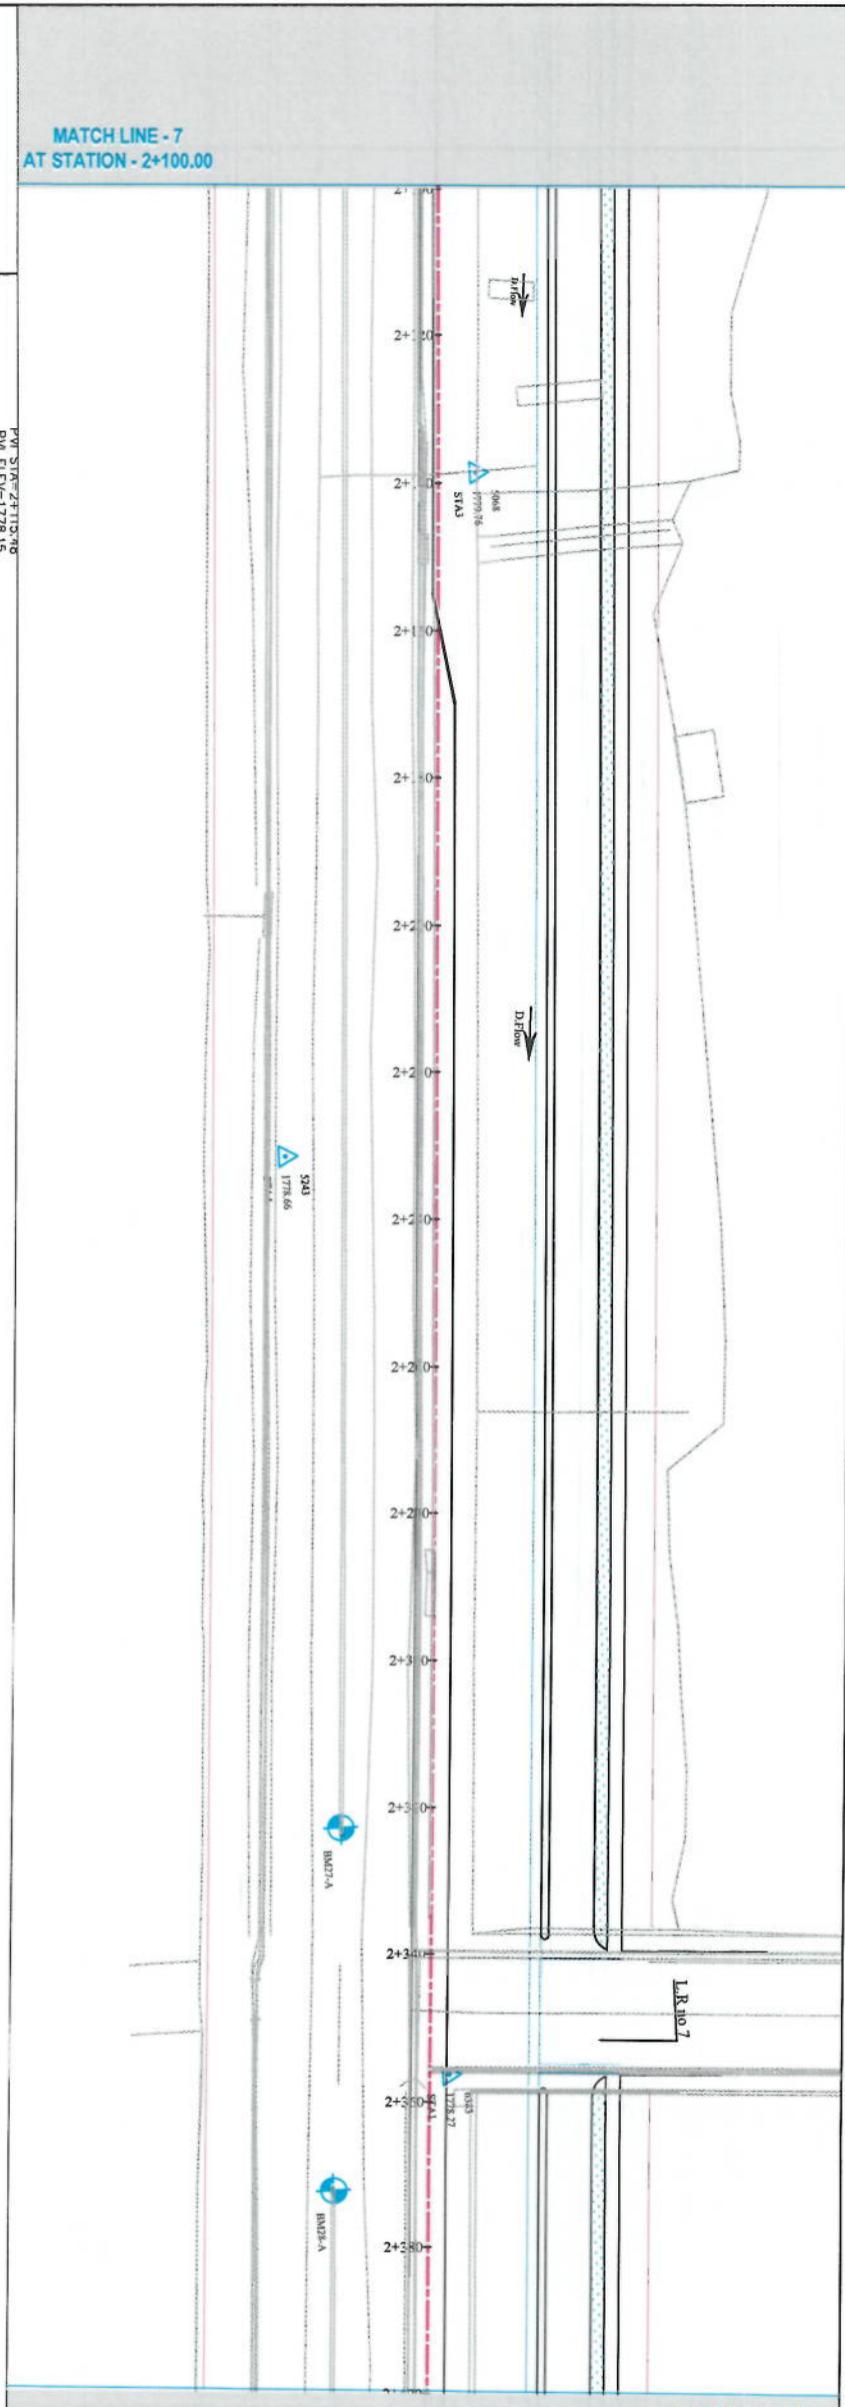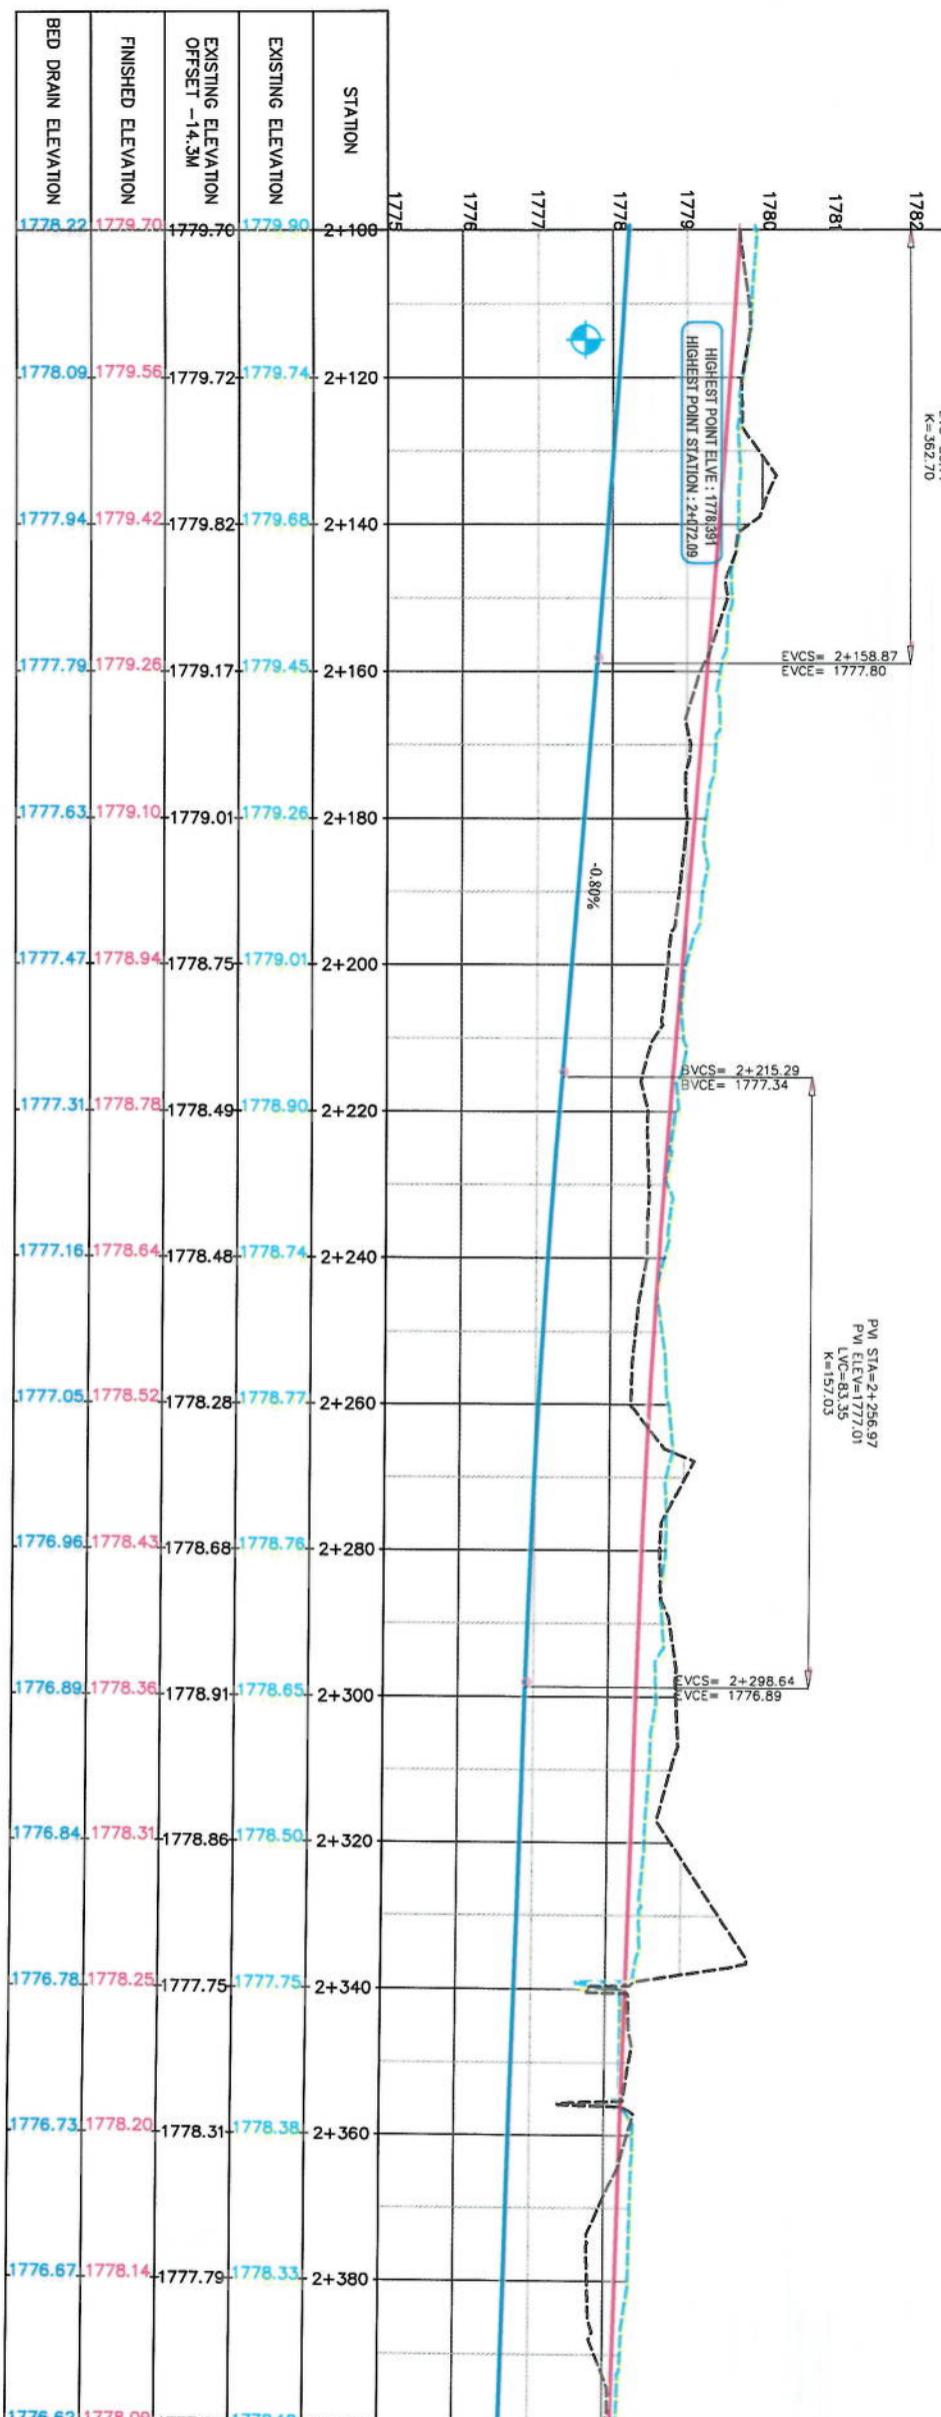


NOTE:
1. All dimensions are in meters unless otherwise indicated.

LEGENDS					
SURVEY BENCHMARK	PROPOSED SIDE DITCH	EXISTING SURFACE	EXISTING SIDE DITCH	PROPOSED SIDEWALK	TREES & GREEN AREA
BM27-A	BM28-A	BM29-A	BM30-A	BM31-A	BM32-A
BM27-A	BM28-A	BM29-A	BM30-A	BM31-A	BM32-A
BM27-A	BM28-A	BM29-A	BM30-A	BM31-A	BM32-A



Divan Khanah

Drawn By:	Checked By:	Approved By:
A. Shaboor Mansour		
Signature:		
Designed by: A. Shaboor Mansour		
Checked by: Hashimullah Shalizi		
Date: 5/30/2023	Scale: 1:1000	
Status: FINAL DESIGN		
Project Code:		
Sheet No: PP-08		
Revision: 01		

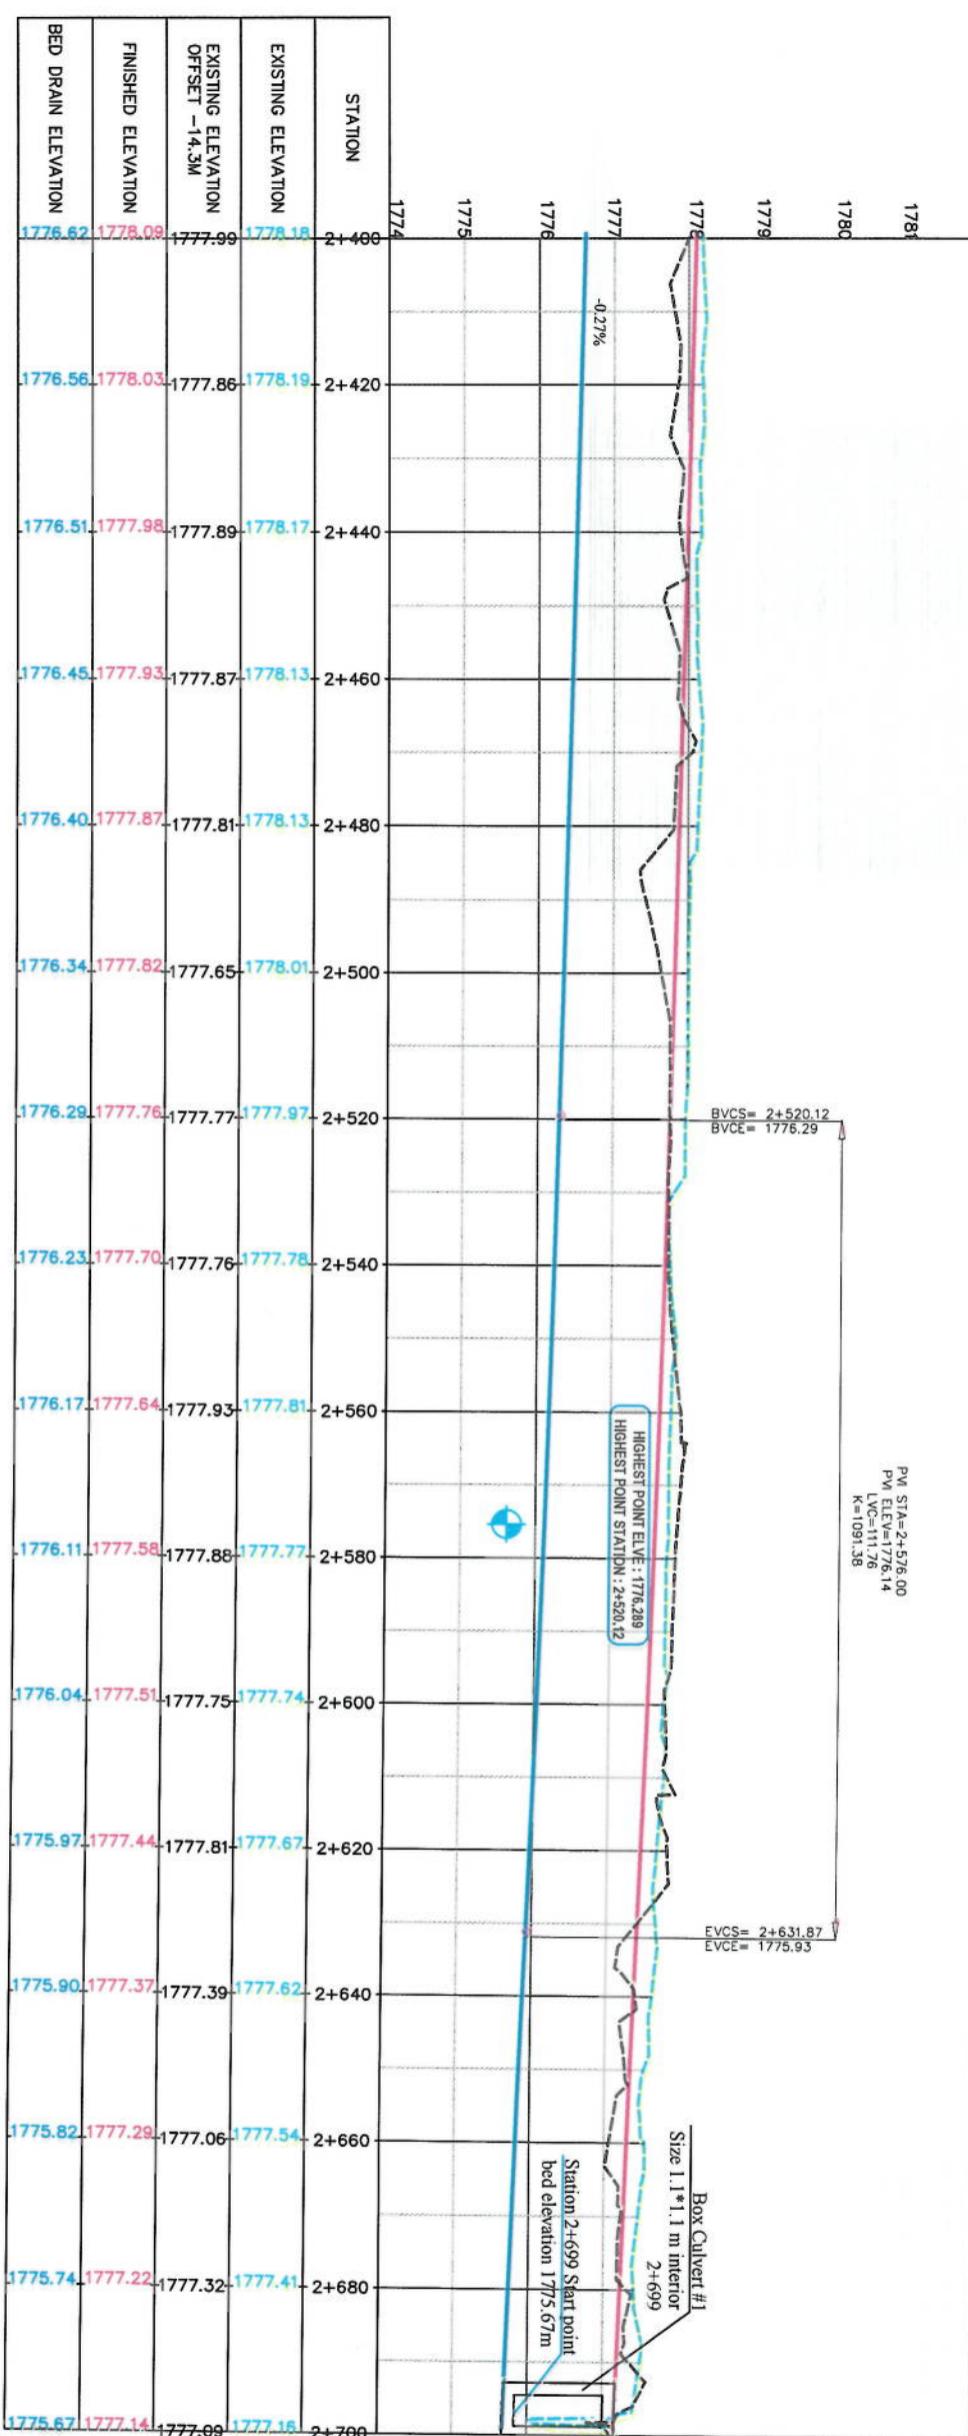

DIRECTORATE OF BARASHNA BUILDING


NOTE:

1. All dimensions are in meters unless otherwise indicated.

LEGENDS

- CENTER-LINE
- EXISTING SURFACE
- PROPOSED SIDE DITCH
- SURVEY BENCHMARK
- PROPOSED SIDEWALK
- TREES & GREEN AREA

MATCH LINE - 9
AT STATION - 2+700.00

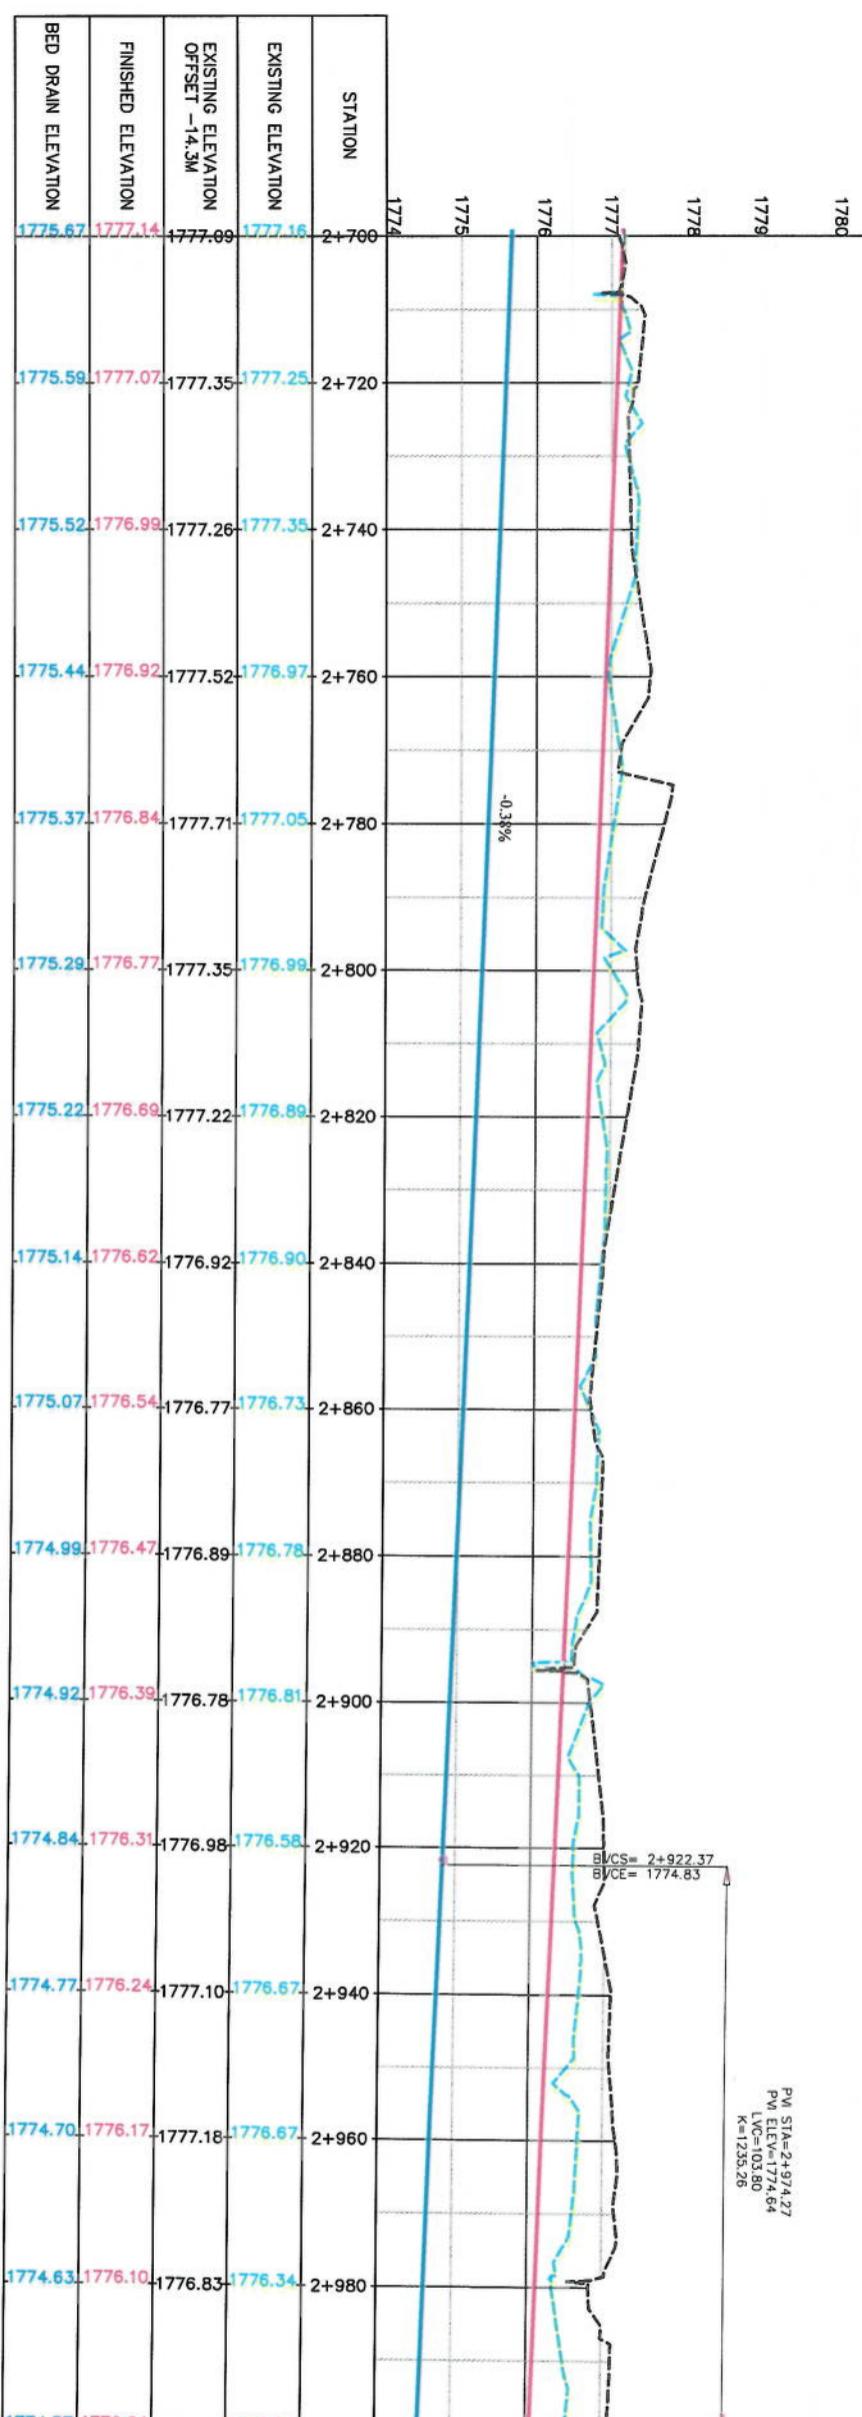

DIRECTORATE OF TRAFFIC

NOTE:
1. All dimensions are in meters unless otherwise indicated.

LEGENDS

- CENTER-LINE
- EXISTING SURFACE
- PROPOSED SIDEWALK
- SURVEY BENCHMARK

MATCH LINE - 10
AT STATION - 3+000.00

Station 3+201.5 Start point of culvert#2 shall be connected appropriately to proposed ditch bed elevation 1774m

N=3818736.3647
E=514038.7868

N=3818736.8617
E=514040.5173

905
895
885
875
865
855
845
835
825
815
805
795
785
775
765
755
745
735
725
715
705
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175
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125
115
105
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85
75
65
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45
35
25
15
5
0



POST OFFICE

POST OFFICE

Rev. Date	Revision Details	Drafter	Checkd	Apvd

KABUL MUNICIPALITY DESIGN TEAM

Project Name:
Koh-e-Sangi To Demazang Road Project

Drawing Title:

DRAINAGE PLAN & PROFILE

Drawn: A. Shaboor Mansour
Signature:


Designed: A. Shaboor Mansour
Signature:

Checked: Hasibullah Shahizi
Signature:

Date: 5/30/2023 Scale: 1:1000

Status: FINAL DESIGN

Project Code:

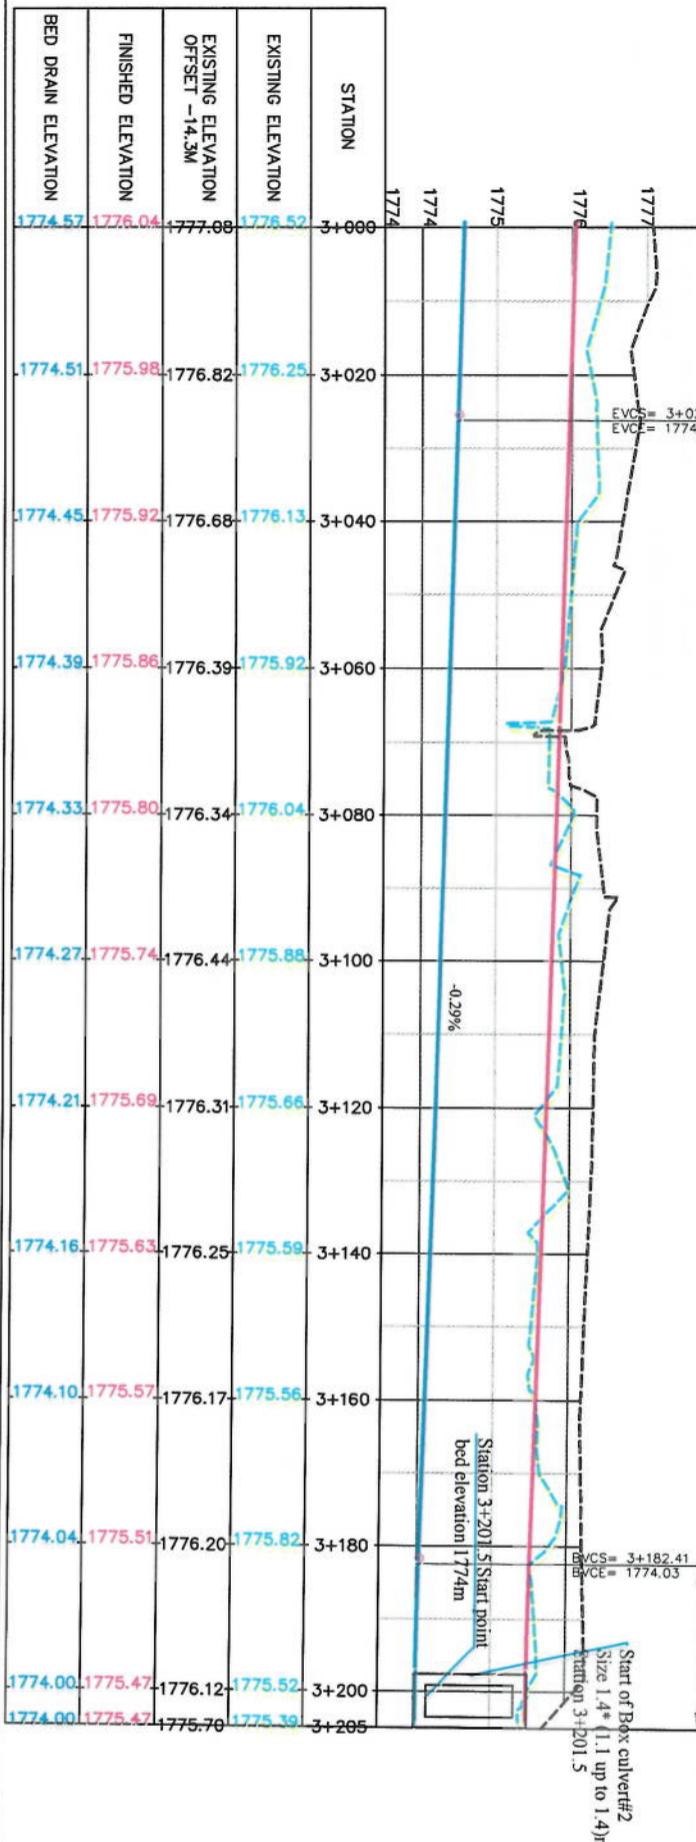




SHEET NO. PP-11 Revision 01

NOTE:

1. All dimensions are in meters unless otherwise indicated

LEGENDS

 CENTER-LINE
 EXISTING SURFACE
 EXISTING SIDE DITCH

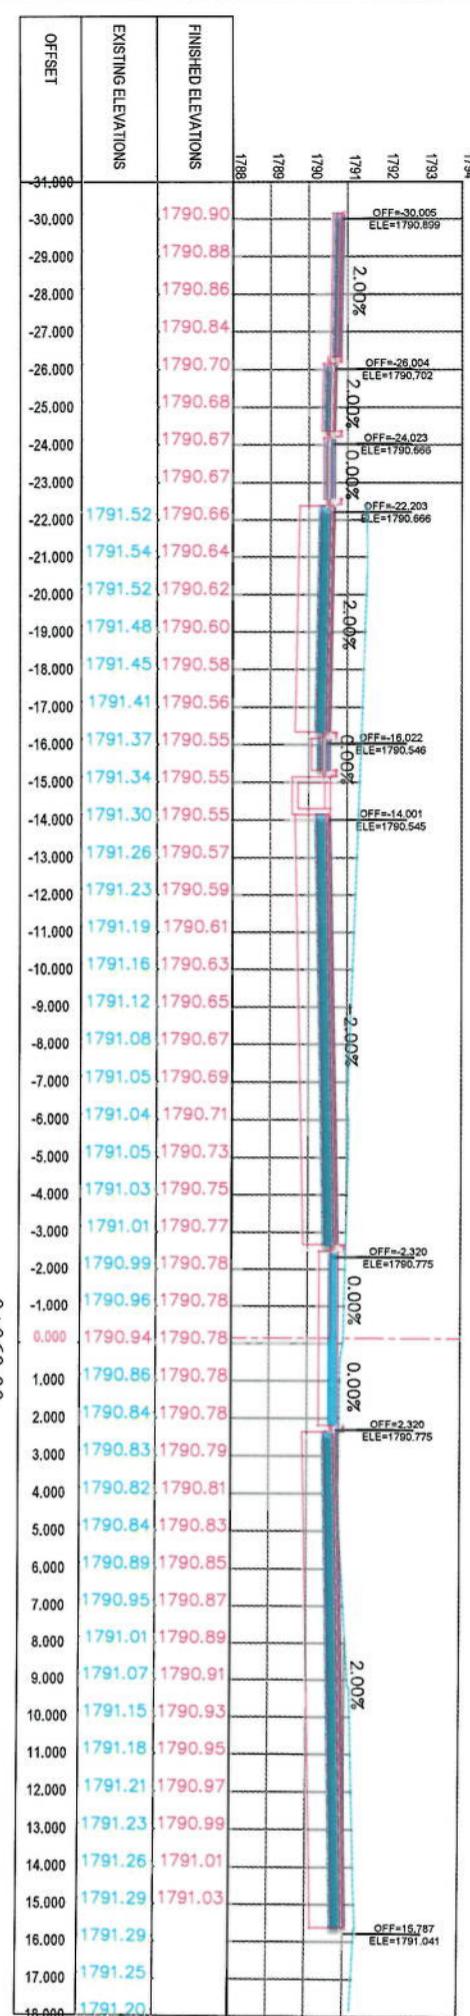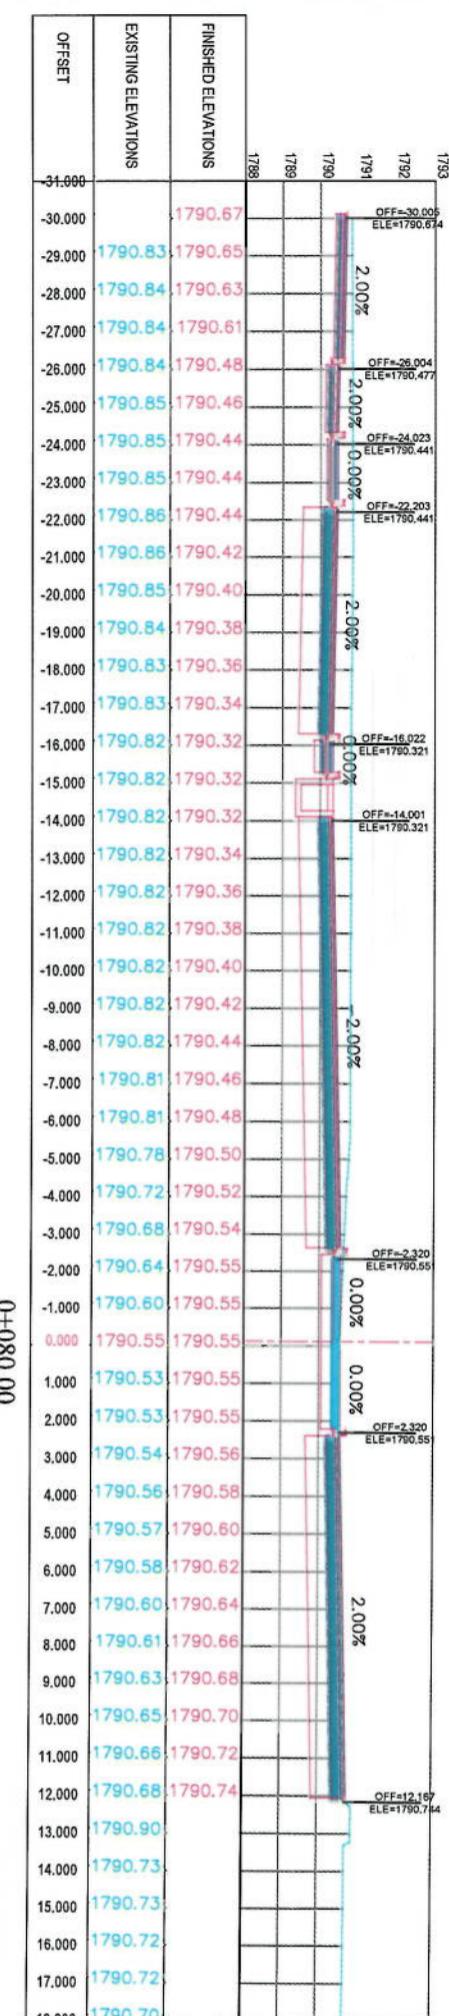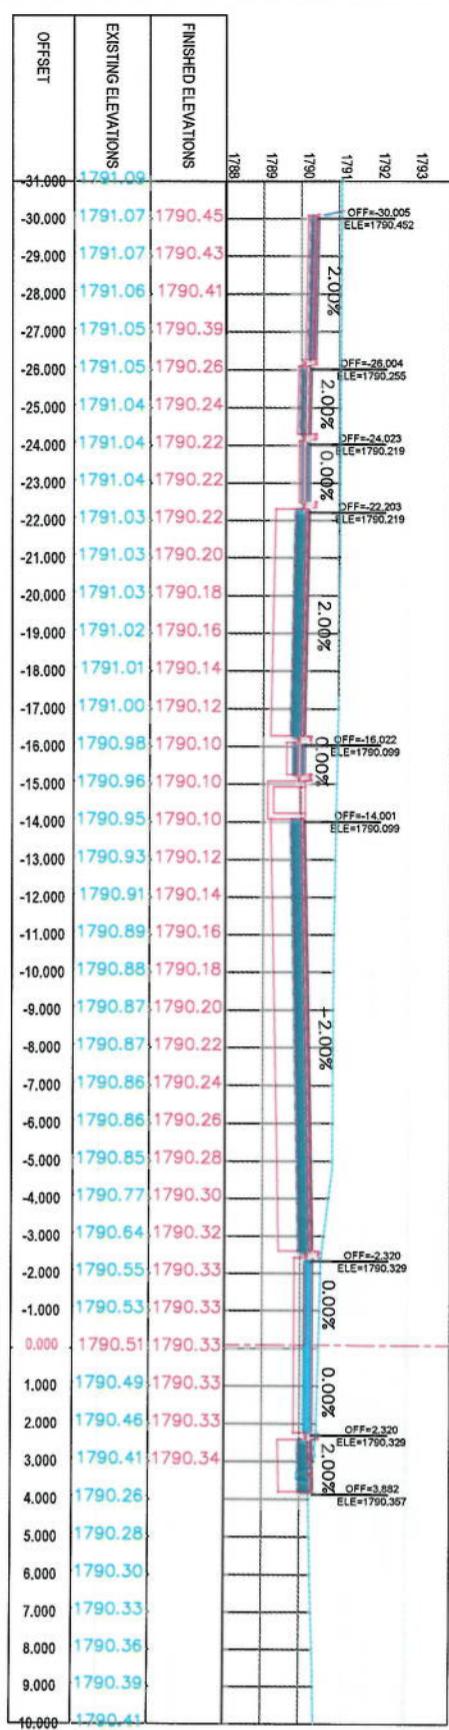


CROSS SECTIONS

Designed by: Signature:
Mohammad Easa Sint
Drawn by: Signature:
Mohammad Easa Sint
Checked by: Signature:
Hamidullah Salizi

Project Name: Core-Samp To Demazang
Road Project
Client: KABUL MUNICIPALITY
DESIGN TEAM


Drawing Title:

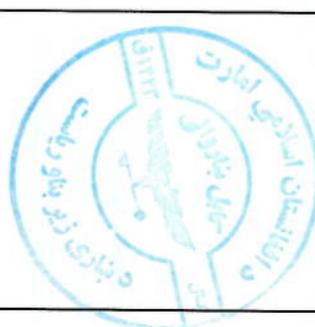


Drawing Number:	CS-2

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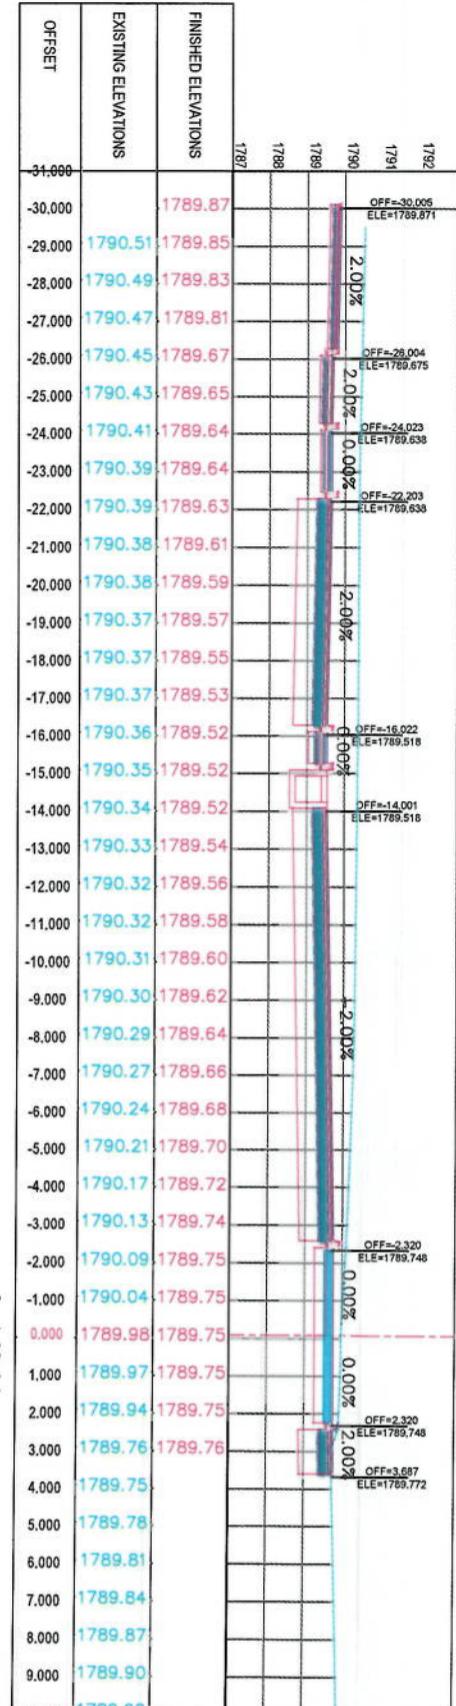
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0+140.00

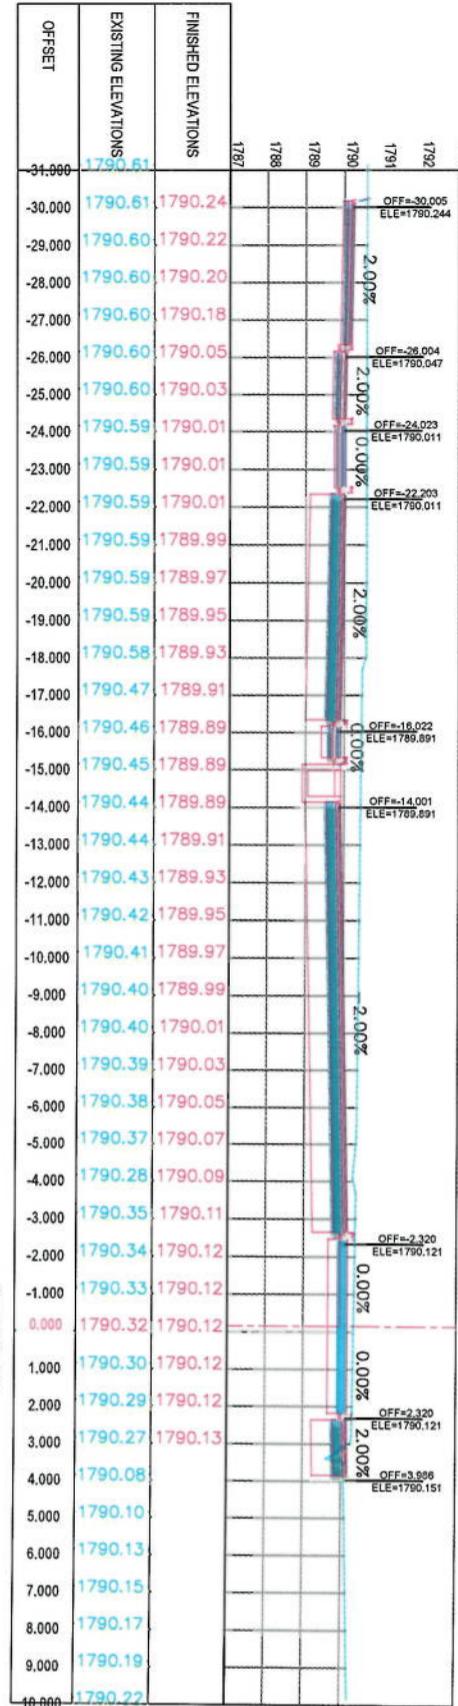


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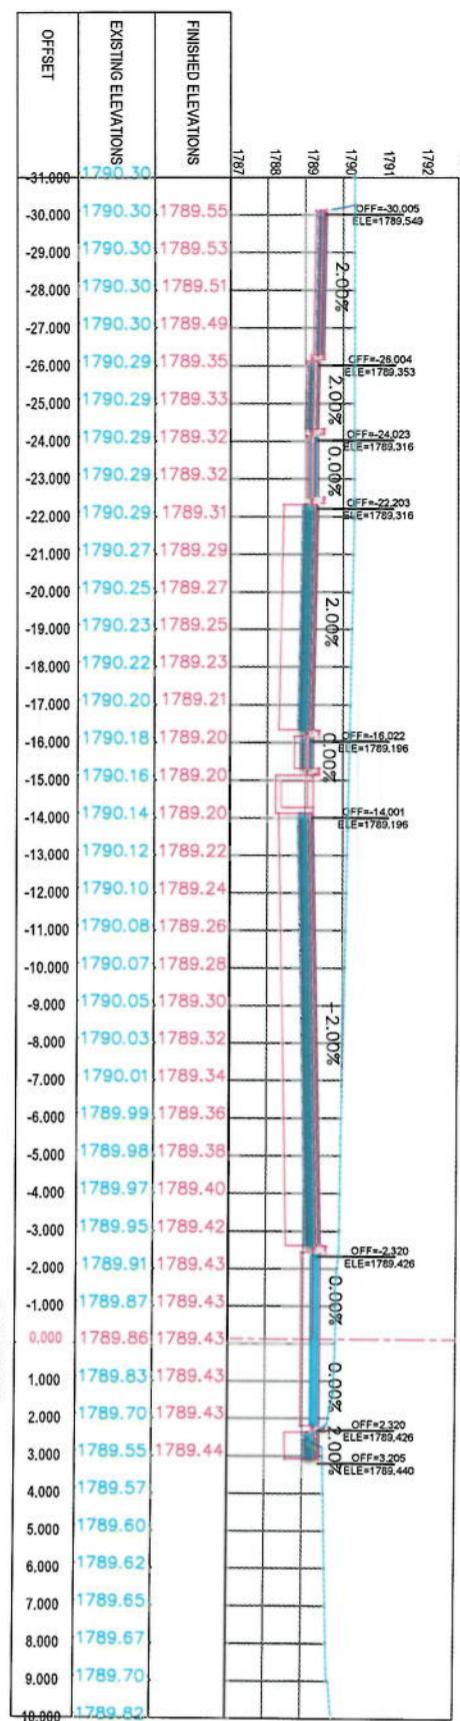
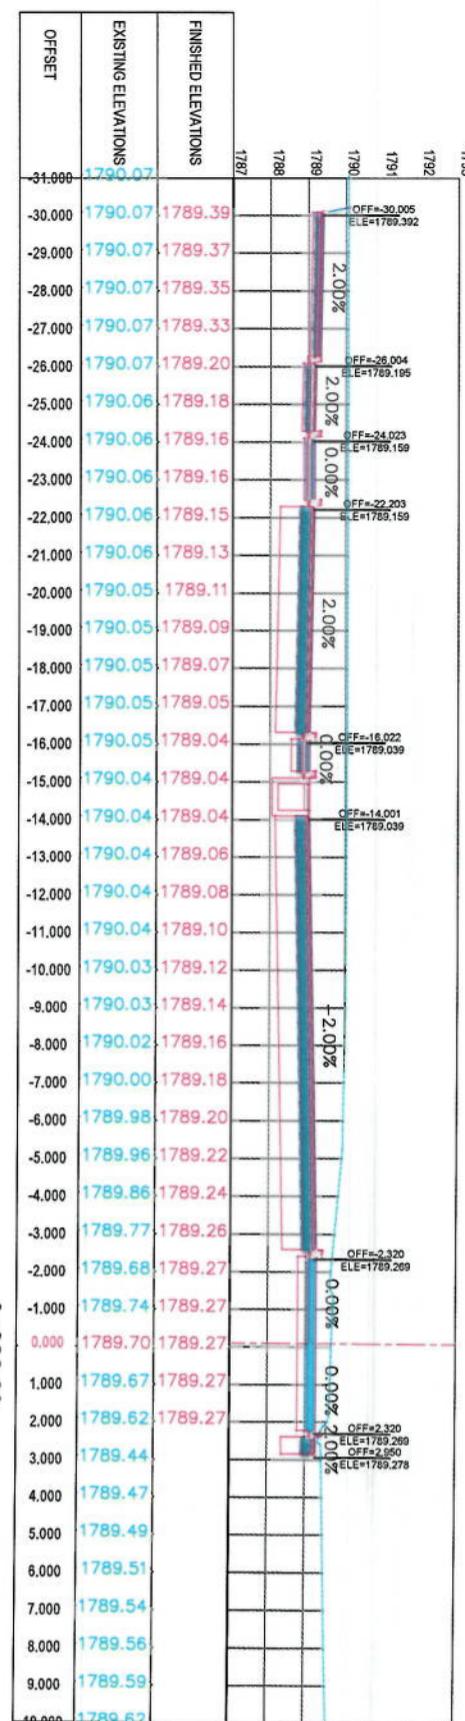
NOTE:

- All dimensions are in metres unless otherwise indicated.

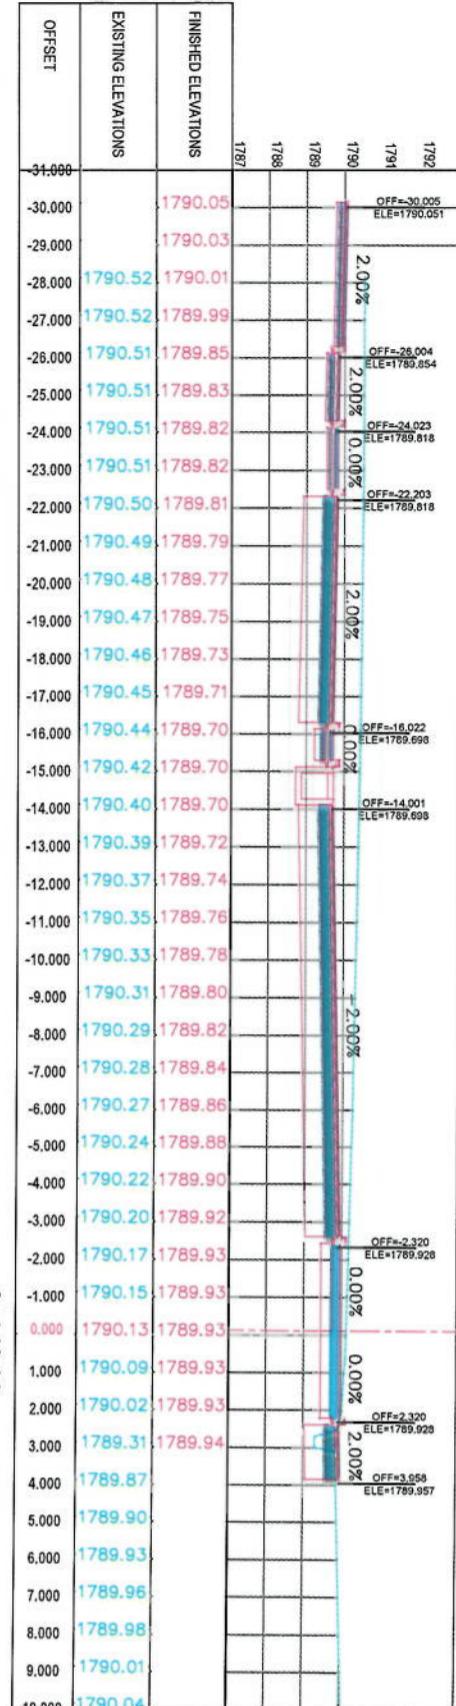LEGENDS	
—	CENTER-LINE
---	EXISTING SURFACE
—	EXISTING SIDE DITCH




Project Name:	KABUL MUNICIPALITY DESIGN TEAM
Design Title:	Cone-Single To Demazang Road Project
Checked by:	Hannanullah Shamsi
Date:	6/7/2023
Scale:	1:200
Status:	FINAL DESIGN
Project Code:	CS-3
Revision:	00

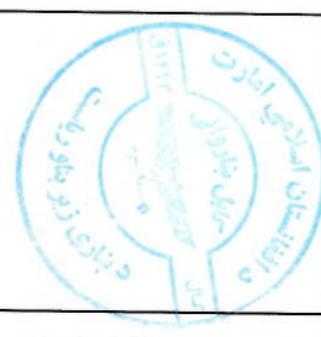

0+180.00

0+200.00

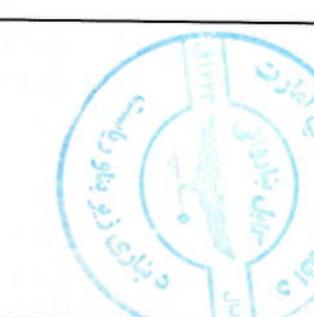


NOTE

1. All dimensions are in meters unless otherwise indicated.

LEGENDS

- CENTER-LINE
- EXISTING SURFACE
- EXISTING SIDE DITCH

Project Name:	KABUL MUNICIPALITY DESIGN TEAM
Client:	KABUL MUNICIPALITY
Designated by:	
Code-Signed To Demanding:	
Drawing Title:	CROSS SECTIONS
Designed by:	Mohammad Eesa Sial
Drawn by:	Mohammad Eesa Sial
Checked by:	Hassanullah Sialzi
Date:	6/7/2023
Scale:	1:200
Status:	FINAL DESIGN
Project Code:	CS-4
Drawing Number:	00
Revision:	

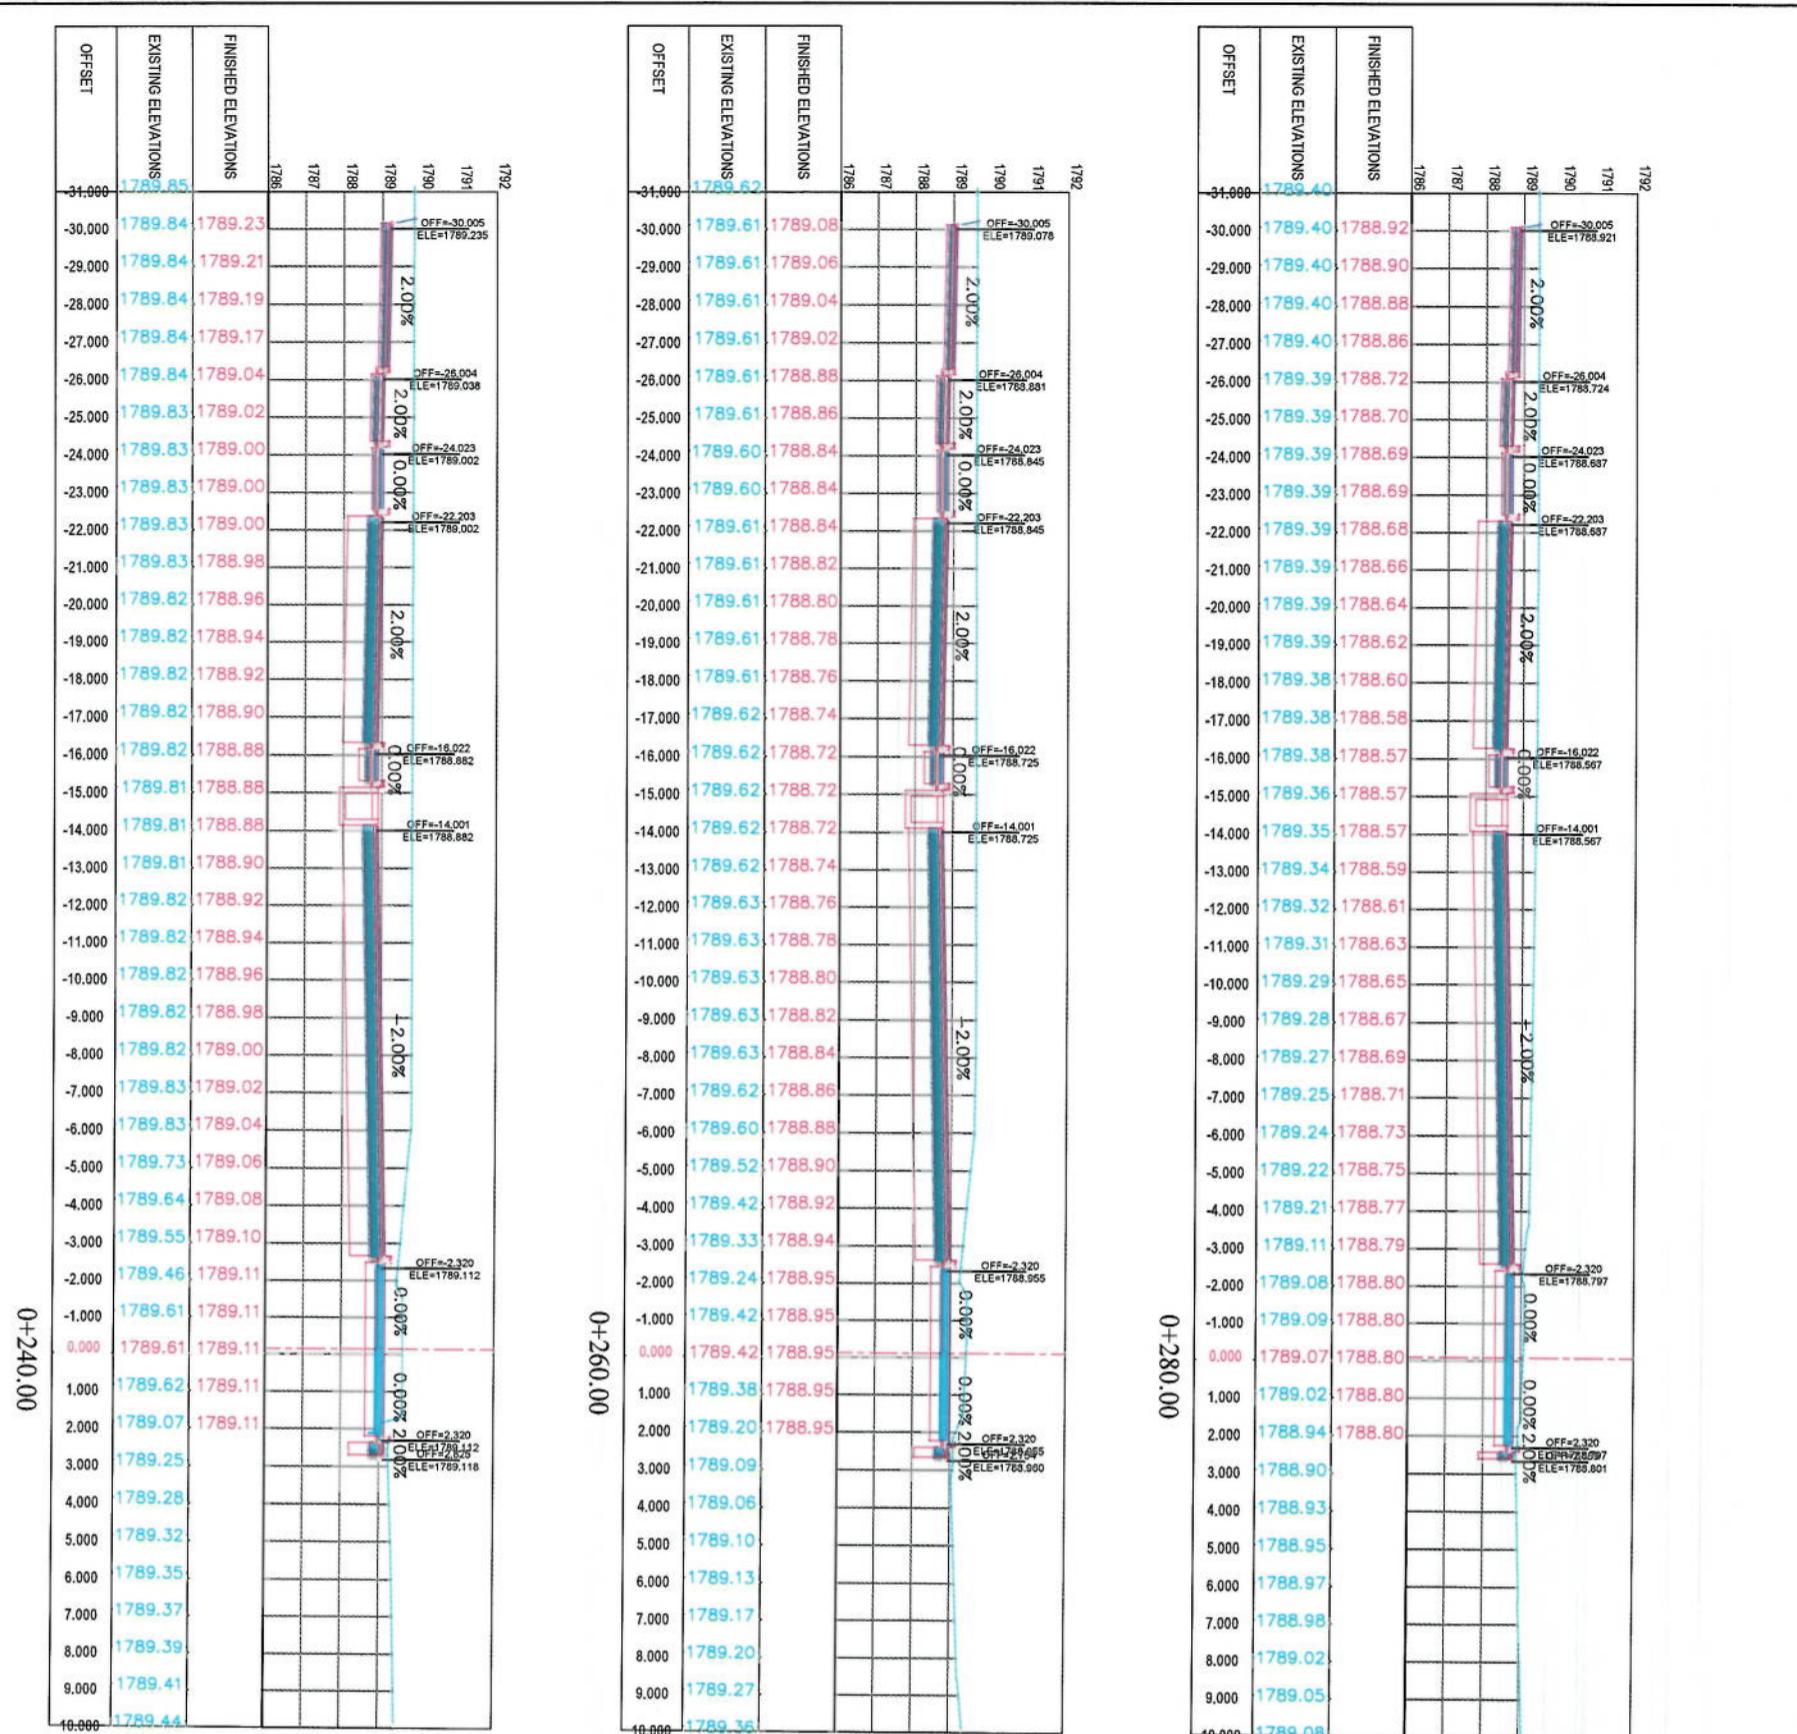


NOTE:


1. All dimensions are in meters unless otherwise indicated.



Designed by:	KABUL MUNICIPALITY DESIGN TEAM
Project Name:	Islamia-Sangi To Demazang Road Project
Drawing Title:	CROSS SECTIONS
Drawn by:	Colo-Sangi To Demazang
Checked by:	Habibullah Shabani
Date:	6/7/2023
Scale:	1:200
Status:	FINAL DESIGN
Project Code:	CS-5
Revision:	00

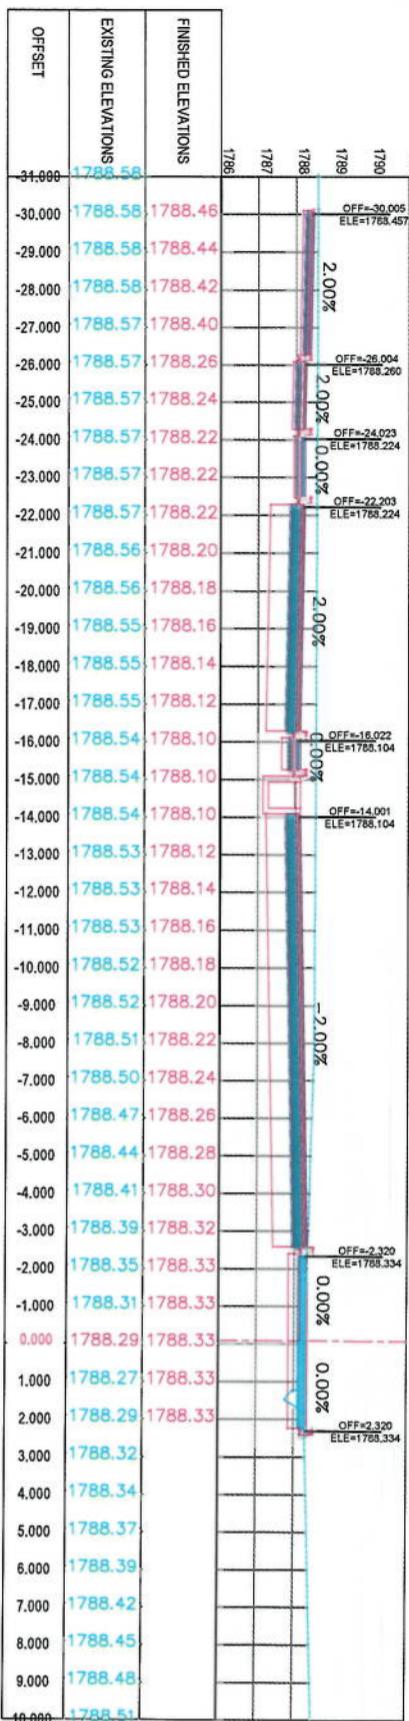


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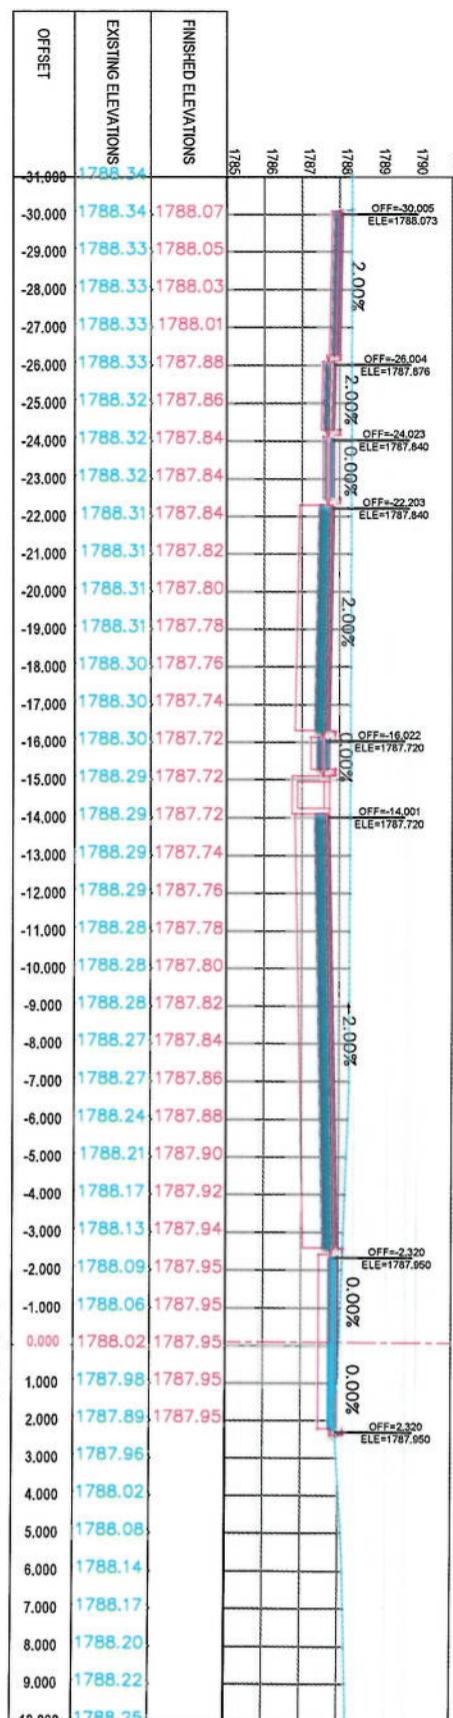


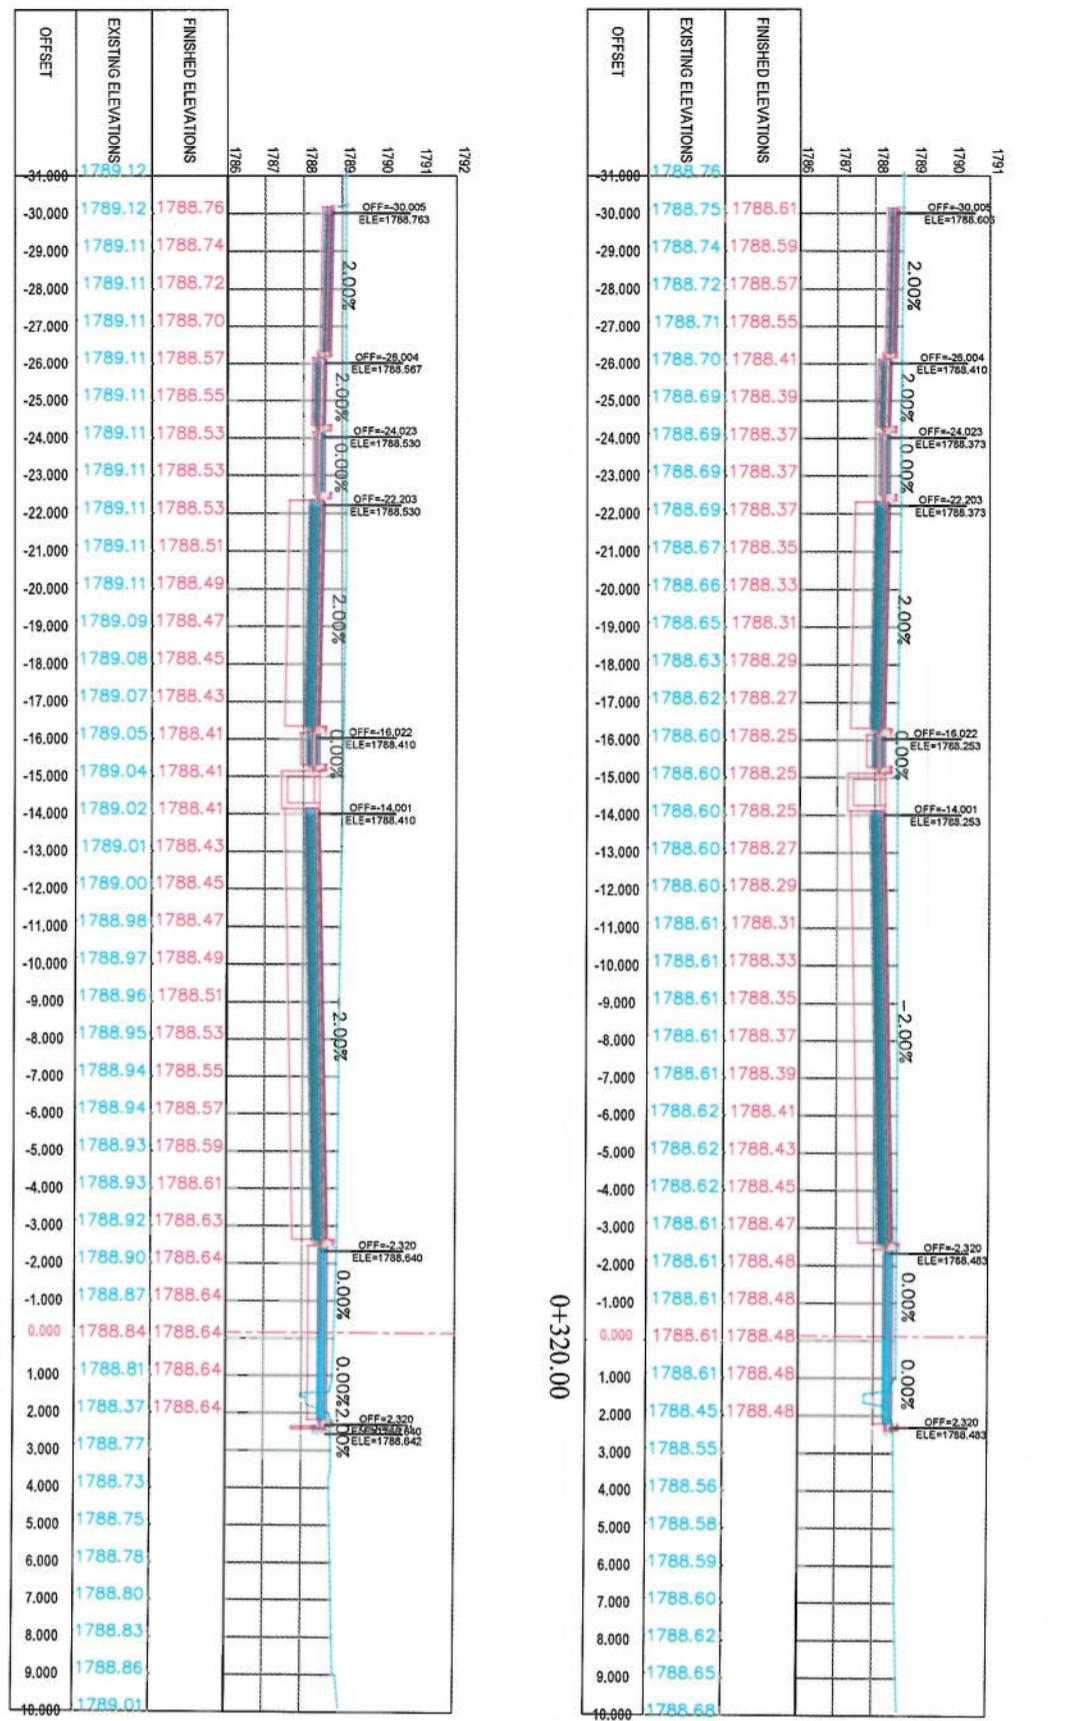0+320.00


0+300.00

NOTES	
1. All dimensions are in meters unless otherwise indicated.	
LEGENDES	
— CENTER-LINE	
— EXISTING SURFACE	
— EXISTING SIDE DITCH	
Project Name:	KABUL MUNICIPALITY DESIGN TEAM
Designed by:	KABUL MUNICIPALITY
Draughting Title:	Coor-Song To Demazang Road project
CROSS SECTIONS	
Drawn by:	Mohammad Esa Sint
Checked by:	Habibullah Shafiq
Date:	6/7/2023
Scale:	1:200
Project Code:	FINAL DESIGN
Drawing Number:	CS-6
Revision:	00




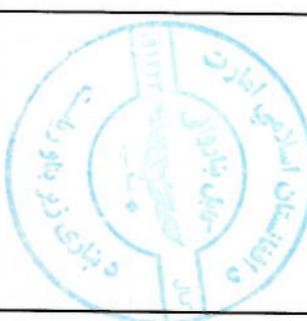


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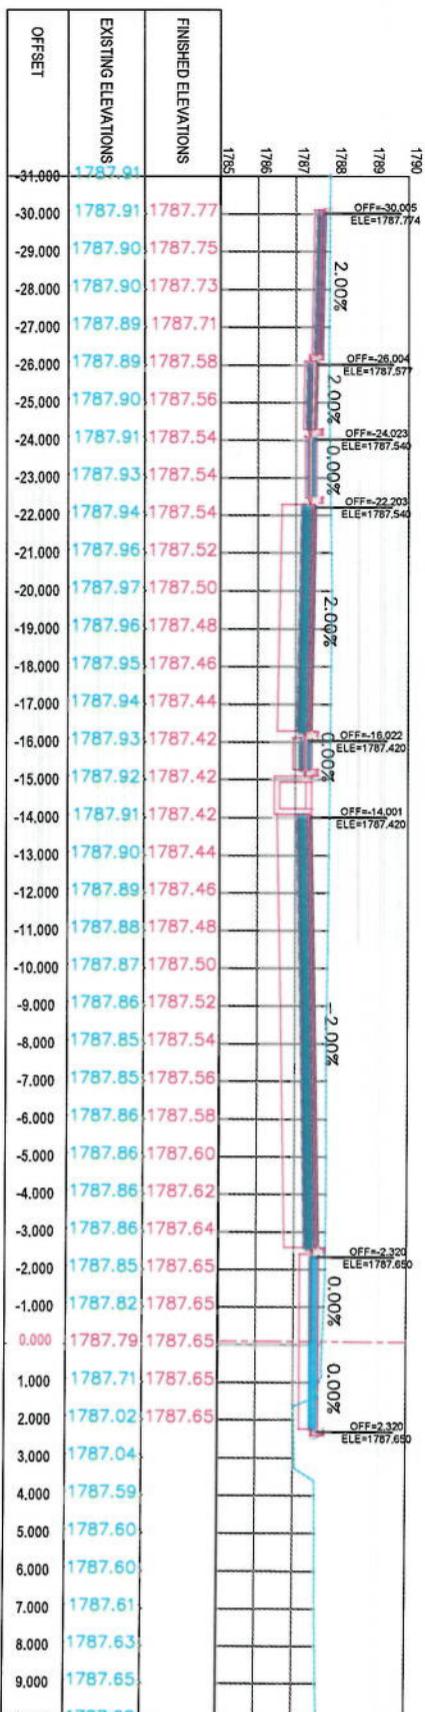
0+420.00

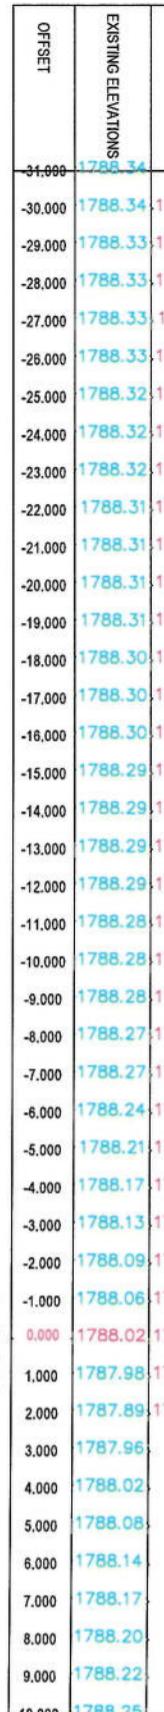

0+440.00

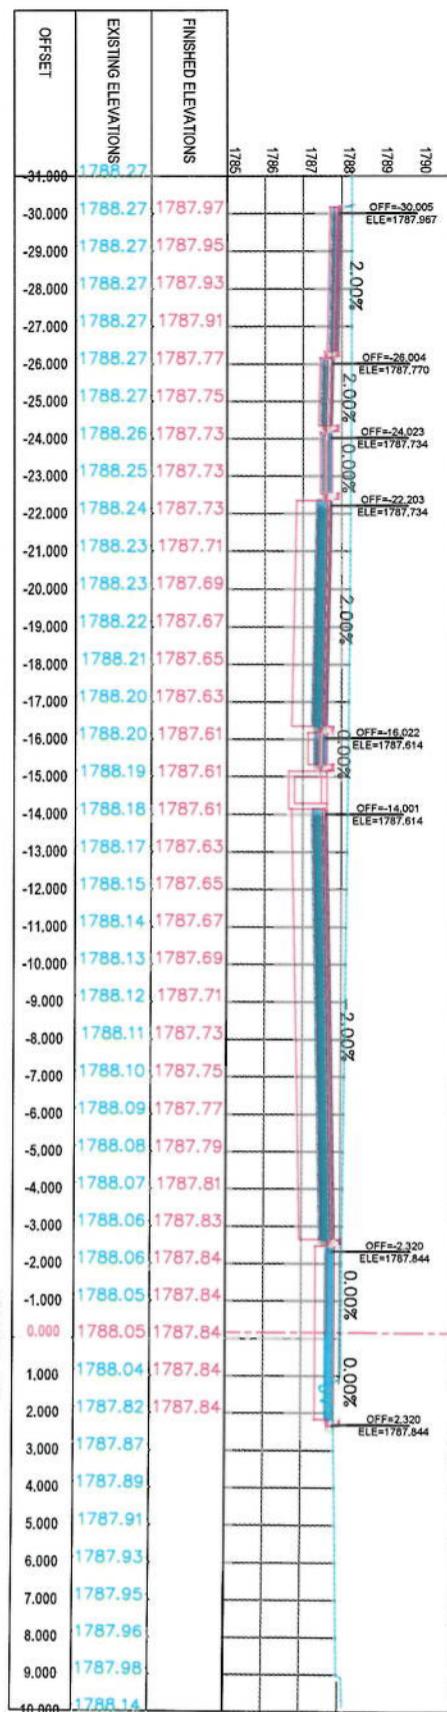

0+460.00

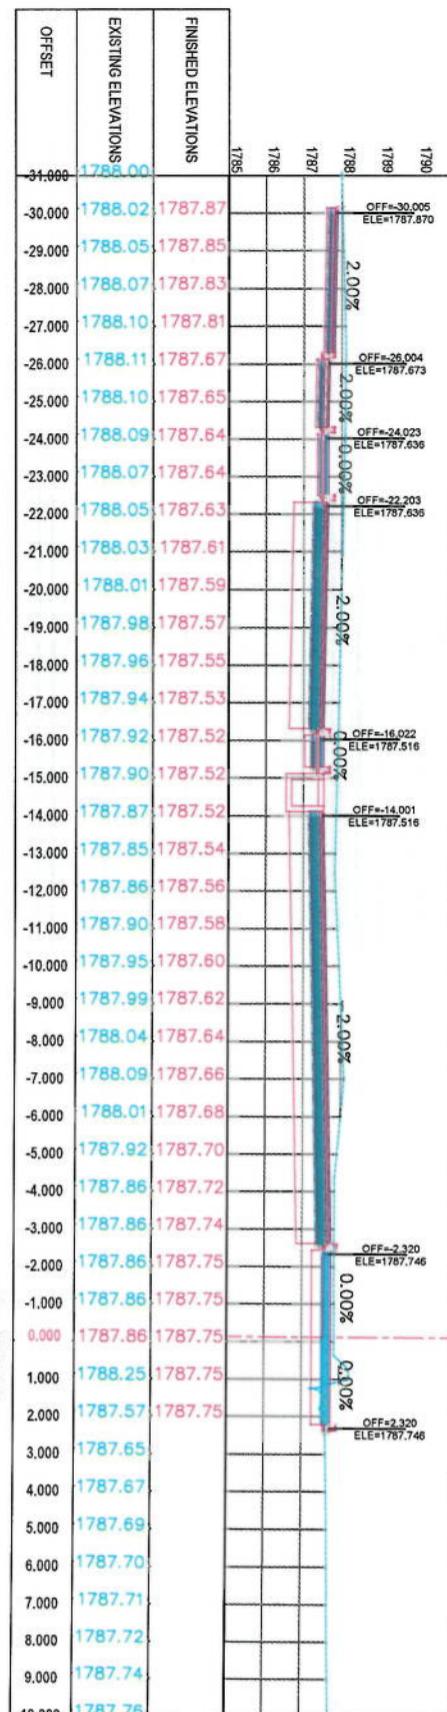NOTE:
1. All dimensions are in meters unless otherwise indicated.

LEGENDS
— CENTER-LINE
--- EXISTING SURFACE
— EXISTING SIDE DITCH




Project Name: Core-Sampling To Demazang
 Road Project
 Drawing Title:

CROSS SECTIONS


Designed by: Mohammad Eesa Sait
 Drawn by: Mohammad Eesa Sait
 Checked by: Hamidullah Shauzai

Date: 6/7/2023
 Scale: 1:200


Status: FINAL DESIGN
 Project Code: CS-8
 Revision: 00

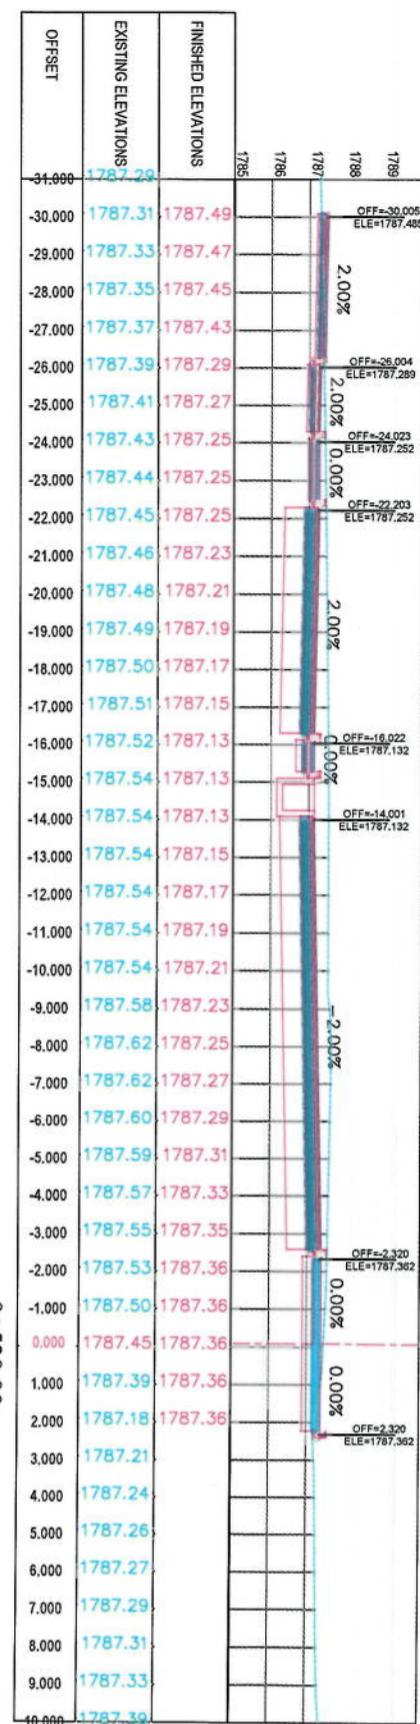

0+520.00

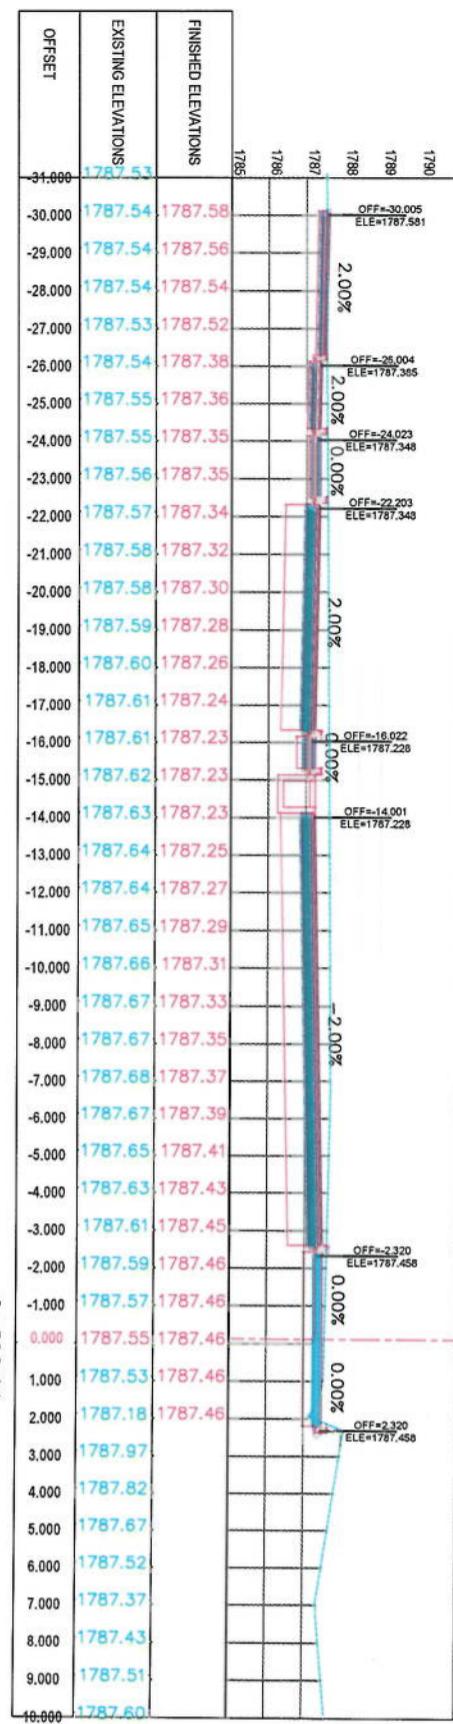

0+500.00

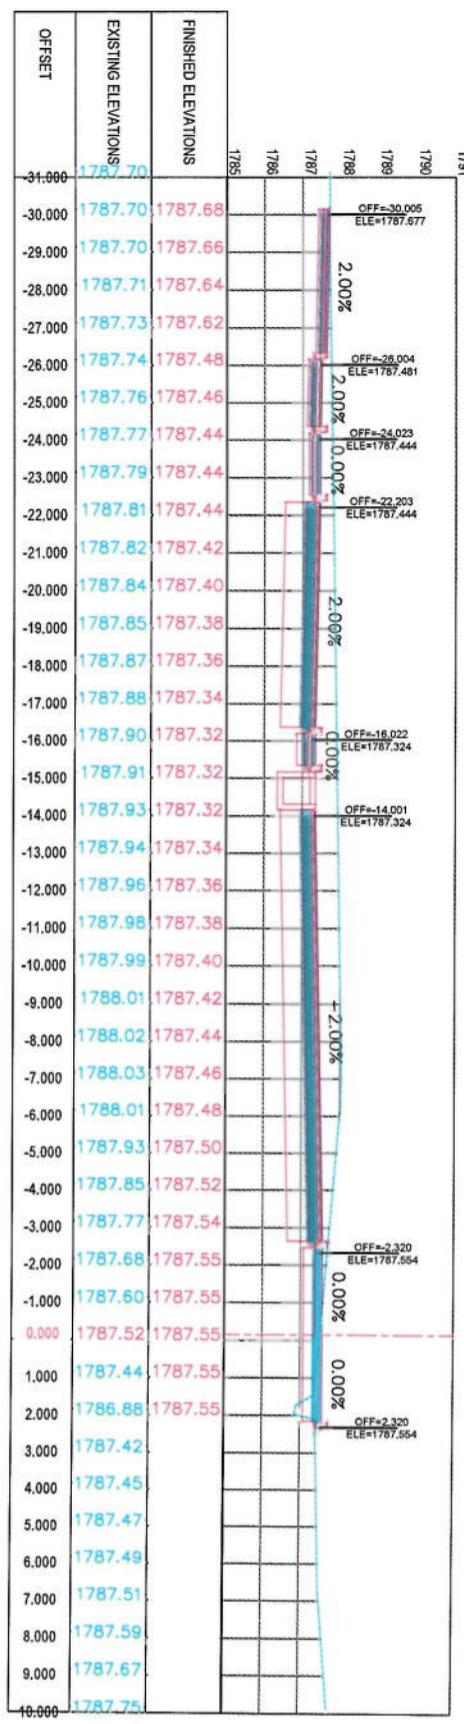


0+480.00


NOTE:
1. All dimensions are in meters unless otherwise indicated.

LEGENDS


- CENTER-LINE
- EXISTING SURFACE
- EXISTING SIDE DITCH

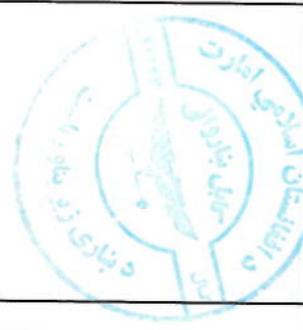

Project Name:	KABUL MUNICIPALITY DESIGN TEAM
Code-Sign To Demazang	Road Project
Designed by:	Mohammad Eesa Sial
Drawn by:	Mohammad Eesa Sial
Checked by:	Hassanullah Shabani
Date:	6/7/2023
Scale:	1:200
Status:	FINAL DESIGN
Project Code:	CS-9
Drawing Number:	00

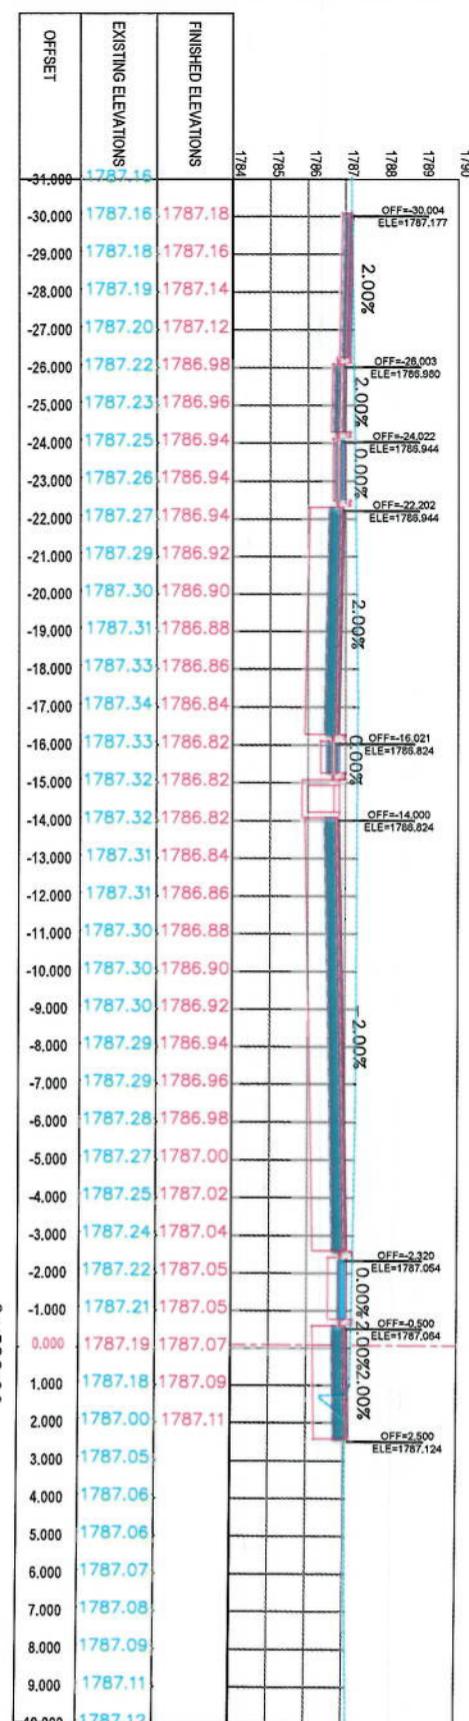

0+580.00

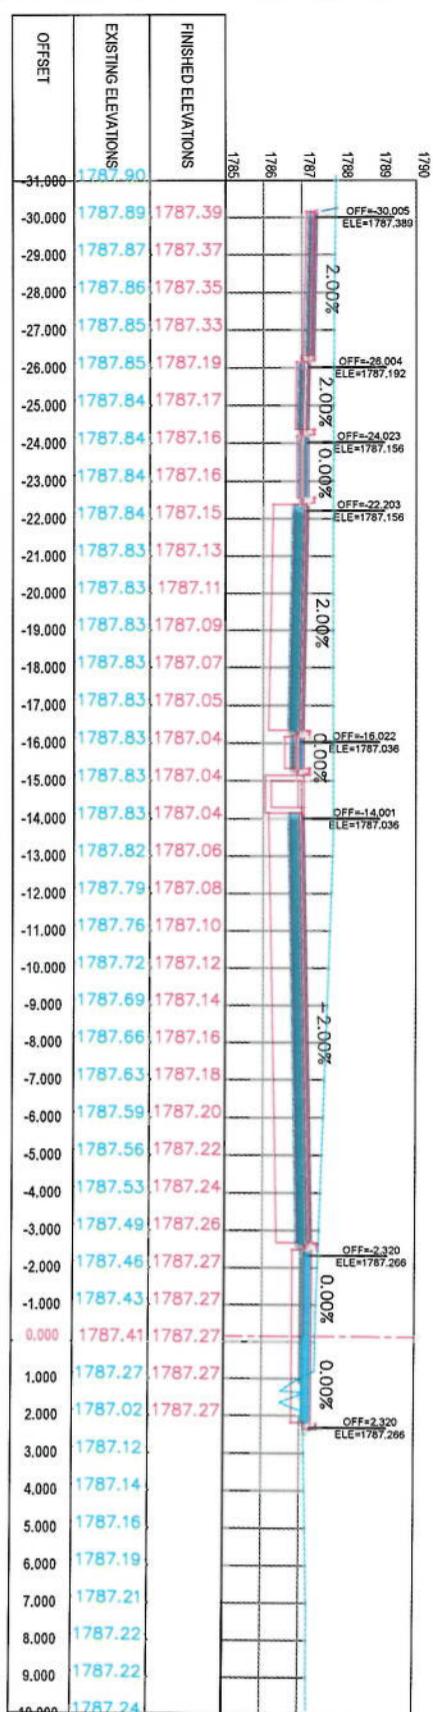

0+540.00


CROSS SECTIONS

Designed by:
Signature:
Mohammad Esa Sari
Drawn by:
Signature:
Mohammad Esa Sari
Checked by:
Signature:
Hasanullah Shahzad

Code-Sign To Demazang
Road Project

Project Name:
KABUL MUNICIPALITY
DESIGN TEAM

Client
KABUL MUNICIPALITY

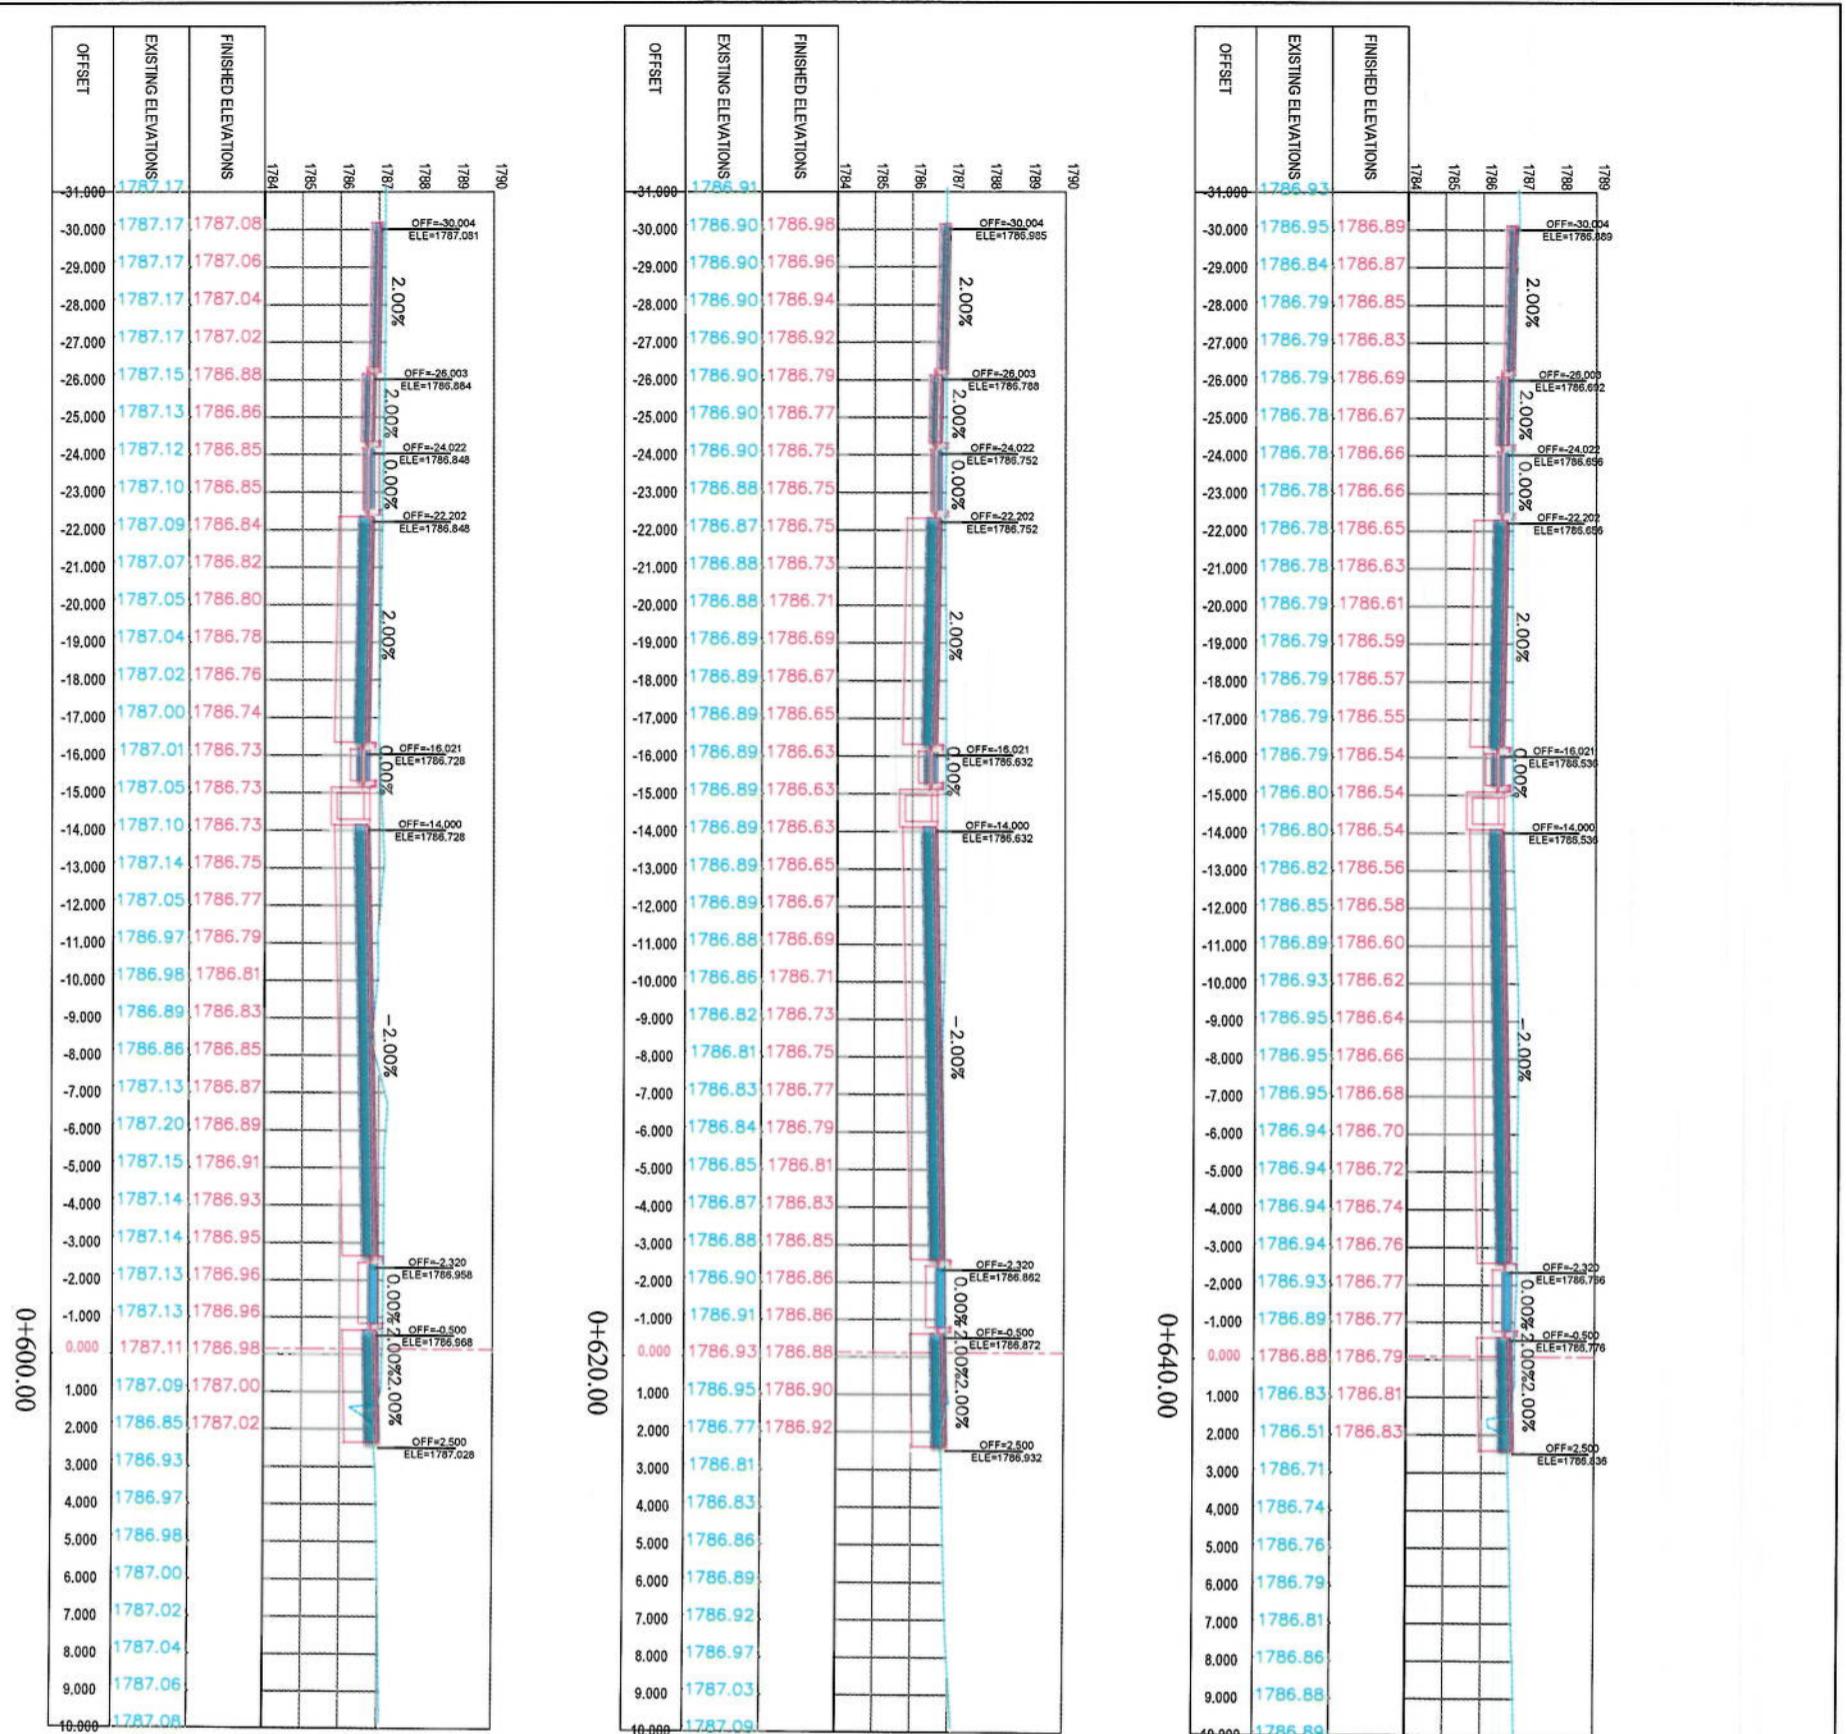

NOTE:


1. All dimensions are in meters unless otherwise indicated

LEGENDS


- CENTER-LINE
- - - EXISTING SURFACE
- EXISTING SIDE DITCH



CROSS SECTIONS		
Drawing Title:		
Designed by:	KABUL MUNICIPALITY	Drawn by:
Project Name:	KABUL MUNICIPALITY DESIGN TEAM	
Conc-Sang To Demazang	Road Project	
Date:	6/7/2023	Scale:
Status:	FINAL DESIGN	
Project Code:	CS-11	Revision: 00

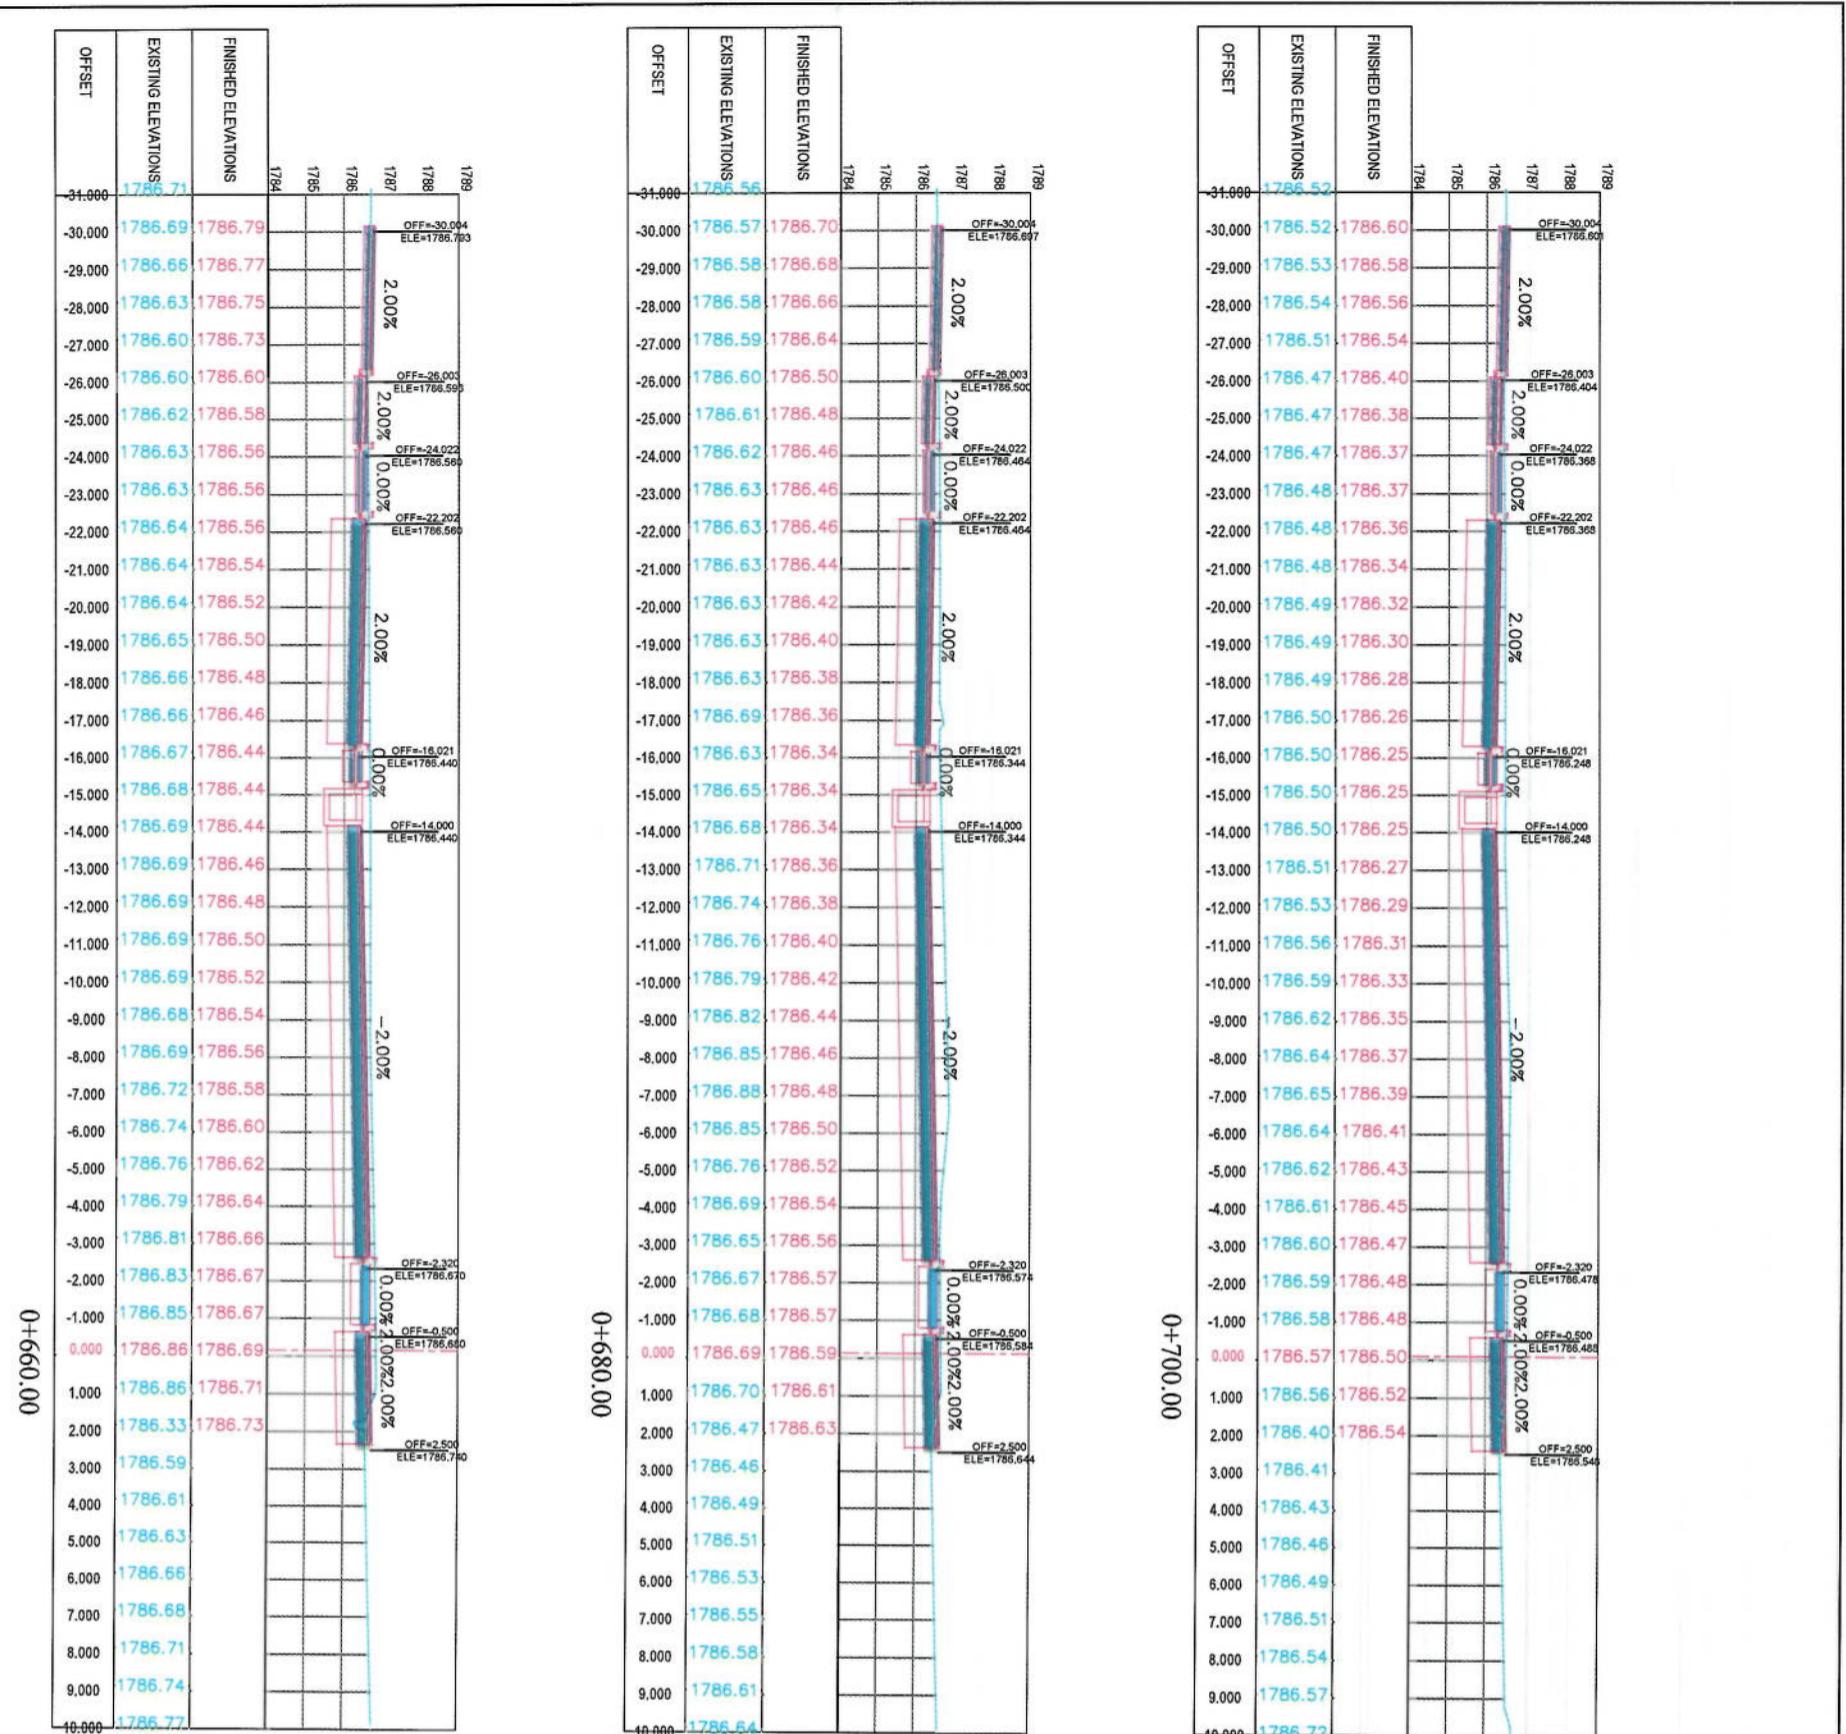

0+680.00

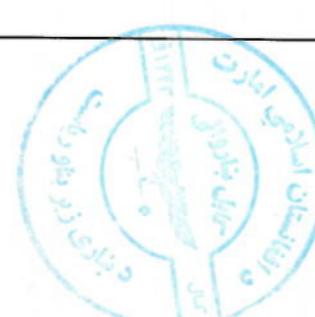

NOTE:


1. All dimensions are in metres unless otherwise indicated.

LEGENDS



- CENTER-LINE
- EXISTING SURFACE
- EXISTING SIDE DITCH

CROSS SECTIONS	
Designed By:	Signature:
Mohammad Esa Solt	
Drawn By:	Signature:
Mohammad Esa Solt	
Checked by:	Signature:
Hanbulah Shahzai	
Project Name:	
Code-Signed To Demazang	
Road project	
Drawing Title:	
Project Code:	
Date:	Scale:
6/7/2023	1:200
Status:	FINAL DESIGN
Drawing Number:	CS-12
Revision:	00

0+720.00

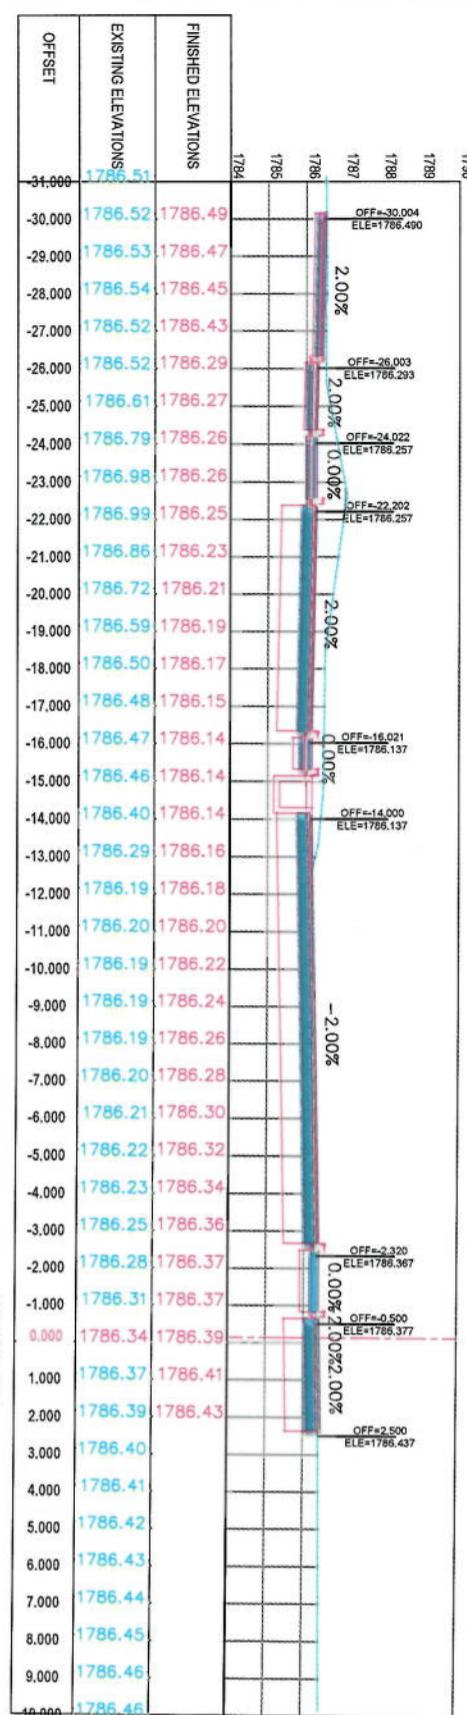


0+740.00

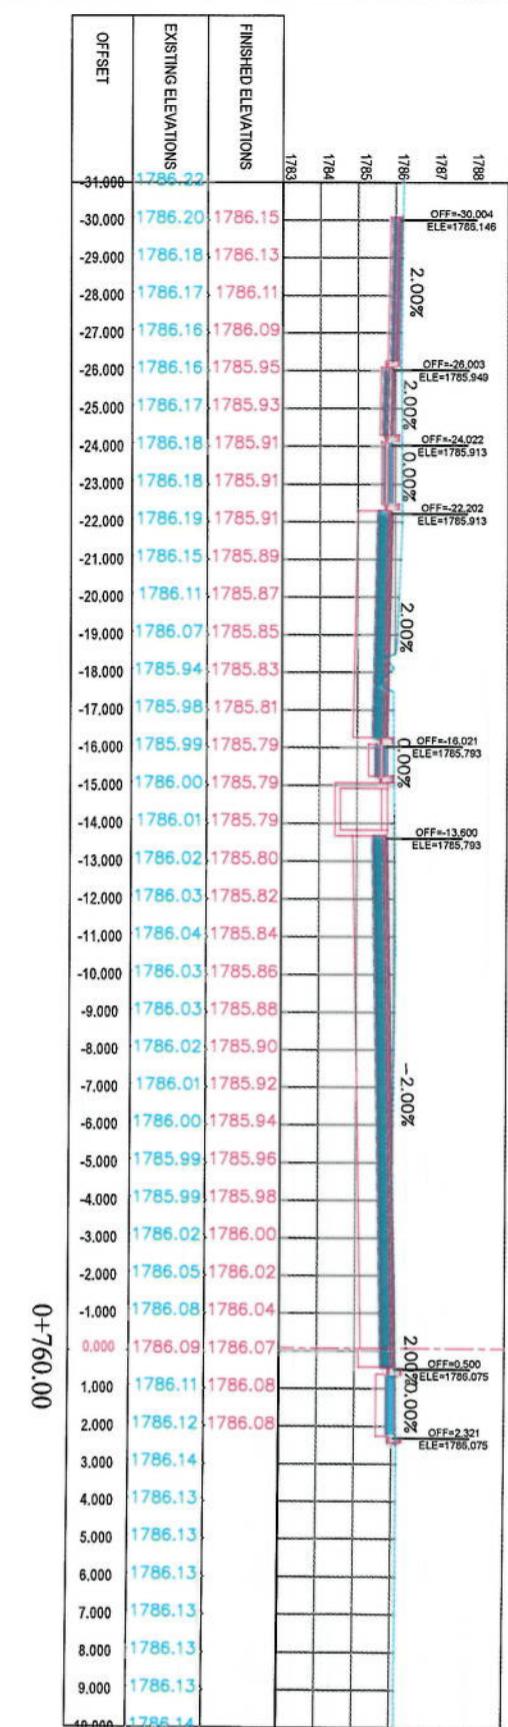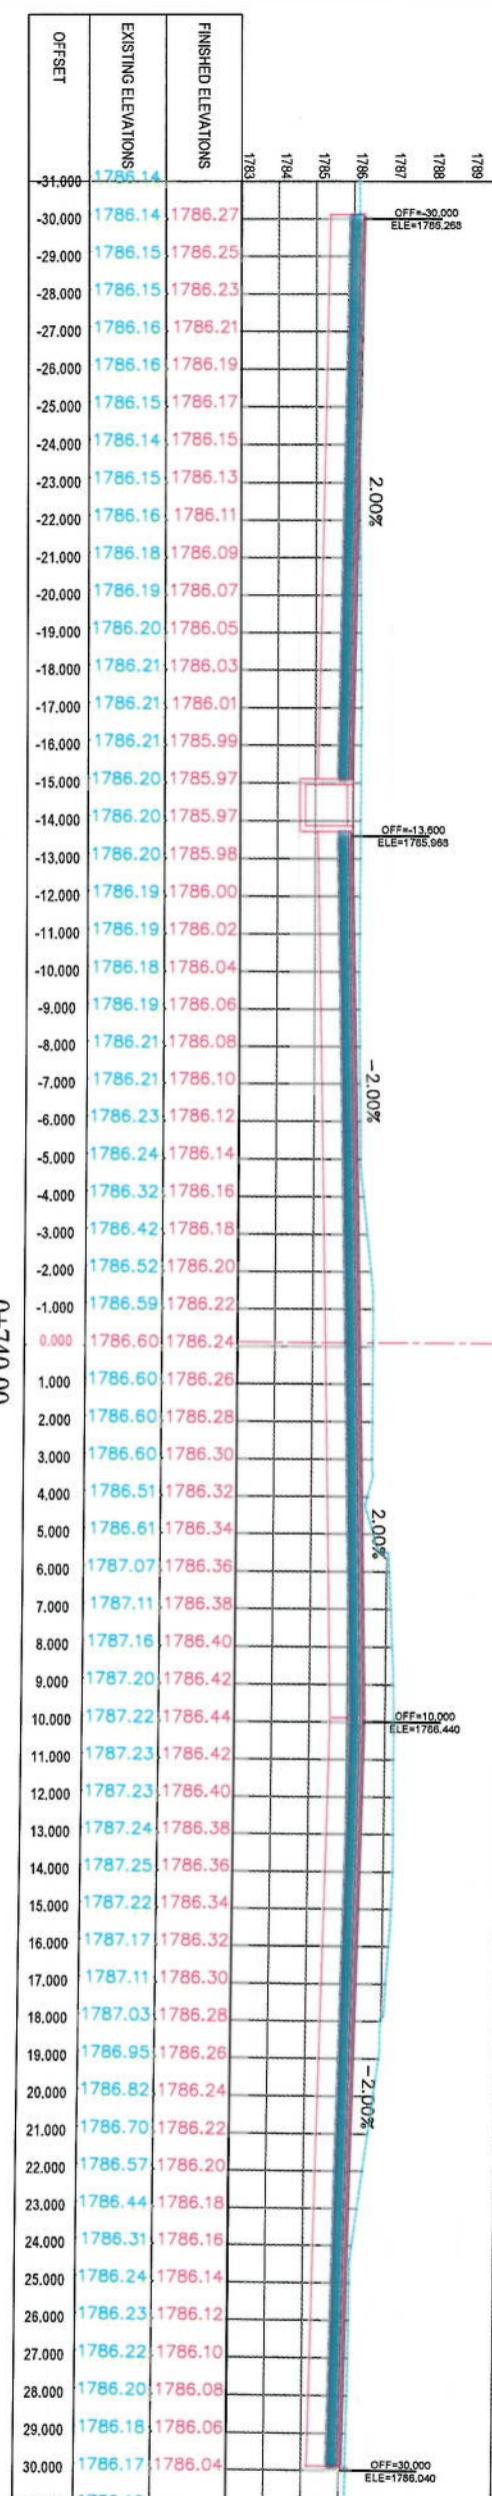


NOTE:

1. All dimensions are in meters unless otherwise indicated.

LEGENDS		
CENTER-LINE		
EXISTING SURFACE		
EXISTING SIDE DITCH		

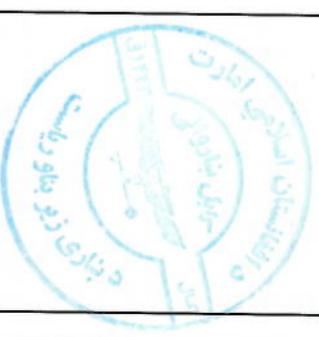

Project Code:	CS-13
Revision:	00

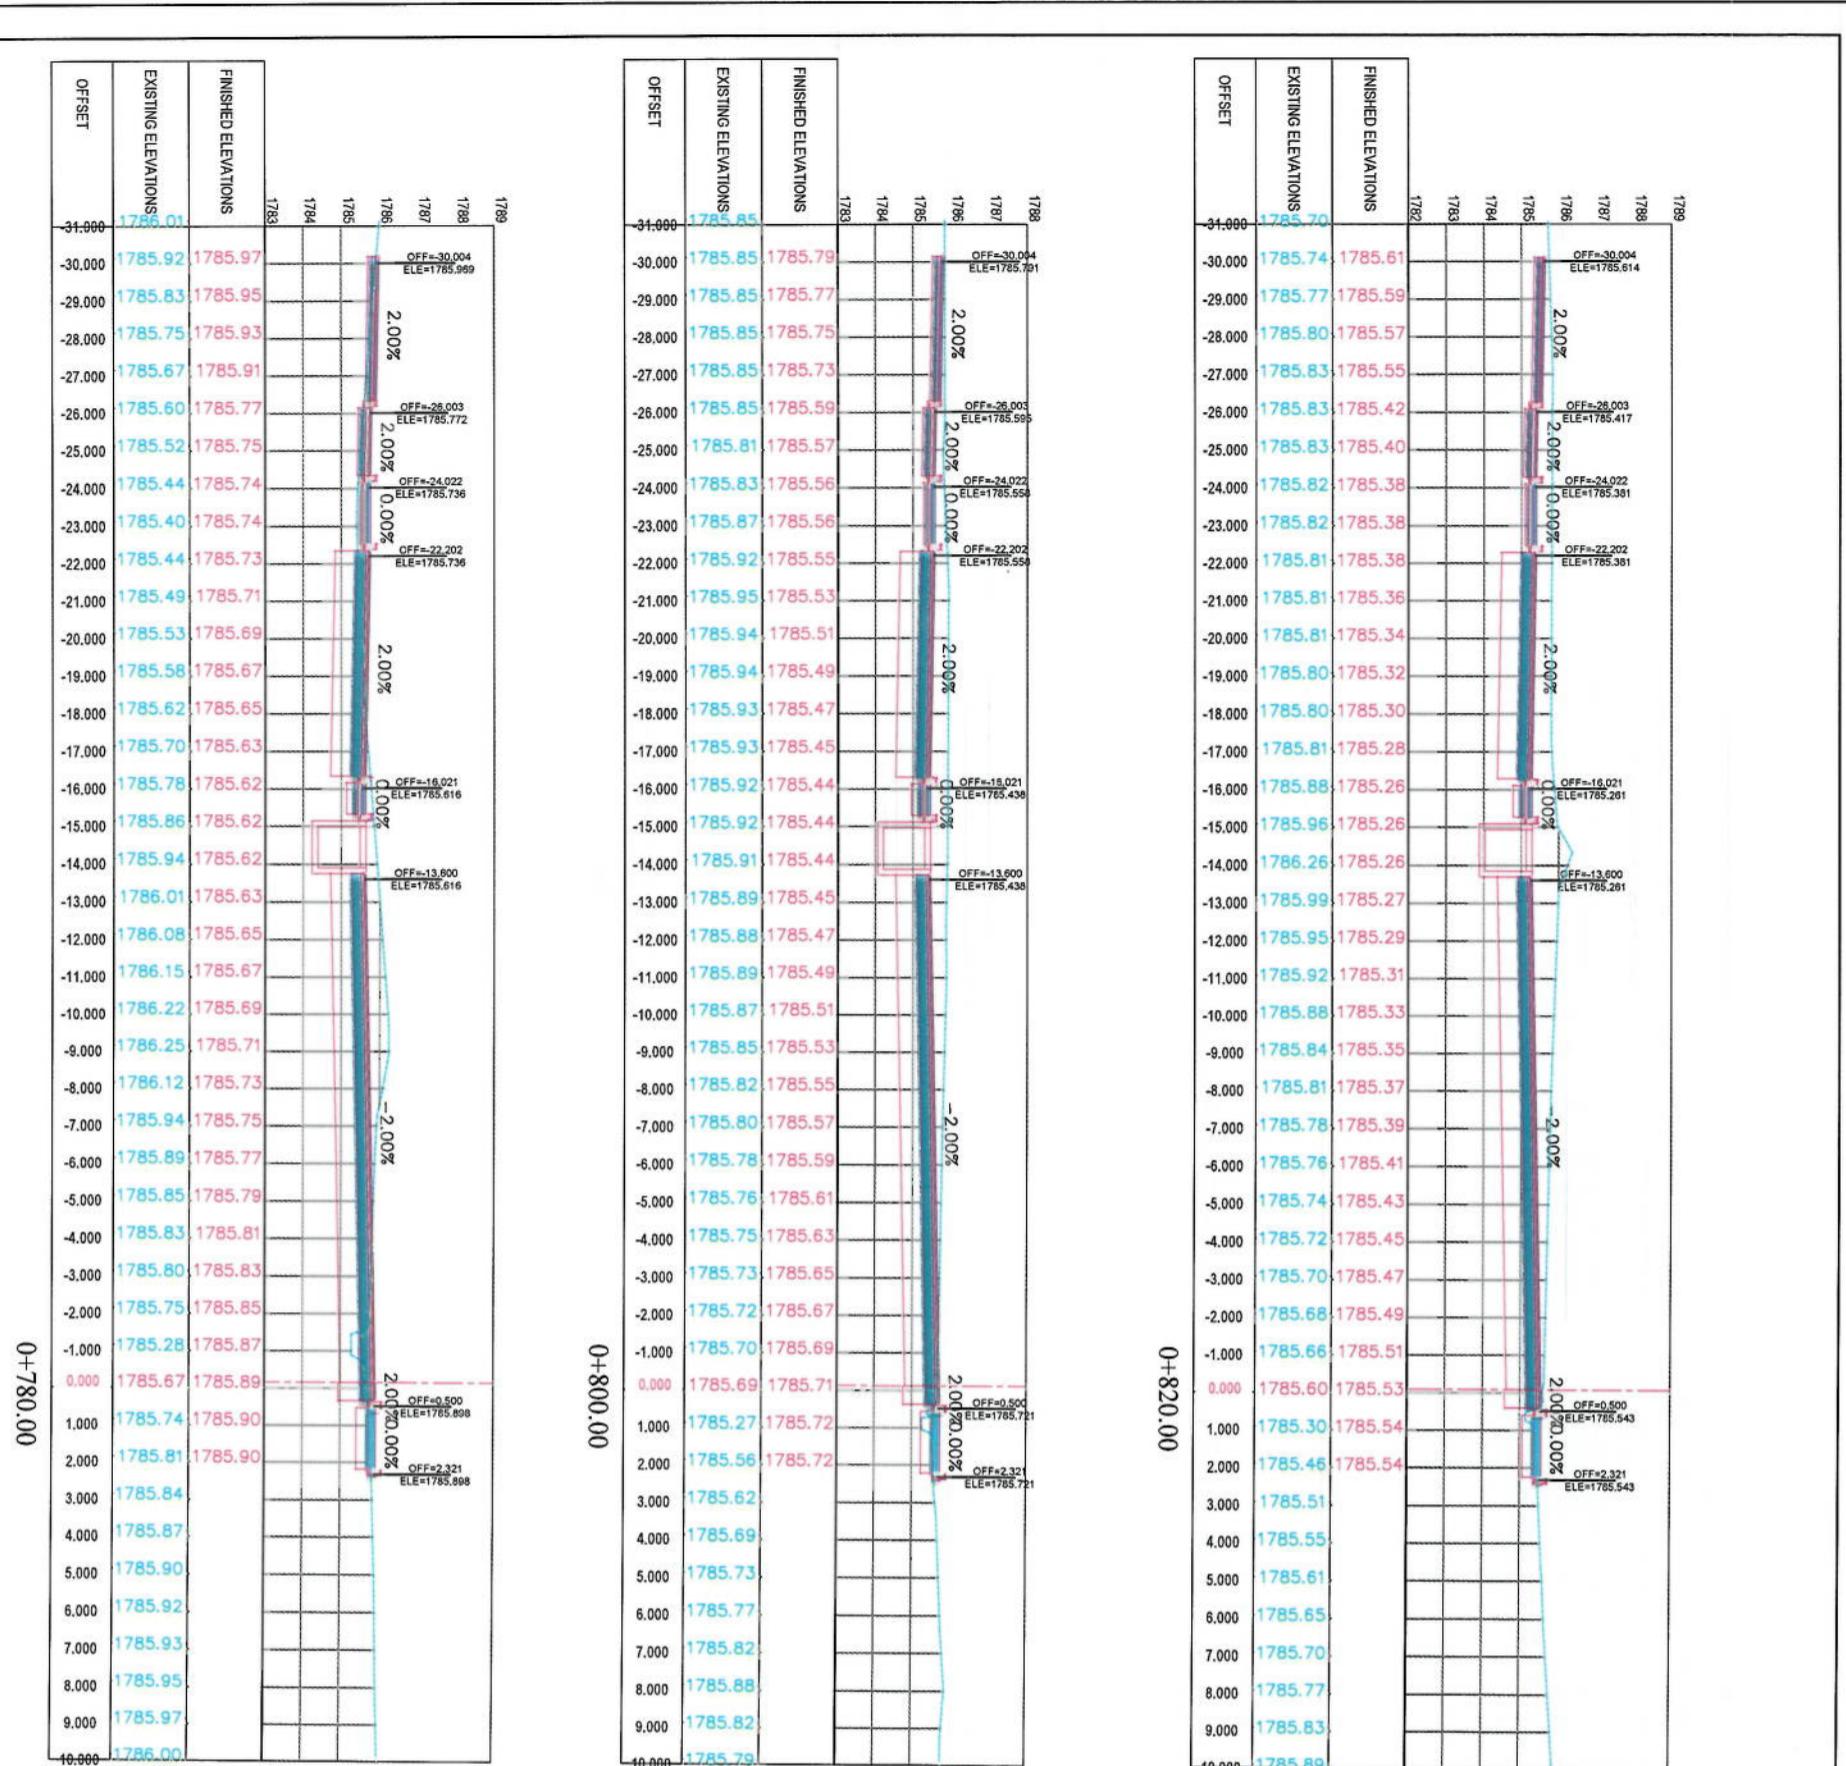

NOTE:


1. All dimensions are in meters unless otherwise indicated.

LEGENDS

- CENTER-LINE
- EXISTING SURFACE
- EXISTING SIDE DITCH



Project Name:	KABUL MUNICIPALITY DESIGN TEAM
Client:	KABUL MUNICIPALITY
Designed by:	KABUL MUNICIPALITY DESIGN TEAM
Drawing Title:	CROSS SECTIONS
Designed by:	Mohammad Eisa Sait
Drawn by:	Mohammad Eisa Sait
Checked by:	Hoshibullah Saitra
Date:	6/7/2023
Scale:	1:200
Status:	FINAL DESIGN
Project Code:	
Drawing Number:	CS-14
Revision:	00


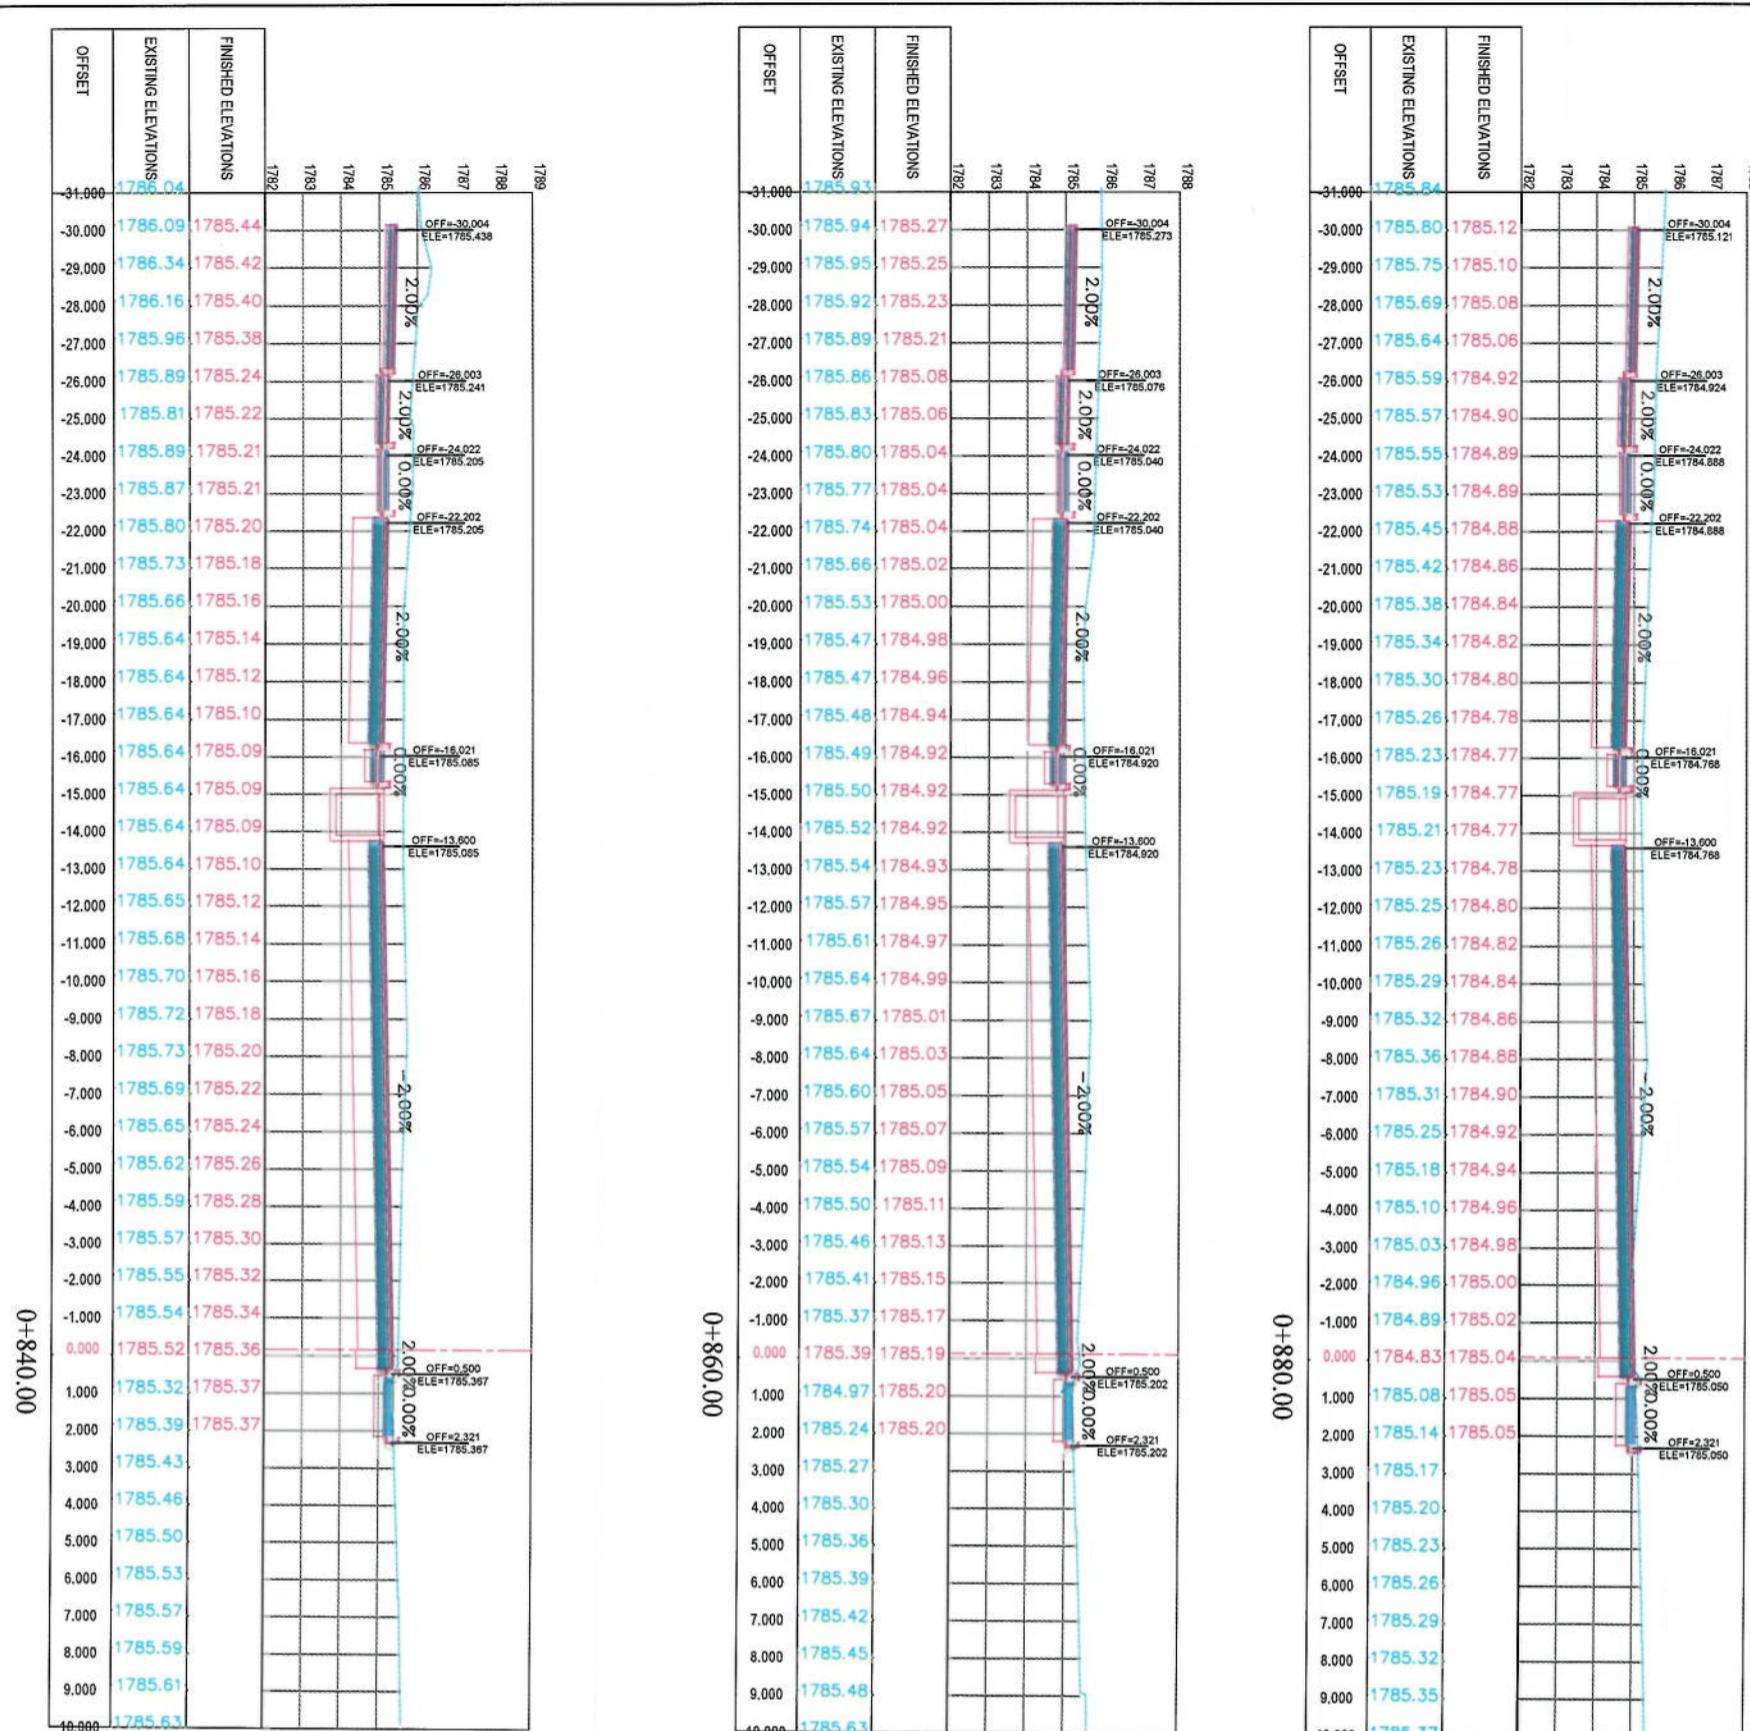


NOTE:
1. All dimensions are in metres unless otherwise indicated.


LEGENDS		
—	CENTER-LINE	
---	EXISTING SURFACE	
—	EXISTING SIDE DITCH	



Project Name:	KABUL MUNICIPALITY DESIGN TEAM		
Drawing Title:	Coke-Sawg To Demazang Road Object		
Designed by:	KABUL MUNICIPALITY		
Checked by:	Habibullah Shabazi		
Date:	6/7/2023		
Scale:	1:200		
Status:	FINAL DESIGN		
Project Code:	CS-15		
Drawing Number:	00		

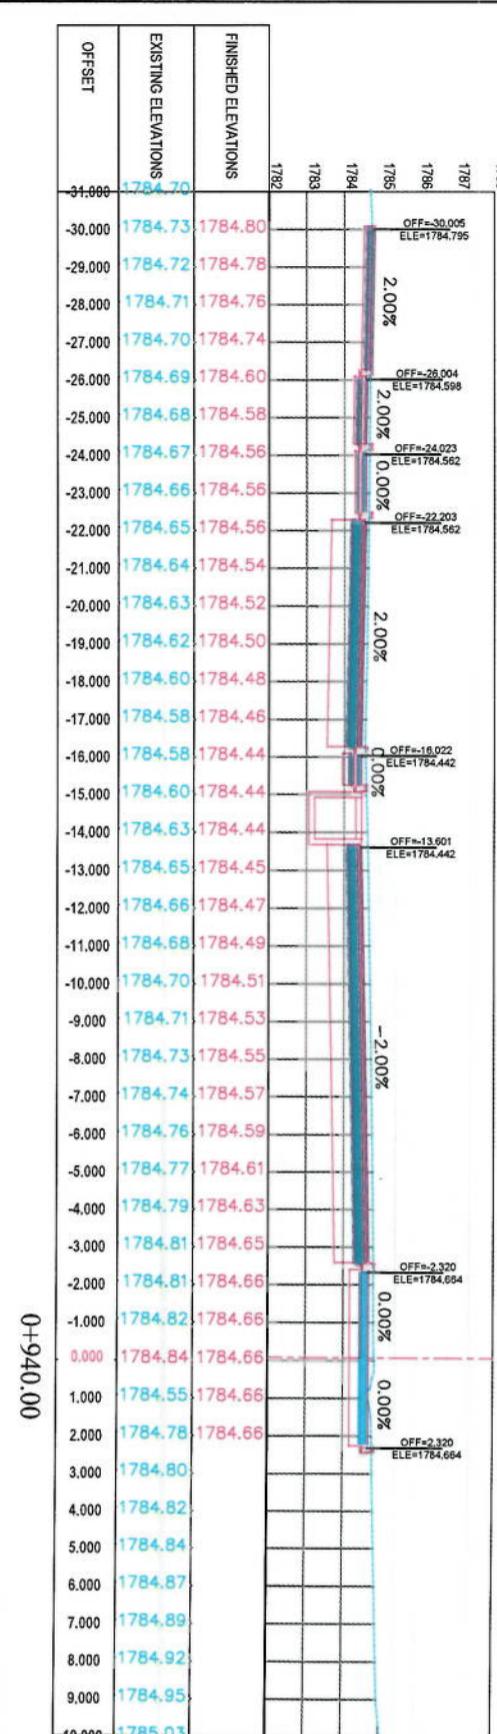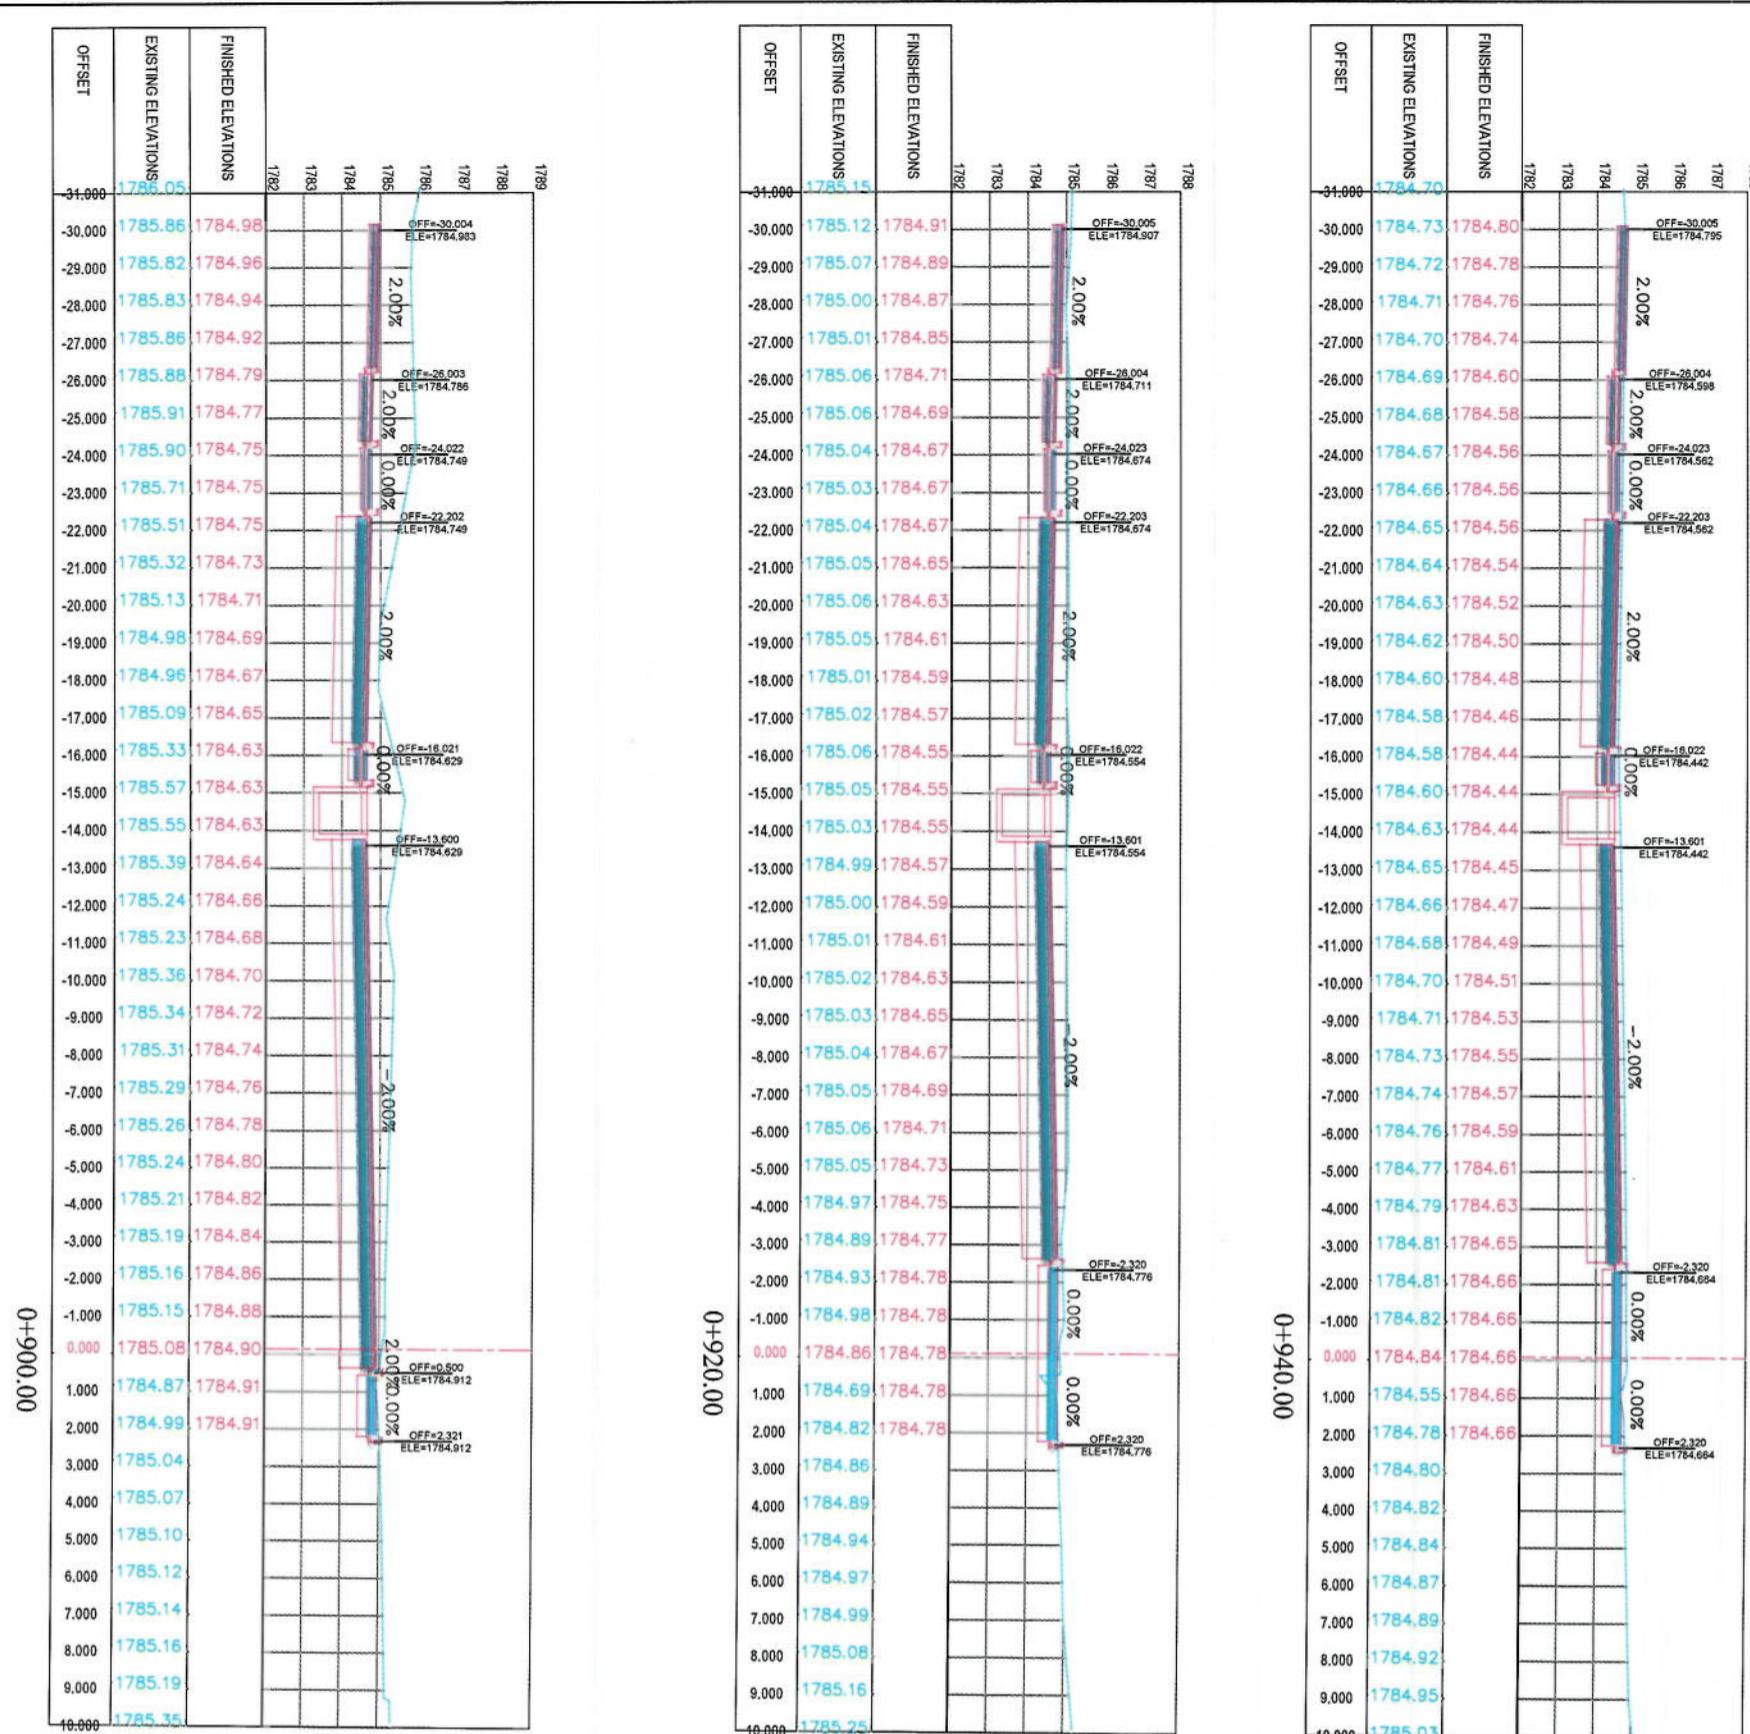

0+920.00

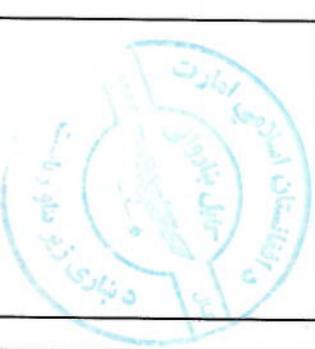


NOTE:
1. All dimensions are in meters unless otherwise indicated.


LEGENDS
CENTER-LINE
EXISTING SURFACE
EXISTING SIDE DITCH

Project Name:	Cone-Sang To Demazang Road Project	
Designed by:	KABUL MUNICIPALITY DESIGN TEAM	
Drawing Title:	CROSS SECTIONS	
Designed by:	Mohammad Ihsan Sirat	
Drawn by:	Signature	
Checked by:	Mohammad Ihsan Sirat	
Client:	Hauzkhil Shura	
Date:	6/7/2023	
Scale:	1:200	
Status:	FINAL DESIGN	
Project Code:	CS-16	
Drawing Number:	00	

0+960.00

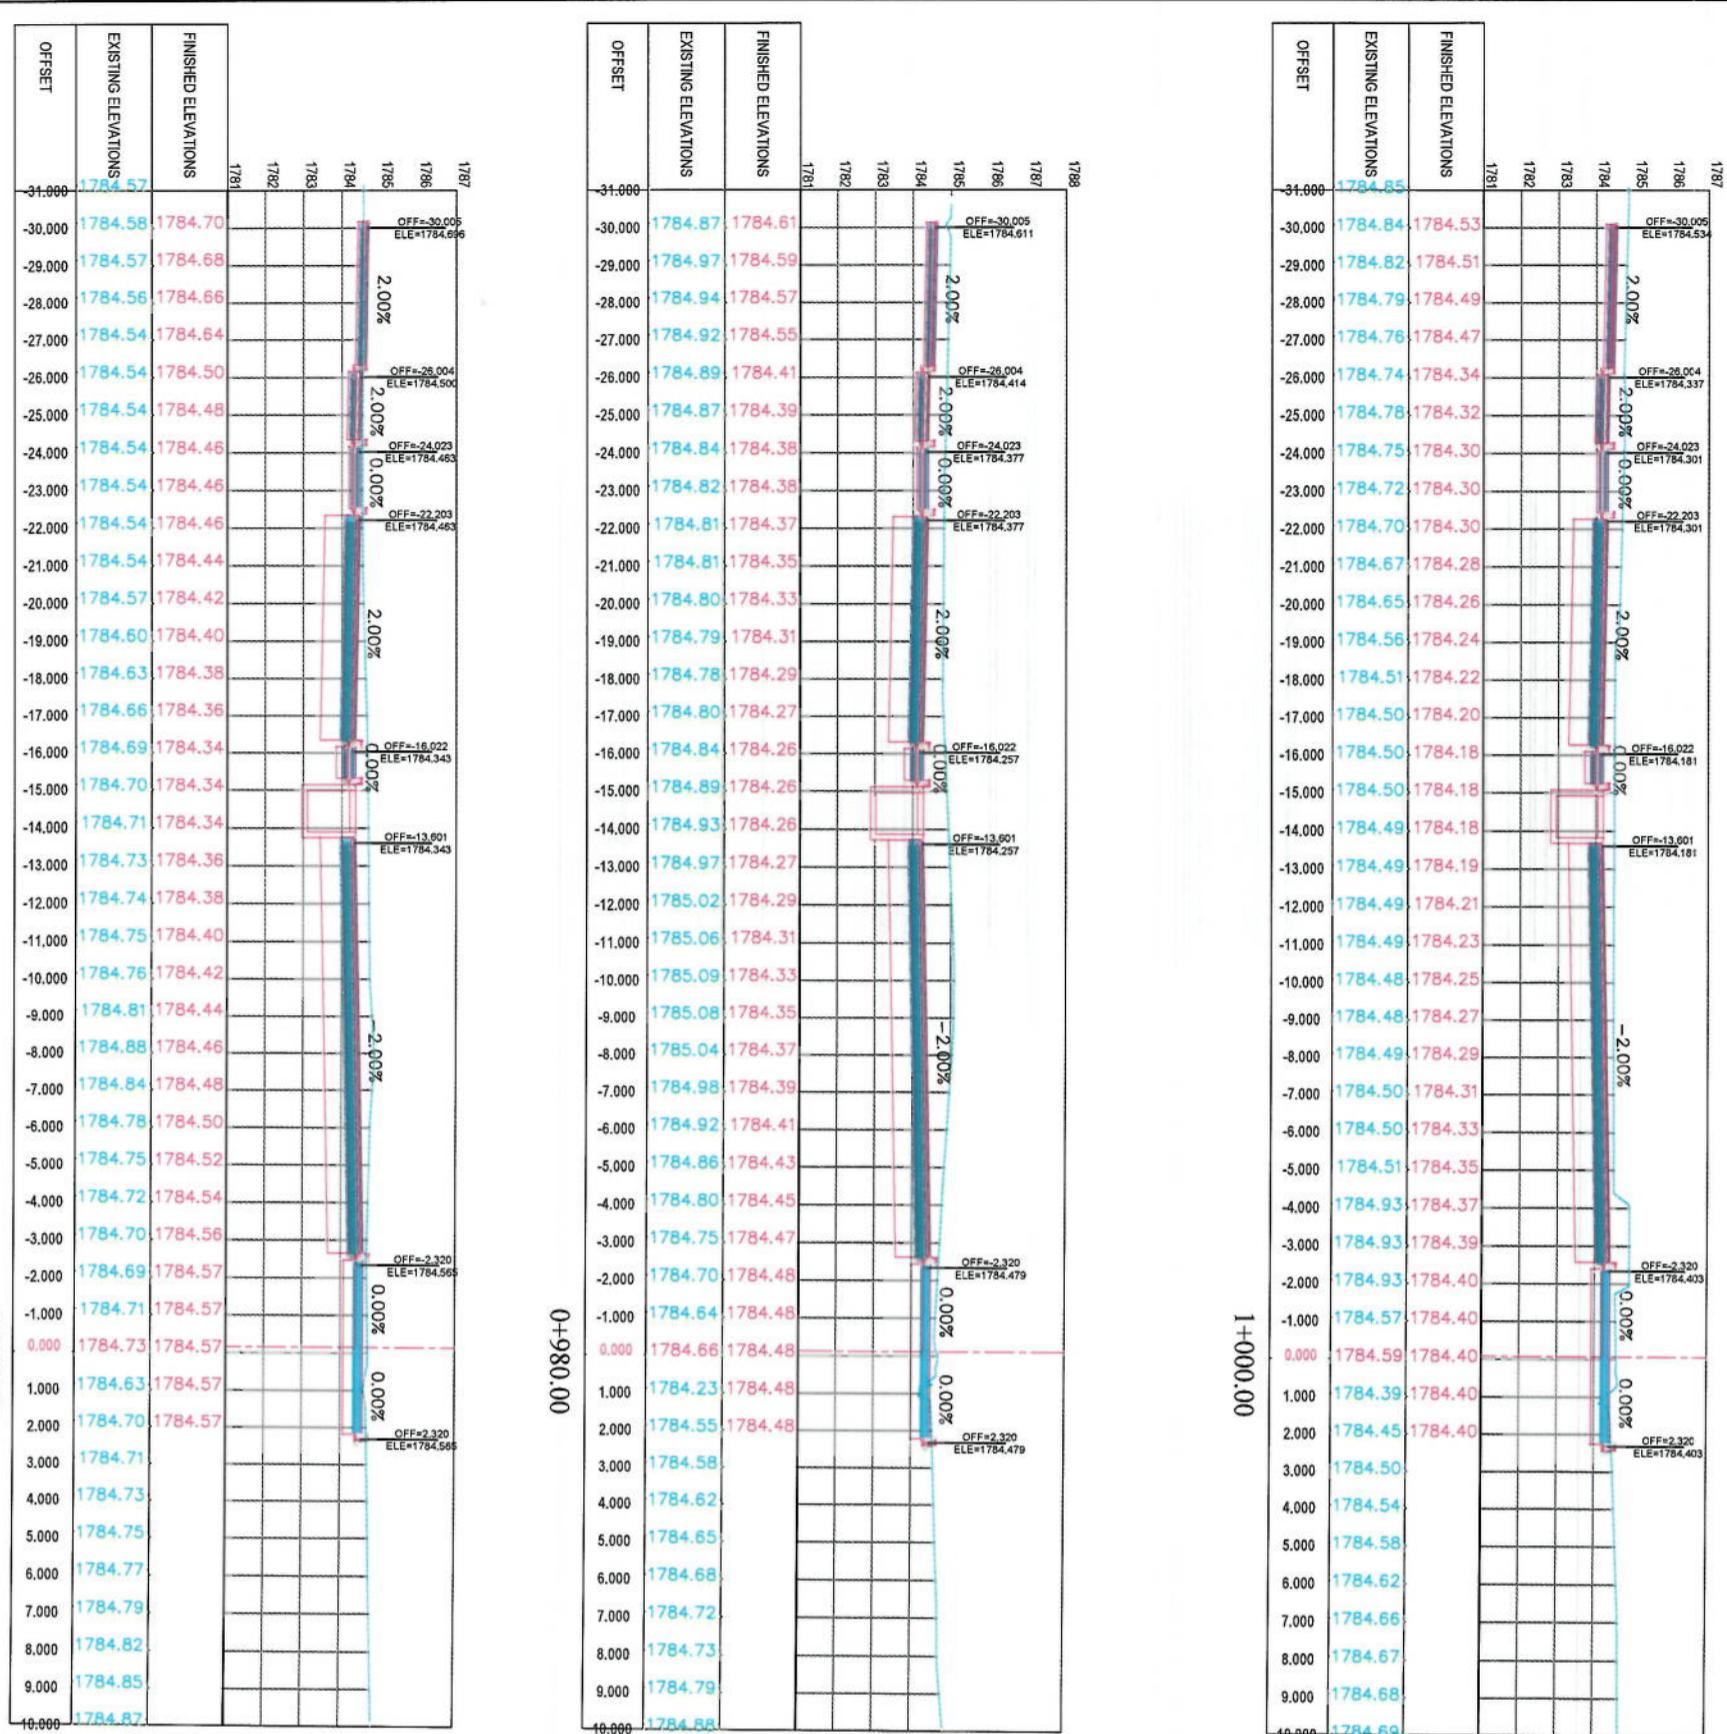

0+980.00

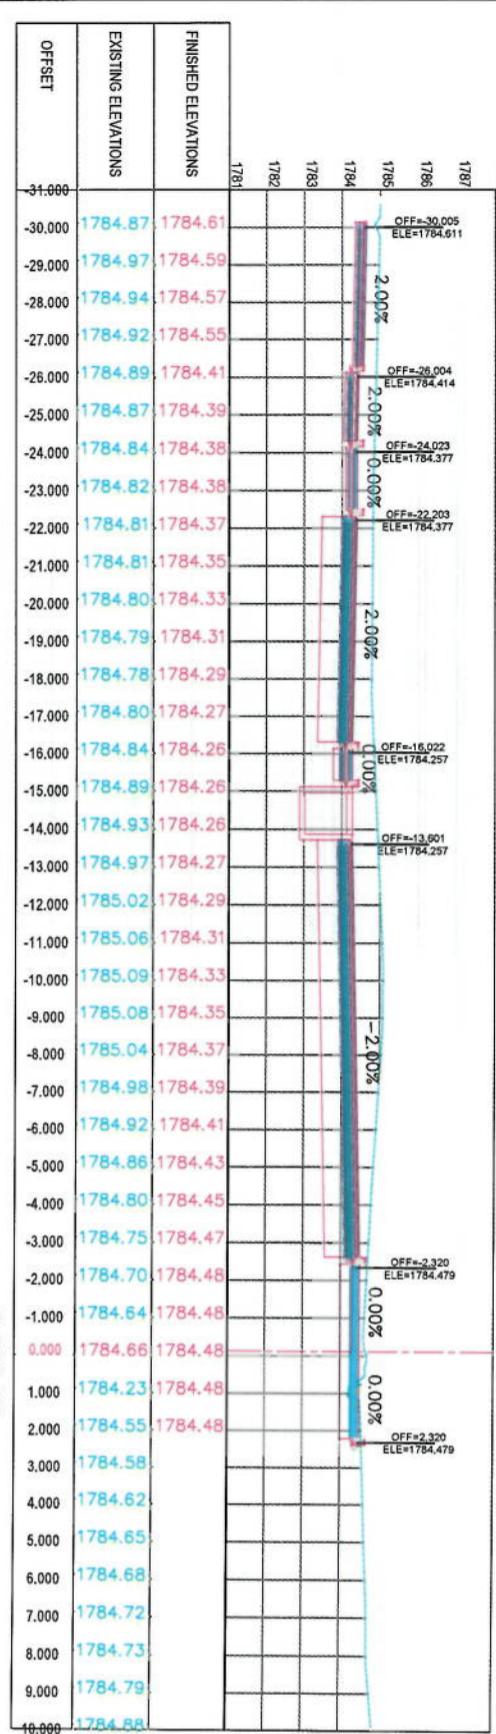





NOTE:
1. All dimensions are in metres unless otherwise indicated

LEGENDS

- CENTER-LINE
- EXISTING SURFACE
- EXISTING SIDE-DITCH




Project Name:	Cord-Sangi To Demizing Road Project	
Designed by:	Mohammad Esa Sirat	
Drawn by:	Signature:	
Checked by:	Signature:	
Date:	6/7/2023	
Scale:	1:200	
Sheet:	FINAL DESIGN	
Project Code:	CS-17	
Drawing Number:	00	

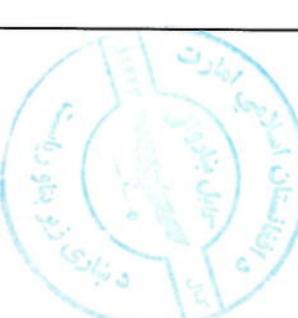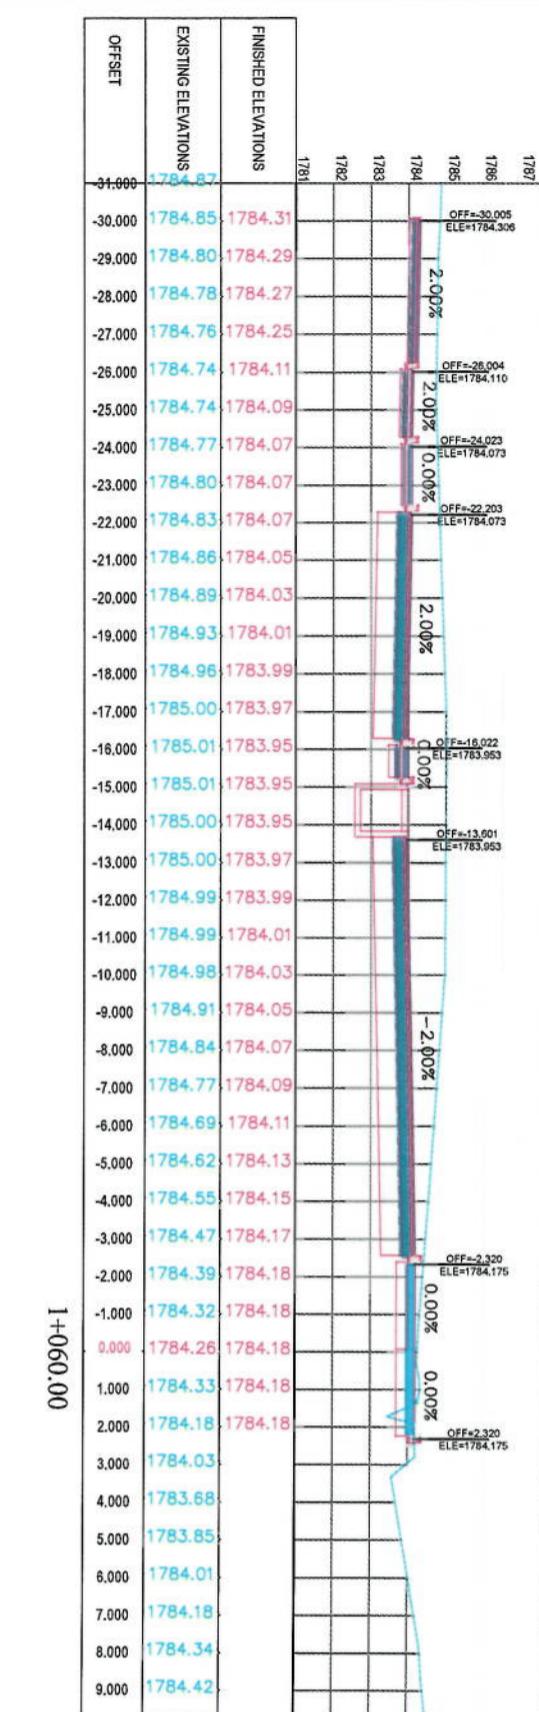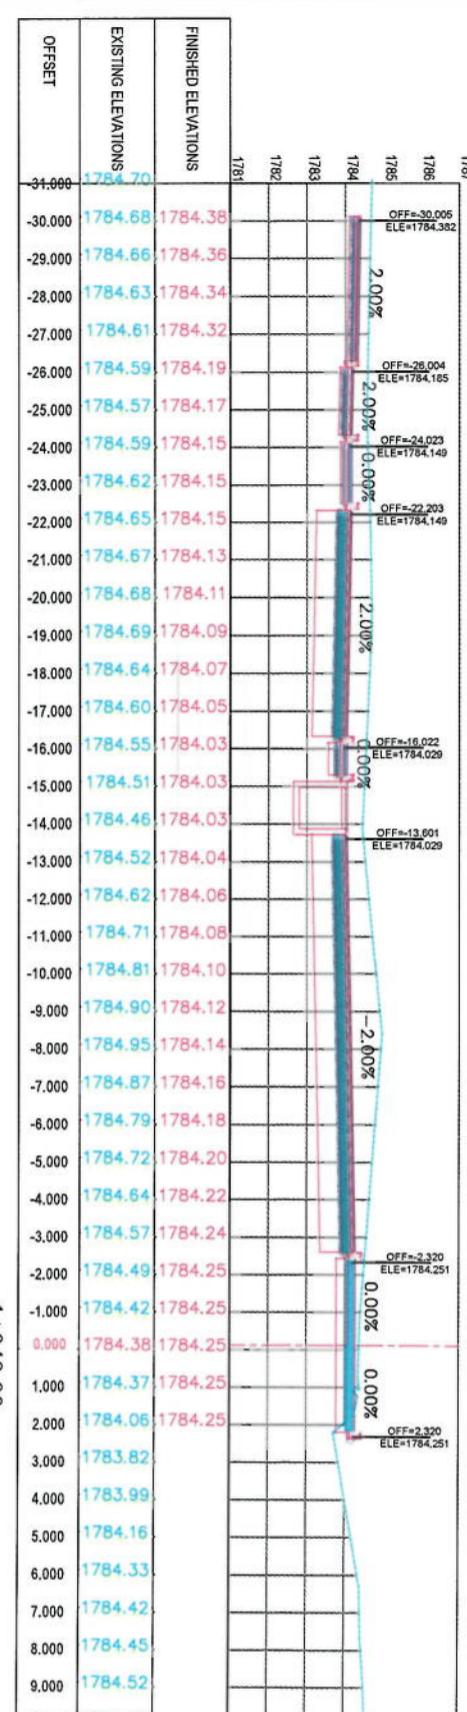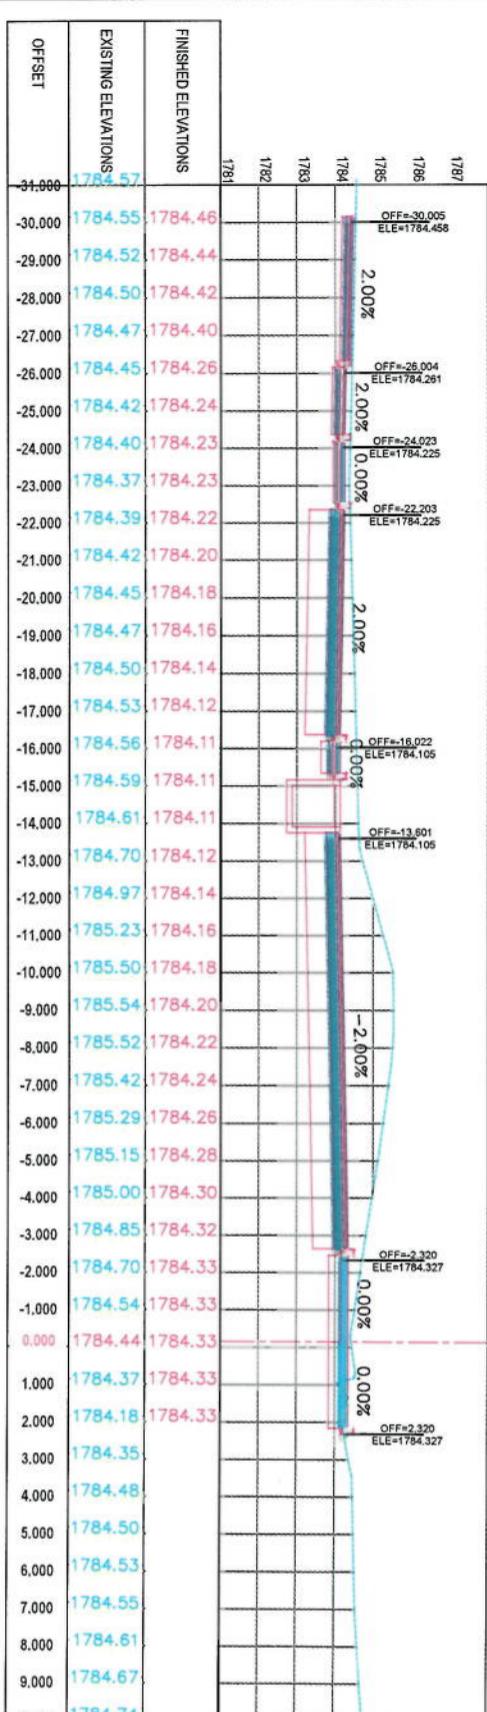

NOTE
1. All dimensions are in meters unless otherwise indicated.

LEGENDS
 — CENTER-LINE
 - - - EXISTING SURFACE
 - - - EXISTING SIDE DITCH

Project Name:	KABUL MUNICIPALITY DESIGN TEAM	
Drawing Title:	Cot-e-Sang To Demzang Road project	
Checked by:	Hasnullah Shabazi	
Date:	6/7/2023	
Status:	FINAL DESIGN	
Project Code:	CS-18	
Drawing Number:	00	

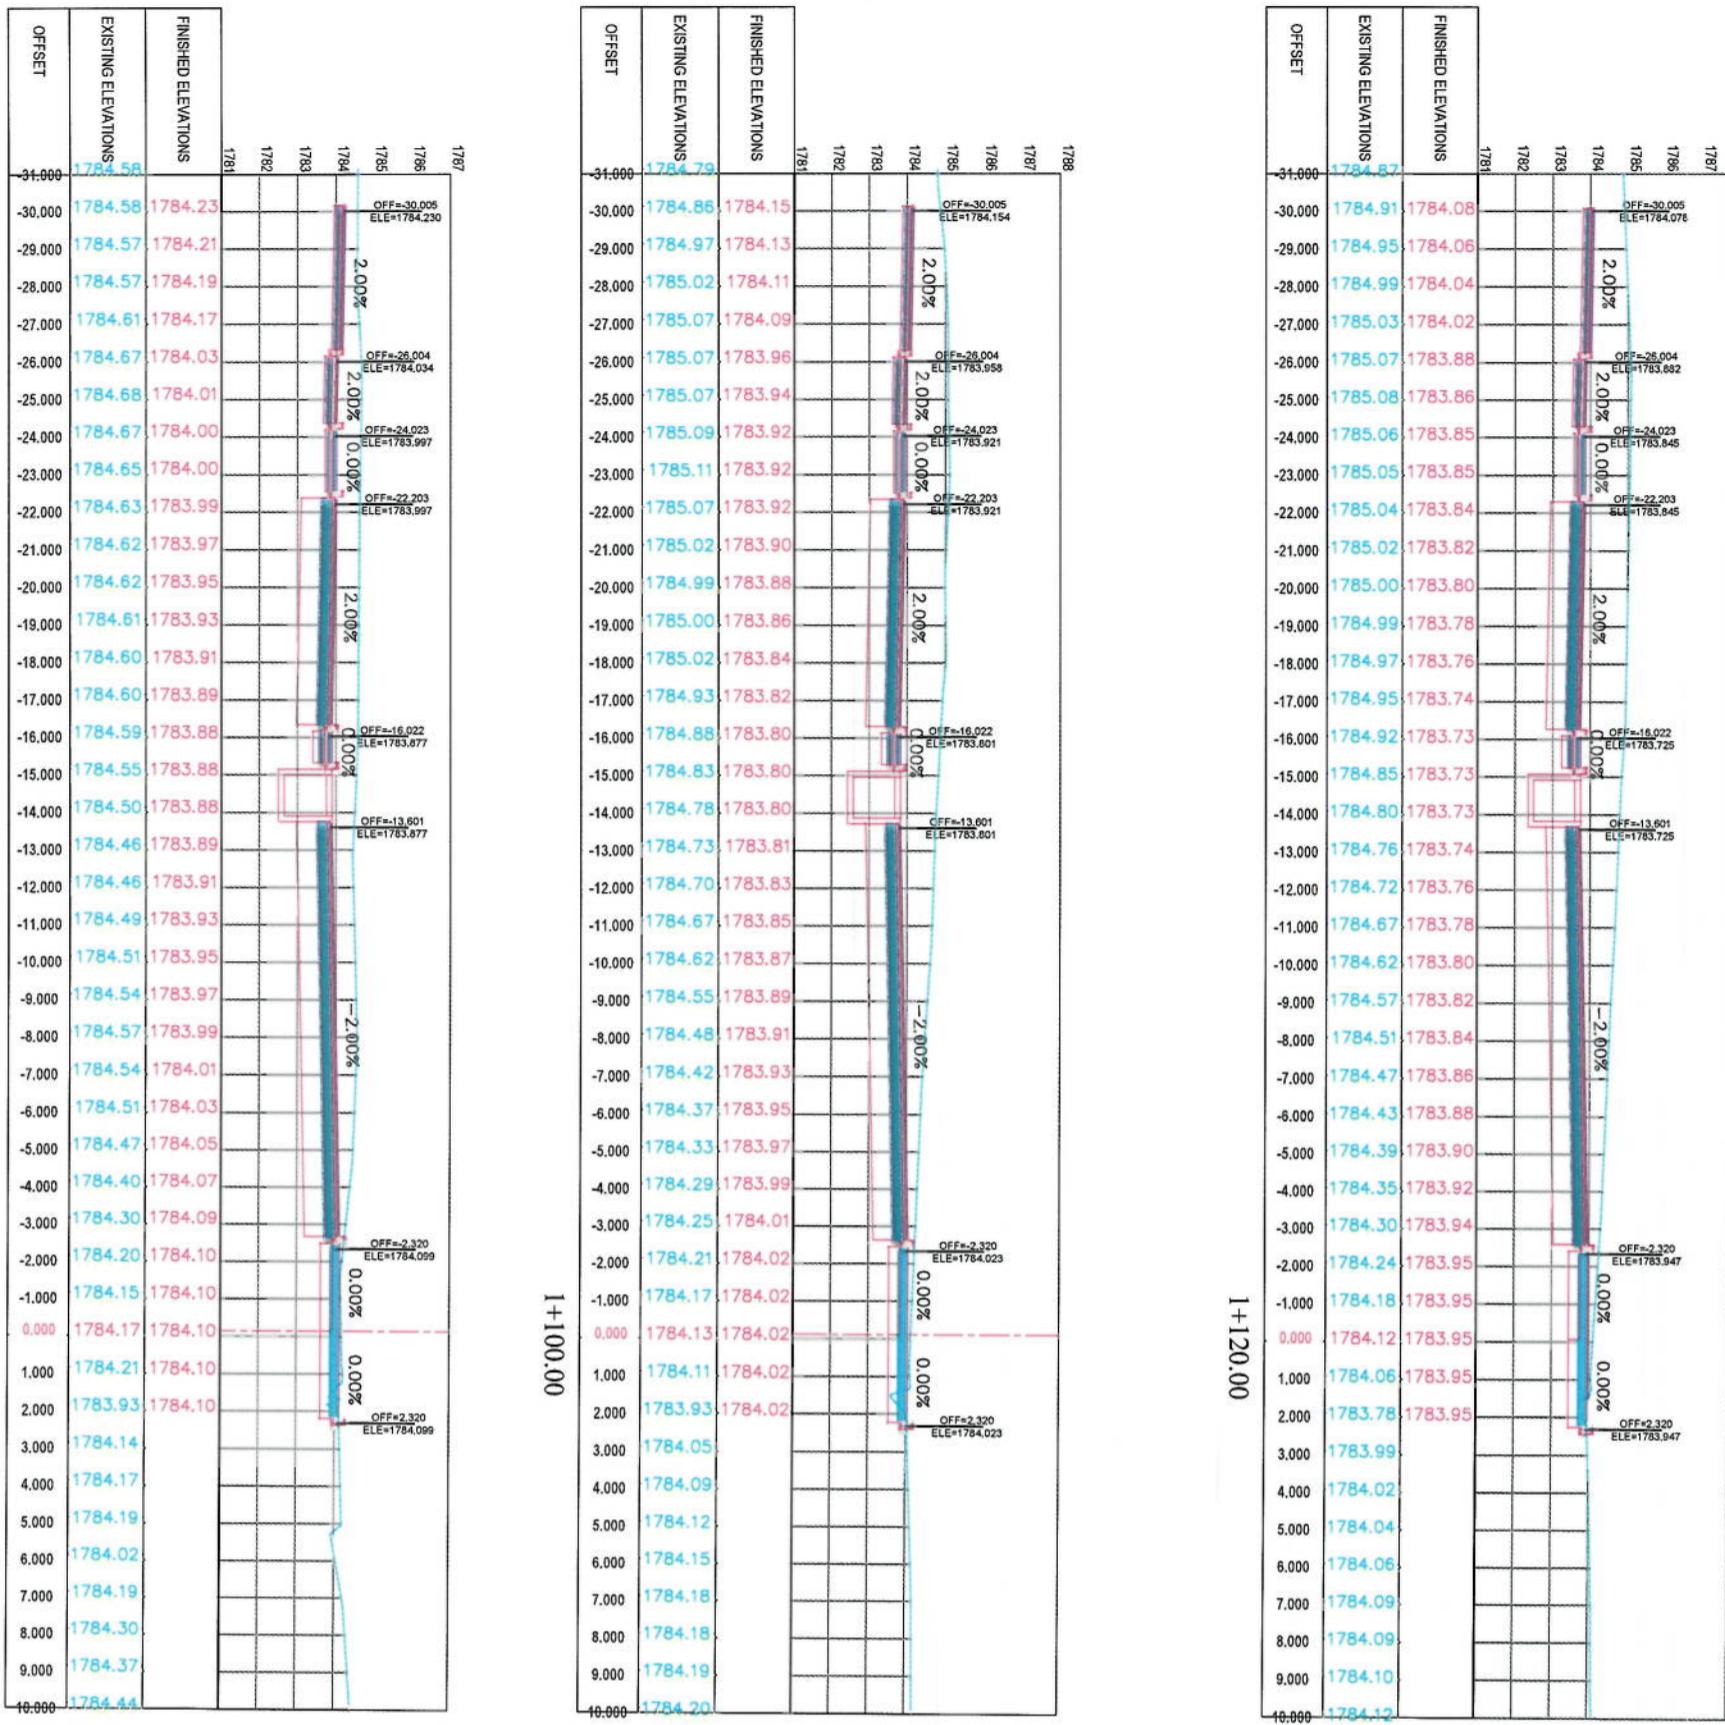

Project Name:	KABUL MUNICIPALITY DESIGN TEAM		
Drawing Title:	Cross-Section To Demazang Road Project		
CROSS SECTIONS			
Designed By:	Signature: Mohammad Esa Sait	Date: 6/7/2023	Revision: 00
Drawn by:	Signature: Mohammad Esa Sait		
Checked by:	Signature: Hashimullah Saitz		
Status:	FINAL DESIGN		
Project Code:			
Drawing Number:	CS-19	Revision:	00




NOTE:

1. All dimensions are in meters unless otherwise indicated.

LEGENDS

— CENTER-LINE
- - - EXISTING SURFACE
— EXISTING SIDE DITCH



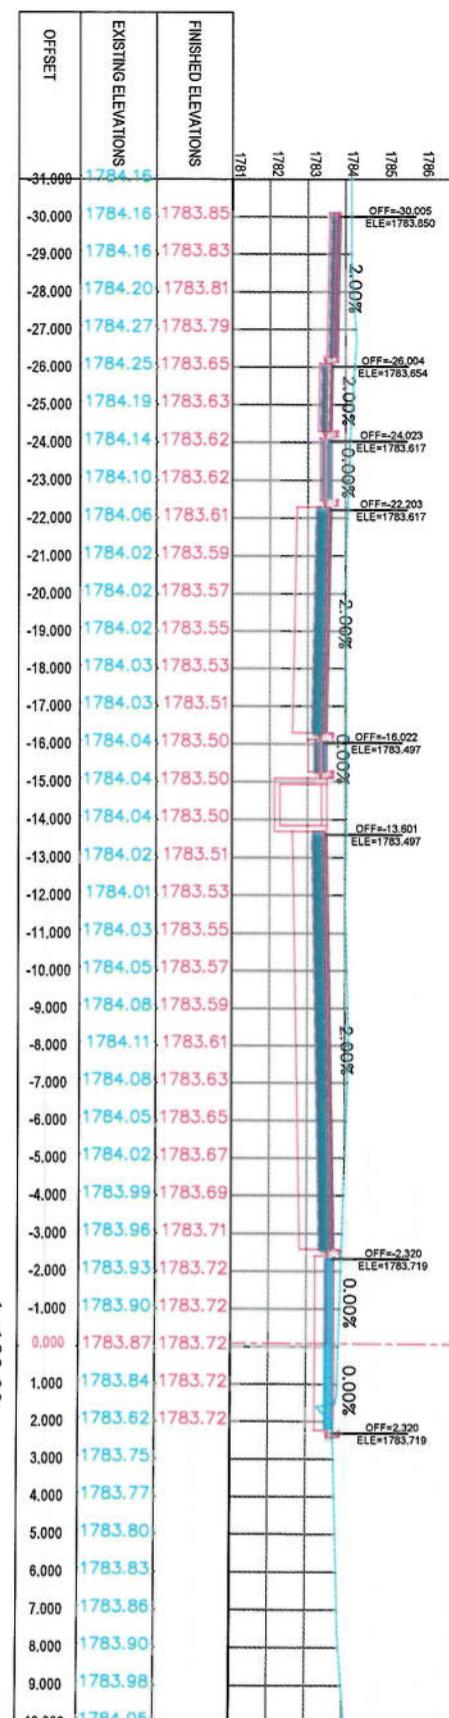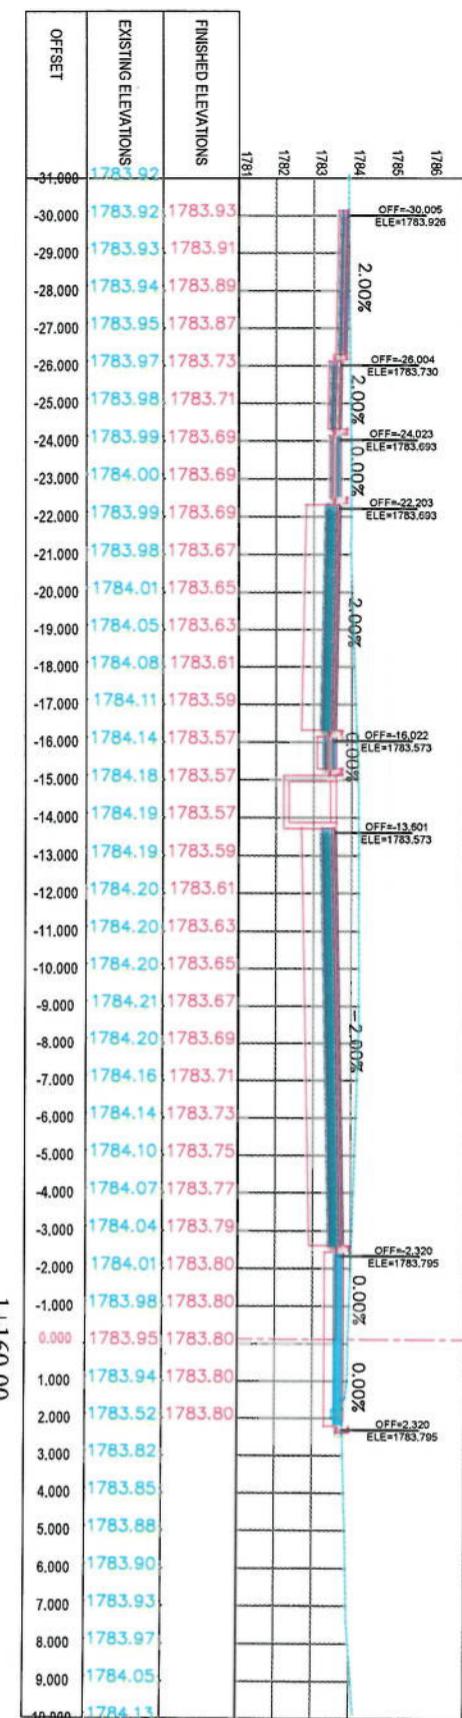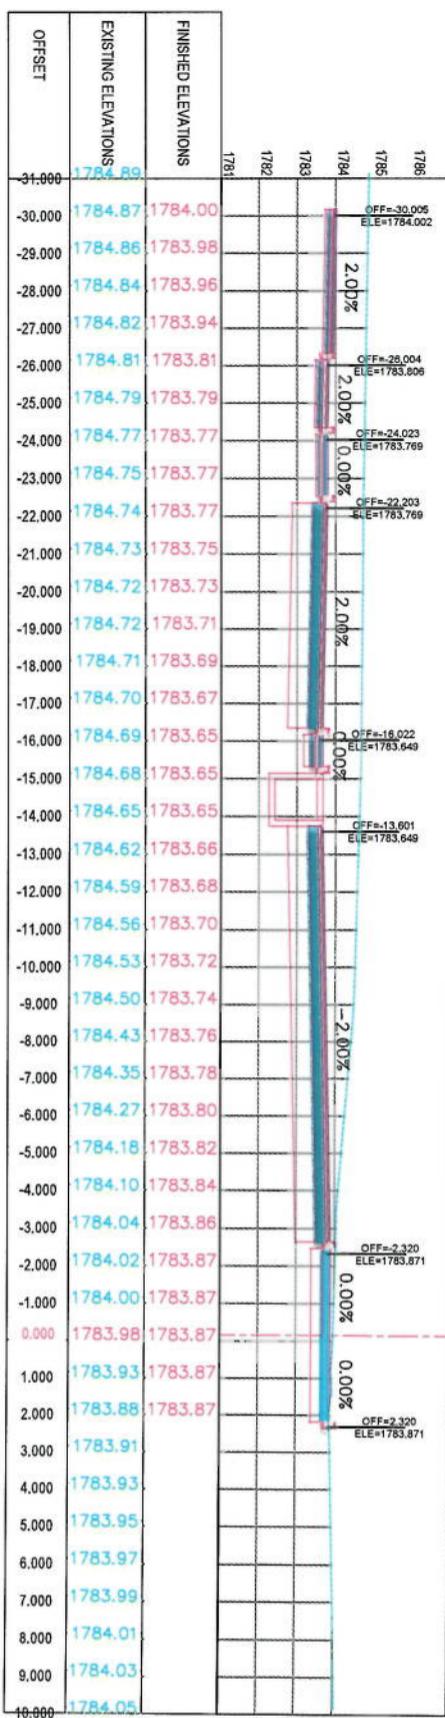

1+160.00

1+180.00




NOTE:
1. All dimensions are in metres unless
otherwise indicated.


LEGENDS

- CENTER-LINE
- EXISTING SURFACE
- EXISTING SIDE DITCH


CROSS SECTIONS	
Designed by:	KABUL MUNICIPALITY DESIGN TEAM
Project Name:	KABUL MUNICIPALITY AFGHANISTAN
Code-Sign To Demazang	Rod Sifat
Drawing Title	
Designed by:	Mohammad Eesa Sifat
Drawn by:	Mohammad Eesa Sifat
Checked by:	Hassanullah Shafiq
Date	6/7/2023
Scale	1:200
Status:	FINAL DESIGN
Project Code:	
Drawing Number	CS-20
Revision	00

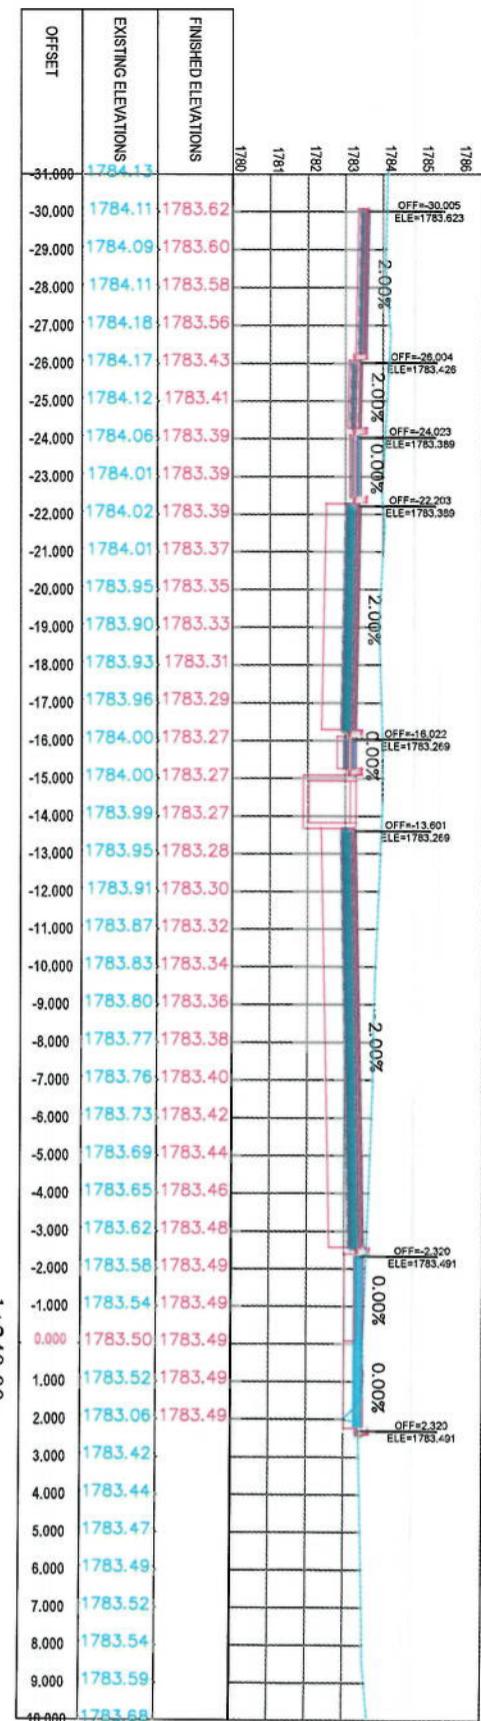


1+260.00

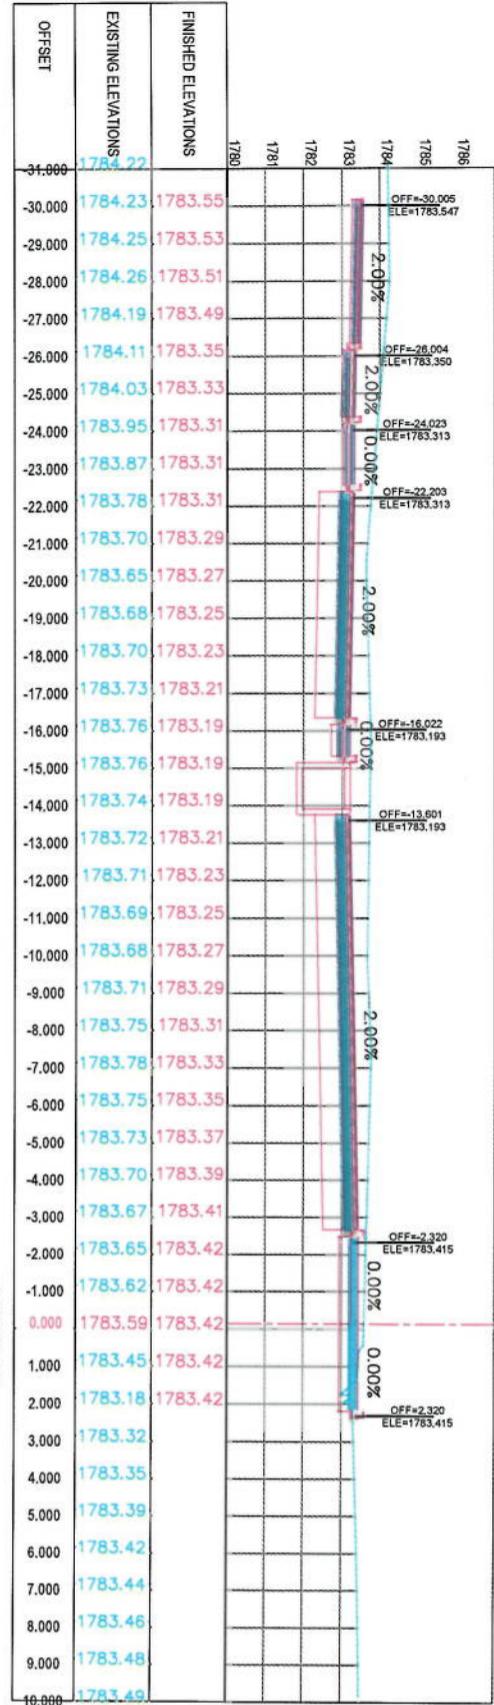

1+280.00

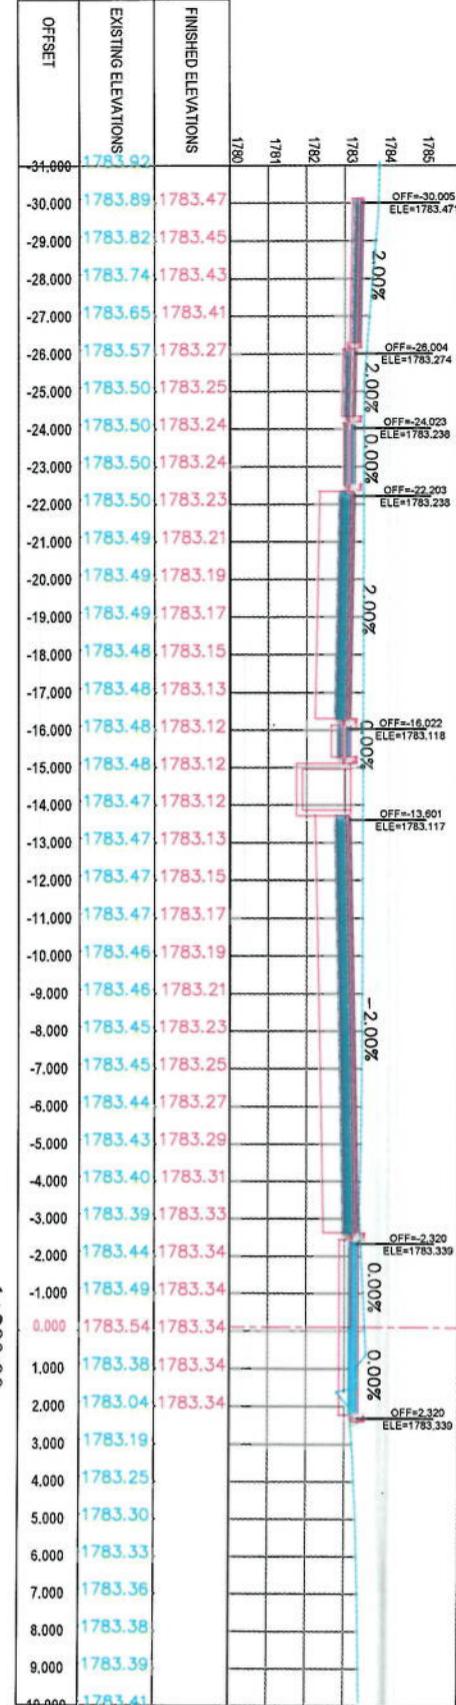

1+300.00

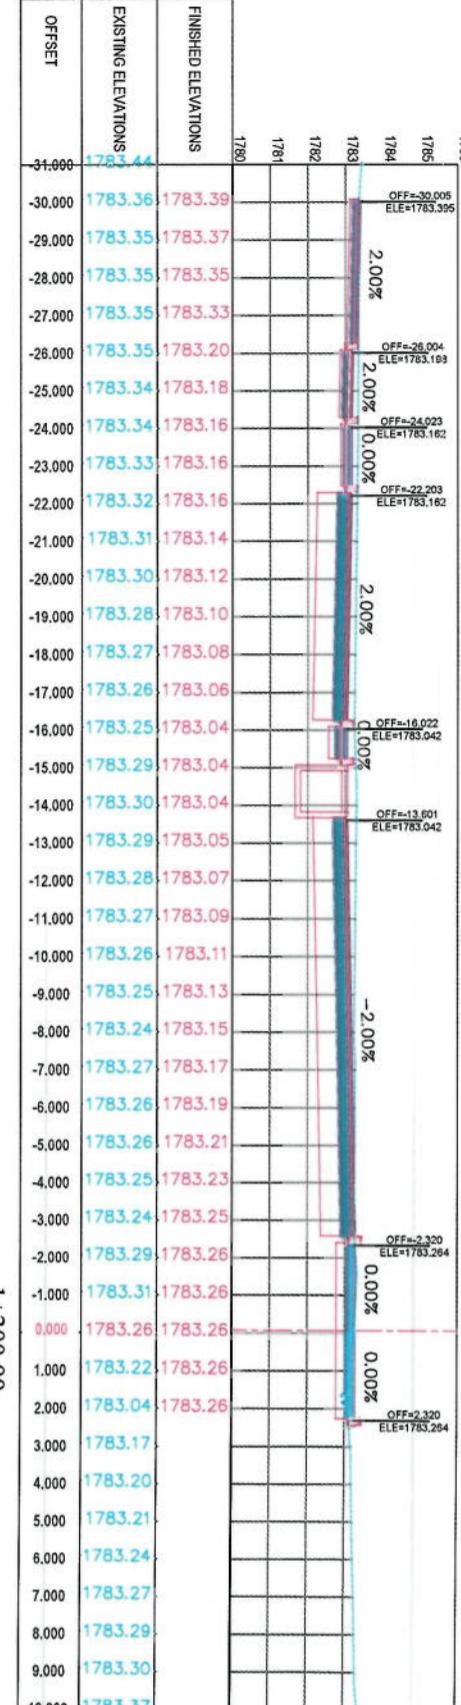

NOTE:
1. All dimensions are in meters unless otherwise indicated.

LEGENDS
— CENTER-LINE
- - - EXISTING SURFACE
— EXISTING SIDE DITCH





Drawing Number	CS-22
Revision	00

Date	6/7/2023
Scale	1:200

Status:	FINAL DESIGN
---------	--------------

Project Code:	
---------------	--

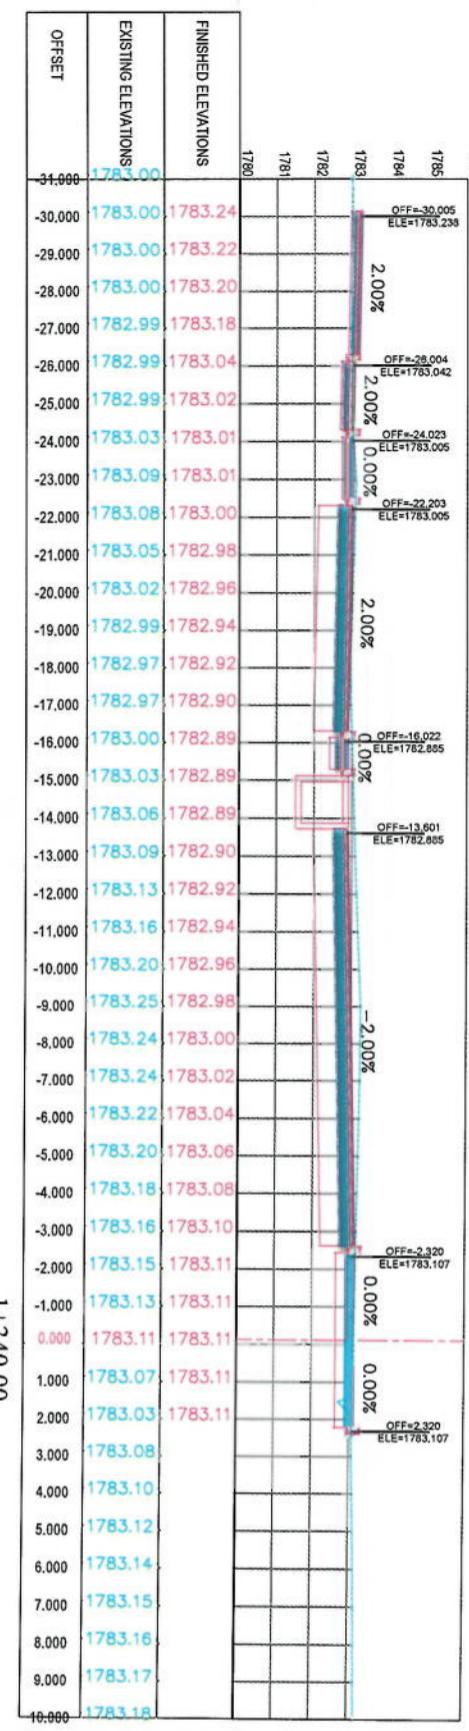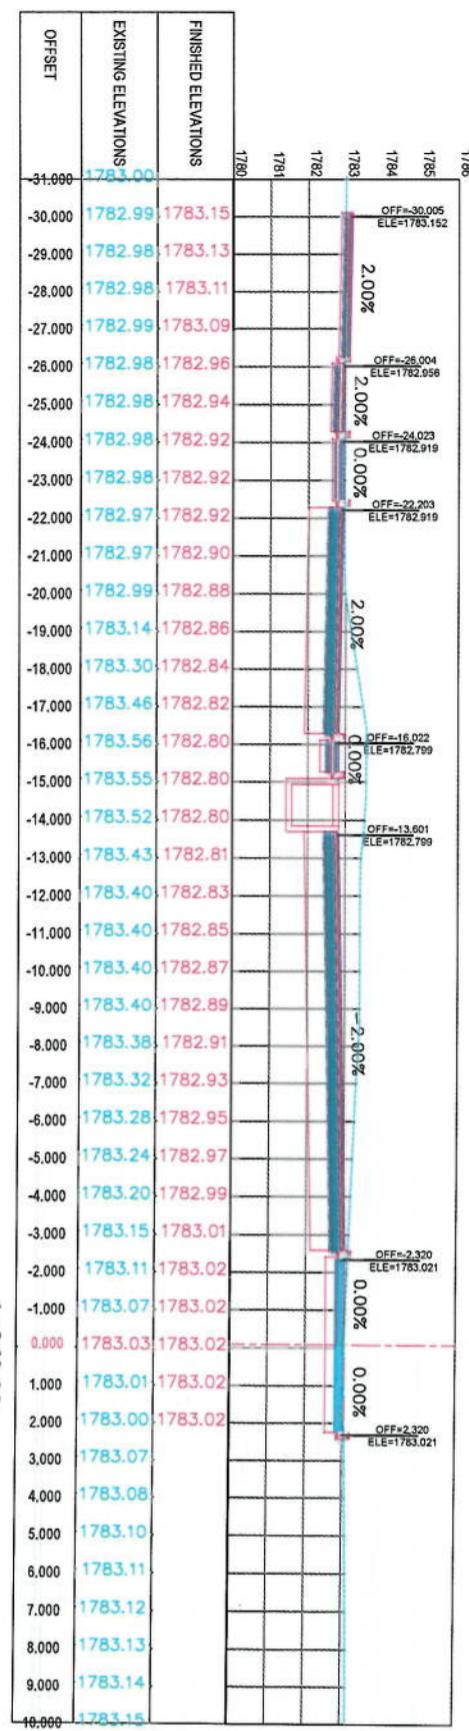

1+320.00

1+340.00



NOTE


1. All dimensions are in meters unless otherwise indicated.

LEGENDS


- CENTER-LINE**: Solid red line.
- EXISTING SURFACE**: Dashed blue line.
- EXISTING SIDE DITCH**: Blue line with a vertical segment.

Project Name:	KABUL MUNICIPALITY DESIGN TEAM		
Code-Sign To Remazang	Road project		
Checked by:	Hasanullah Shahzai		
Designed by:	Signature: Mohammad Esa Sint		
Drawn by:	Signature: Mohammad Esa Sint		
Date: 6/7/2023	Scale: 1:200		
Status: FINAL DESIGN			
Project Code: CS-23	Revision: 00		


1+380.00

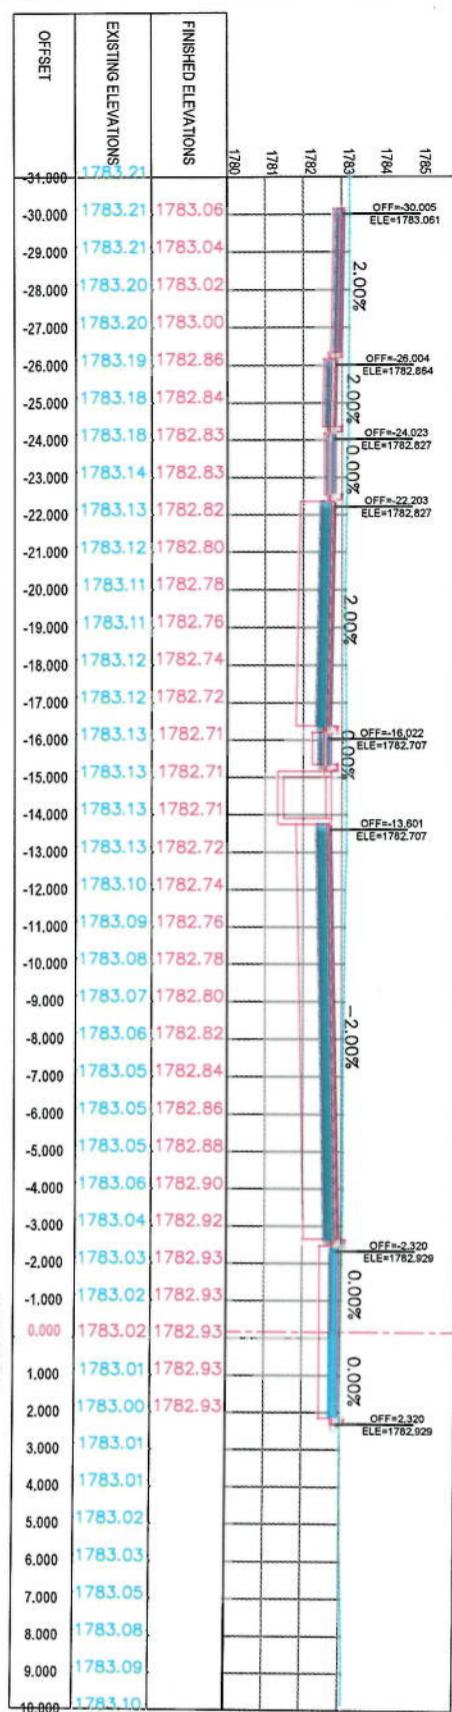

1+400.00

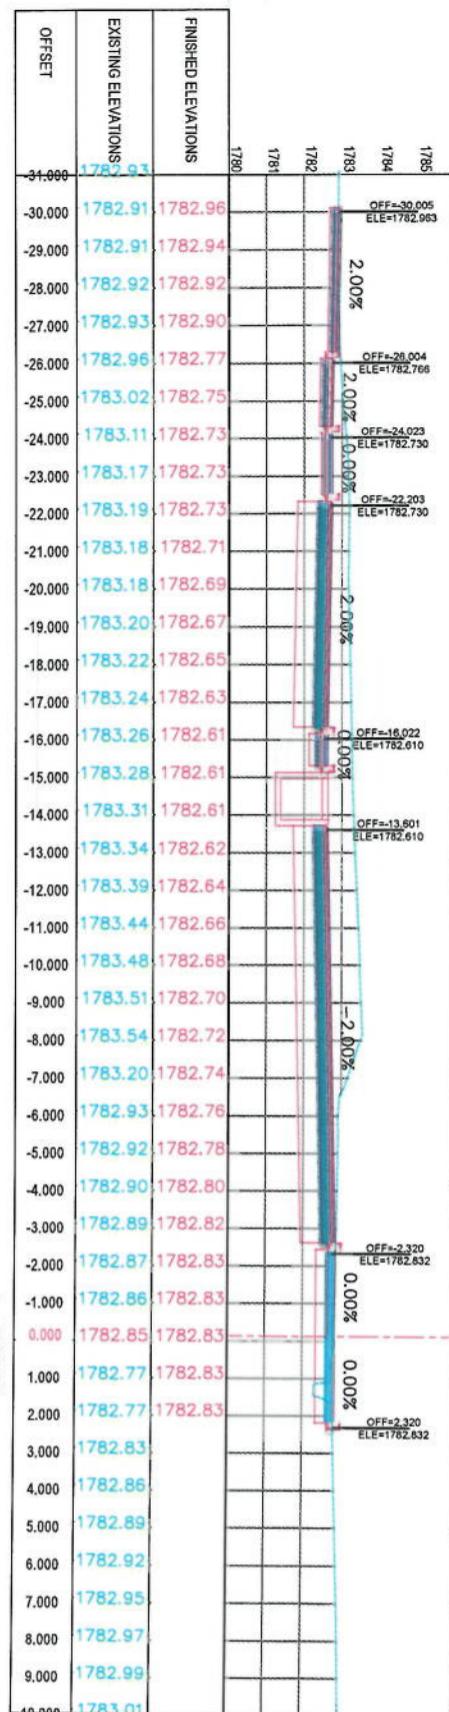

1+420.00

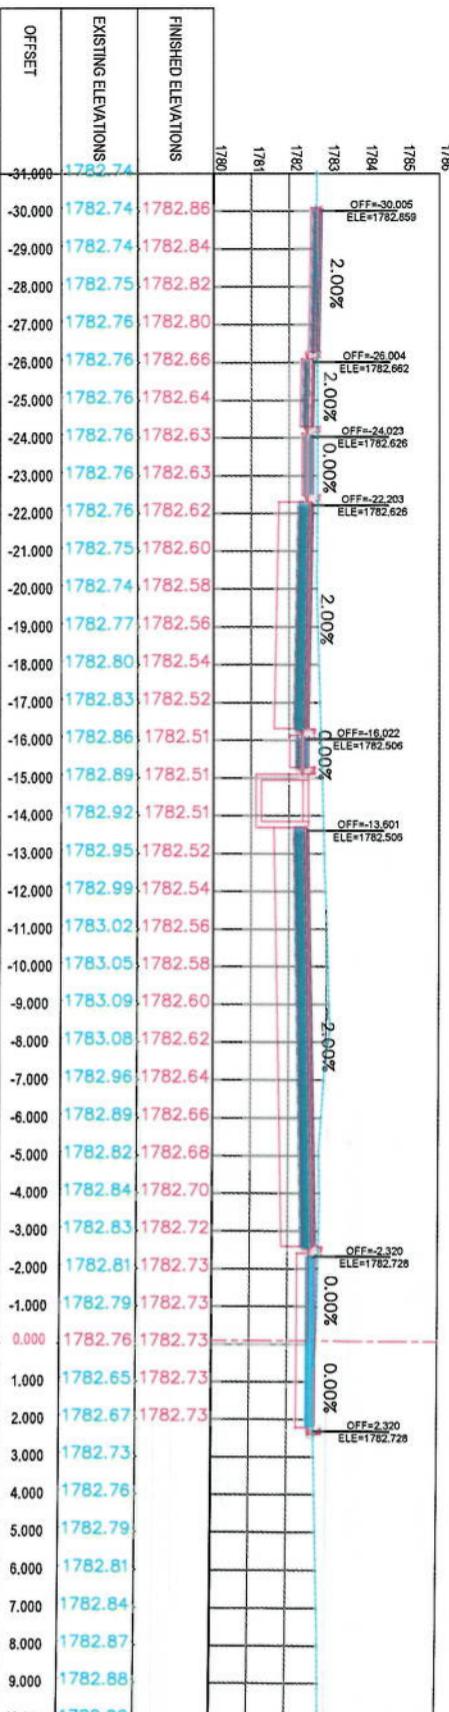

NOTE

1. All dimensions are in meters unless otherwise indicated



LEGENDS	
CENTER-LINE	
EXISTING SURFACE	
EXISTING SIDE DITCH	



Project Name:	KABUL MUNICIPALITY DESIGN TEAM
Code-Sign:	To Demazang Road Project
Drawing Title:	CROSS SECTIONS
Designed By:	Mohammad Esa Sharif
Drawn by:	Mohammad Esa Sharif
Checked by:	Habibullah Shabani
Date:	6/7/2023
Scale:	1:200
Status:	FINAL DESIGN
Project Code:	CS-24
Drawing Number:	00
Revision:	

NOTE:

1. All dimensions are in meters unless otherwise indicated.

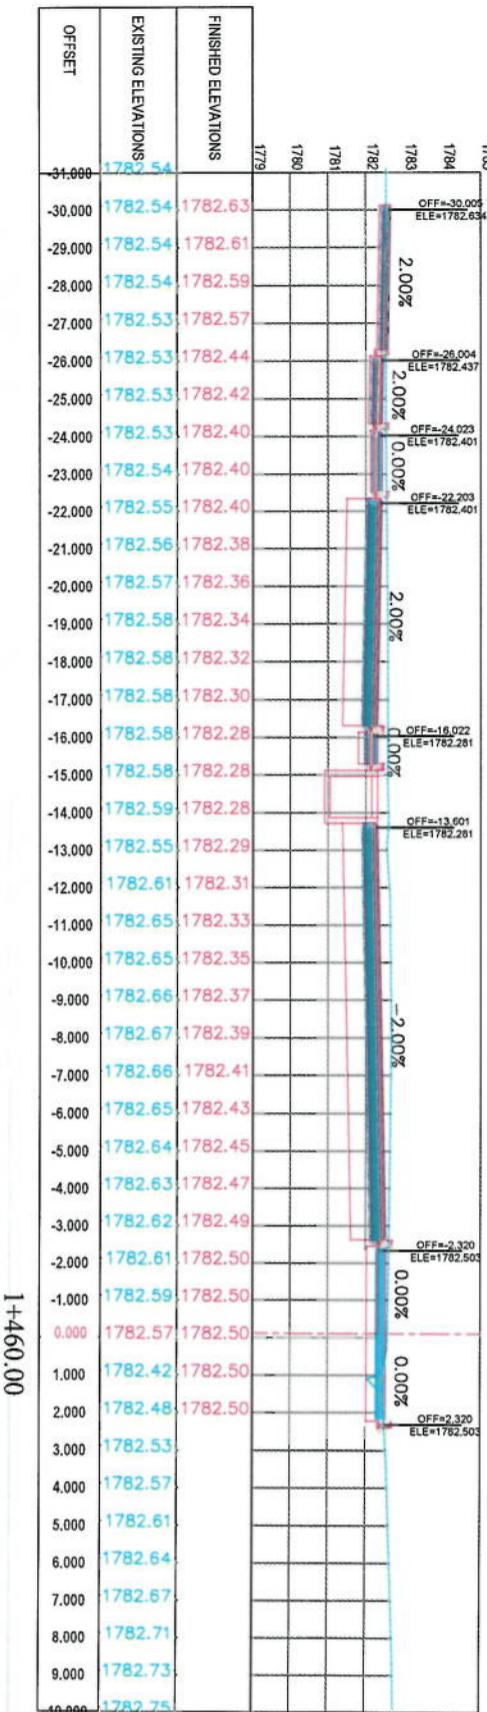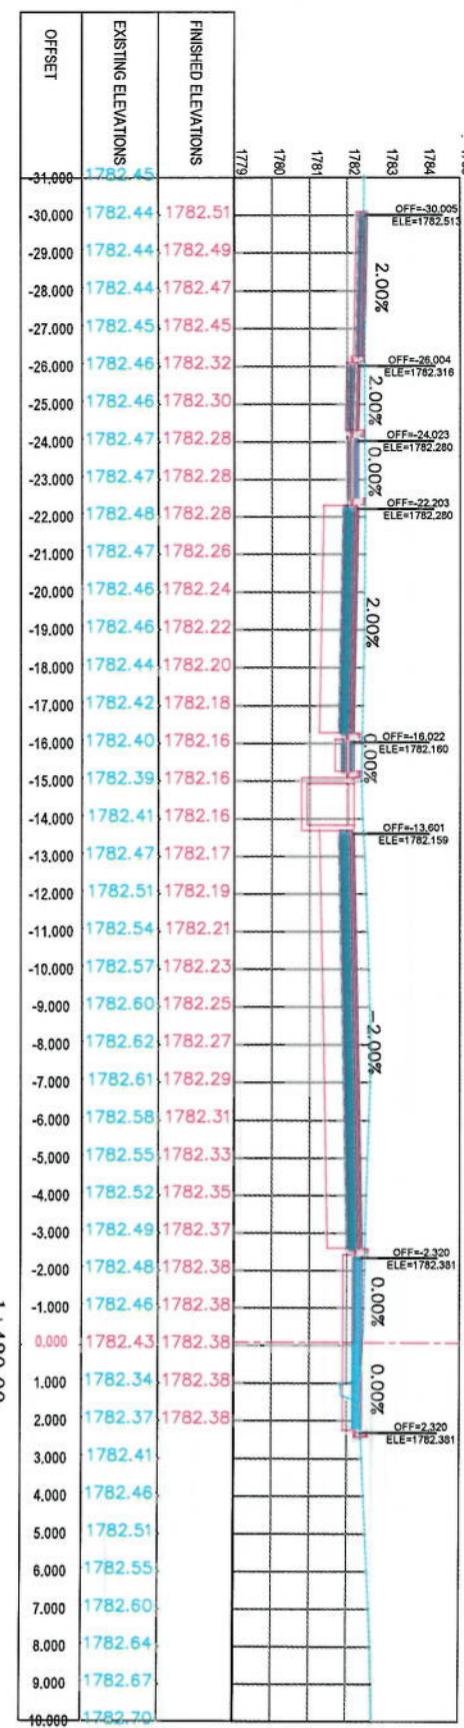LEGENDS**CENTER-LINE****EXISTING SURFACE****EXISTING SIDE DITCH**

I+460.00




1+440.00

CROSS SECTIONS

Project Name	KABUL MUNICIPALITY DESIGN TEAM	
Drawing Title	Cross-Section To Demazang Road project	
Designed by:	Mohammad Easa Sial	Signature:
Drawn by:	Nominees Easa Sial	Signature:
Checked by:	Habibullah Sialzai	Signature:
Date:	6/7/2023	Scale:
Status:	FINAL DESIGN	
Project Code:	CS-25	Revision: 00



1+500.00

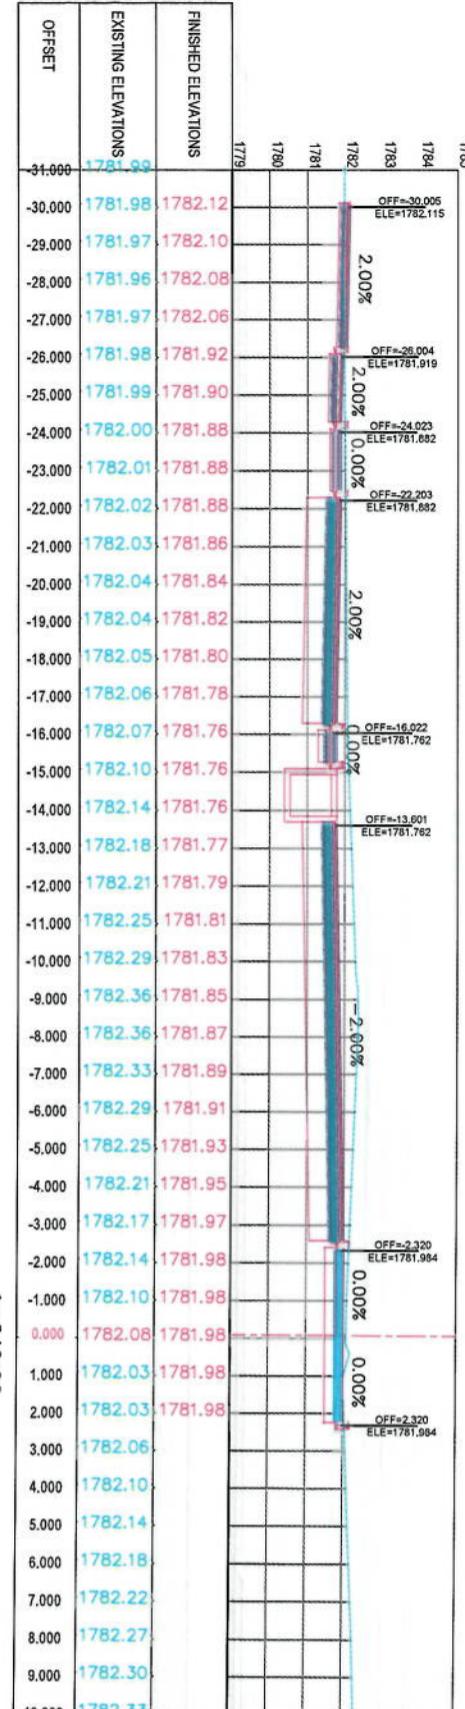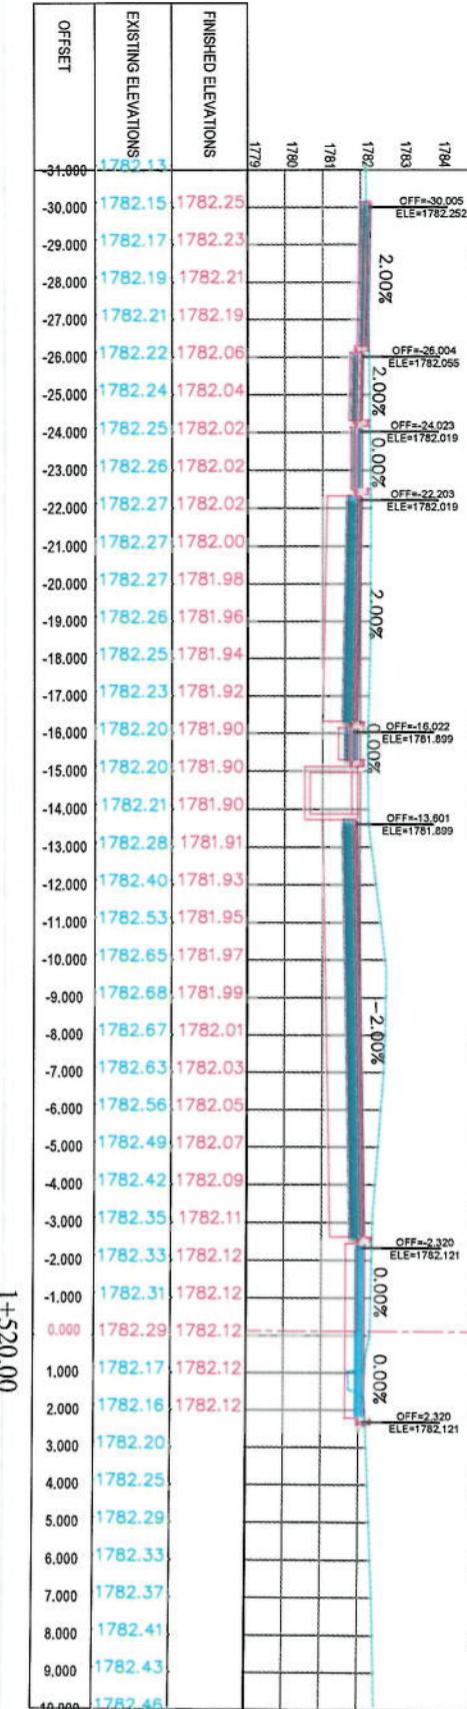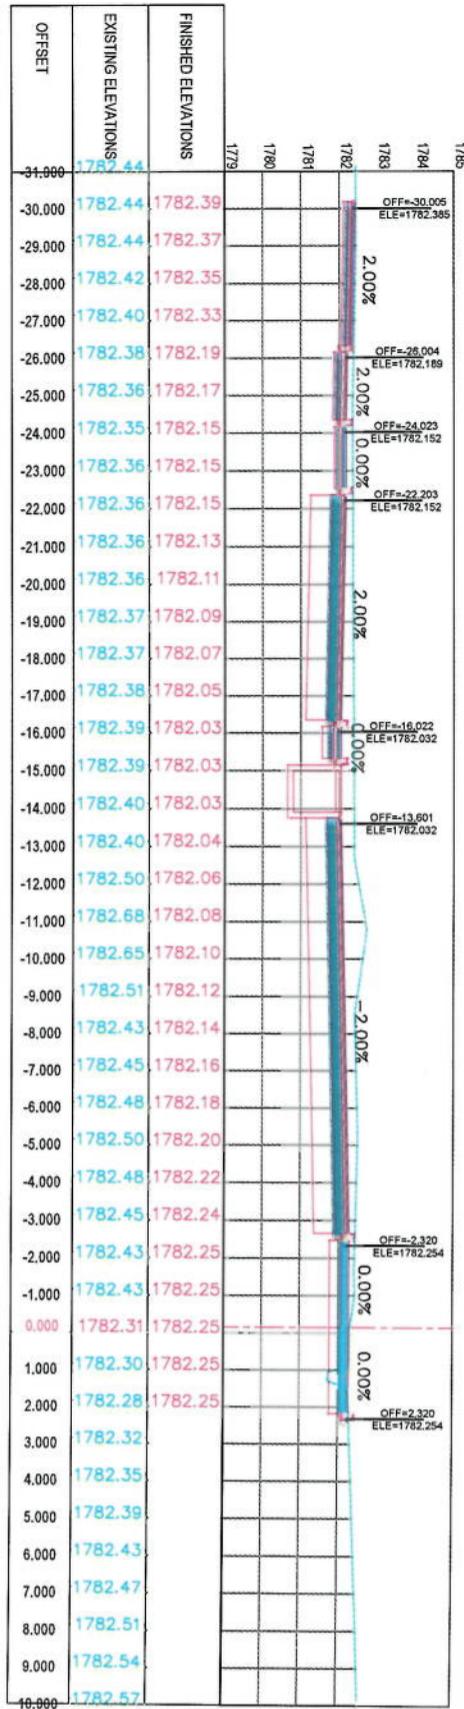


NOTE:

1. All dimensions are in metres unless otherwise indicated.

LEGENDS		
—	—	CENTER-LINE
---	---	EXISTING SURFACE
—	—	EXISTING SIDE DITCH



Project Name:	KABUL MUNICIPALITY DESIGN TEAM	
Design by:	KABUL MUNICIPALITY	
Date:	6/7/2023	
Signature:		
Checked by:	Habibullah Shamsi	
Date:	6/7/2023	
Signature:		
Driver by:	Mohammad Eisa Sint	
Signature:		
Reviewed by:	Mohammad Eisa Sint	
Signature:		
Status:	FINAL DESIGN	
Project Code:	CS-26	
Drawing Number:	00	
Revision:		

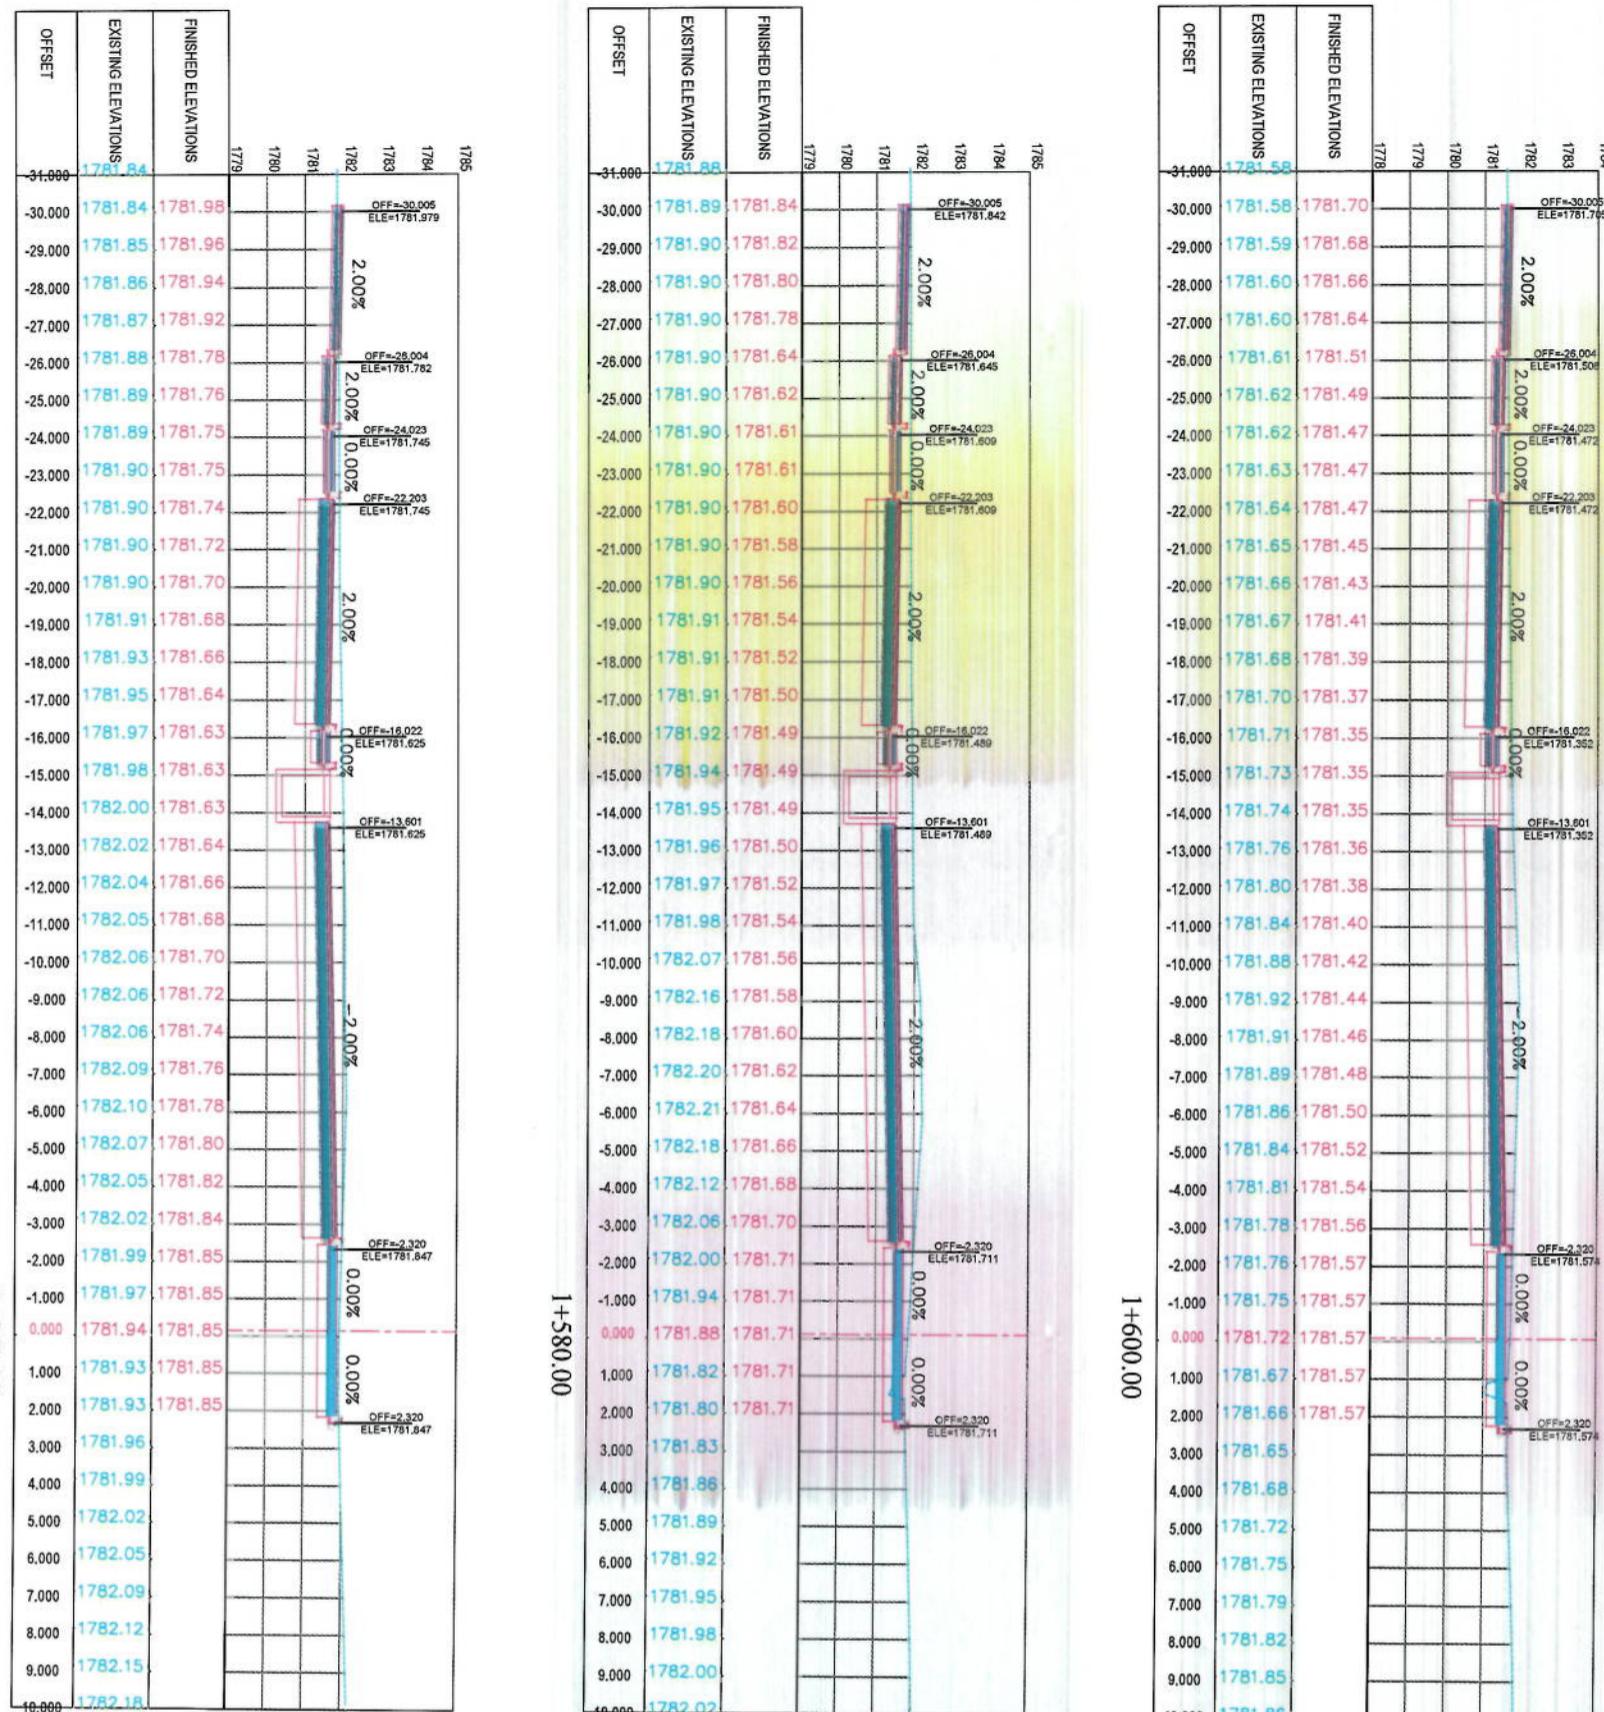


NOTE:

1. All dimensions are in meters unless otherwise indicated.


LEGENDS
CENTER-LINE
EXISTING SURFACE
EXISTING SIDE DITCH



Project Code	CS-27	Revision	00
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1+660.00

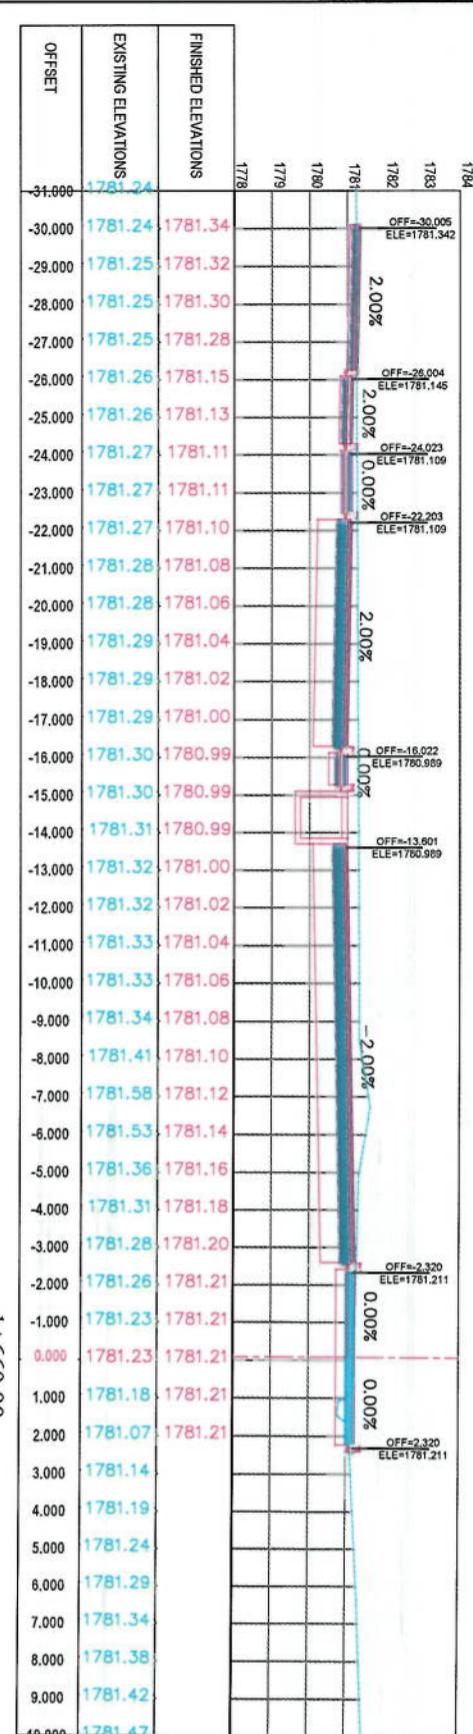




1+640.00

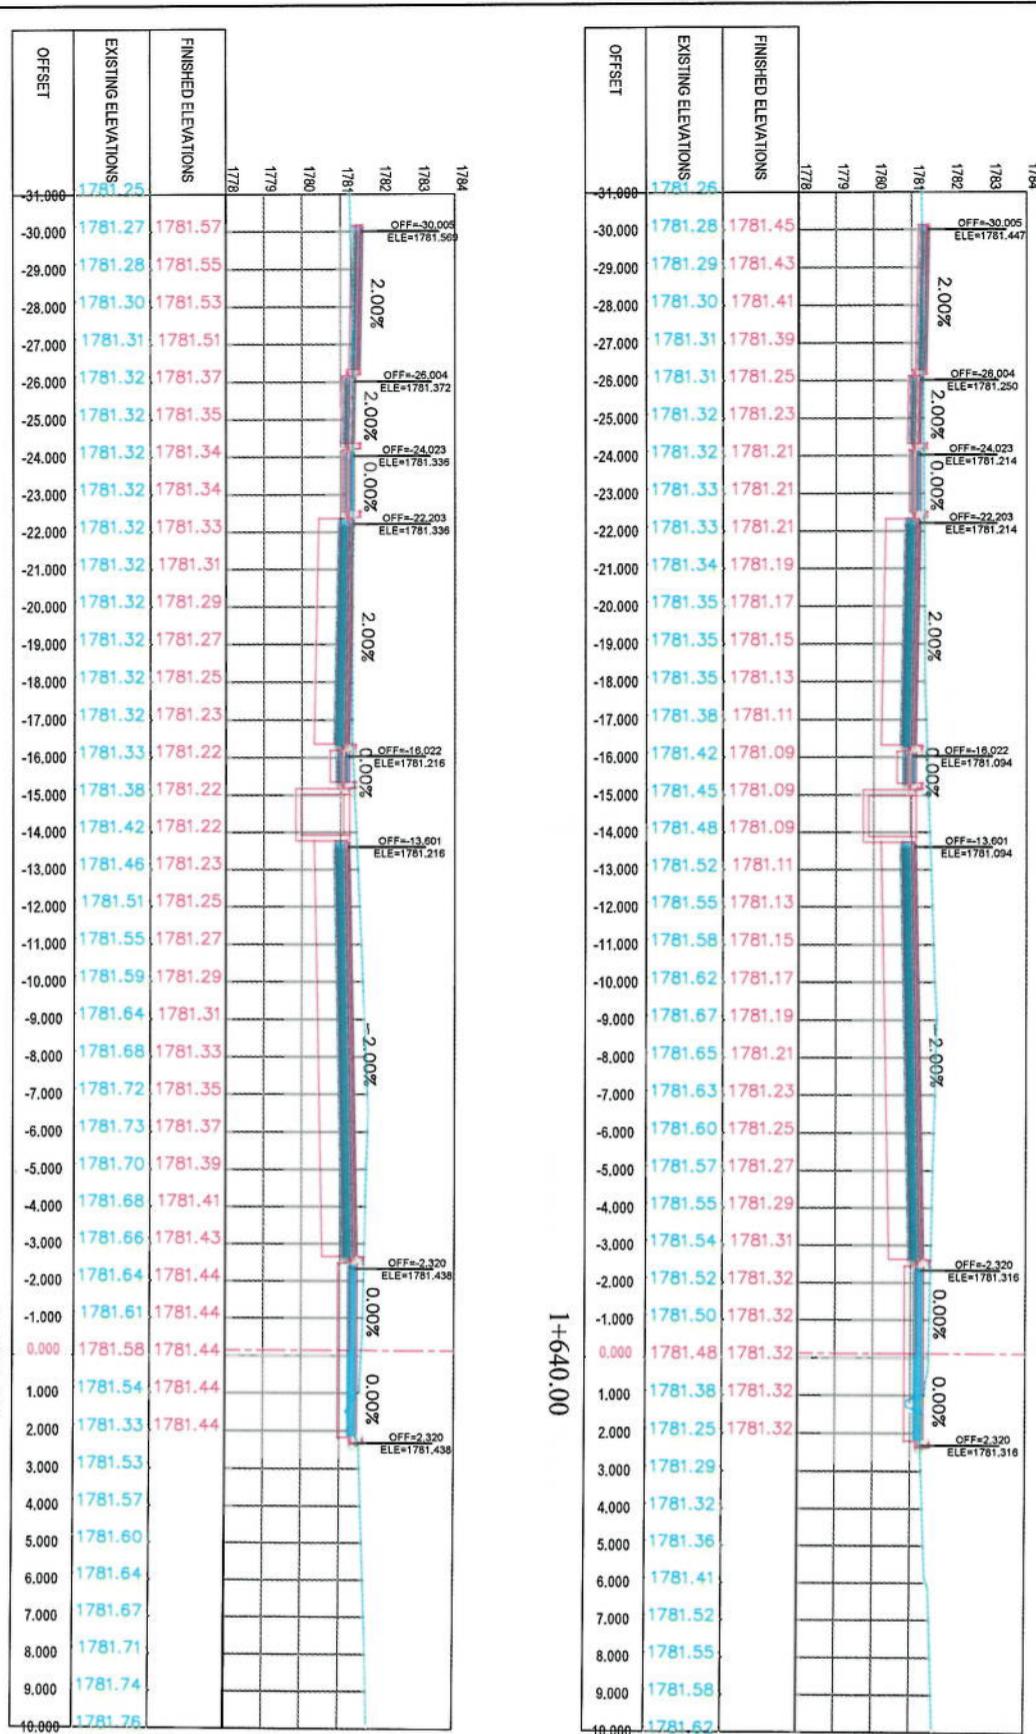NOTE:
1. All dimensions are in meters unless otherwise indicated.

LEGENDS
— CENTER-LINE
--- EXISTING SURFACE
— EXISTING SIDE DITCH



Project Name:	KABUL MUNICIPALITY DESIGN TEAM
Code-Sang To Demazang	Road Project
Drawing Title:	CROSS SECTIONS
Designed by:	Mohammad Eesa Sial
Signature:	
Drawn by:	Mohammad Eesa Sial
Signature:	
Checked by:	Husnullah Shams
Signature:	
Date:	6/7/2023
Scale:	1:200
Status:	FINAL DESIGN
Drawing Number:	CS-28
Revision:	00

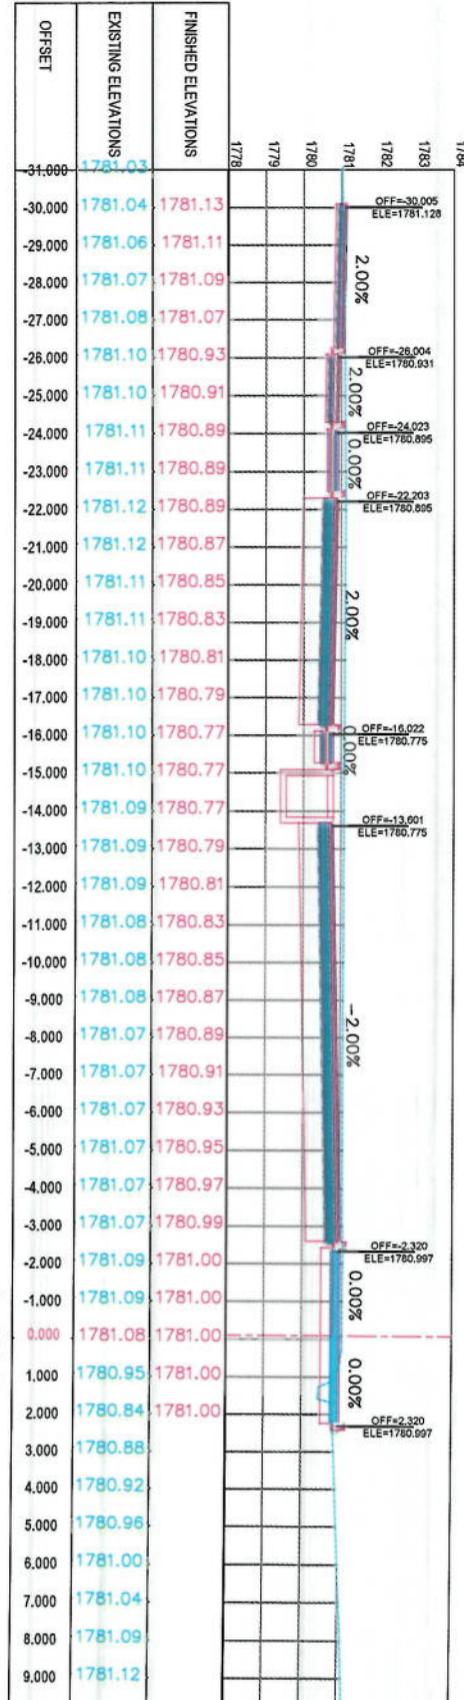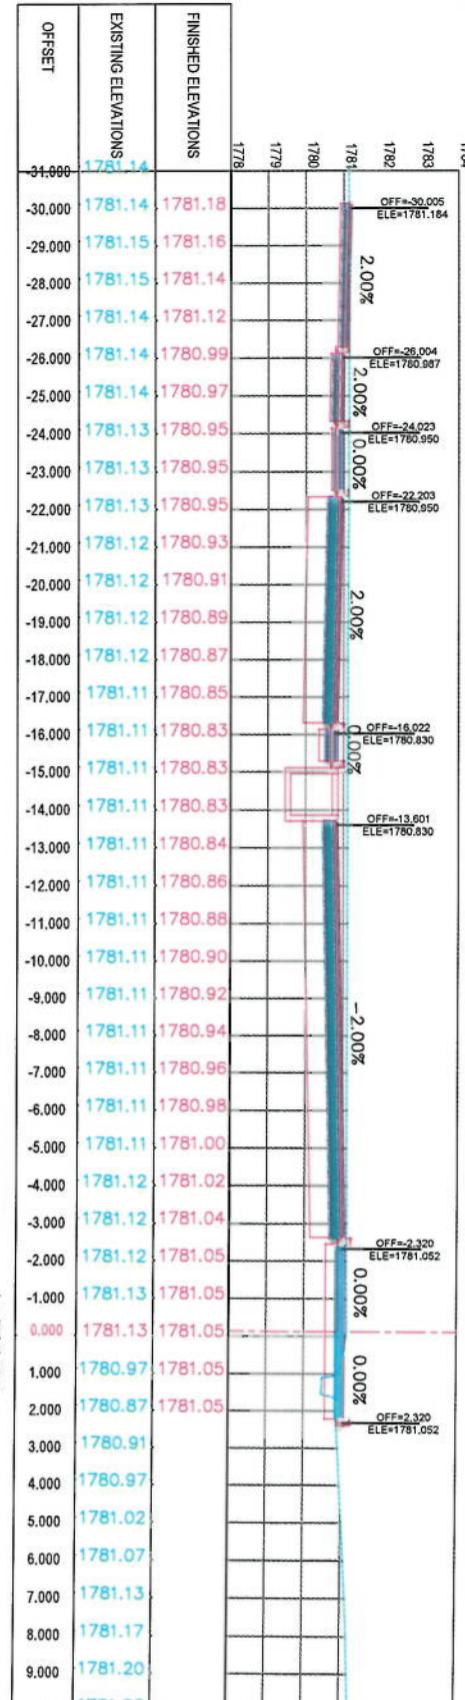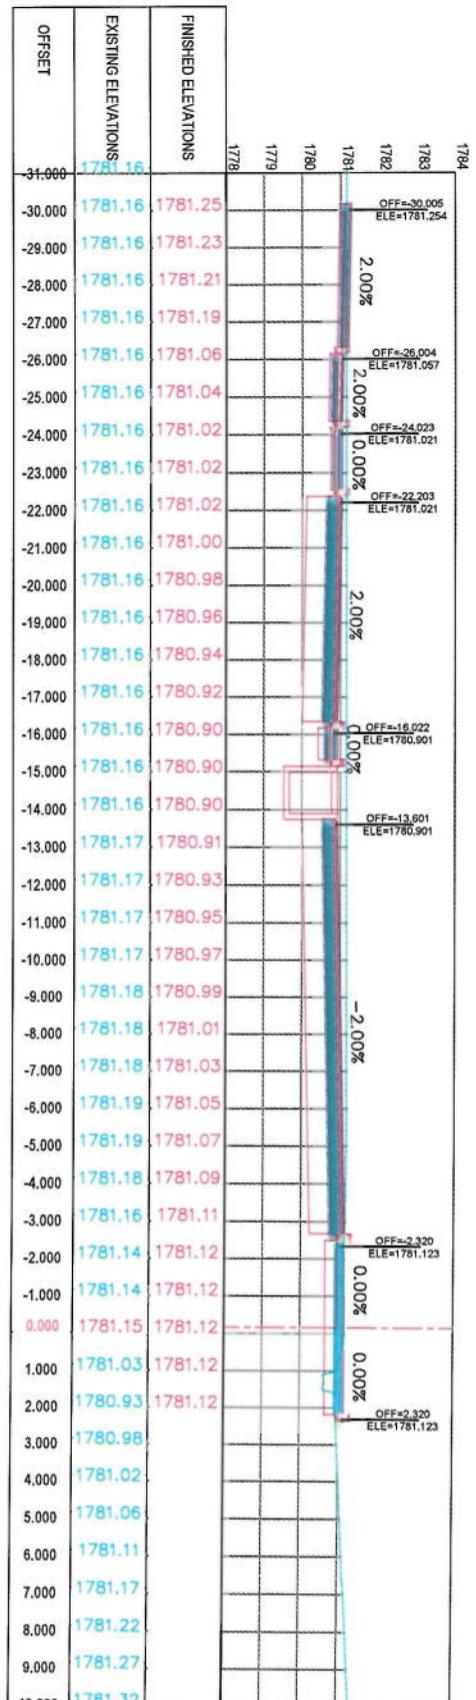

1+700.00

1+720.0C


1+680.00

KARUL MUNICIPALITY
DESIGN TEAM

AFGHANISTAN
KABUL MUNICIPALITY

A circular blue ink stamp. The outer ring contains the text "NATIONAL LIBRARY" at the top and "ISLAMABAD" at the bottom, both in English. The inner circle contains the same text in Urdu: "کتب خانہ ملی اسلام آباد".

NOTE

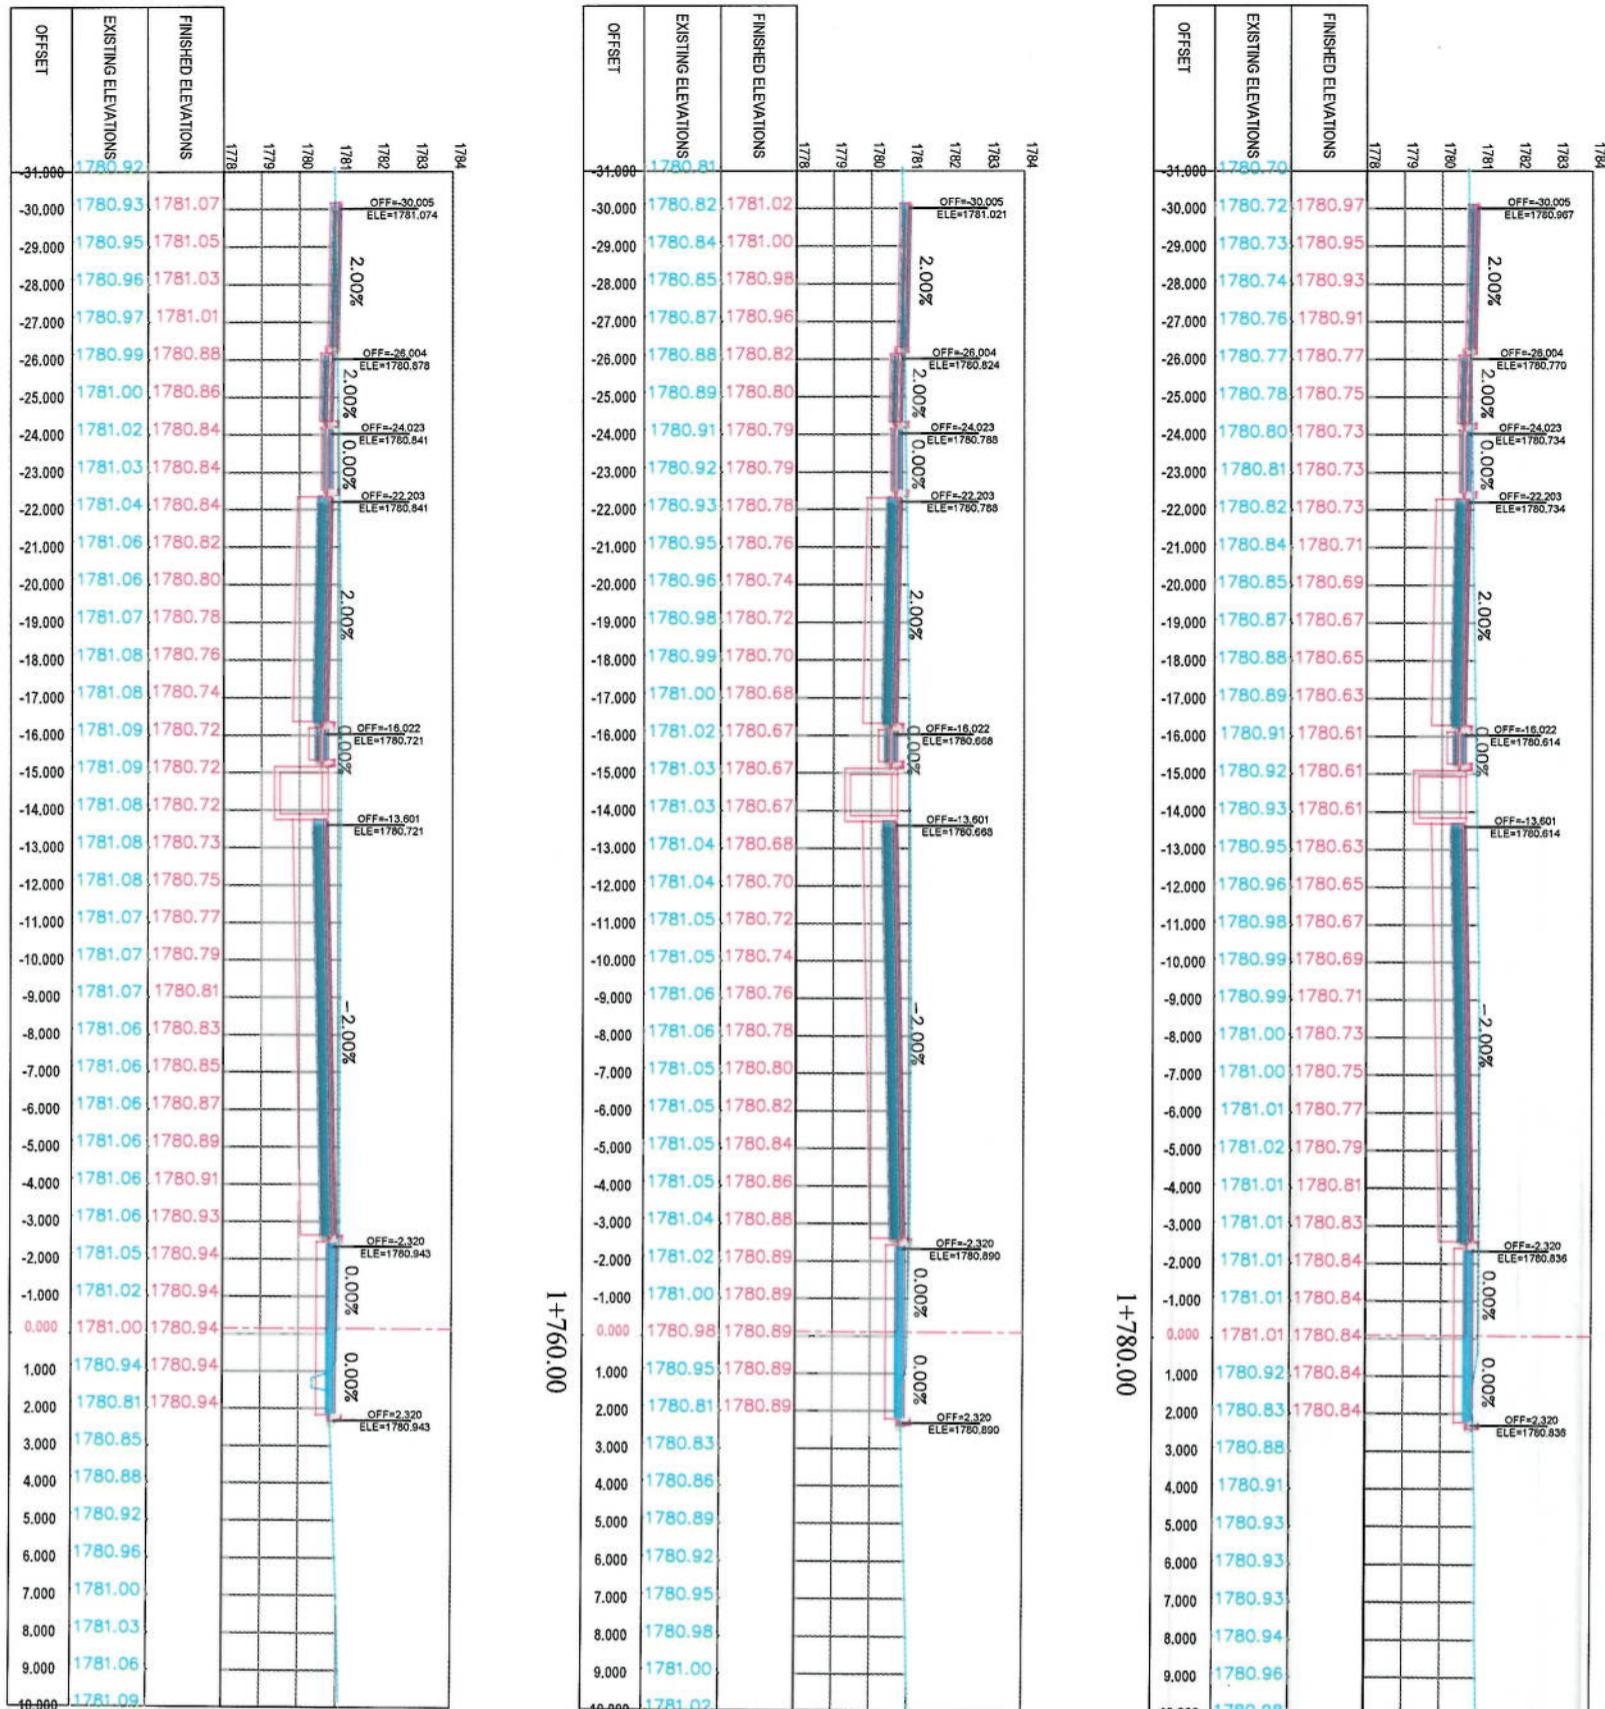

1+740.00

1+760.00






CROSS SECTIONS	
Designed by:	Mohammad Essa Sura
Drawn by:	Mohammad Essa Sura
Checked by:	Hasanullah Shahzai
Date:	6/7/2023
Scale:	1:200
Status:	FINAL DESIGN
Project Code:	
Drawing Number	CS-30
Revision	00

NOTE

1. All dimensions in meters unless otherwise indicated.

LEGENDS


- CENTER-LINE
- EXISTING SURFACE
- EXISTING SIDE DITCH

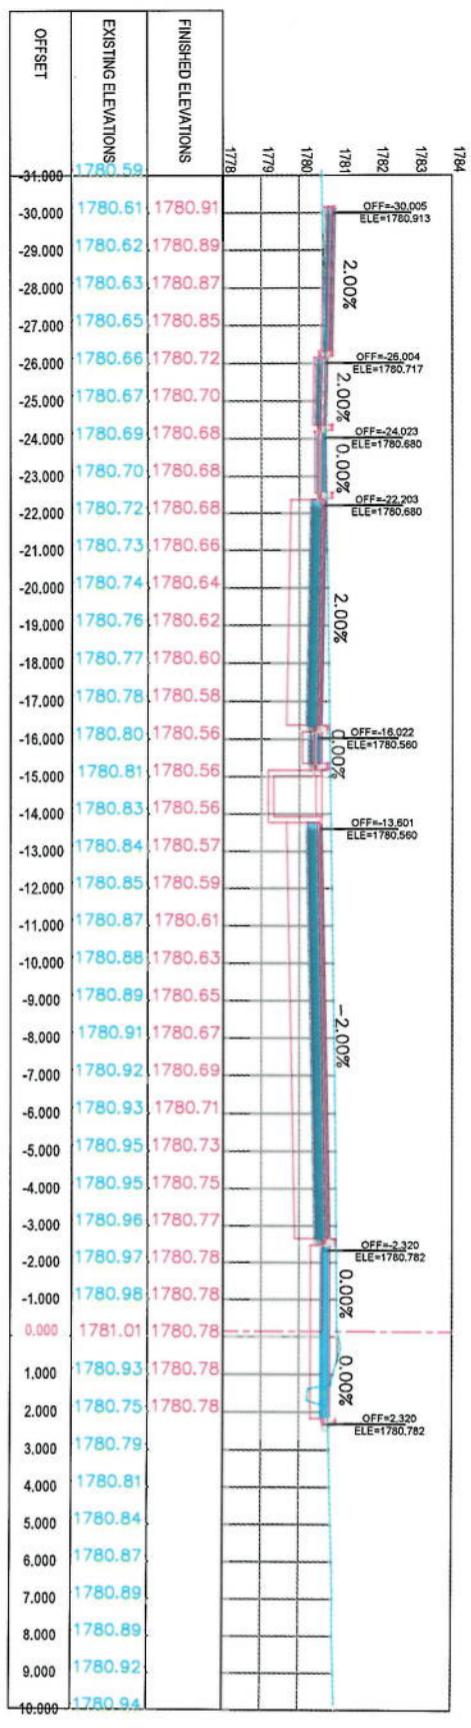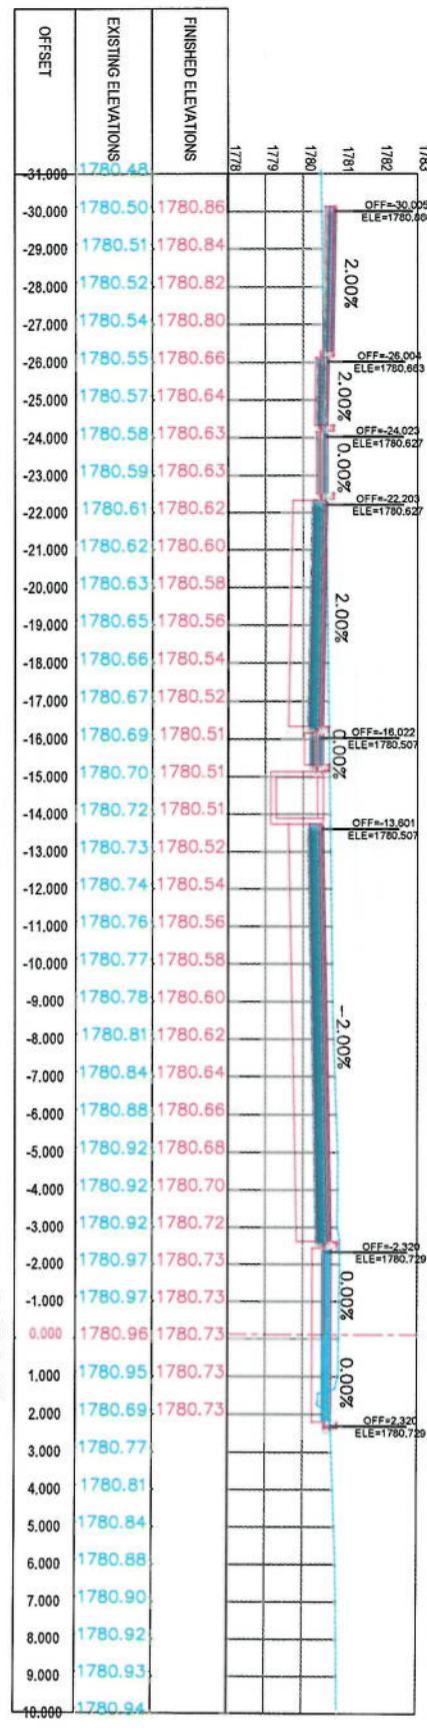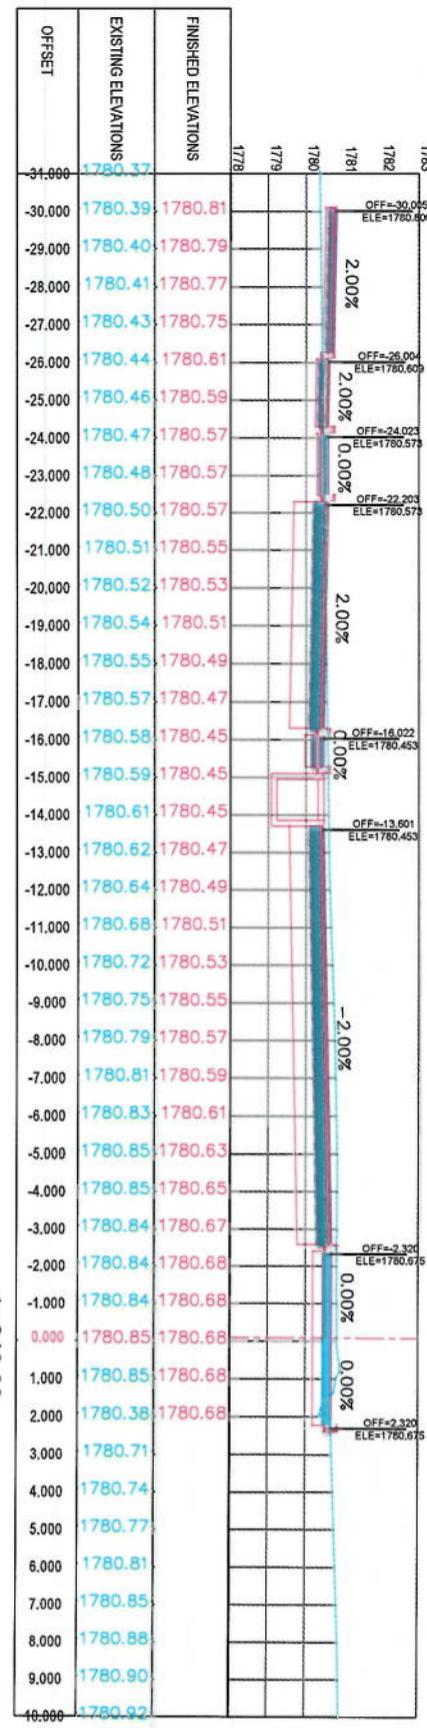


1+800.00

1+820.00




Project Name:	KABUL MUNICIPALITY DESIGN TEAM	
Designed by:	Colle-Sauve To Demazang	
Drawing Title:	CROSS SECTIONS	
Designed by:	Mohammad Fiaz Sial Signature:	
Drew by:	Mohammad Fiaz Sial Signature:	
Checked by:	Hasibullah Sialzai Signature:	
Date:	6/7/2023	
Scale:	1:200	
Status:	FINAL DESIGN	
Project Code:	CS-31	
Drawing Number:	00	
Revision:		

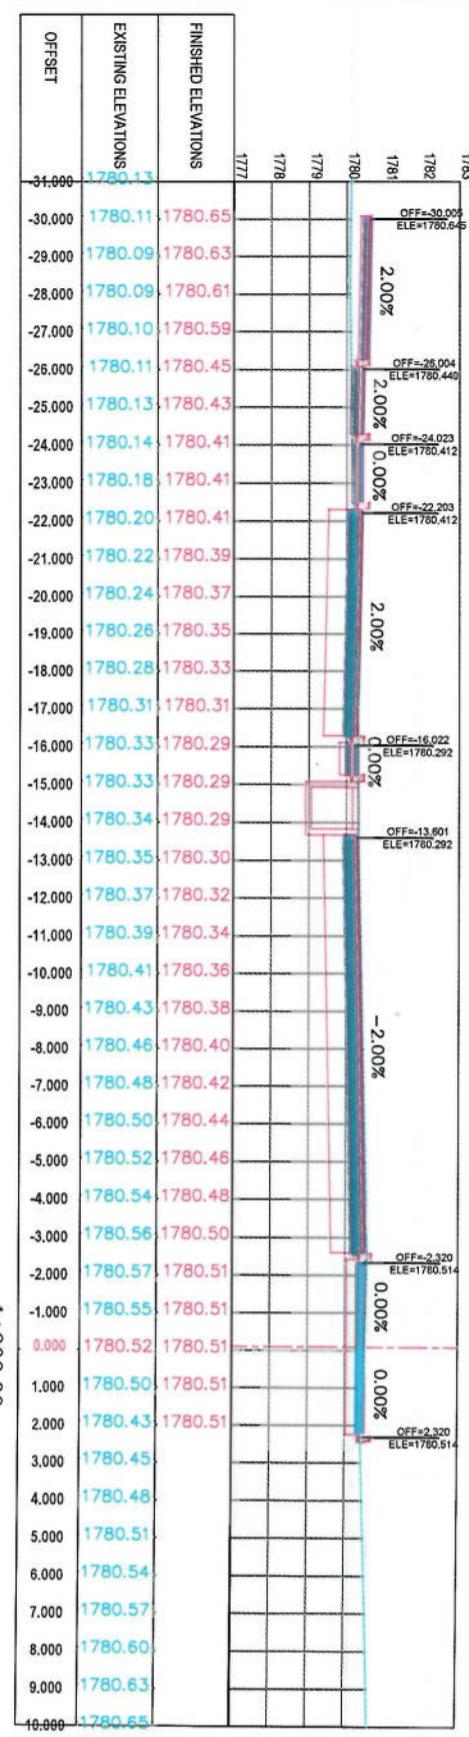


1+900.00

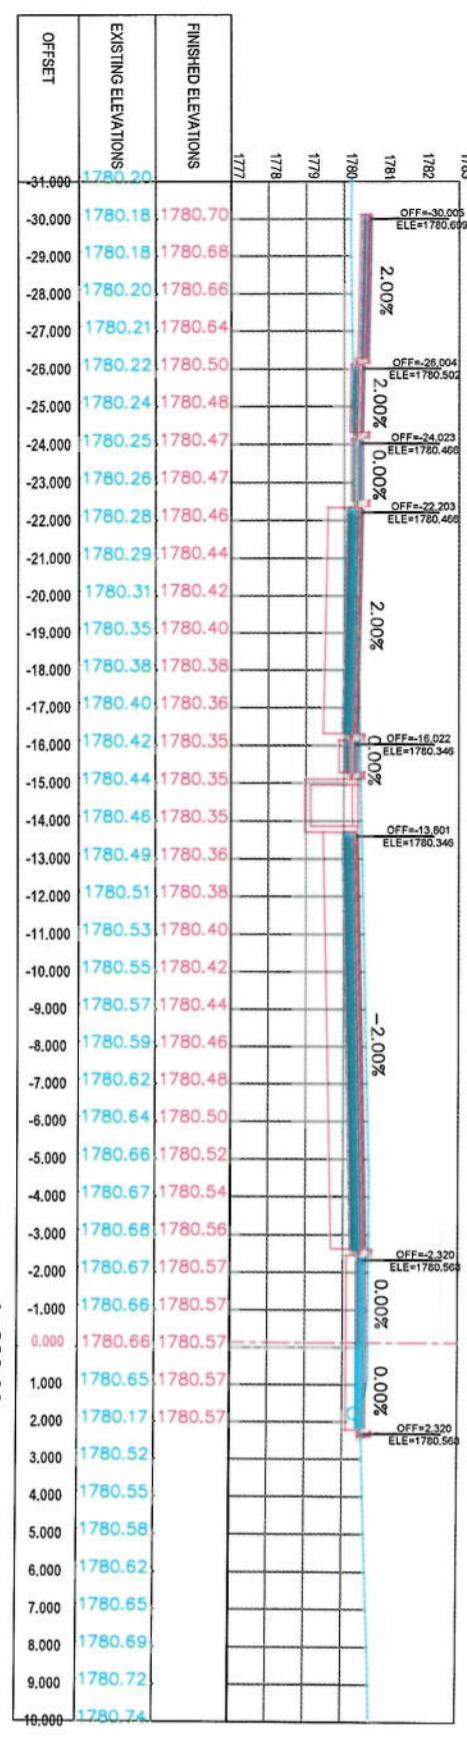


1+860.00

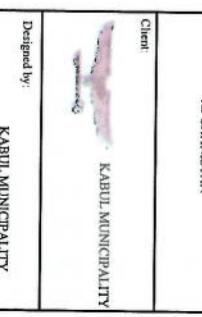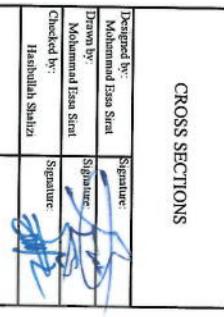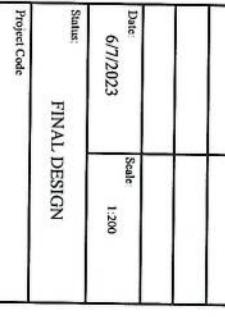Project Name:	KABUL MUNICIPALITY DESIGN TEAM	
Designed by:		
Drawing Title:	CROSS SECTIONS	
Code-Sign To Demanding	Road Object	
Checked by:		
Drawn by:		
Date:	6/7/2023	State:
Status:	FINAL DESIGN	
Project Code:	CS-32	Revision: 00

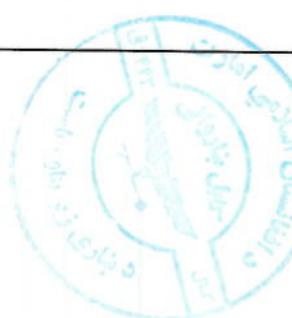


LEGENDS
— CENTER-LINE
--- EXISTING SURFACE
— EXISTING SIDE DITCH


NOTE:
1. All dimensions are in meters unless otherwise indicated

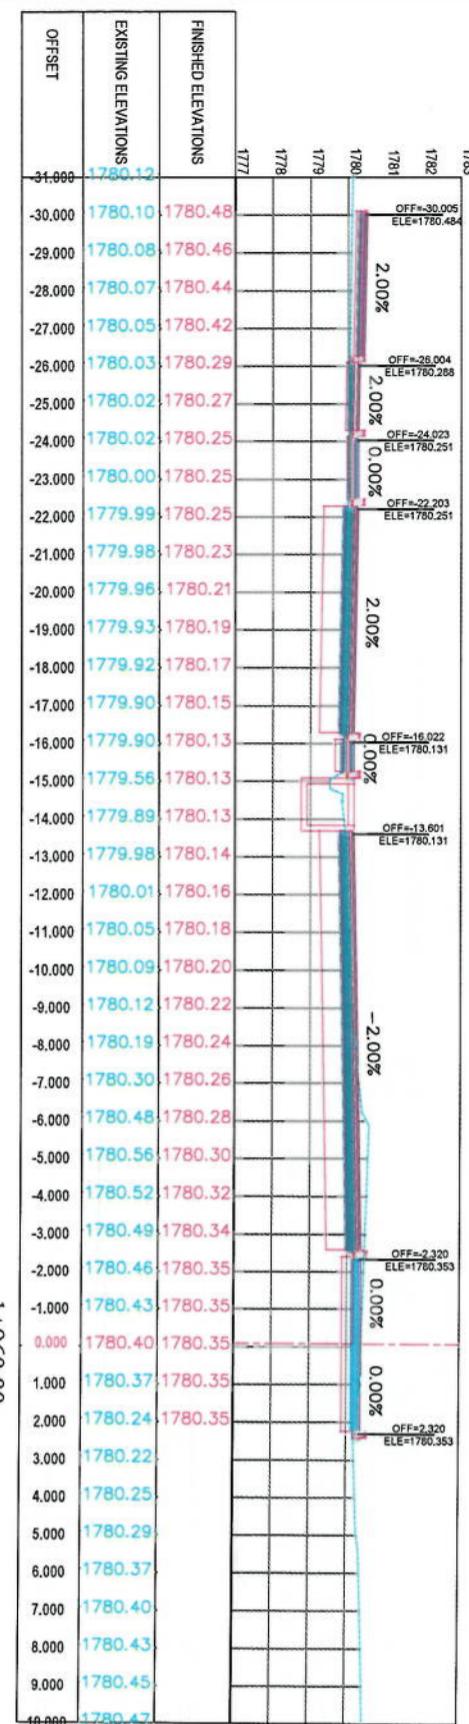

1+960.00

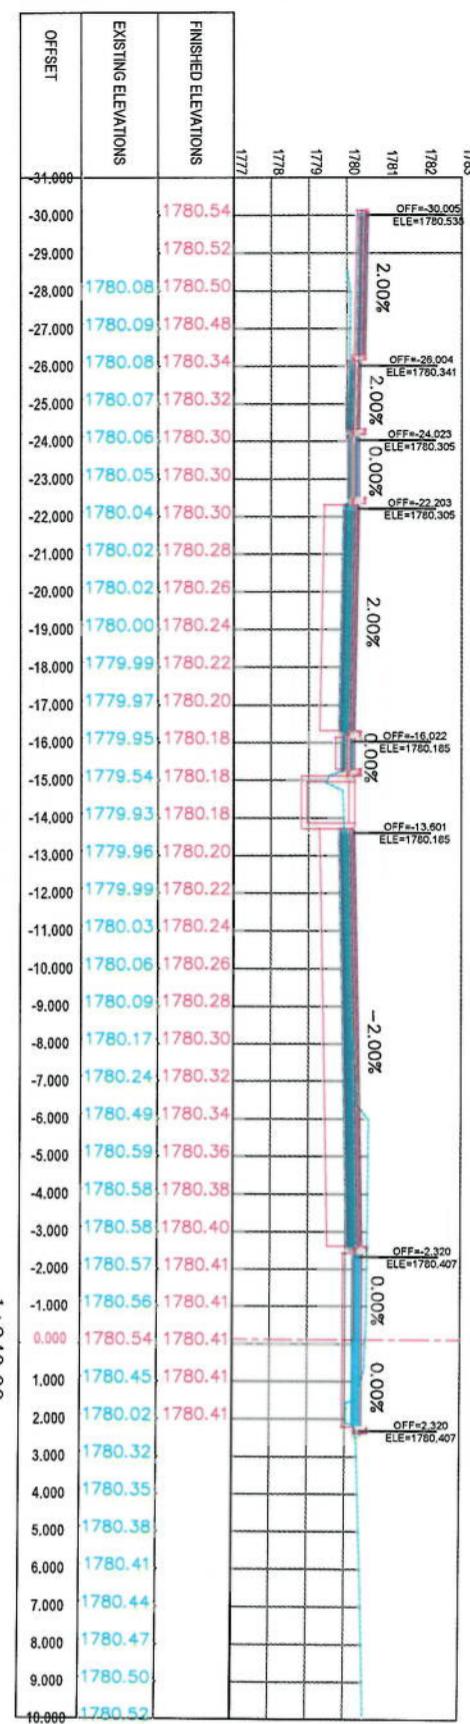

1+940.00

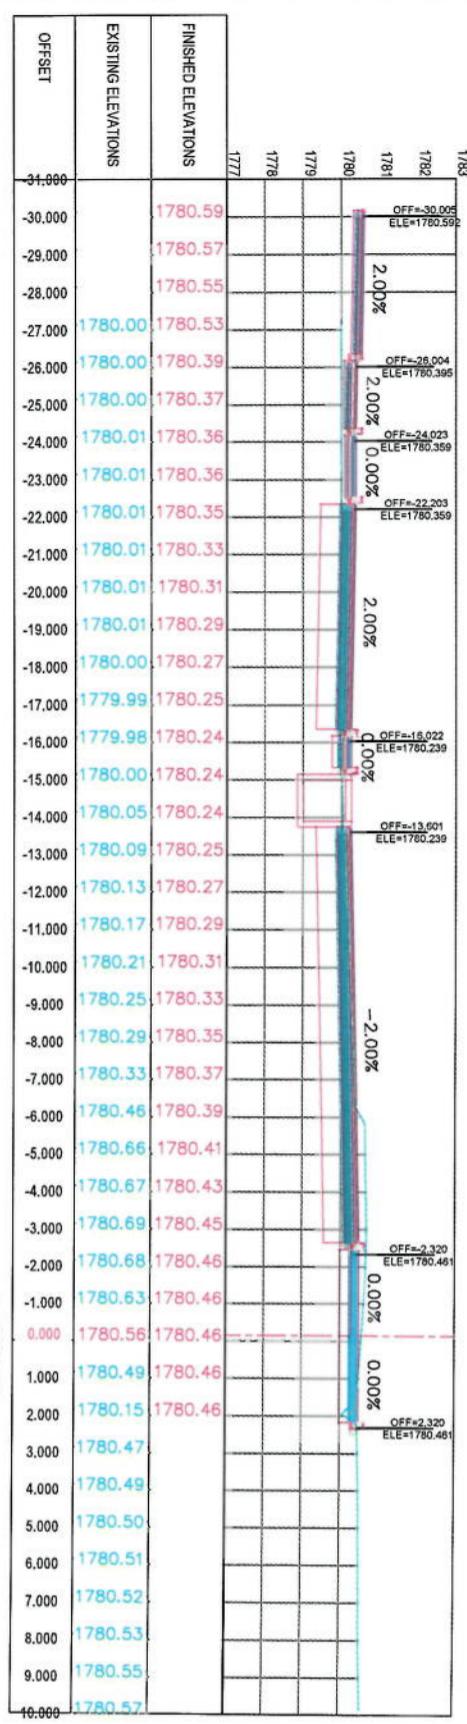

1+920.00

NOTE:


- All dimensions are in meters unless otherwise indicated.

LEGENDS		
CENTER-LINE	EXISTING SURFACE	EXISTING SIDE-DITCH




Project Name:	KABUL MUNICIPALITY DESIGN TEAM	
Designing Title:	CROSS SECTIONS	
Designed by:		
Drawn by:		
Checked by:		
Date:	6/7/2023	
Scale:	1:200	
Status:	FINAL DESIGN	
Project Code:	CS-33	Revision 00


1+980.00

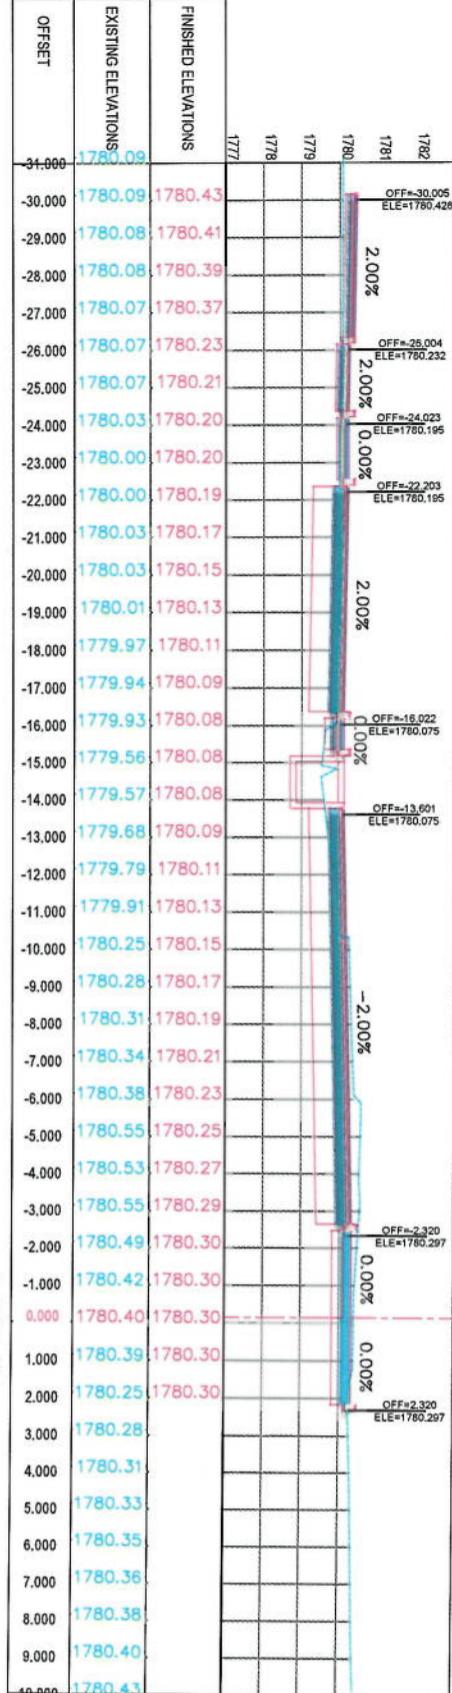

2+000.00

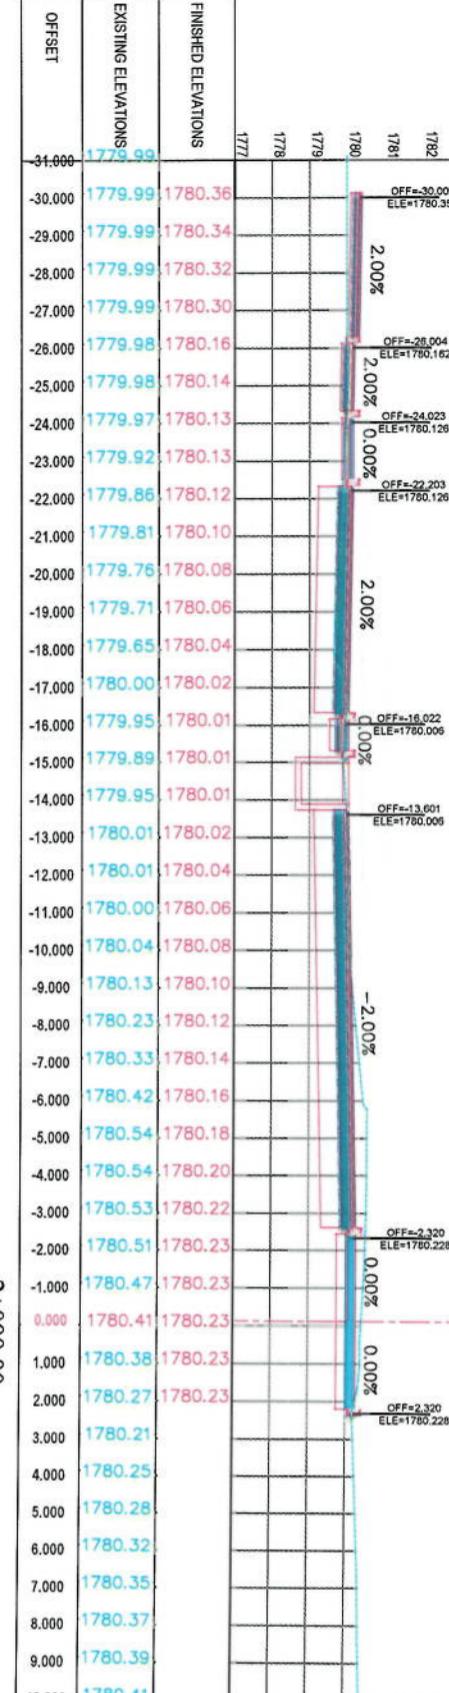


2+020.00

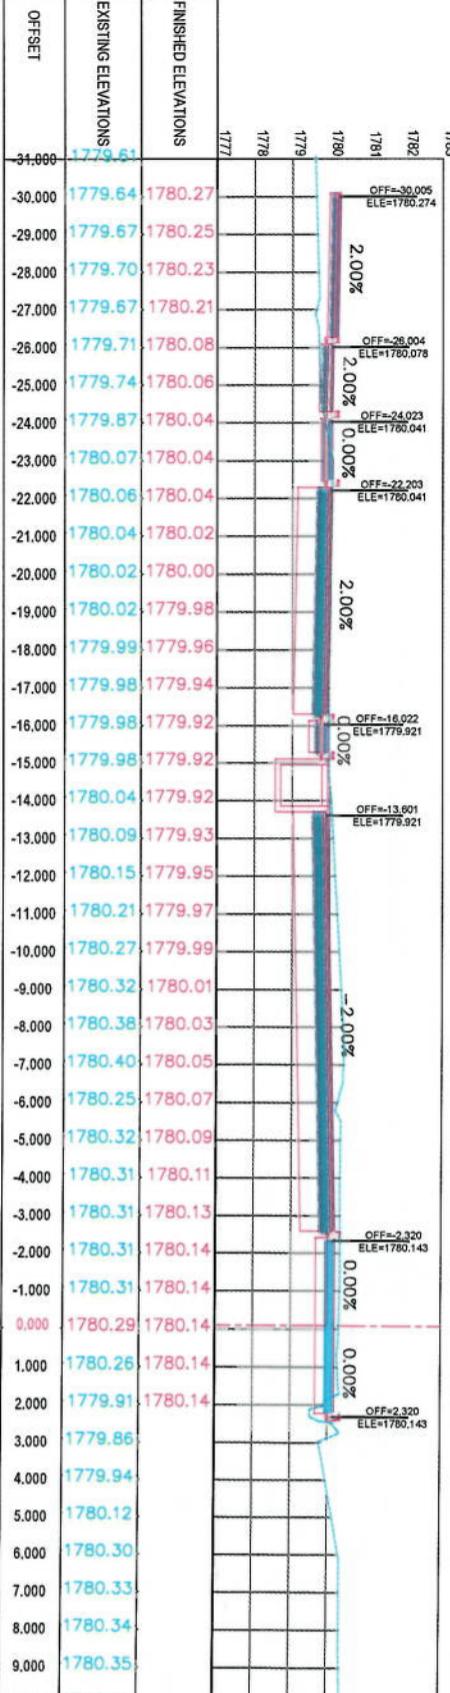


NOTE:

- All dimensions are in meters unless otherwise indicated


LEGENDS
 CENTER-LINE
 EXISTING SURFACE
 EXISTING SIDE DITCH

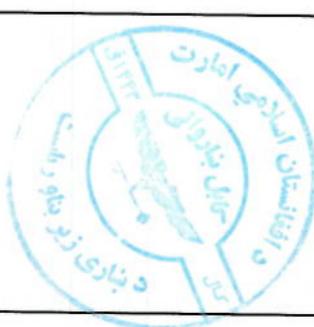


Project Name:	Corr-Sangi To Demzang Road project	
Drawing Title:	CROSS SECTIONS	
Designed by:	KABUL MUNICIPALITY DESIGN TEAM	
Checked by:	Hassanullah Shabani	
Date:	6/7/2023	
Scale:	1:200	
Status:	FINAL DESIGN	
Project Code:	CS-34	
Drawing Number:	00	
Revision:		

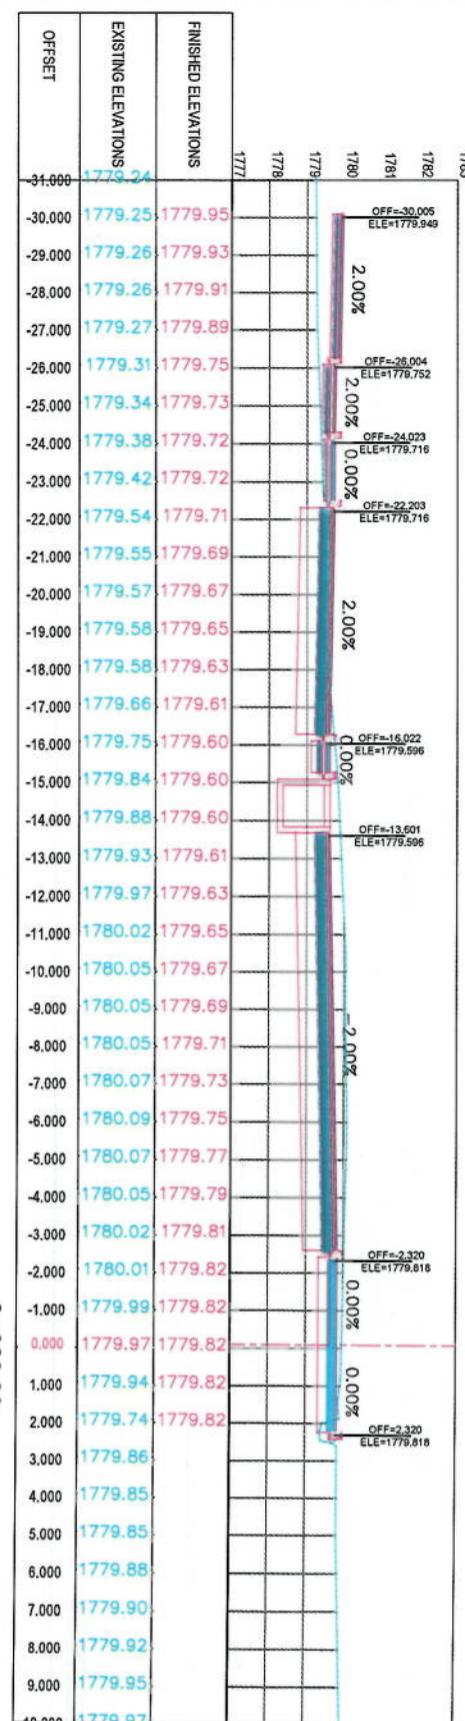

2+080.00

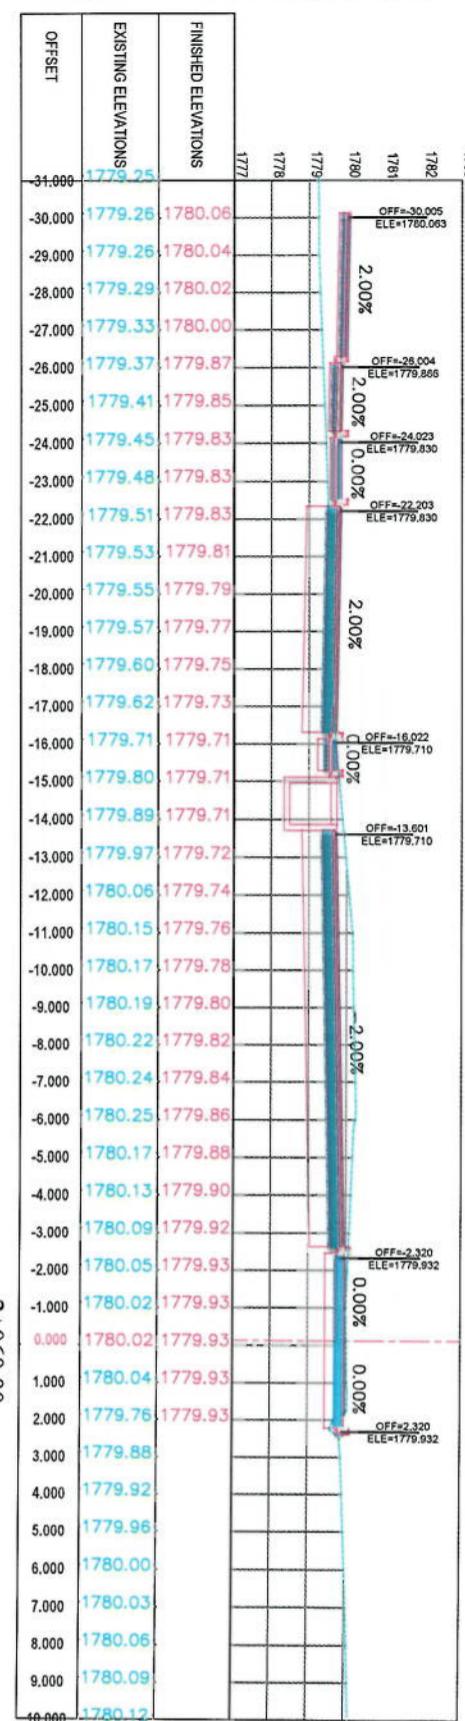

2+060.00

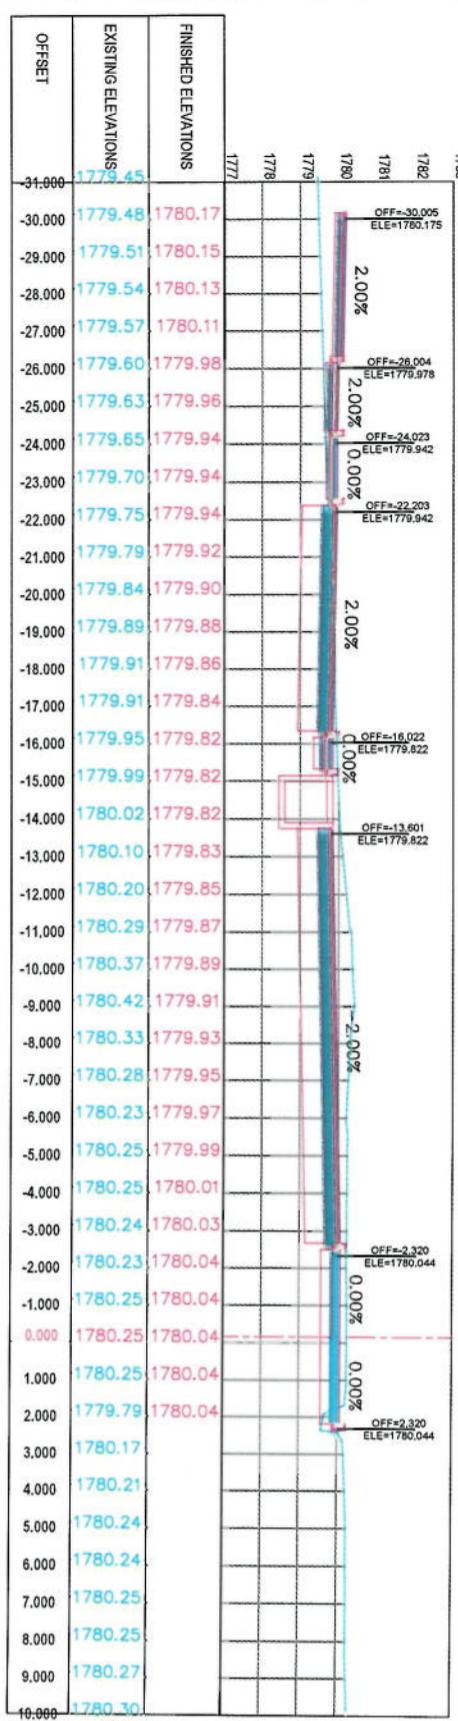

2+040.00


Project Name:		ISLAMIC EMIRATE OF AFGHANISTAN		
Designed by:		KABUL MUNICIPALITY		
Drawing Title:		CROSS SECTIONS		
Designed by:		KABUL MUNICIPALITY		
Drawn by:		Signature: _____		
Checked by:		Signature: _____		
Date:		6/7/2023		
Scale:		1:200		
Status:		FINAL DESIGN		
Project Code:		CS-35		
Revision:		00		

NOTES:
1. All dimensions are in meters unless otherwise indicated.


LEGENDS

- CENTER-LINE**: Dashed line
- EXISTING SURFACE**: Dotted line
- EXISTING SIDE DITCH**: Blue line




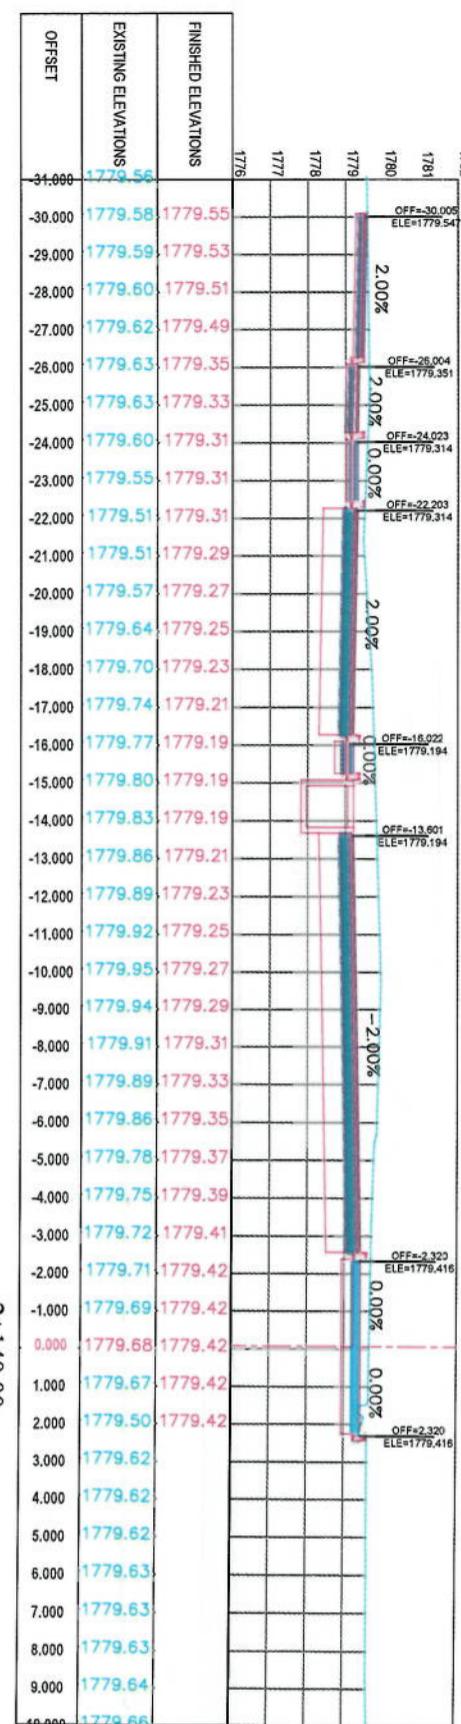

2+140.00

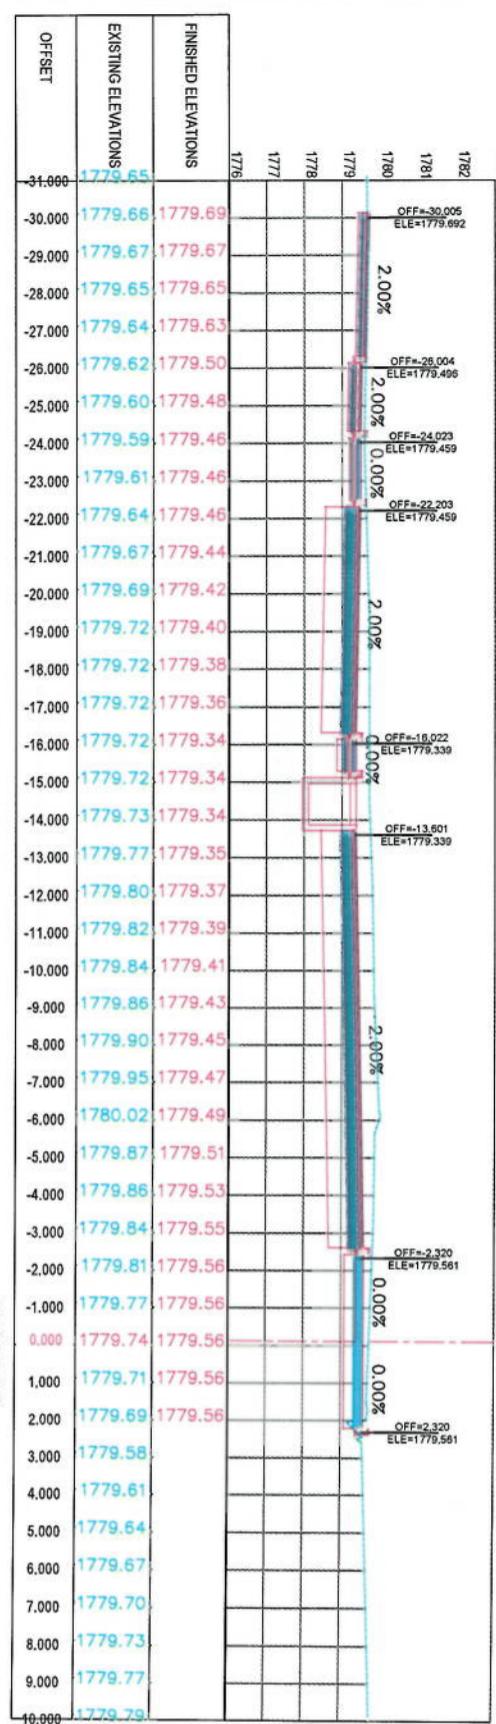


2+120.00

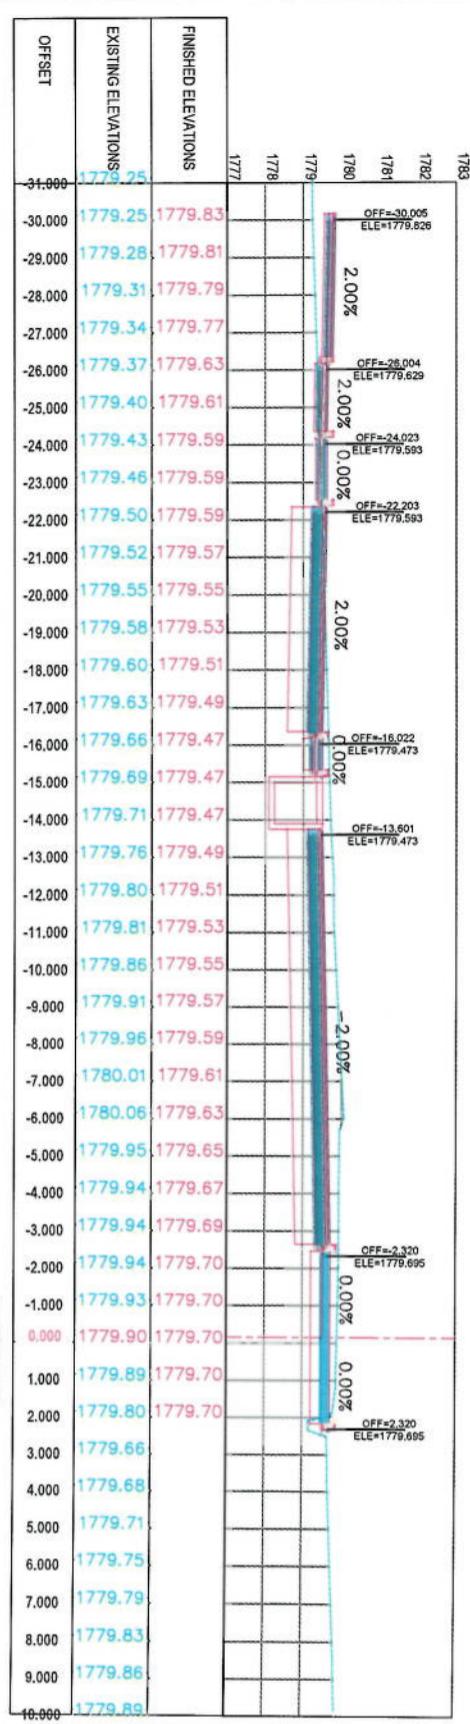



2+100.00

Project Name:	KABUL MUNICIPALITY	
Designed by:	KABUL MUNICIPALITY	
Drawn by:	KABUL MUNICIPALITY	
Checked by:	KABUL MUNICIPALITY	
Date:	6/7/2023	
Scale:	1:200	
Same:	FINAL DESIGN	
Project Code:	CS-36	
Drawing Number:	00	

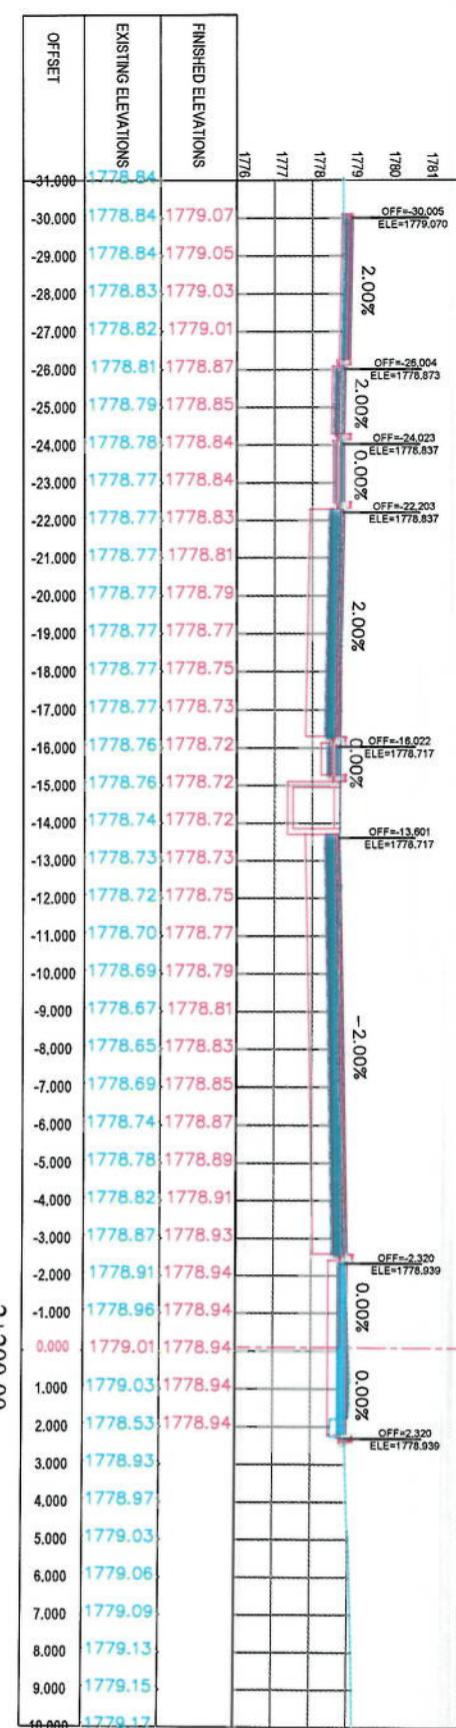

2+200.00

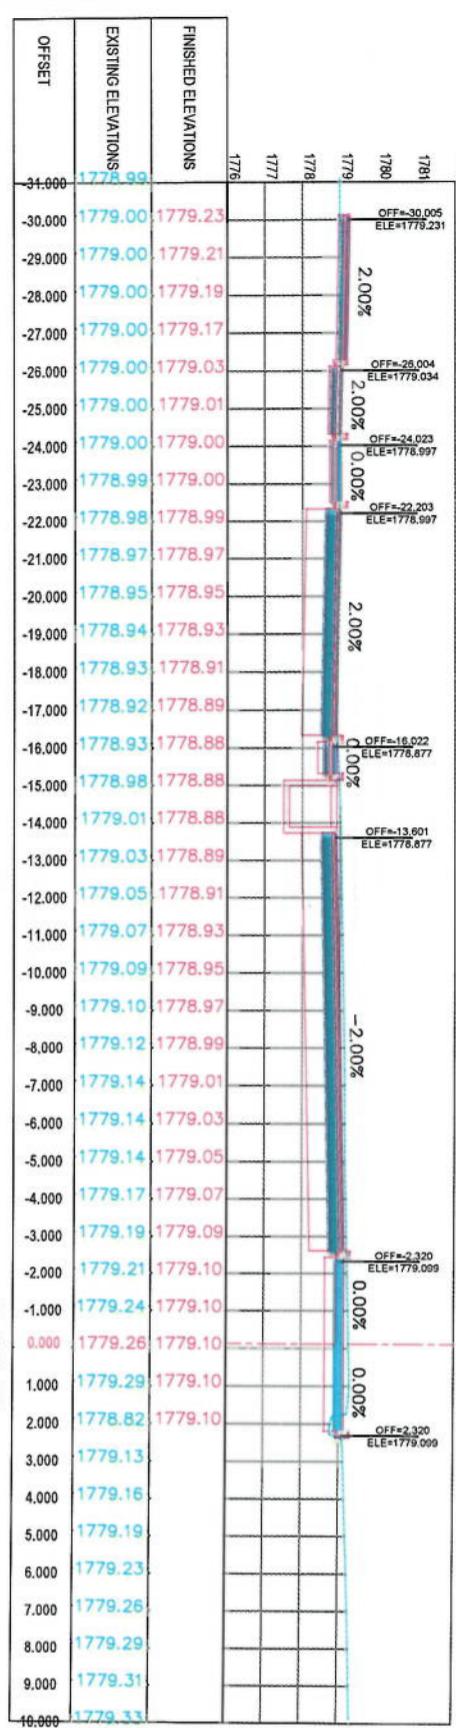


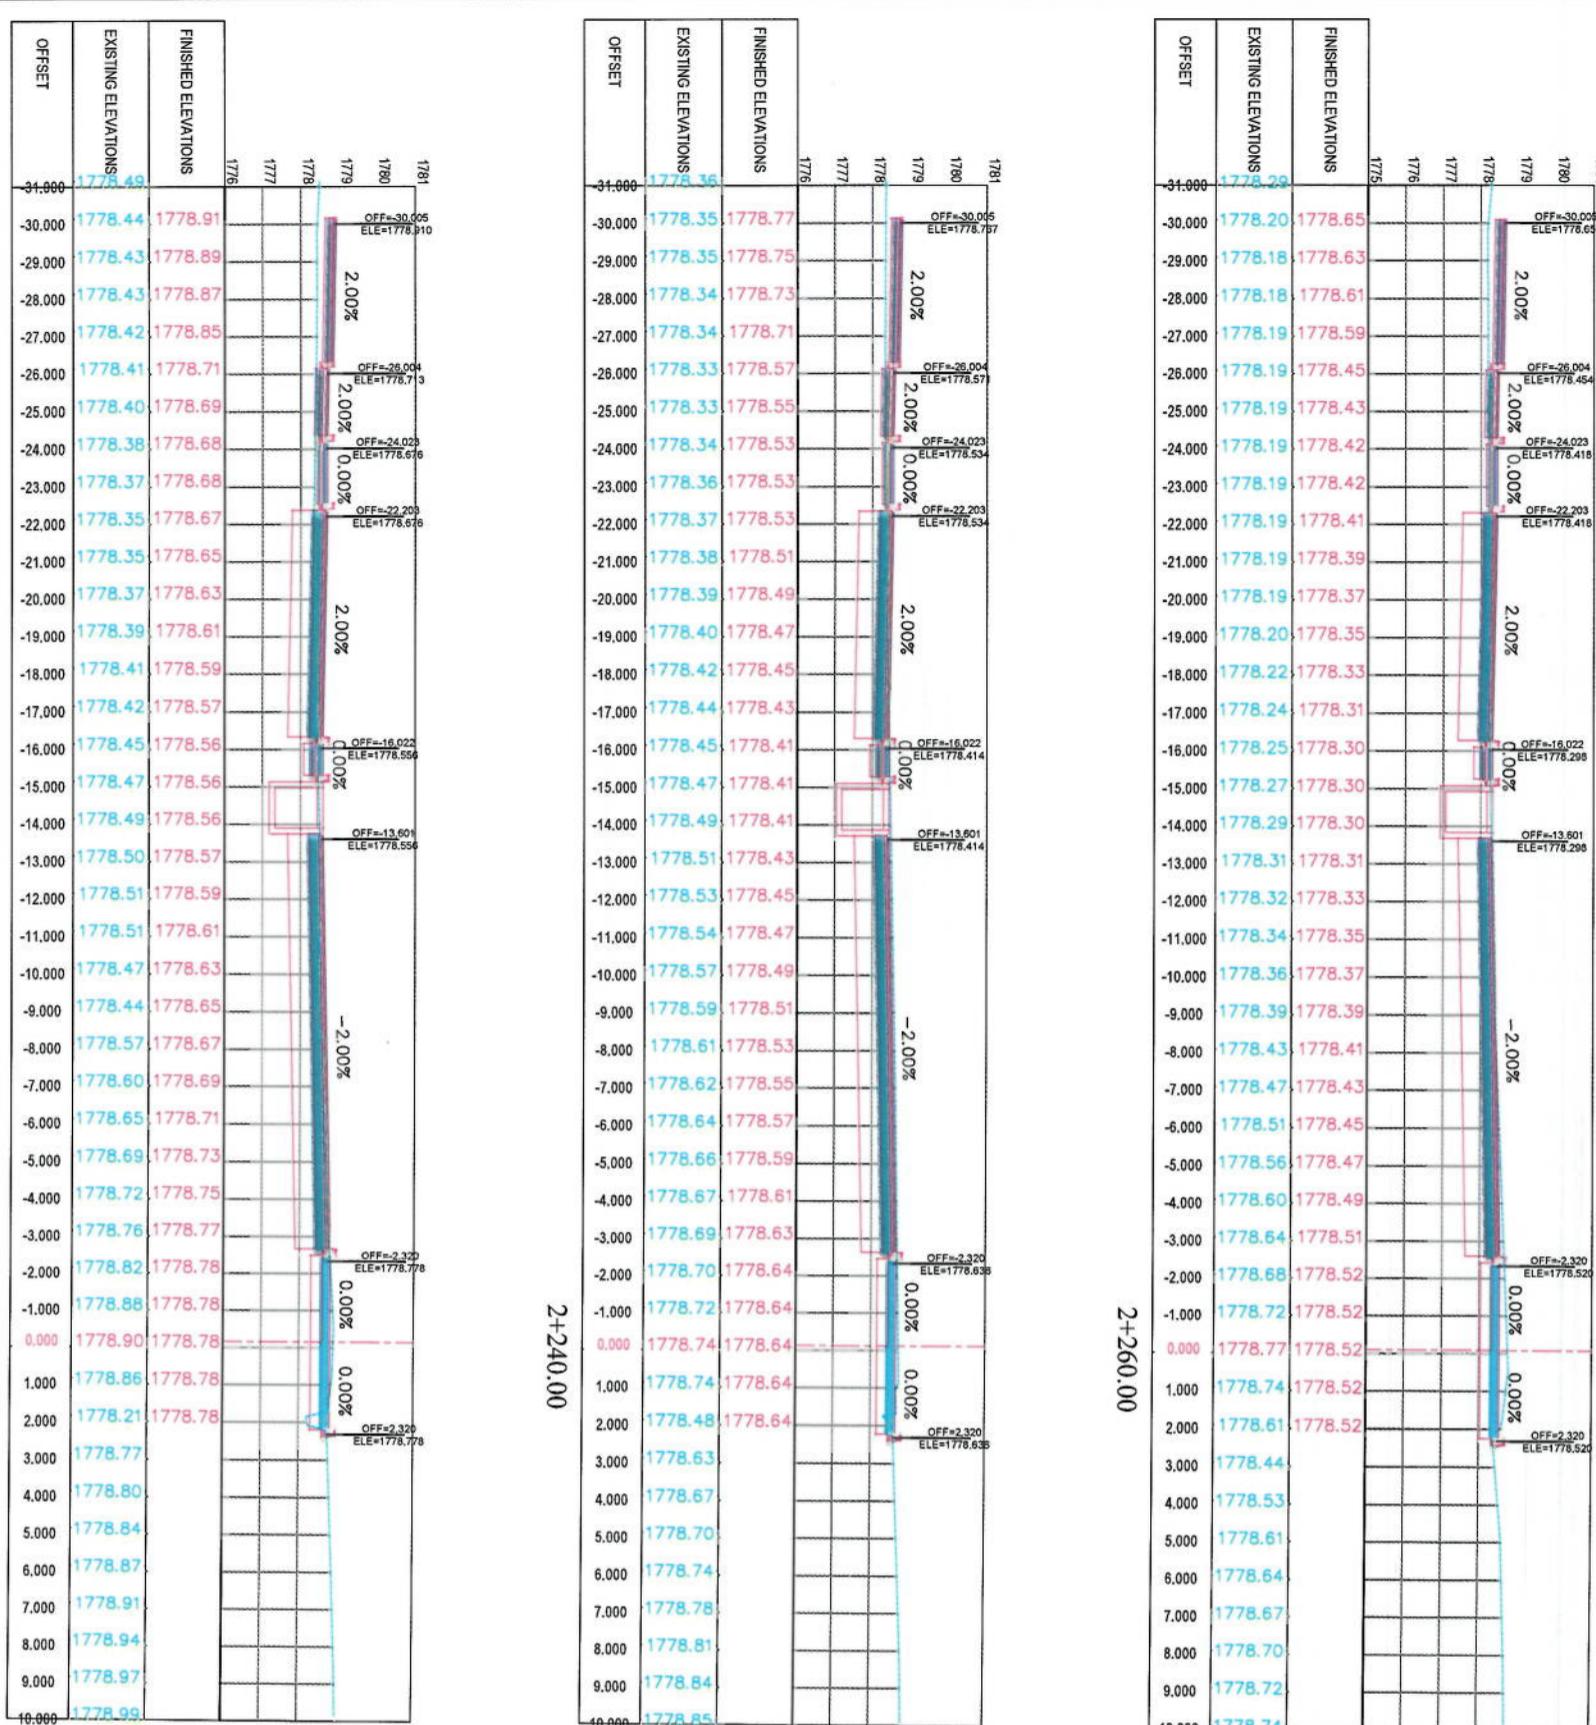

2+220.00

2+240.00




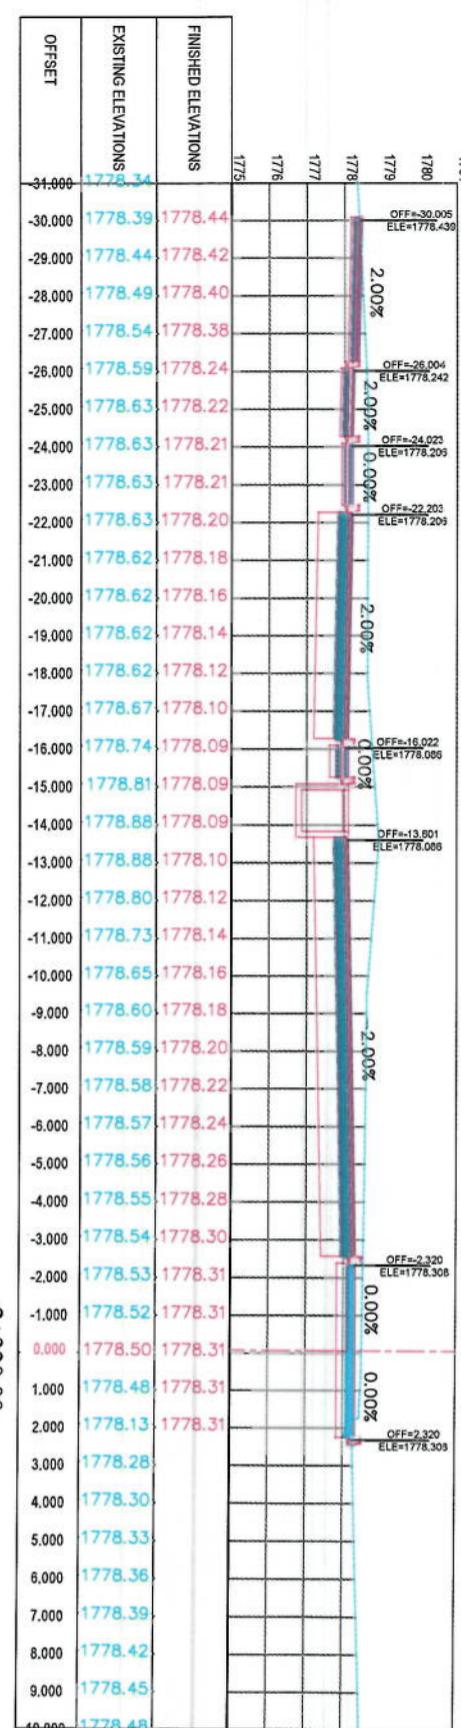


2+330.00



2+320.00

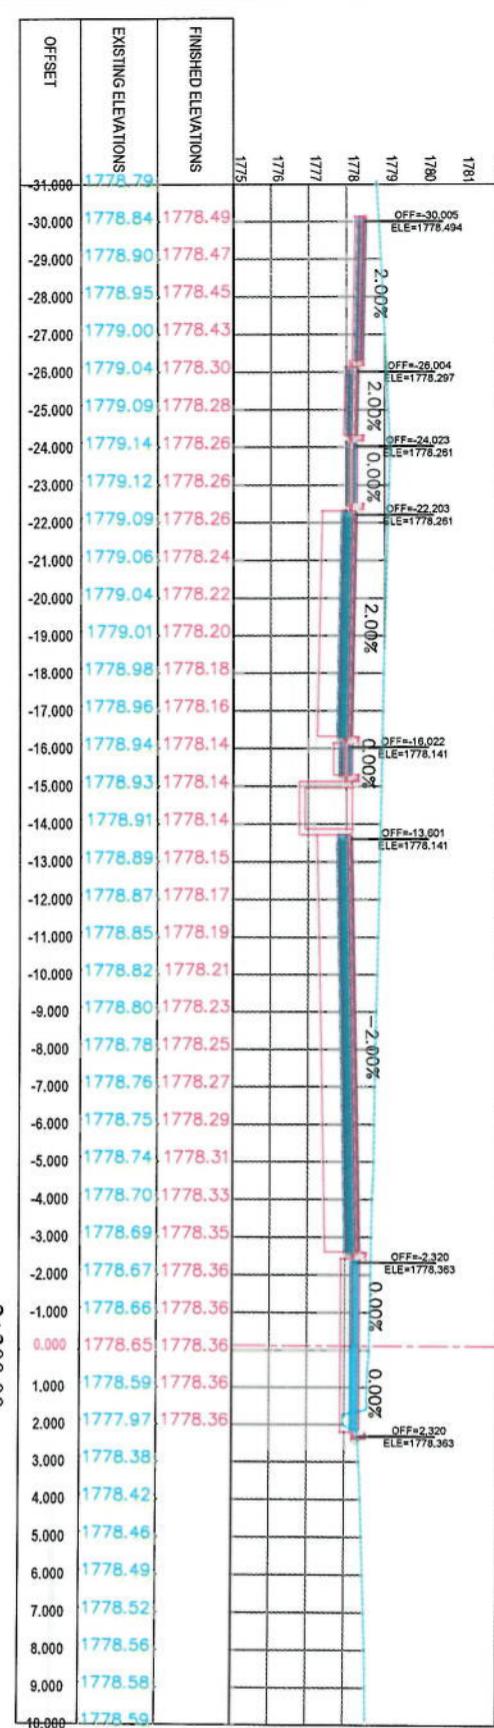


2+300.00

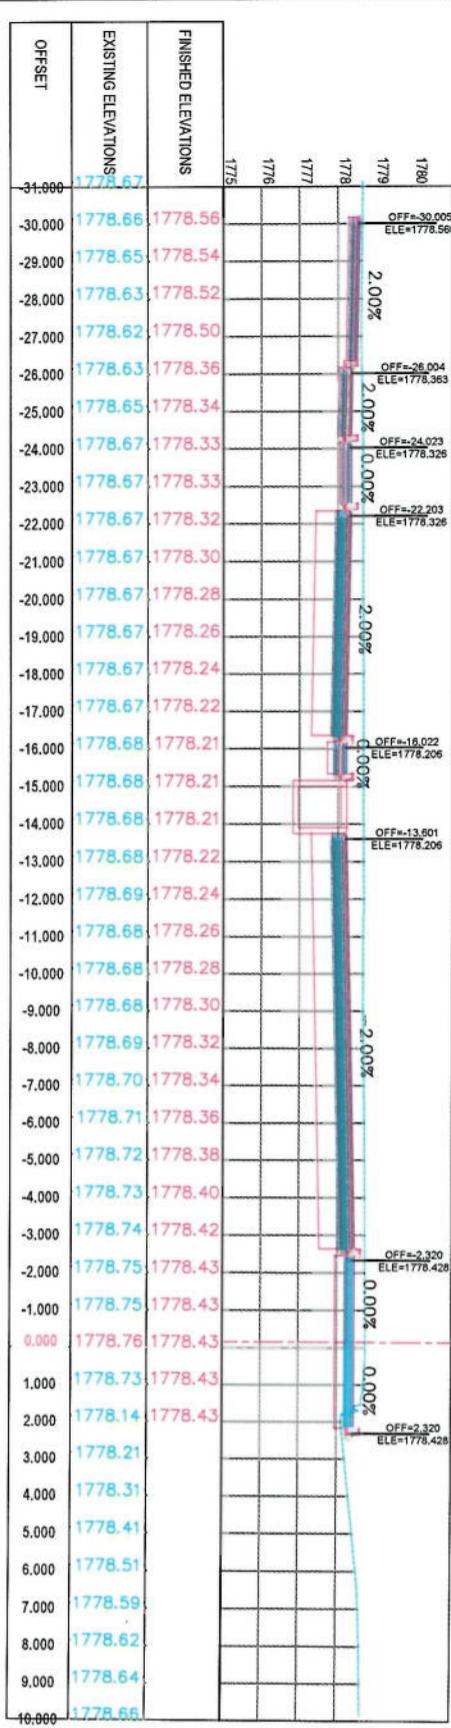



2+280.00

Project Name:	
Cord-Sangil To Demzang	Road Project
Designed by:	Mohammad Eesa Sirat
Drawn by:	Mohammad Eesa Sirat
Checked by:	Hannah Shams
Date:	6/7/2023
Scale:	1:200
Status:	FINAL DESIGN
Project Code:	CS-39
Revision:	00

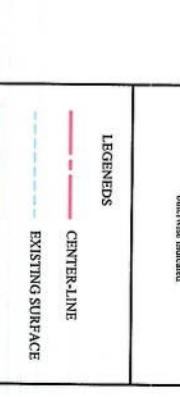

1. All dimensions are in meters unless otherwise indicated

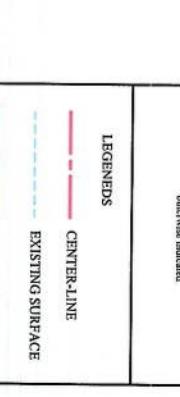

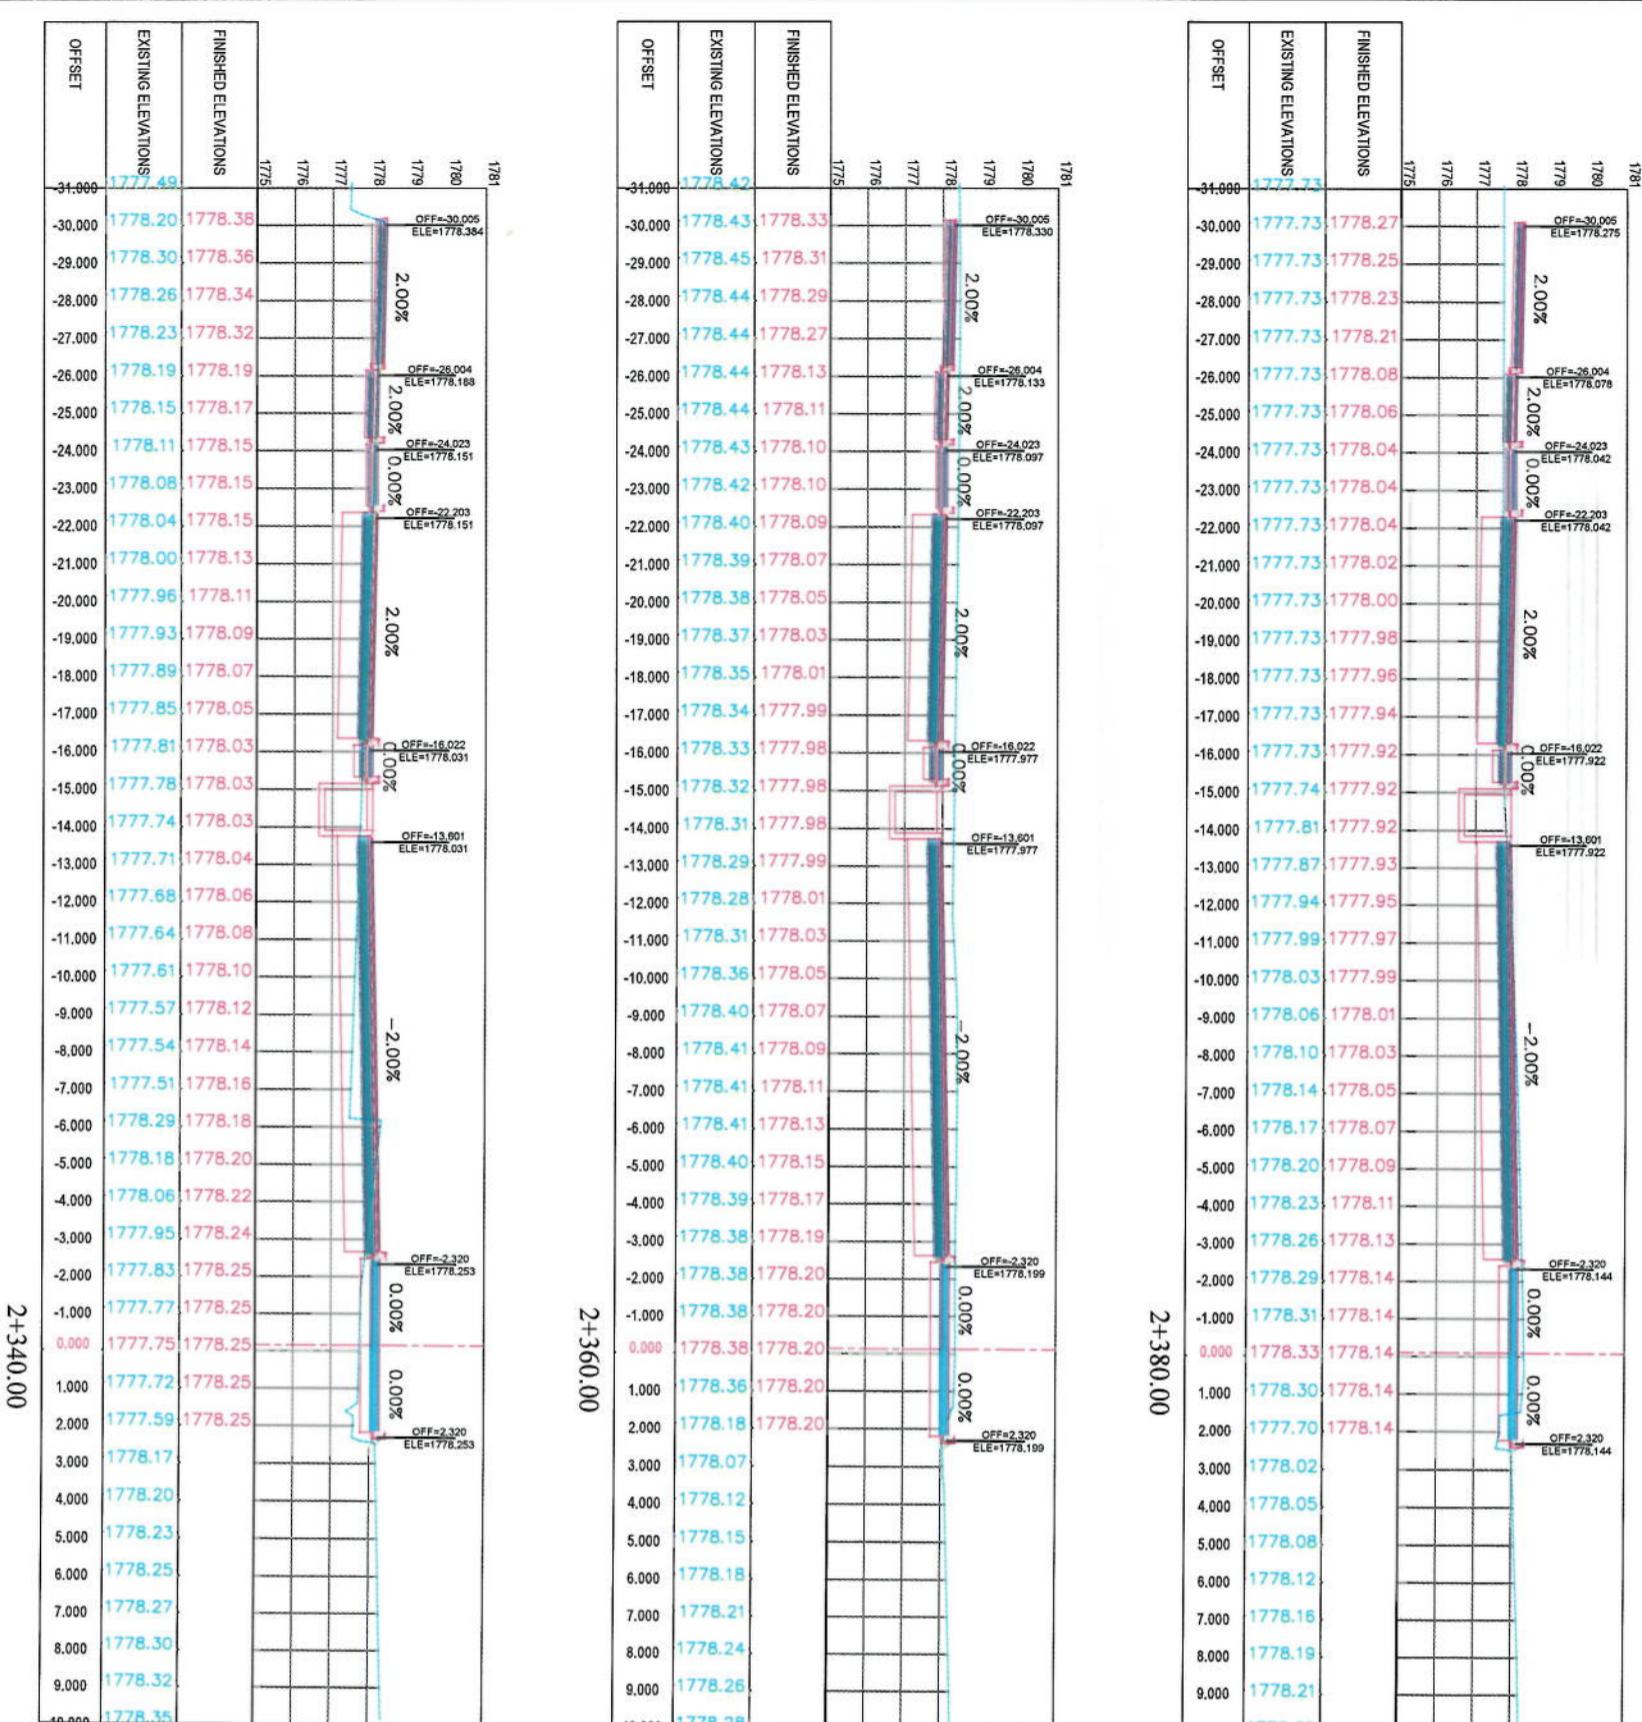


NOTE:


1. All dimensions are in meters unless otherwise indicated.

LEGENDS
CENTER-LINE
EXISTING SURFACE
EXISTING SIDE DITCH


Project Name:	KABUL MUNICIPALITY DESIGN TEAM
Conc-Samp To Demazang	Road project
Drawing Title:	CROSS SECTIONS
Designed by:	Client
Drawn by:	KABUL MUNICIPALITY
Checked by:	
Approved by:	
Date:	6/7/2023
Scale:	1:200
Status:	FINAL DESIGN
Project Code:	
Drawing Number:	CS-40
Revision:	00

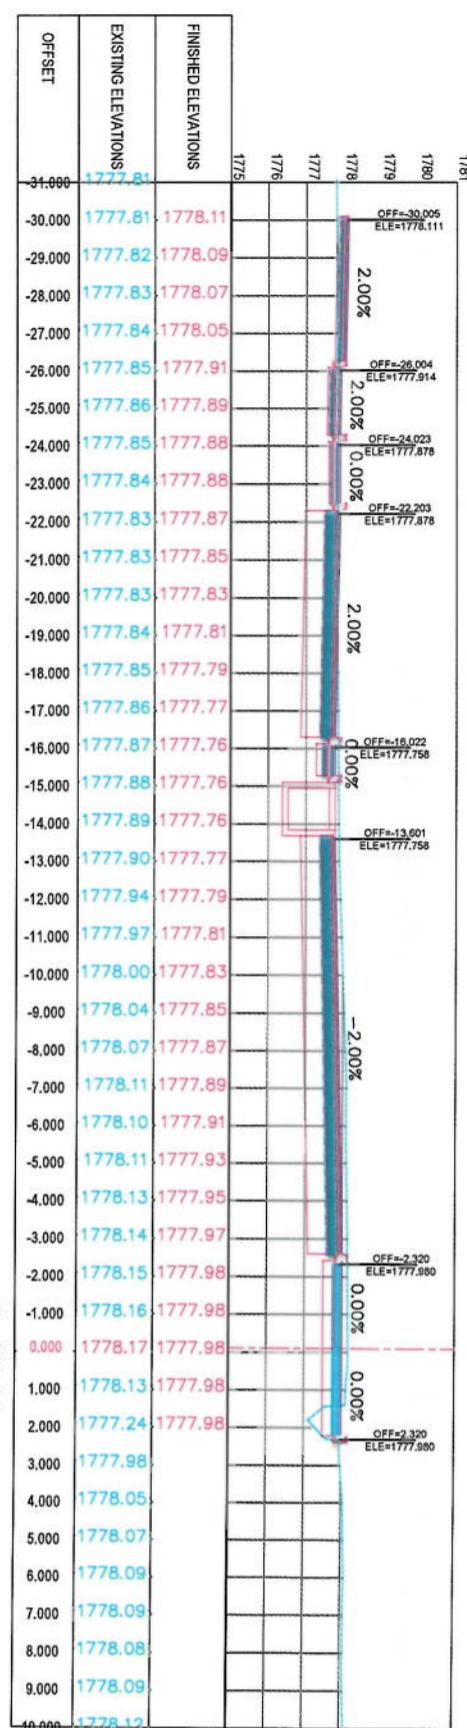


2+440.00

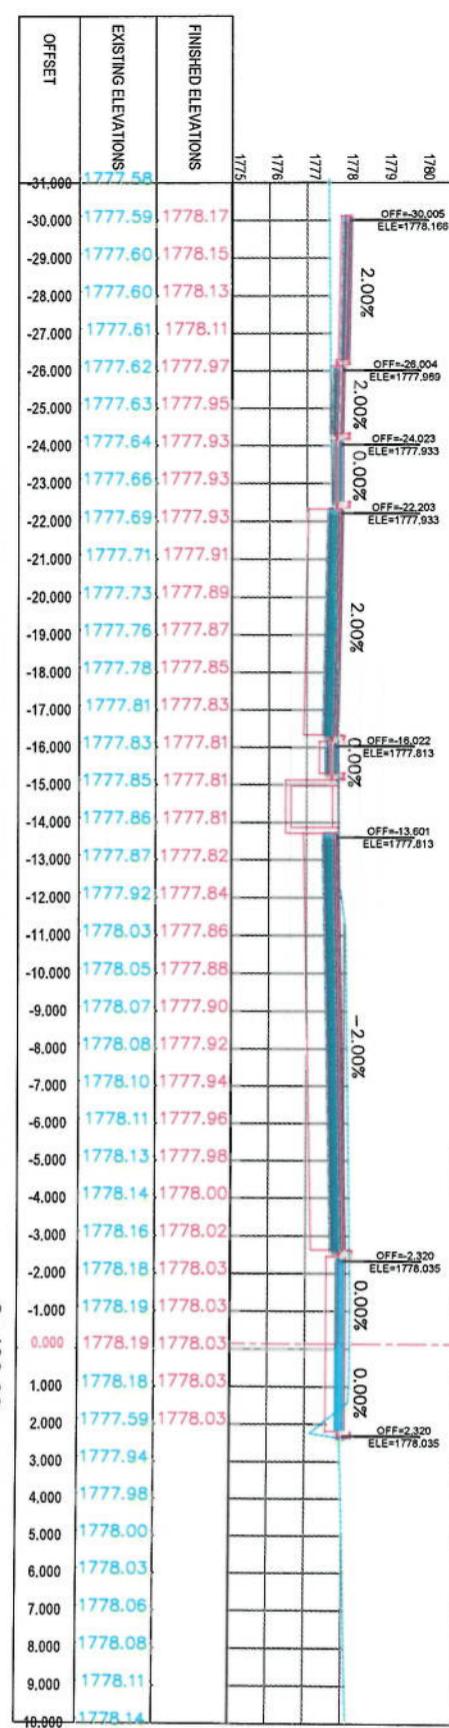


2+420.00

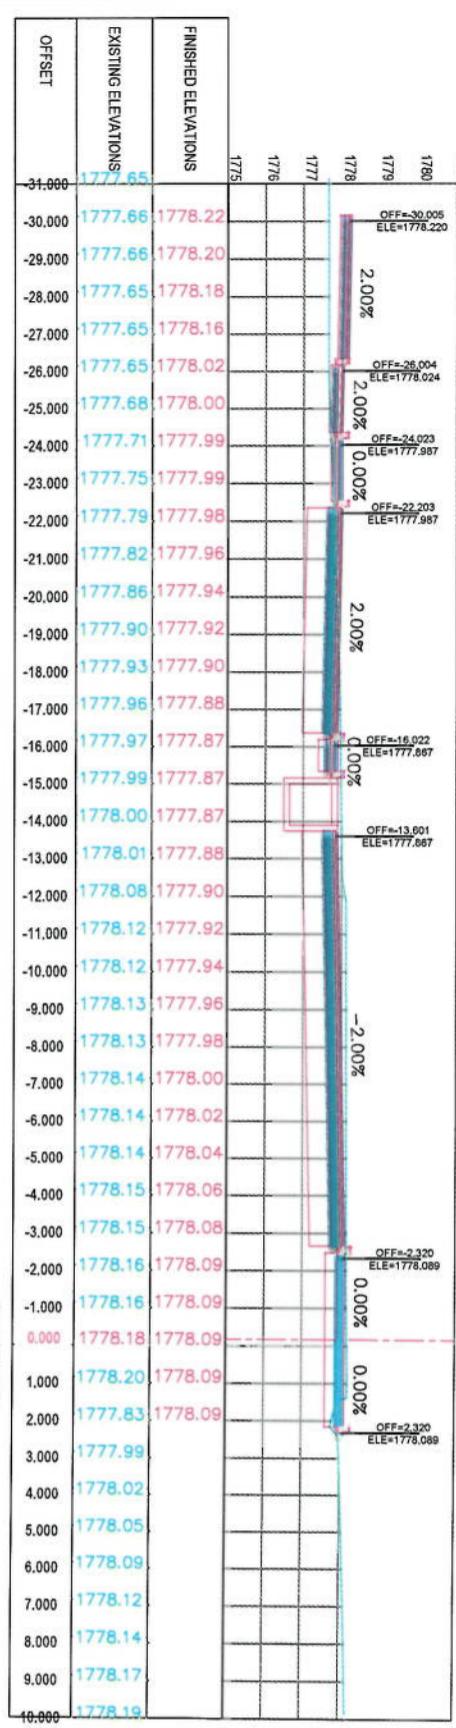


2+400.00

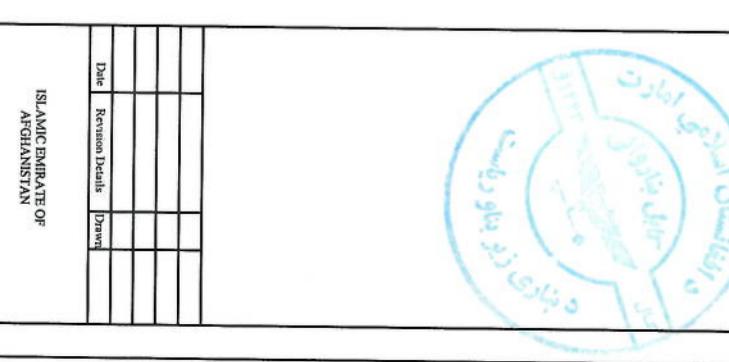


Drawing Title:	CROSS SECTIONS		
Designed by:	Signature	Signature	Signature
Drawn by:	Signature	Signature	Signature
Checked by:	Signature	Signature	Signature
Stamp:	FINAL DESIGN		
Project Code:			
Drawing Number:	CS-4-1	Revision	00

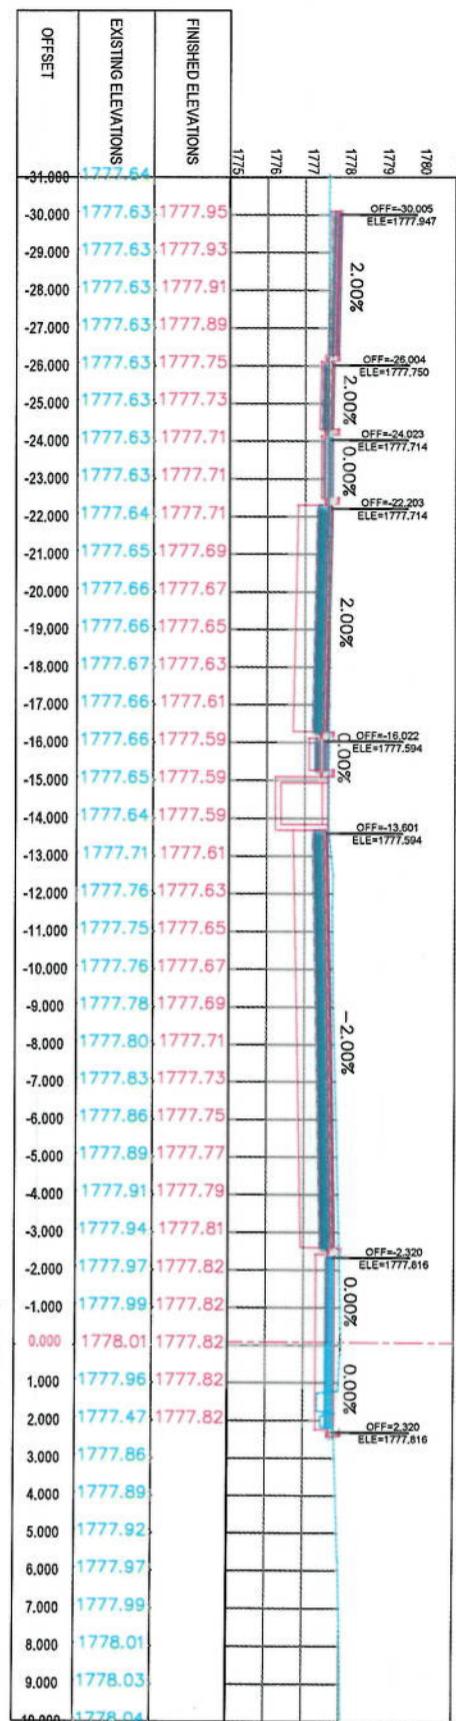

2+500.00

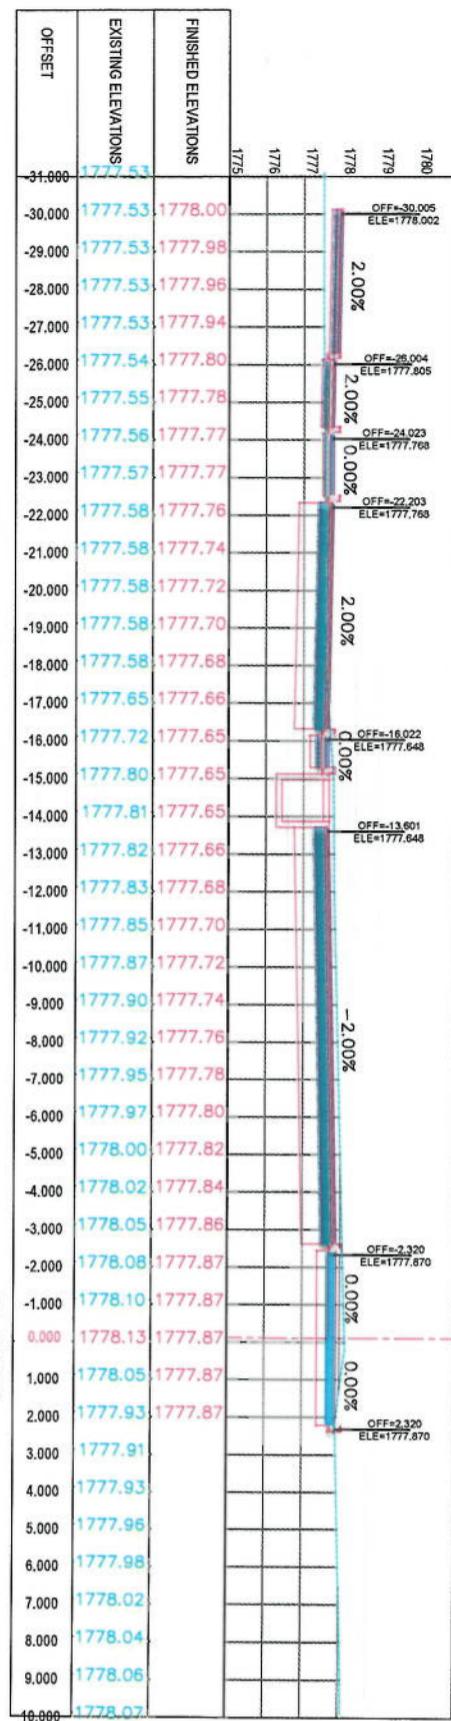

2+480.00

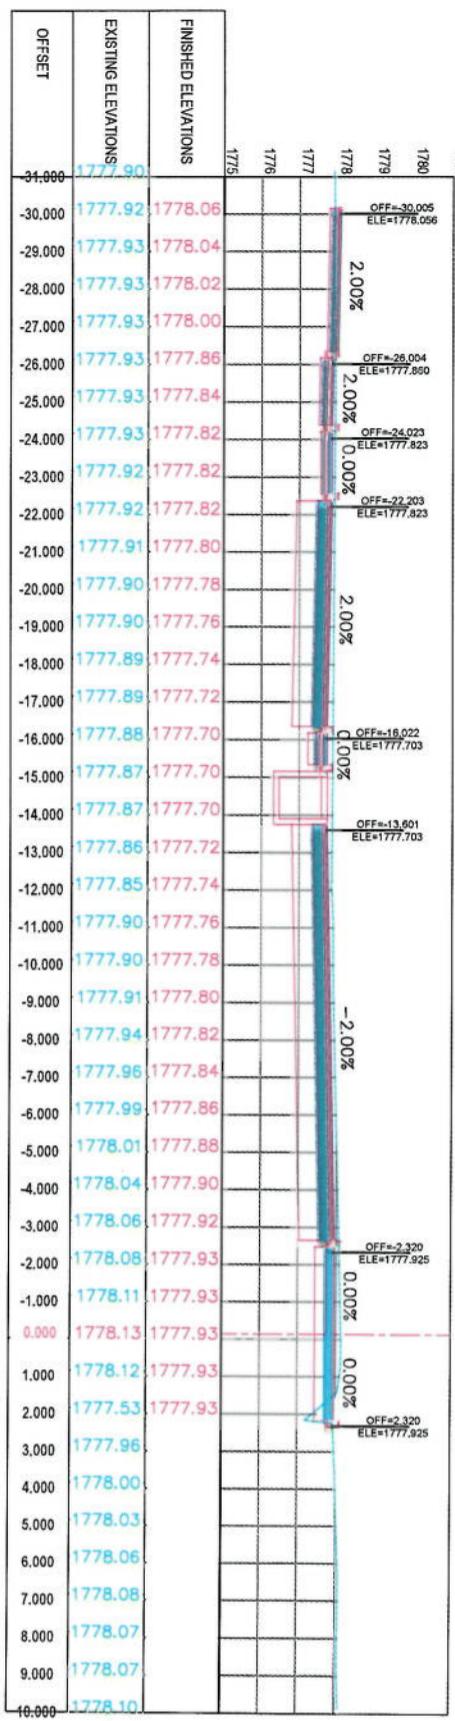

2+460.00

NOTE:


- All dimensions are in meters unless otherwise indicated.

LEGENDS

CENTER-LINE
--- EXISTING SURFACE
— EXISTING SIDE DITCH



Drawing Title:	CROSS SECTIONS		
Designed by:	Signature:	Date:	Revision Details
Mohammad Fisa Street		6/7/2023	Drawn
Mohammad Fisa Street		6/7/2023	Checked by:
Habibullah Shatzi		6/7/2023	Signature:
Project Name:	KABUL MUNICIPALITY	Project Code:	
Client:	KABUL MUNICIPALITY		
ISLAMIC EMIRATE OF AFGHANISTAN			
Braving Title:			
Date:	Scale:	6/7/2023	1:200
Status:	FINAL DESIGN		
Project Number:	CS-42	Revision:	00

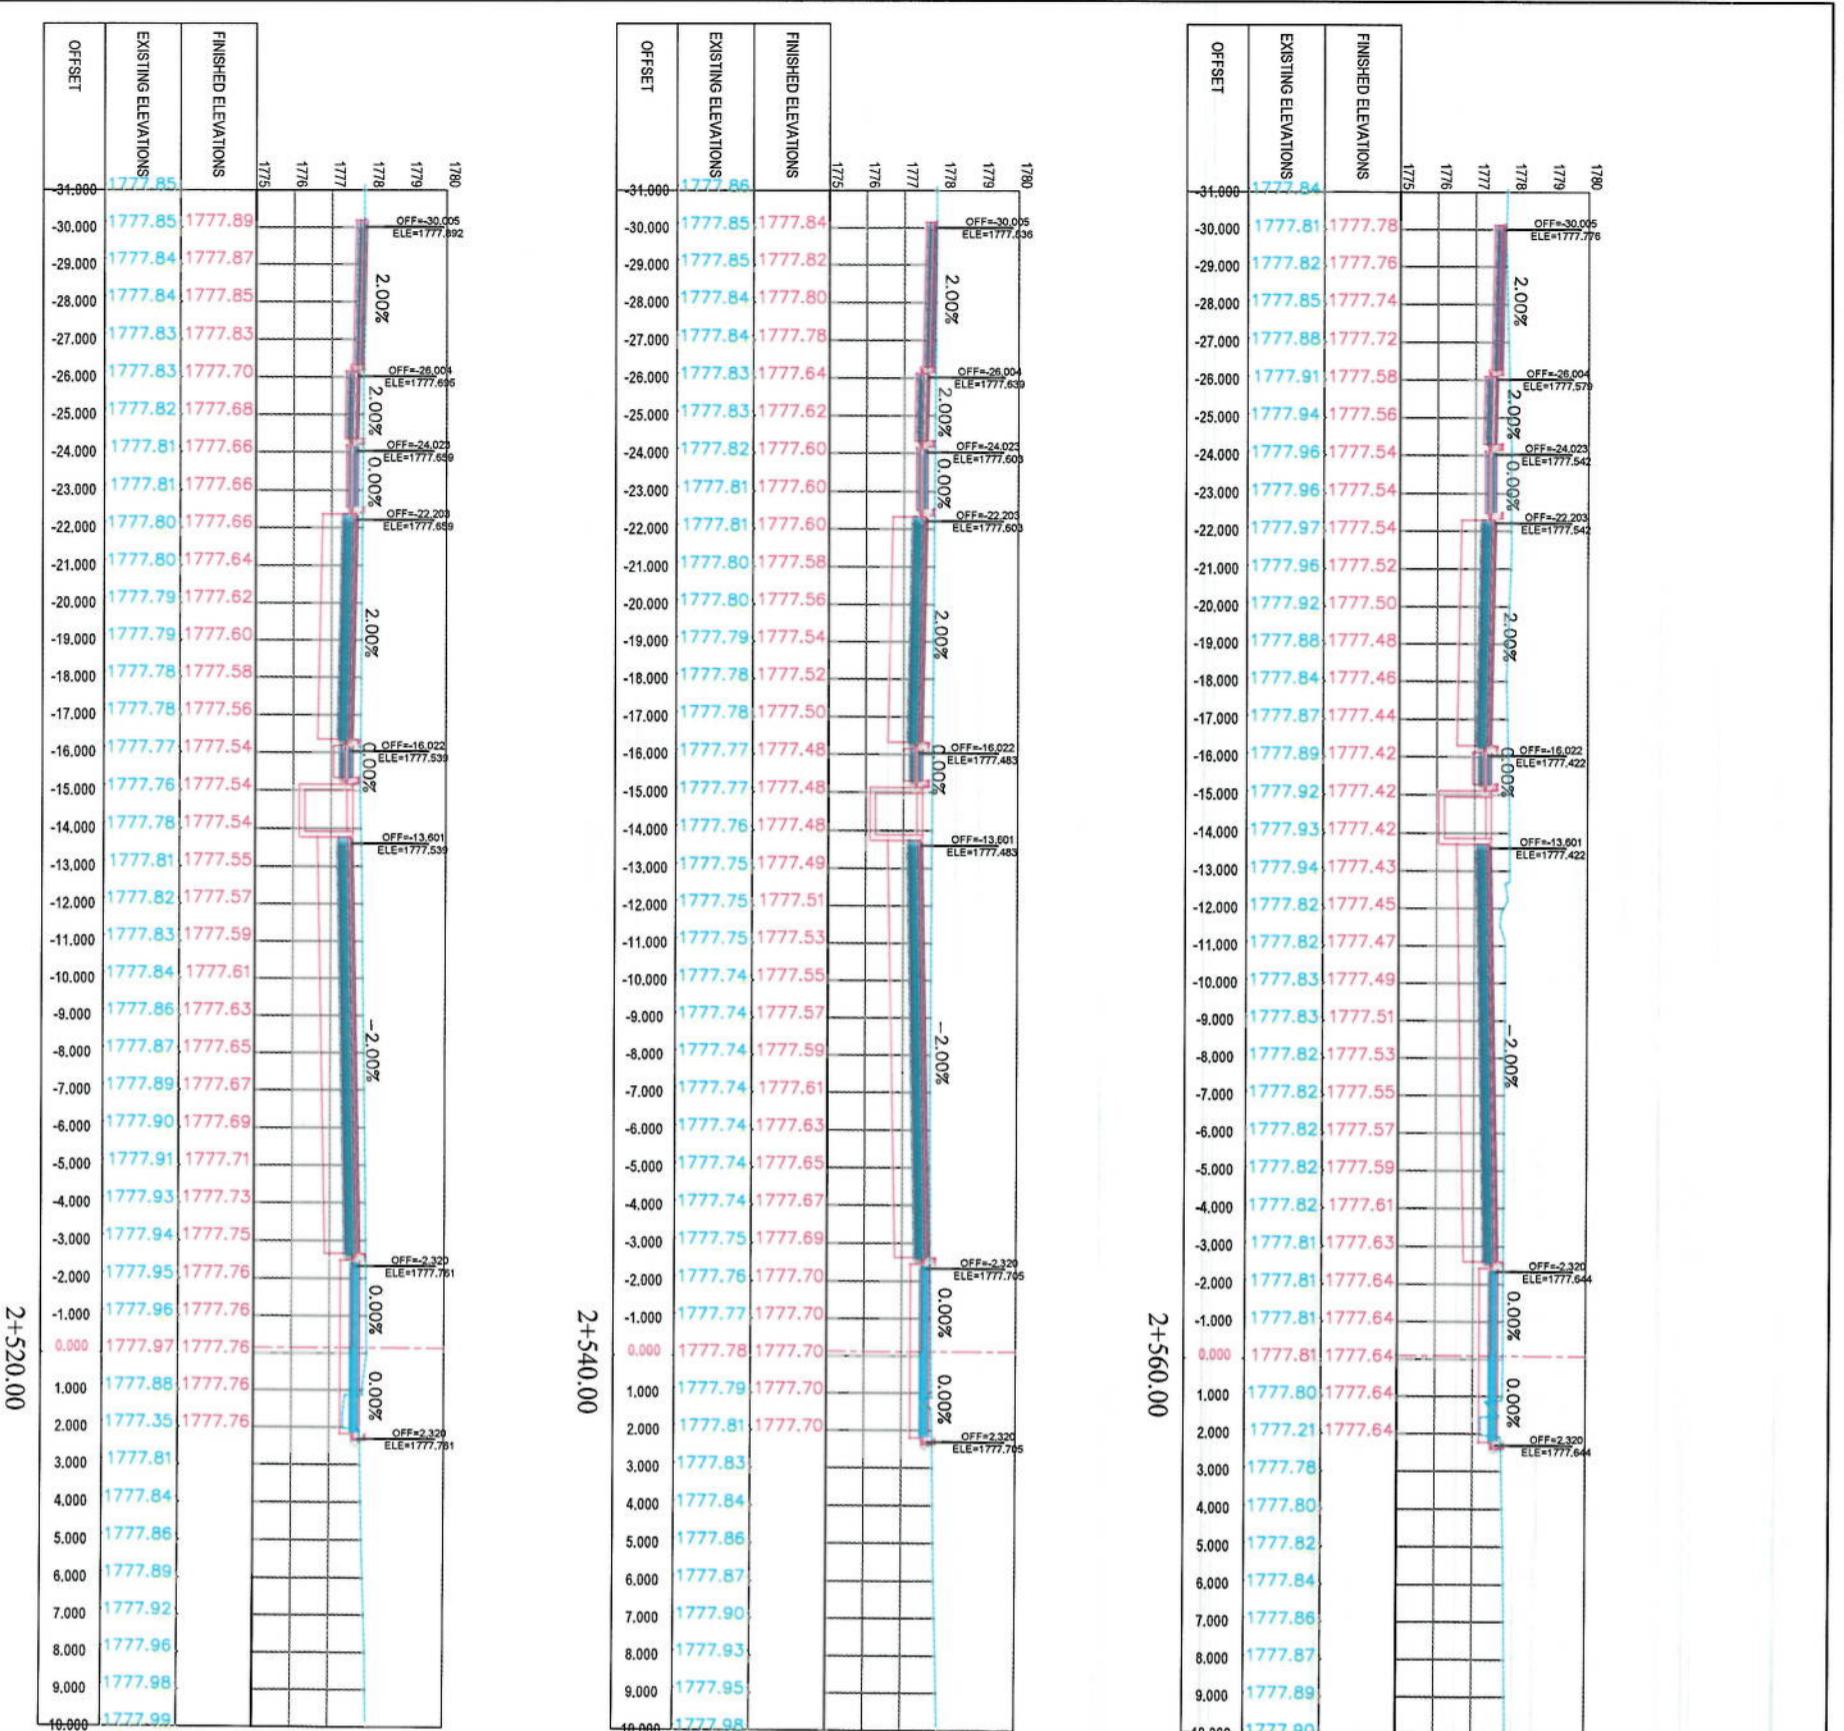

NOTE:


- All dimensions are in meters unless otherwise indicated.



LEGENDS


- CENTER-LINE
- EXISTING SURFACE
- EXISTING SIDE DITCH




Designing by:	KABUL MUNICIPALITY DESIGN TEAM
Project Name:	One-Stop To Demazang
Checked by:	Road project
Training Title:	
CROSS SECTIONS	
Designed by:	Mohammad Esa Sait Signature:
Drawn by:	Mohammad Esa Sait Signature:
Checked by:	Hasbullah Shabiz Signature:
Date:	6/7/2023
Scale:	1:200
Status:	FINAL DESIGN
Project Code:	
Drawing Number:	CS-43
Revision:	00

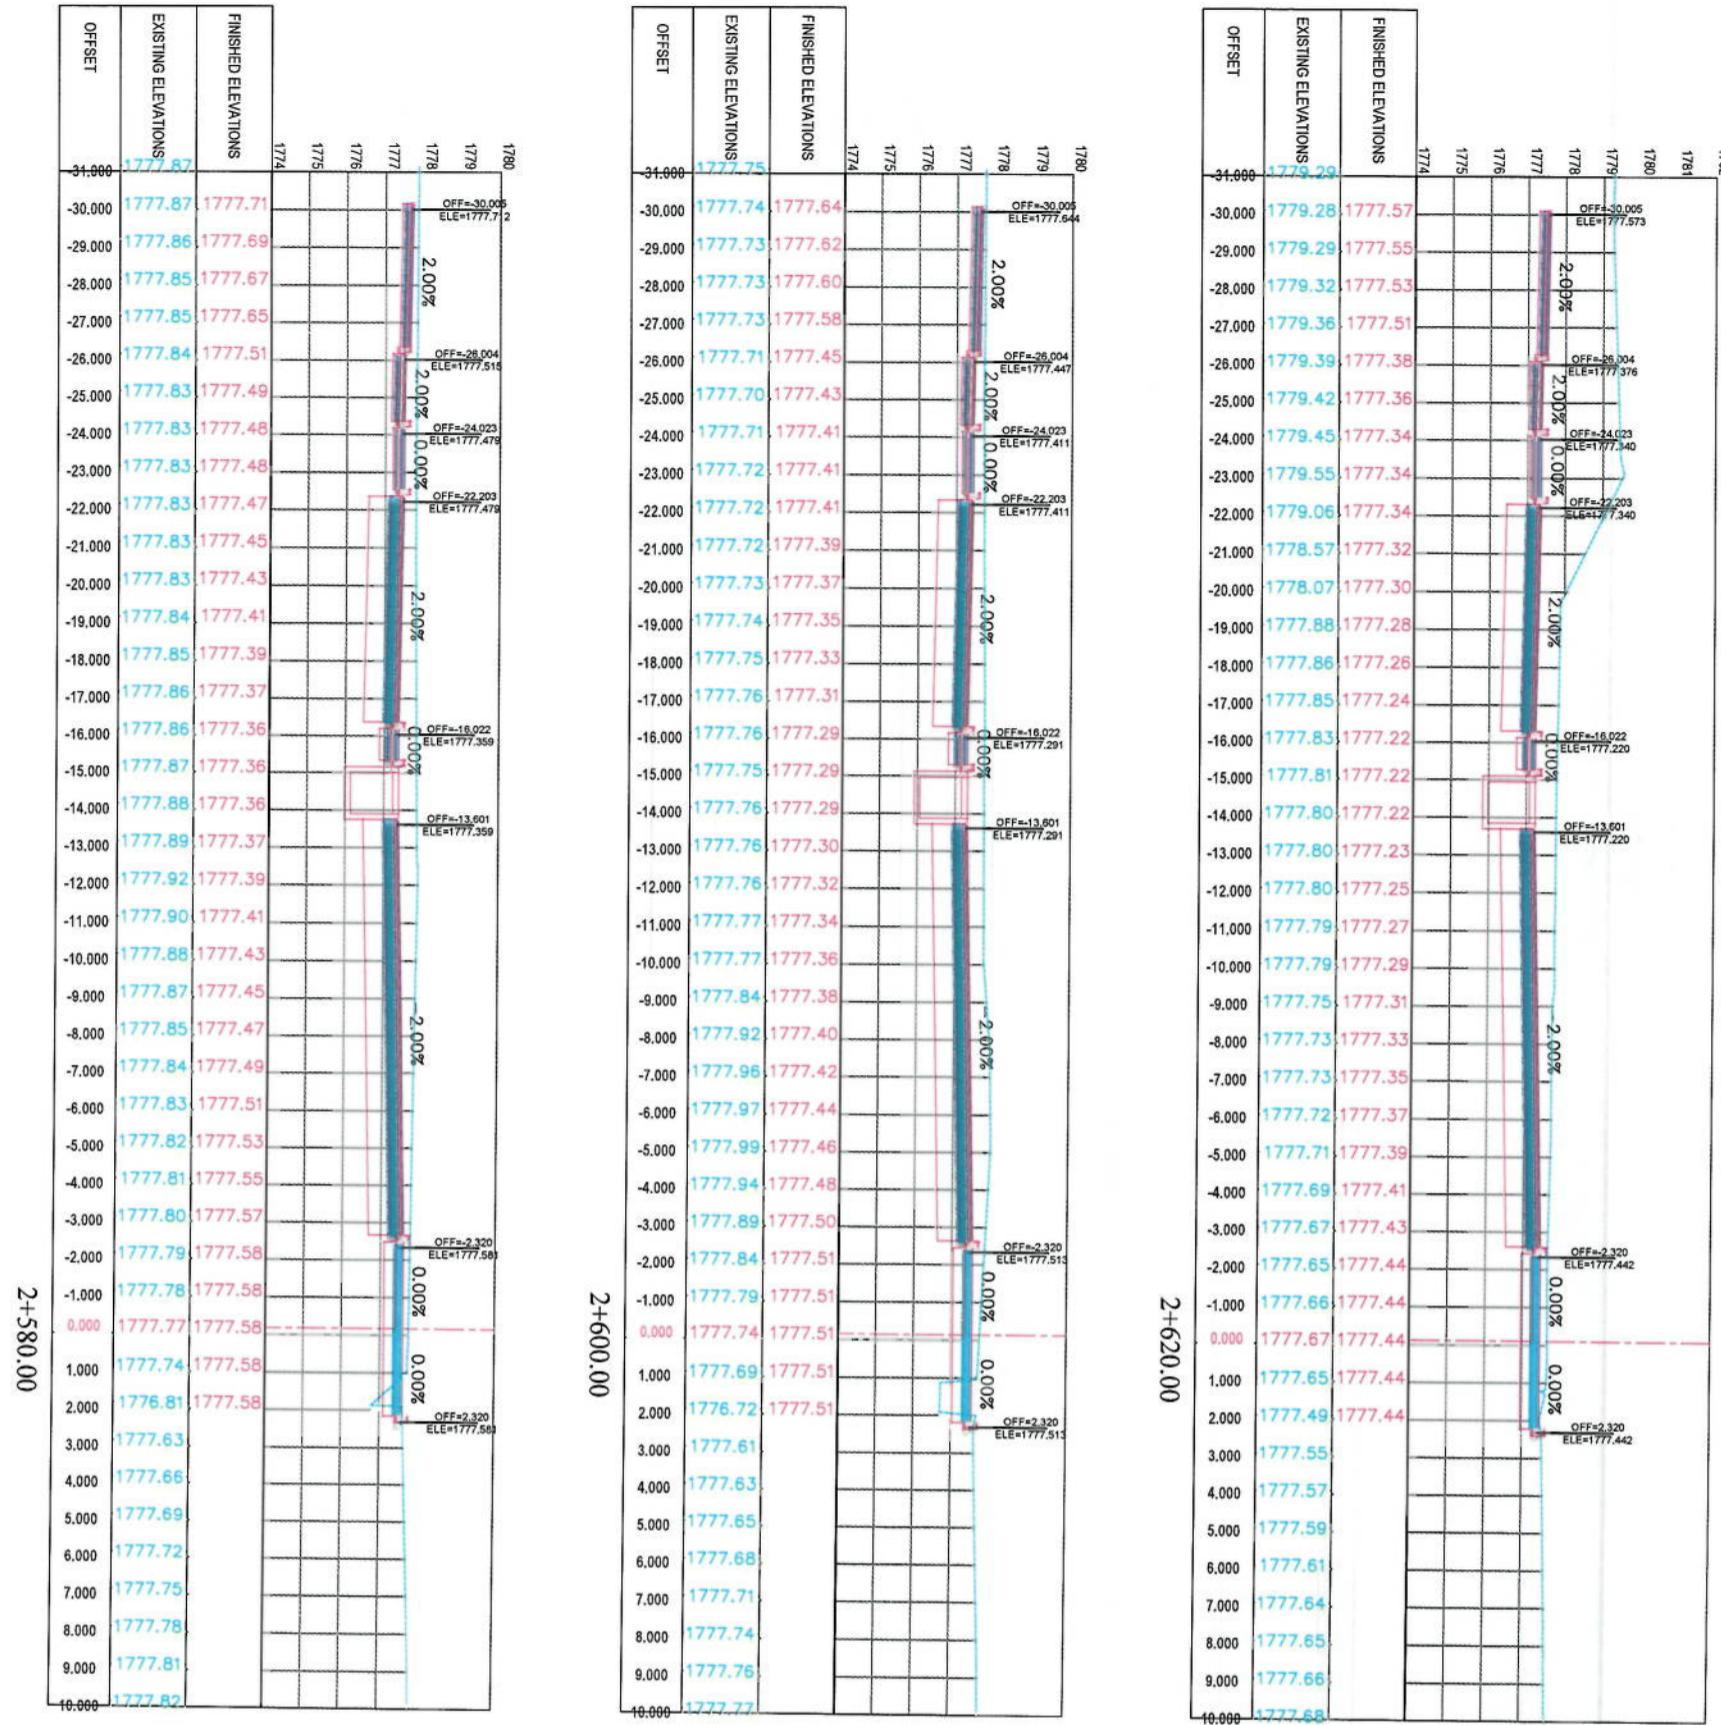

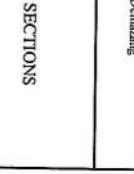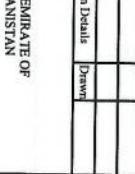
Project Name:	KABUL MUNICIPALITY DESIGN TEAM	
Designed by:	KABUL MUNICIPALITY	
Client:	 KABUL MUNICIPALITY	
Contractor:	KABUL MUNICIPALITY	
Contract No.:	Contract No.:	
Design No.:	Design No.:	
Date:	Date:	
Signature:		
Signature:		
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Signature:		
Signature:		
Signature:	<img alt="Signature of Project Manager" data	

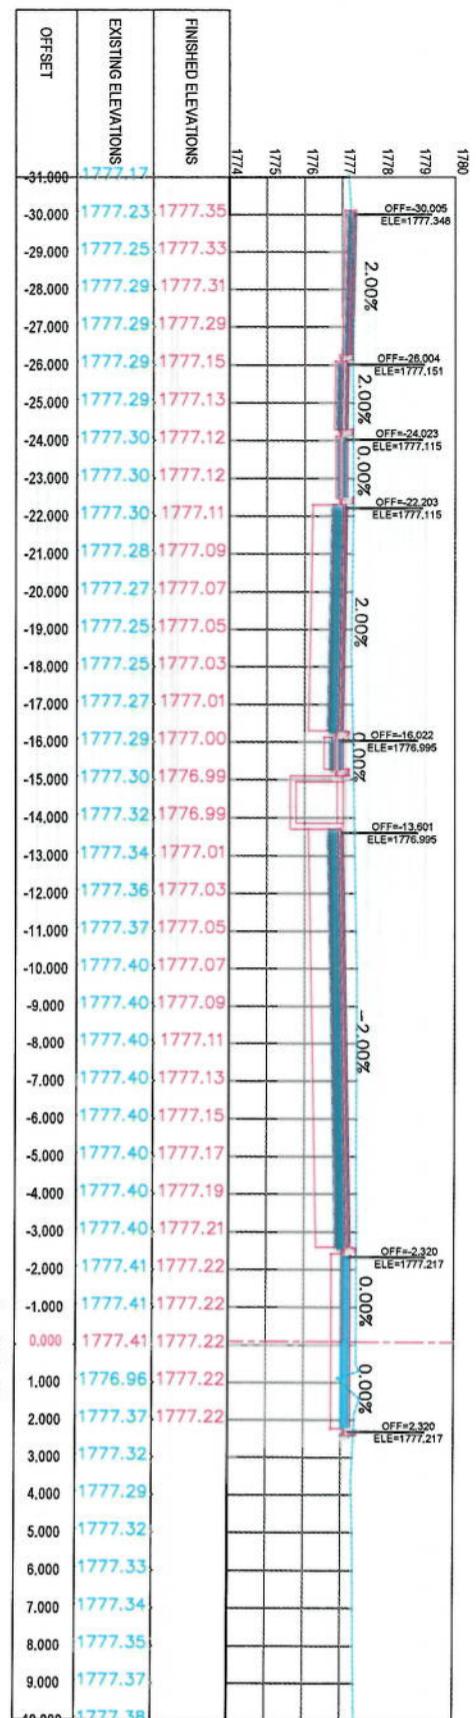

2+680.00

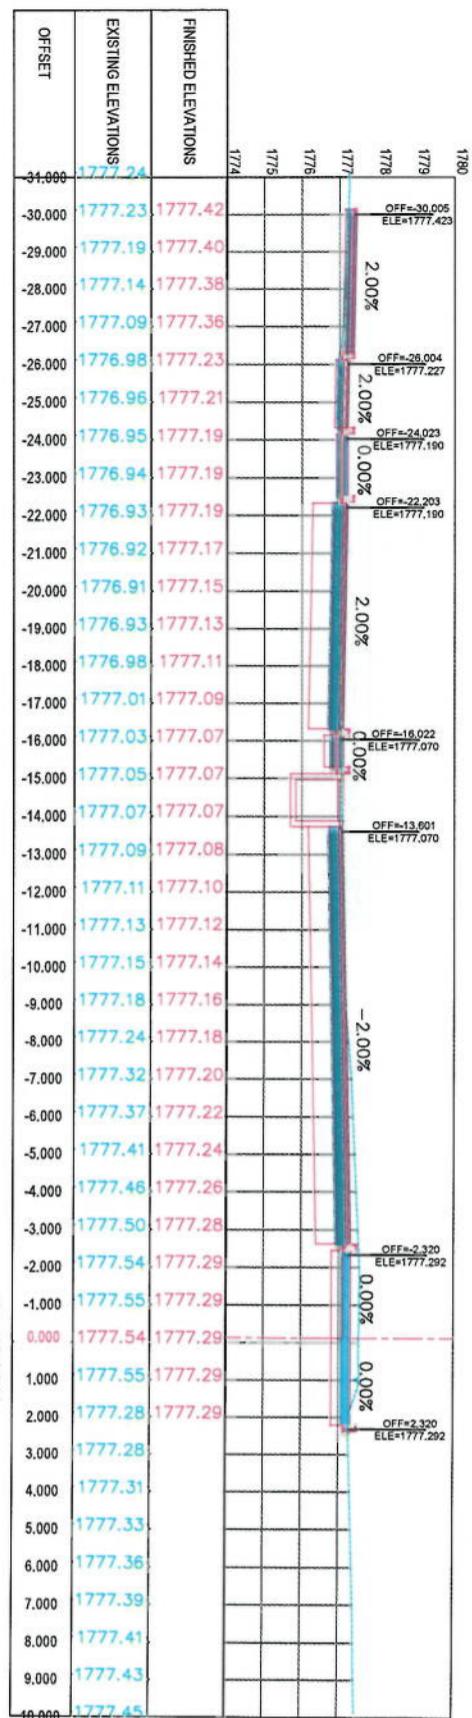

2+660.00

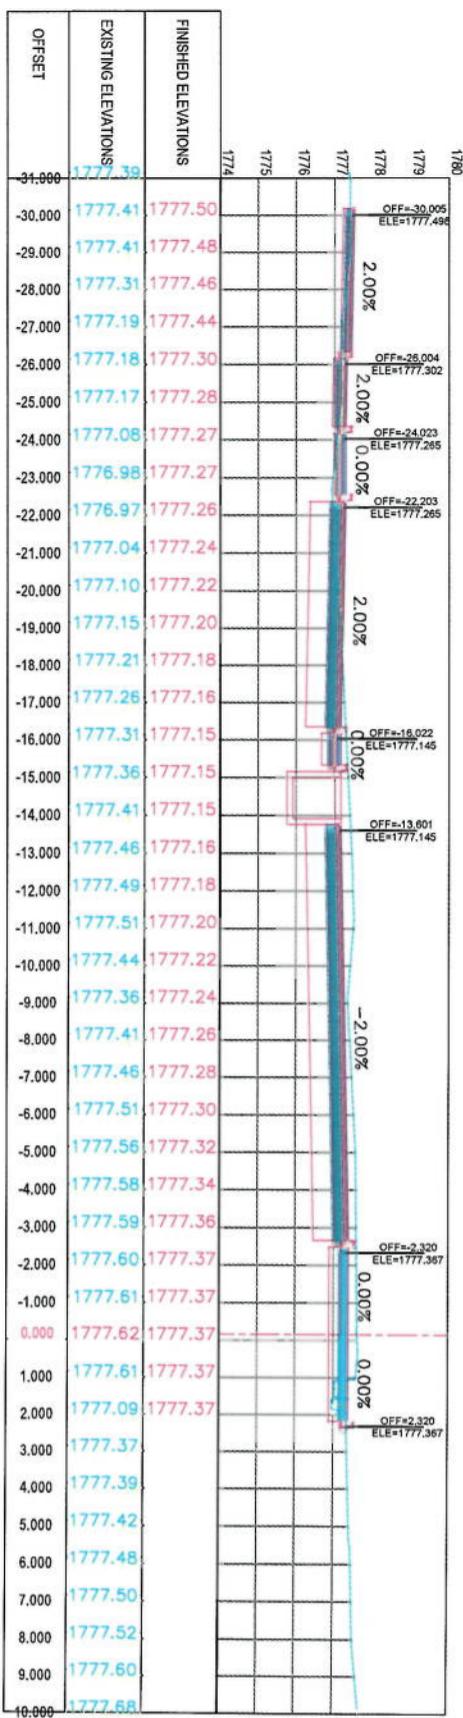




2+640.00

NOTE:
1. All dimensions are in meters unless otherwise indicated.

LEGENDS





Project Name:	KABUL MUNICIPALITY DESIGN TEAM		
Designing by:	Co-c-Sang To Designing		
Road project			
Drawing Title:	CROSS SECTIONS		
Designed by:	Signature: Mohammad Ehsa Siaat		
Drawn by:	Signature: Mohammad Ehsa Siaat		
Checked by:	Signature: Hashbulah Shalizi		
Date:	6/7/2023	Scale:	1:200
Status:	FINAL DESIGN		
Project Code:	CS-45	Revision:	00

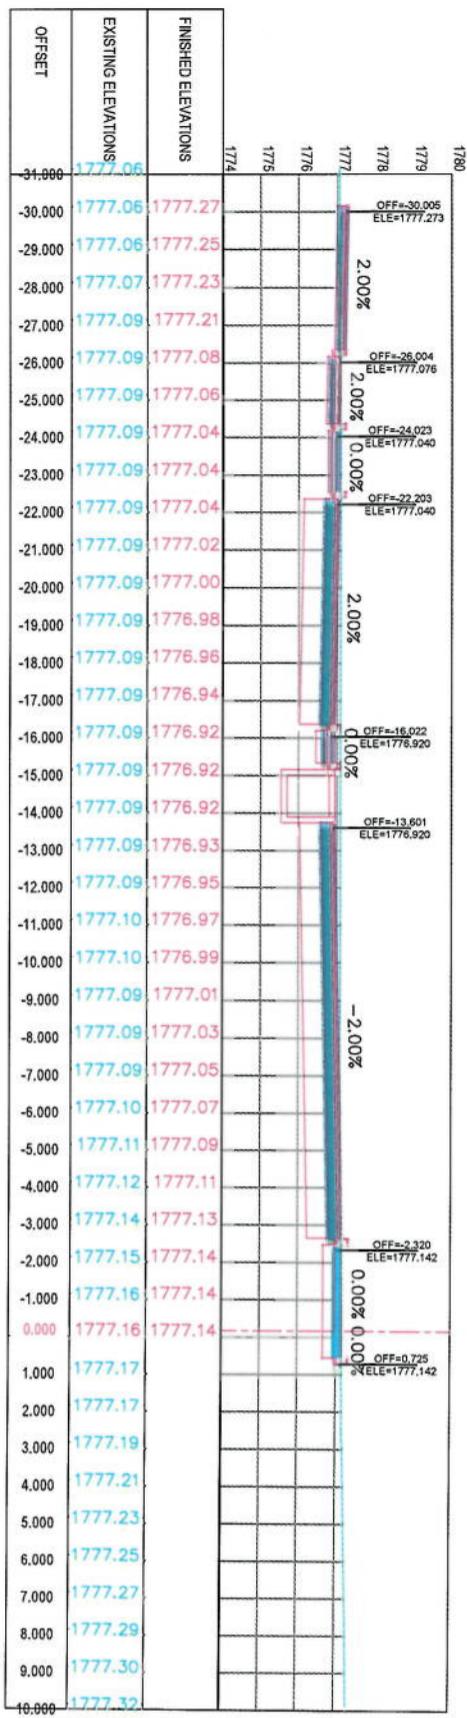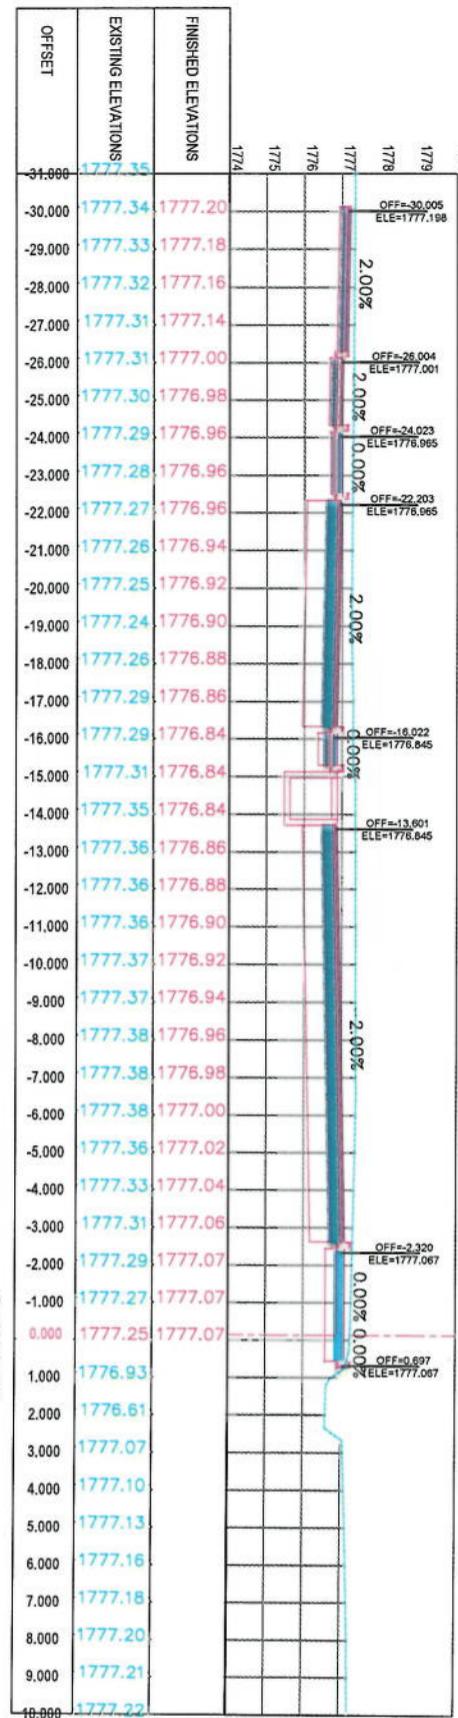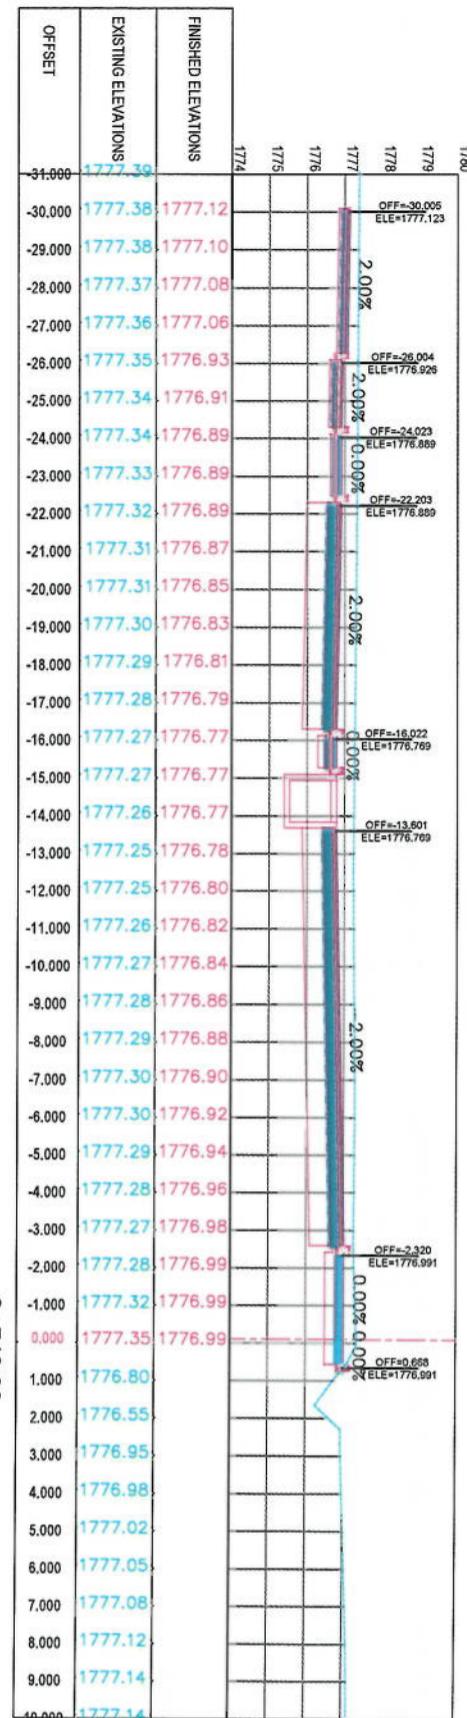

2+700.00

CROSS SECTIONS

Designed by: Mohammad Eisa Sint Signature: 

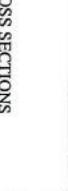Drew by: Mohammad Eisa Sint Signature: 

Checked by: Hafizullah Sint Signature: 

Drawing Title: FINAL DESIGN

Project Name: City-Sang To Demazang

Road project

ISLAMIC EMIRATE OF AFGHANISTAN KABUL MUNICIPALITY

Client: 


Designed by: KABUL MUNICIPALITY DESIGN TEAM

Drawing Number: CS-46 Revision: 00


Date: 6/7/2023 Scale: 1:200

Status: FINAL DESIGN

Project Code:

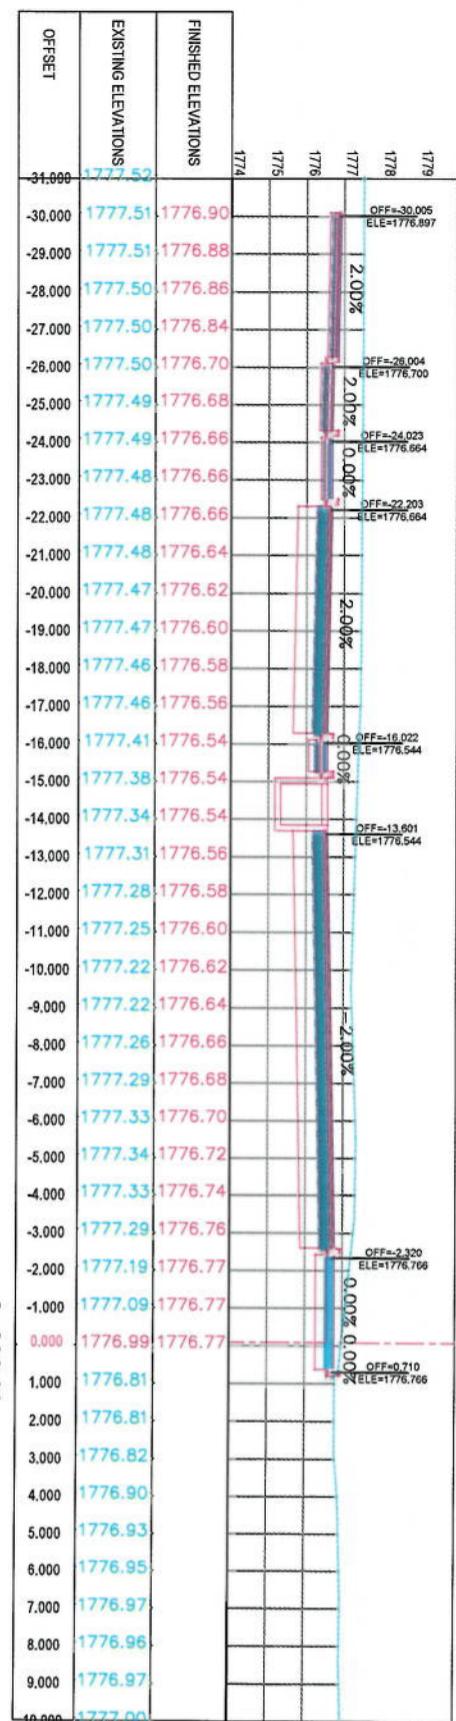

2+780.00

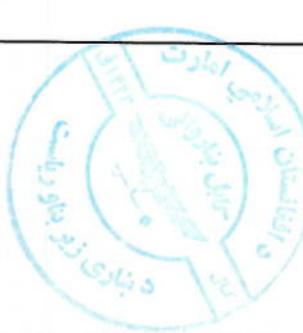


NOTE:

- All dimensions are in meters unless otherwise indicated


LEGENDS

- CENTER-LINE
- EXISTING SURFACE
- EXISTING SIDE DITCH

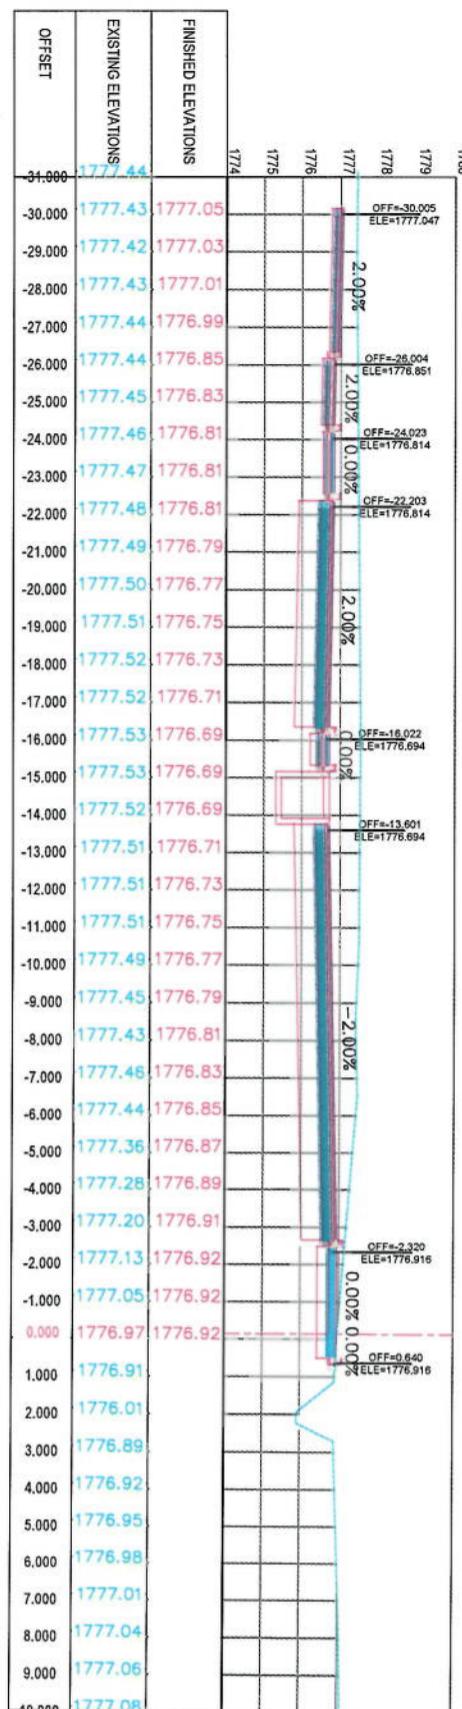

2+780.00

ISLAMIC EMIRATE OF AFGHANISTAN	
Designed by:	KABUL MUNICIPALITY
Project Name:	KABUL MUNICIPALITY
Co-Design To:	
Drawing Title:	Road Project
CROSS SECTIONS	
Designed By:	Signature:
Drawn By:	Signature:
Checked by:	Signature:
Date:	6/7/2023
Scale:	1:200
Status:	FINAL DESIGN
Project Code:	
Drawing Number:	CS-47
Revision:	00

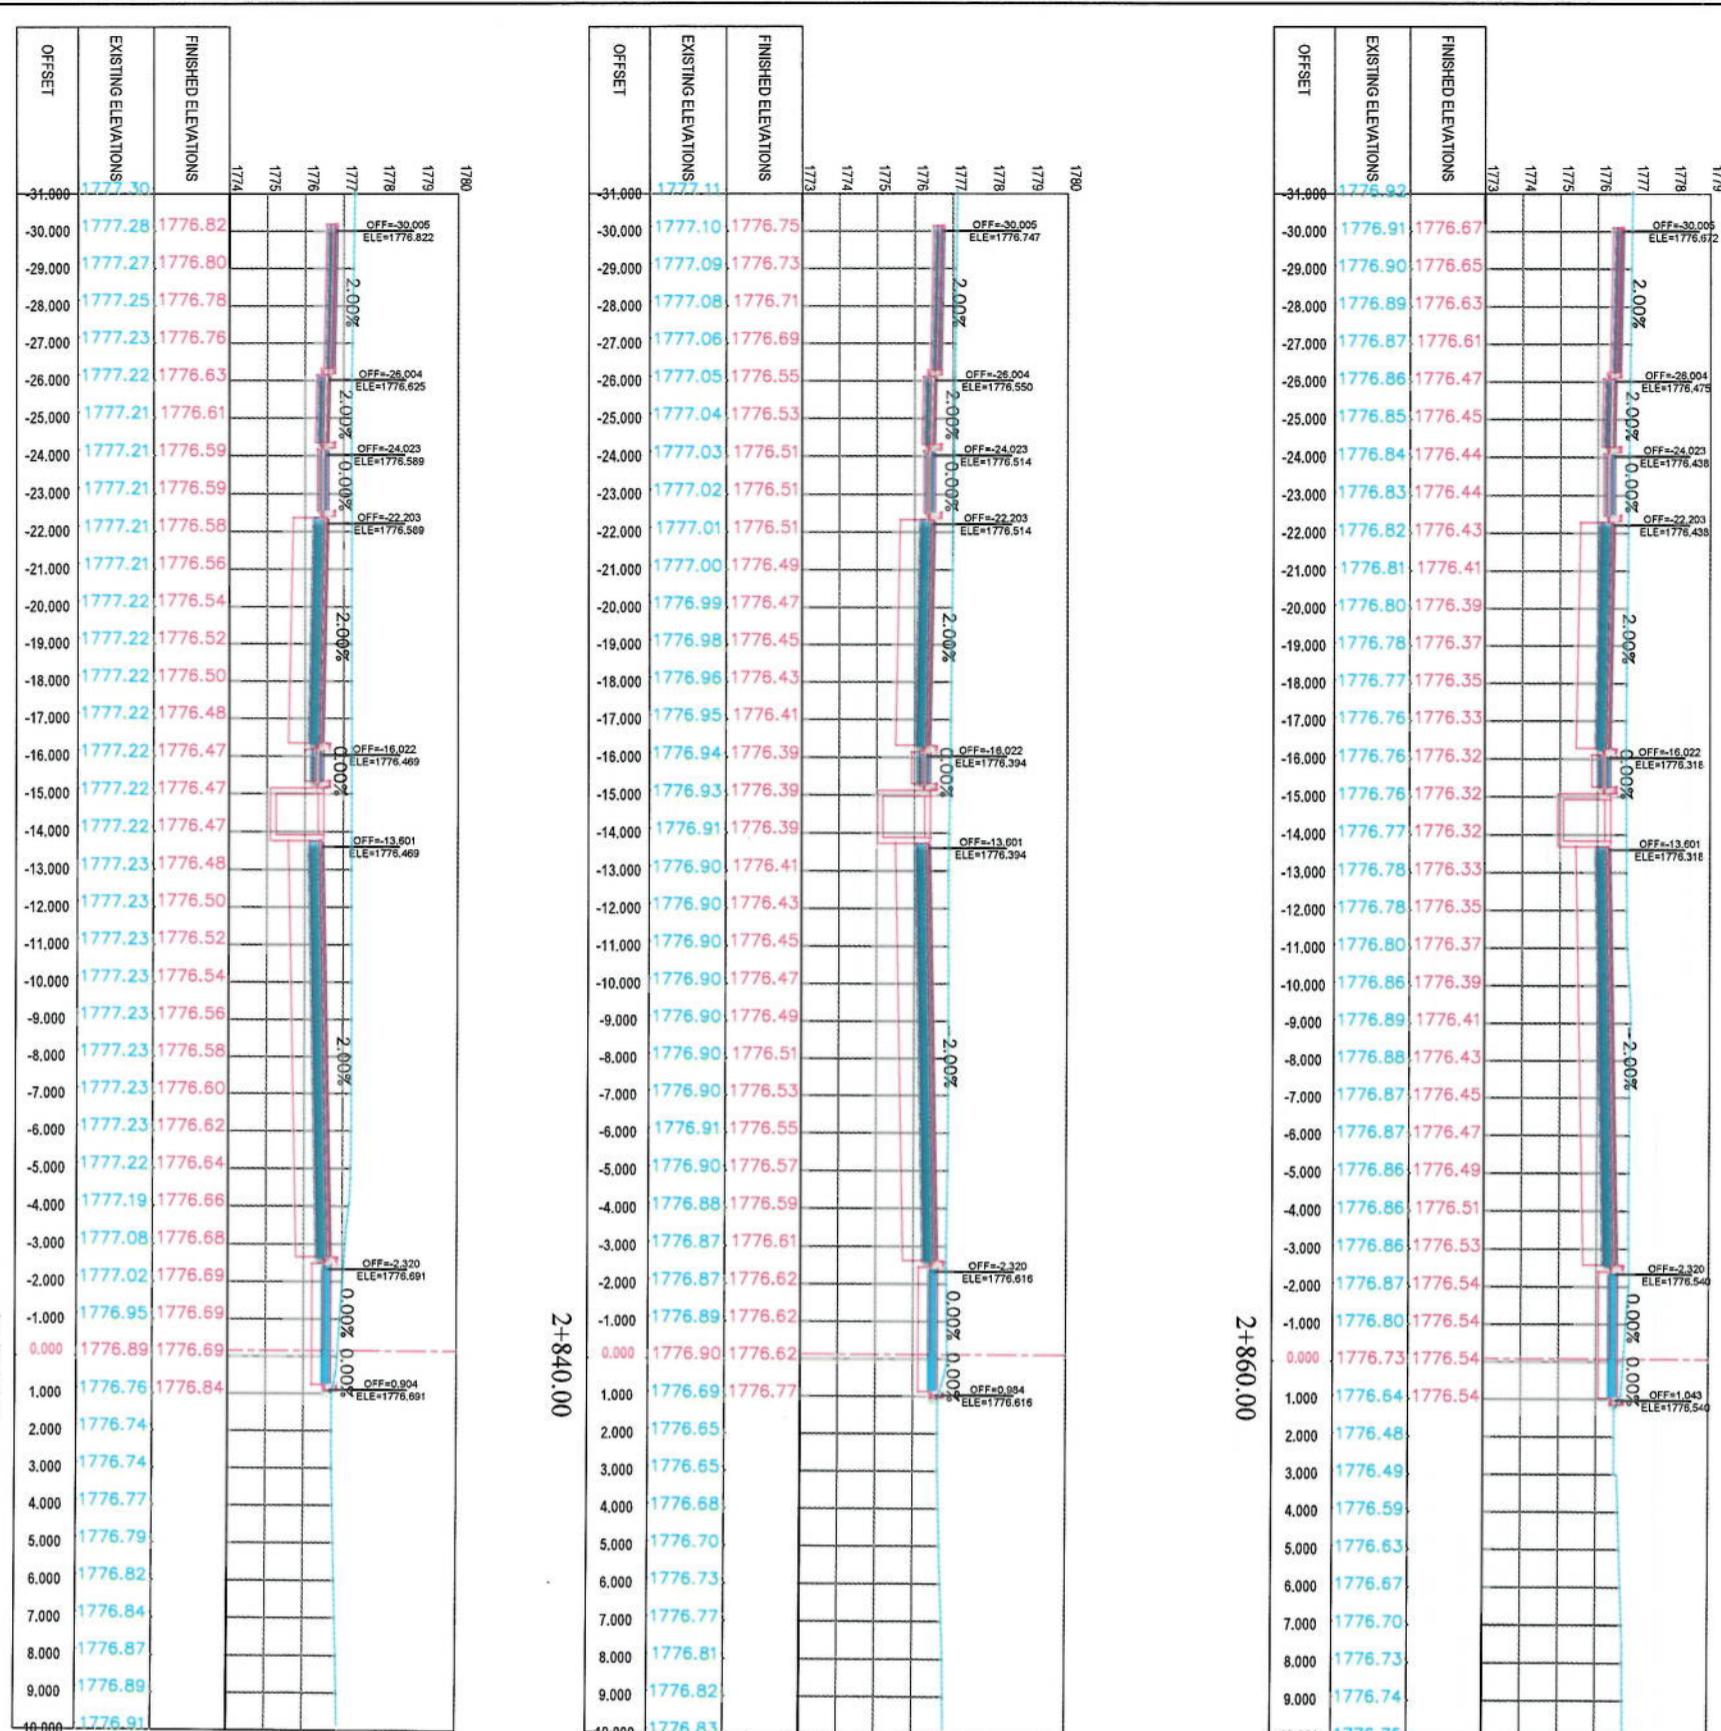


NOTE

1. All dimensions are in meters unless otherwise indicated

LEGENDS
CENTER-LINE
EXISTING SURFACE




Project Code	CS-48	Revision	00
Drawing Number			
Date	6/7/2023	Scale	1:200
Status:	FINAL DESIGN		

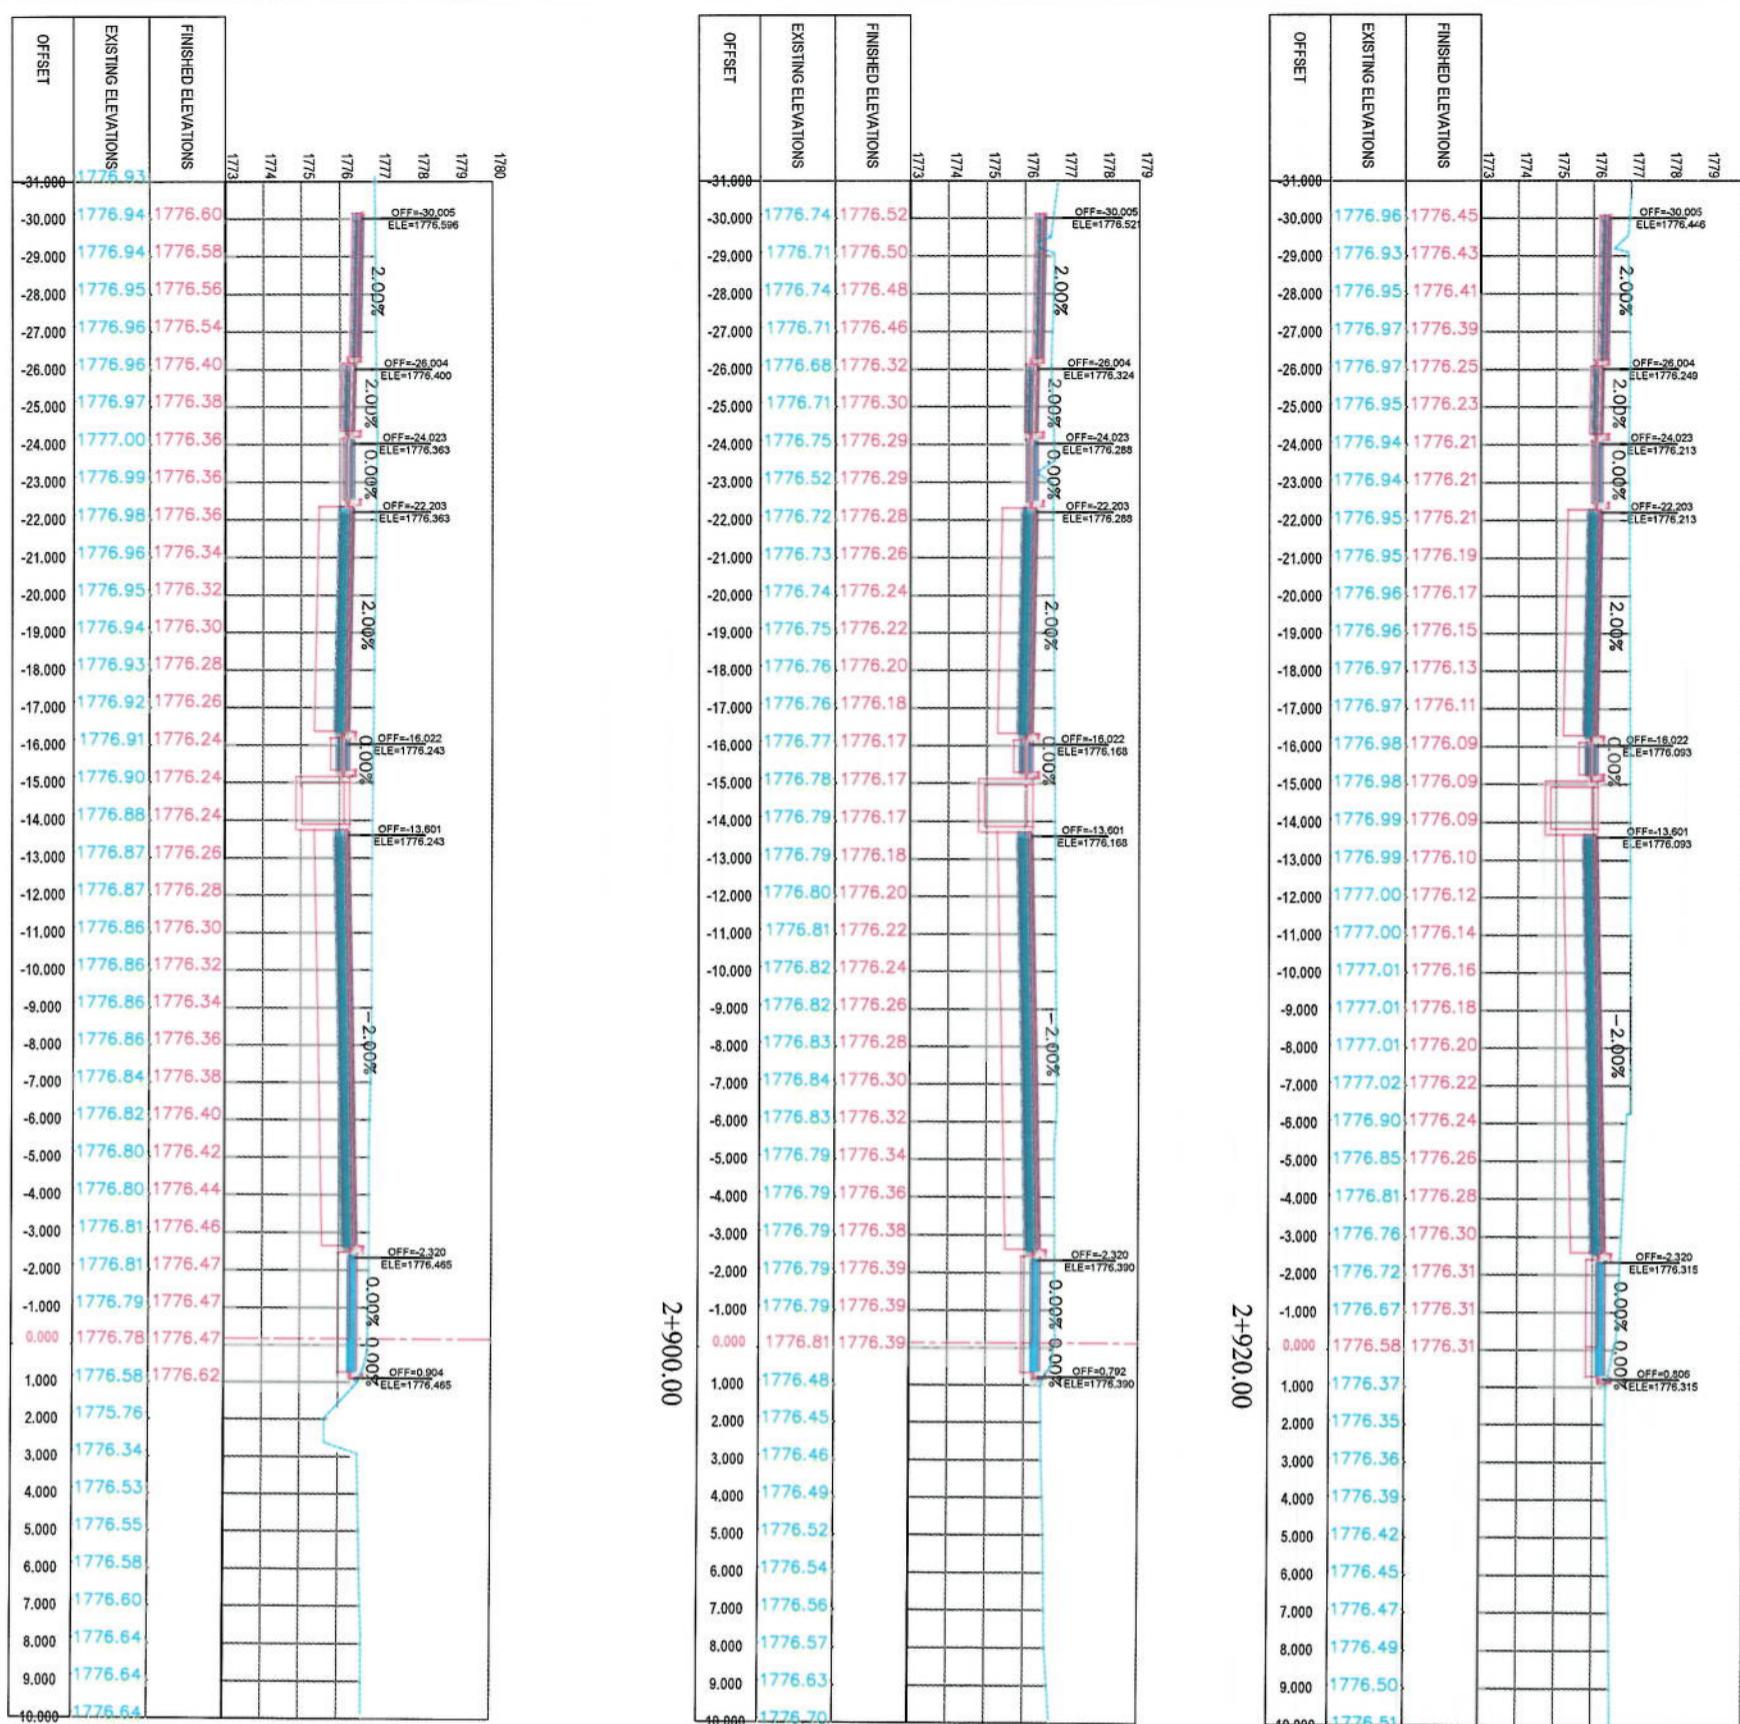

NOTE:


1. All dimensions are in meters unless otherwise indicated

LEGENDS
CENTER-LINE
EXISTING SURFACE

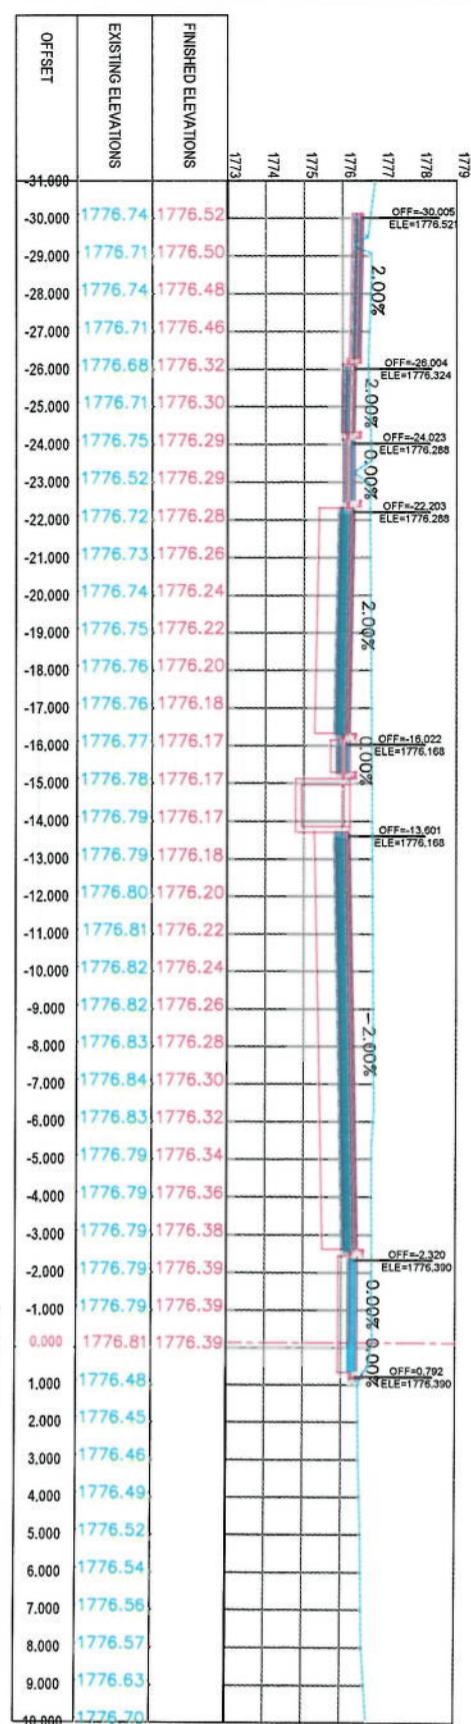


2+880.00

Project Code	Revision
CS-49	00


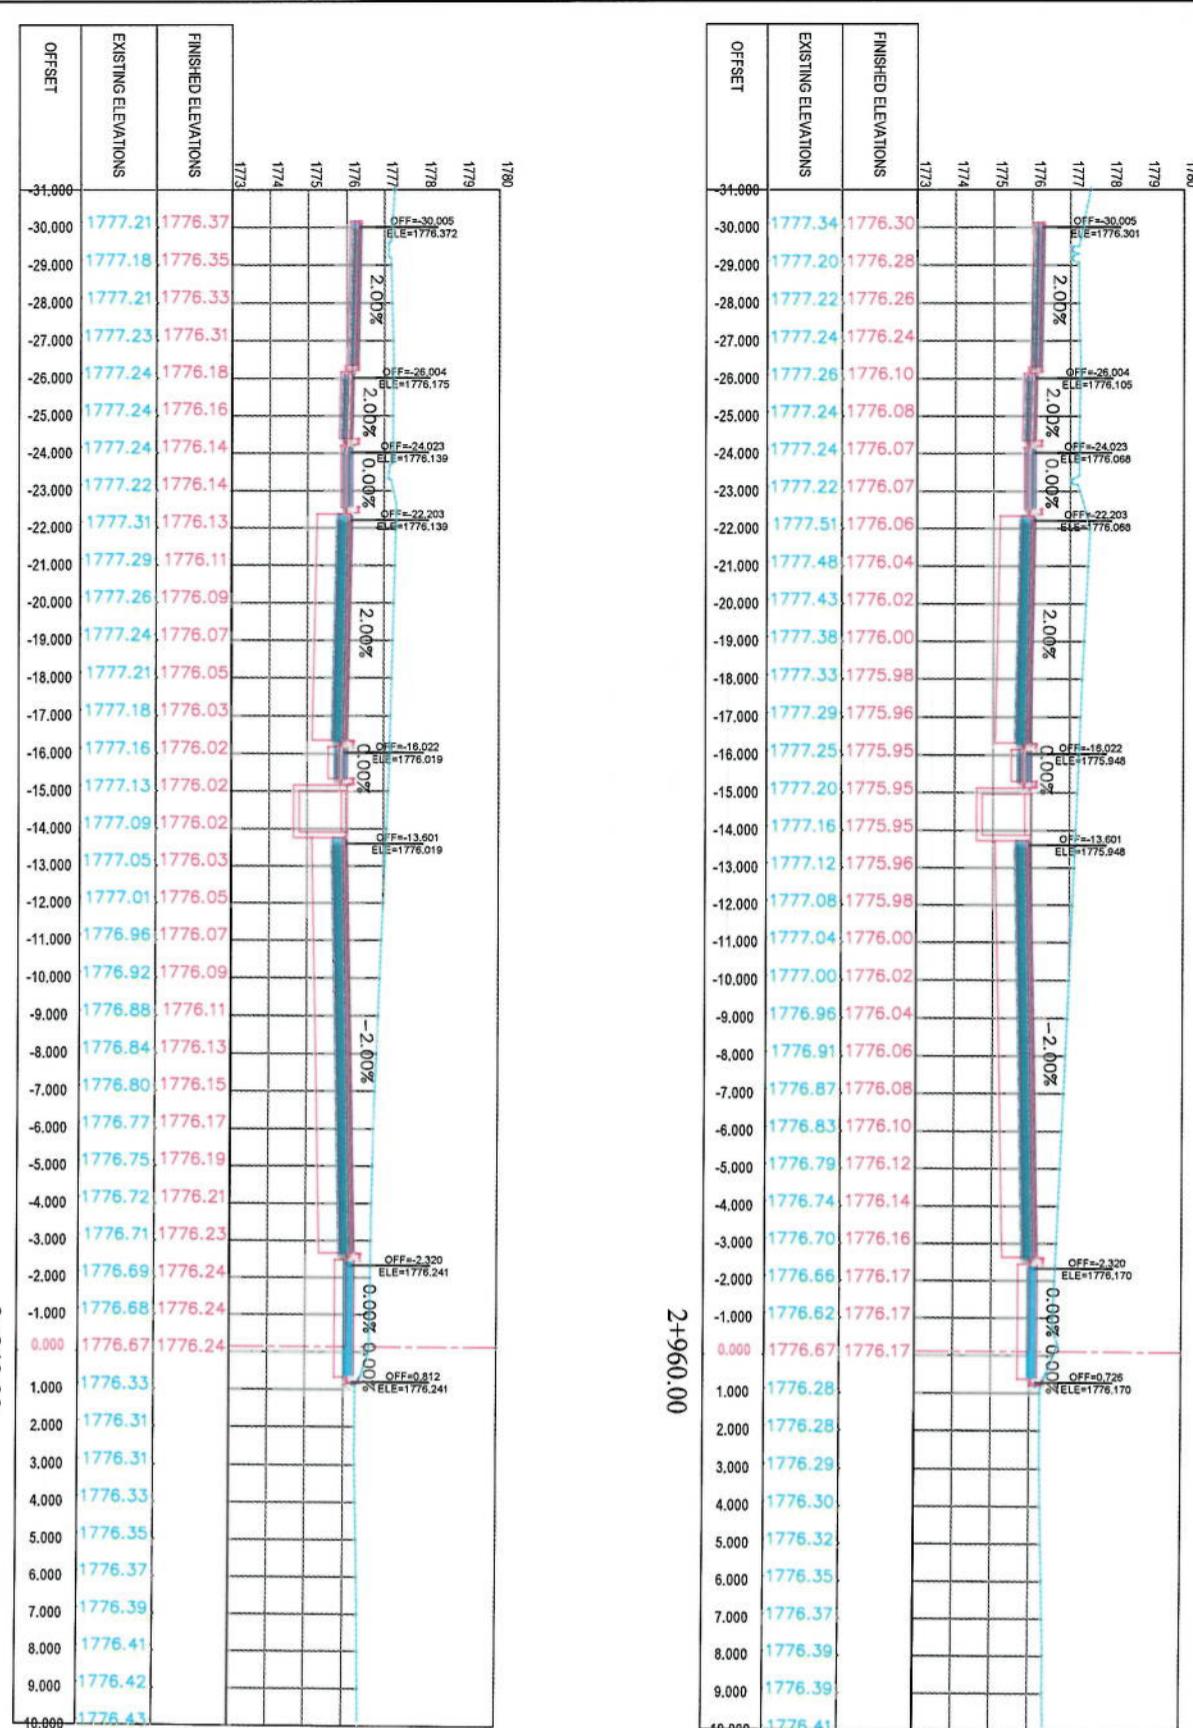


NOTE:
1. All dimensions are in meters unless otherwise indicated


LEGENDS
 CENTER-LINE
 EXISTING SURFACE
 EXISTING SIDE DITCH

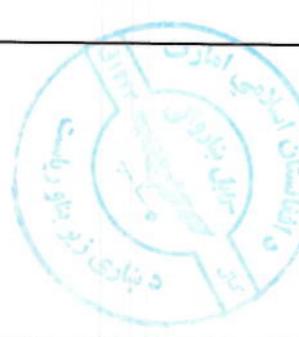

CROSS SECTIONS	
Designed by:	Signature
Mohammad Fasal Sial	Signature
Drafter:	Signature
Mohammad Ishaq Sial	Signature
Checked by:	Signature
Hastullah Sialzi	Signature
Date: 6/7/2023	Scale: 1:200
Status: FINAL DESIGN	Project Code: CS-50
Drawing Number: CS-50	Revision: 00

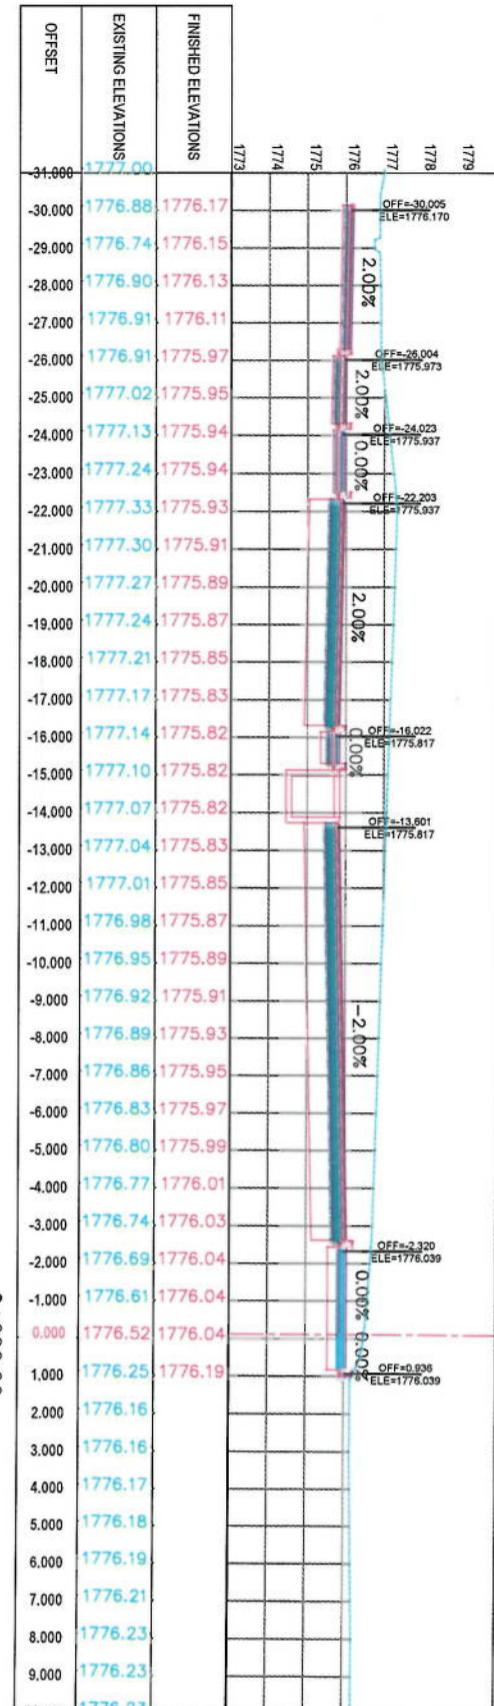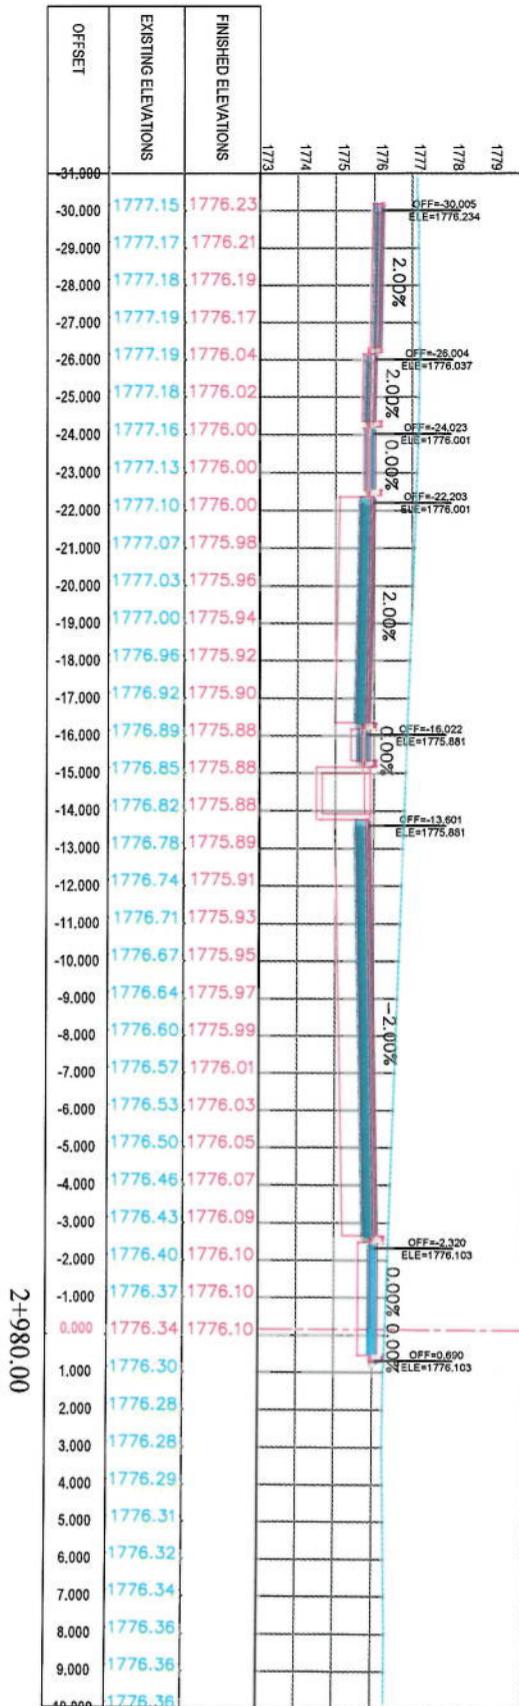

2+980.00

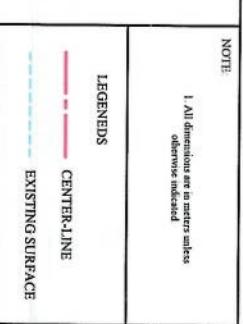


NOTE:

1. All dimensions are in meters unless otherwise indicated


LEGENDS

- CENTER-LINE
- EXISTING SURFACE
- EXISTING SIDE DITCH


Project Name:	ISLAMIC EMIRATE OF AFGHANISTAN		
Designed by:	KABUL MUNICIPALITY		
Coe-Sang To Pemazang	KABUL MUNICIPALITY		
Road Project			
Drawing Title:	CROSS SECTIONS		
Designed By:	Signature:	Date: 6/7/2023	Scale: 1:200
Drawn By:	Signature:		
Checked by:	Signature:		
Project Code:	FINAL DESIGN		
Drawing Number:	CS-51	Revision: 00	

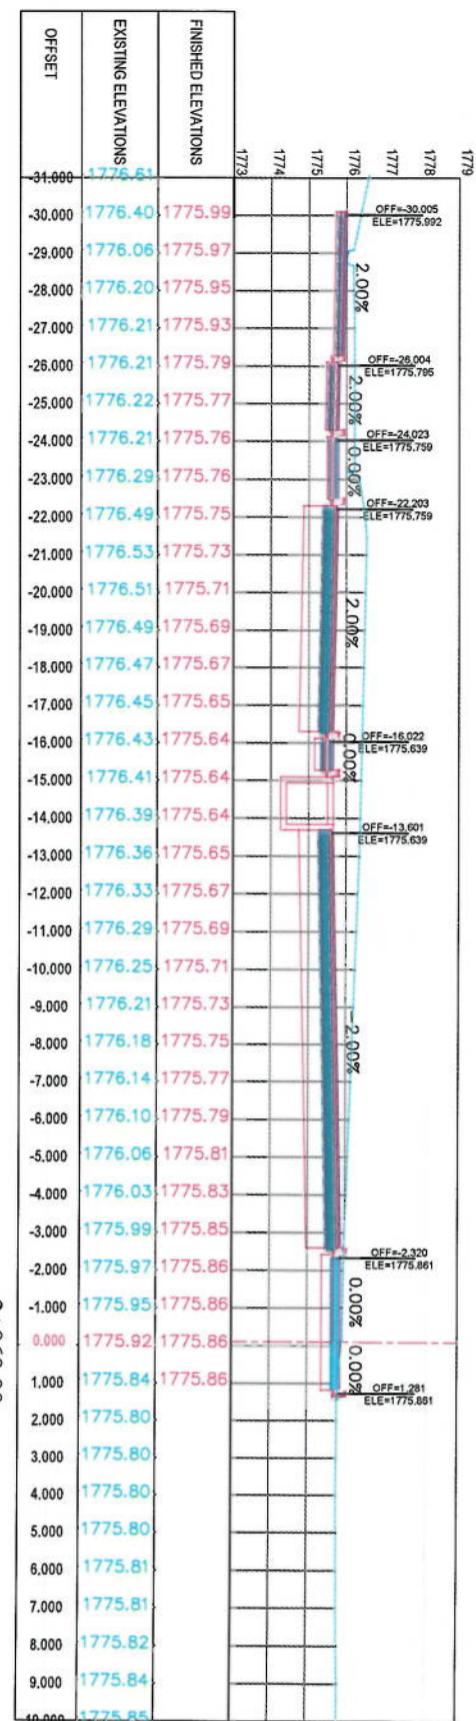

3+060.00

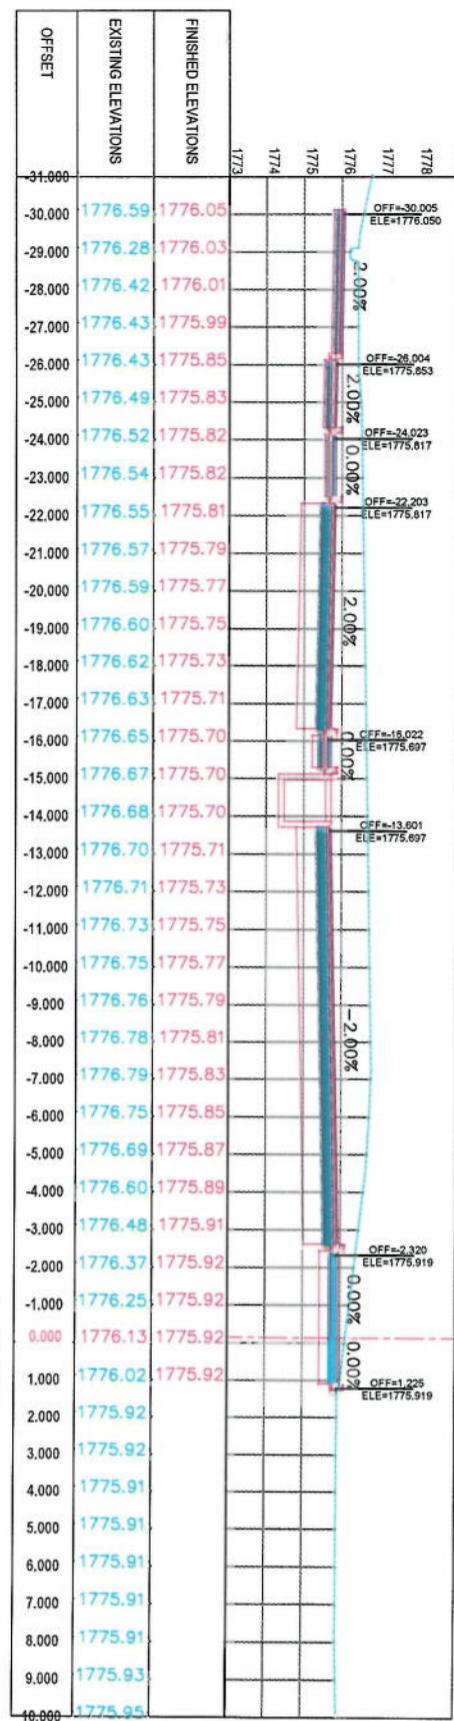

3+040.00

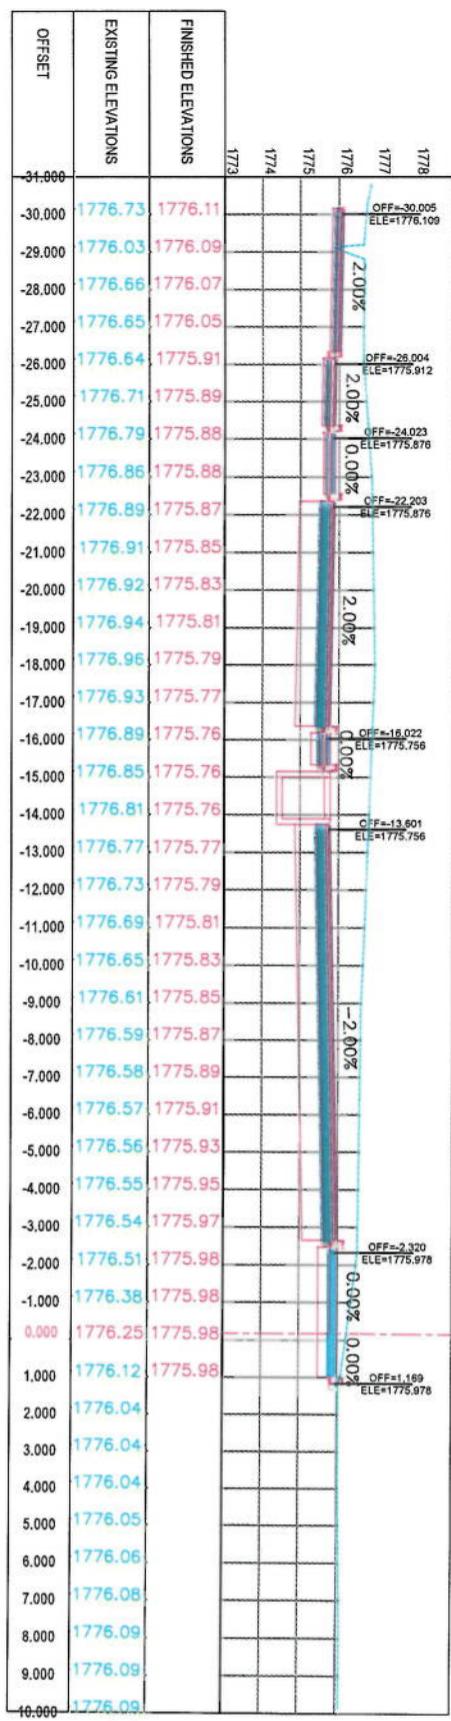**CROSS SECTIONS**

Designed by:
Mohammad Esa Sint
Drawn by:
Mohammad Esa Sint
Checked by:
Hasanullah Shahzai

KABUL MUNICIPALITY
DESIGN TEAM
Client:
ISLAMIC EMIRATE OF
AFGHANISTAN

Drawing Title:



LEGENDS

- CENTER-LINE
- EXISTING SURFACE
- EXISTING SIDE DITCH

NOTE:
1. All dimensions are in meters unless otherwise indicated.




Project Name:
Co-e-Sang To Benazang
Road project

Status: FINAL DESIGN

Drawing Number: CS-52

Revision: 00


3+020.00

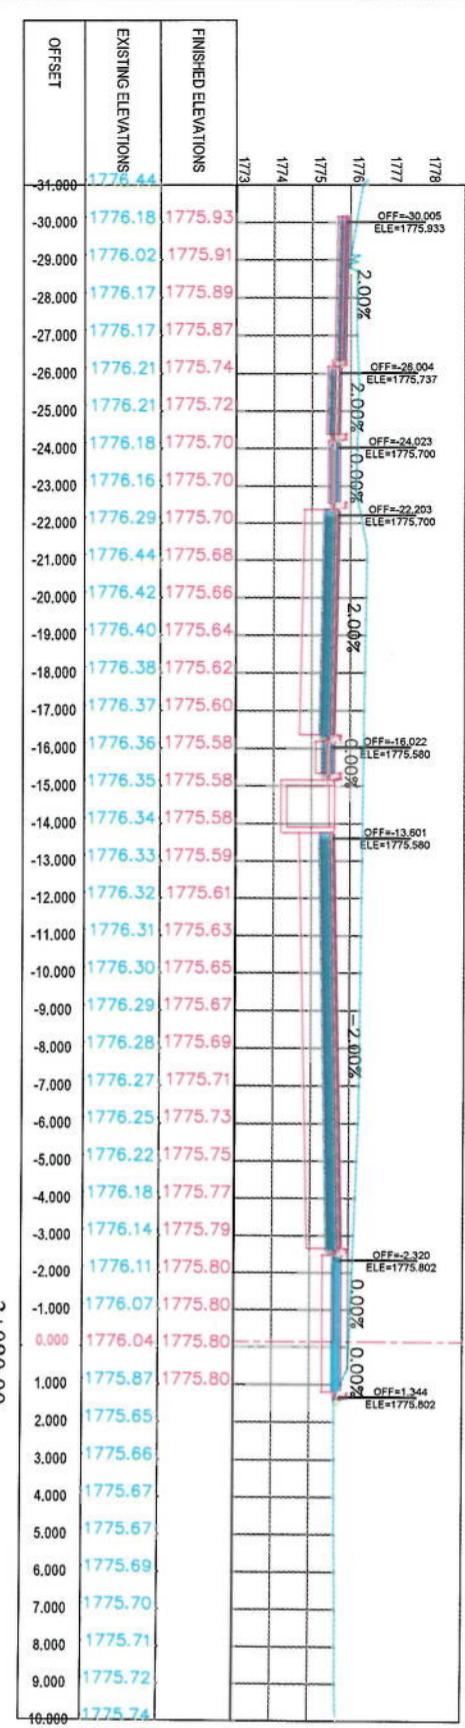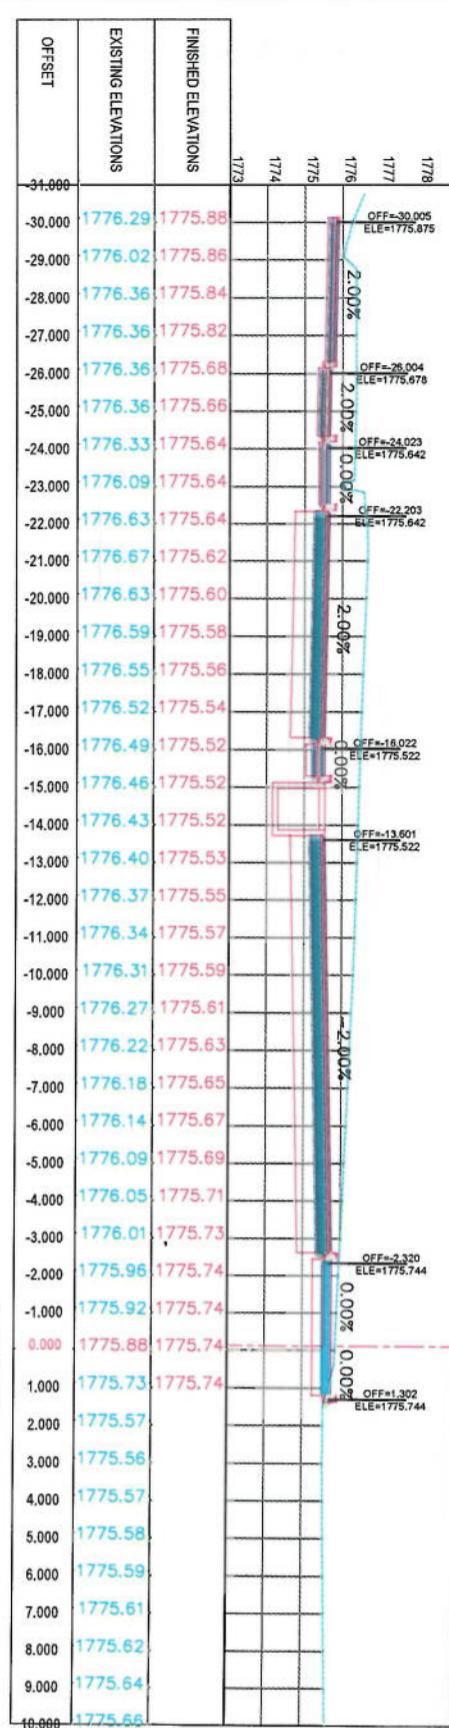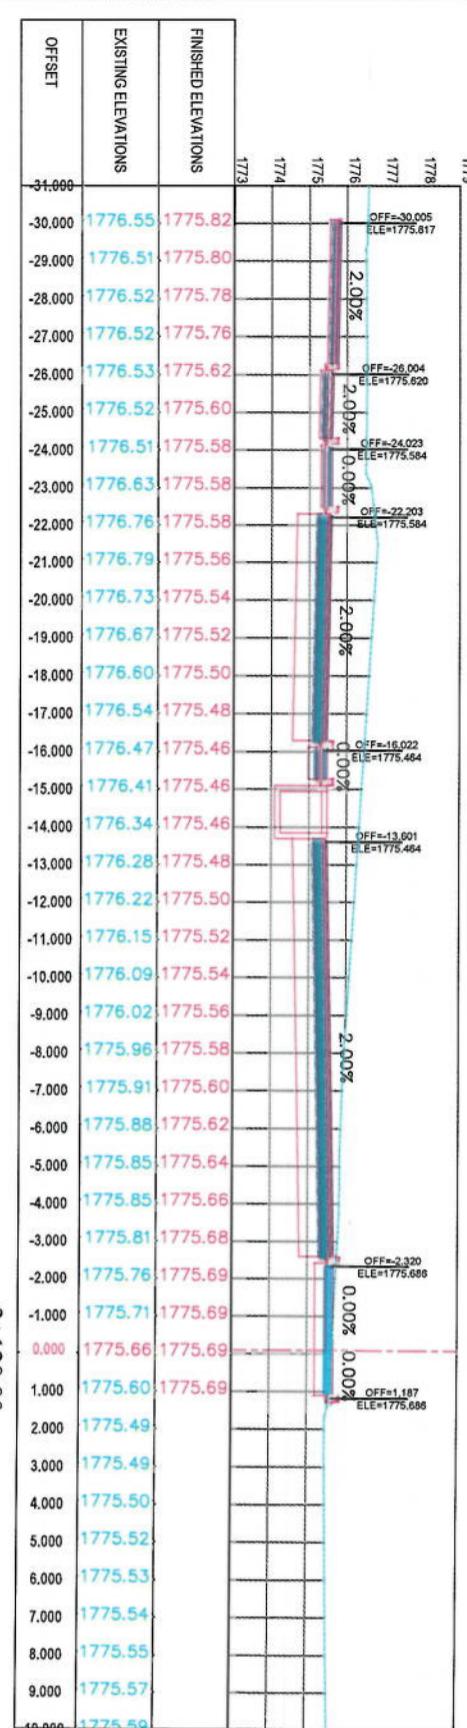

LEGENDS
 CENTER-LINE
 EXISTING SURFACE
 EXISTING SIDE DITCH

NOTE:
1. All dimensions are in meters unless otherwise indicated

Designed by:	Signature:
Drafter by:	Signature:
Checked by:	Signature:
Drawn by:	Signature:
Project Name:	KABUL MUNICIPALITY DESIGN TEAM
Cert-Sign To Demarcate	Road project
Drawing Title:	CROSS SECTIONS
Designed by:	Signature:
Date:	6/7/2023
Scale:	1:200
Status:	FINAL DESIGN
Project Code:	
Drawing Number:	CS-53
Revision:	00

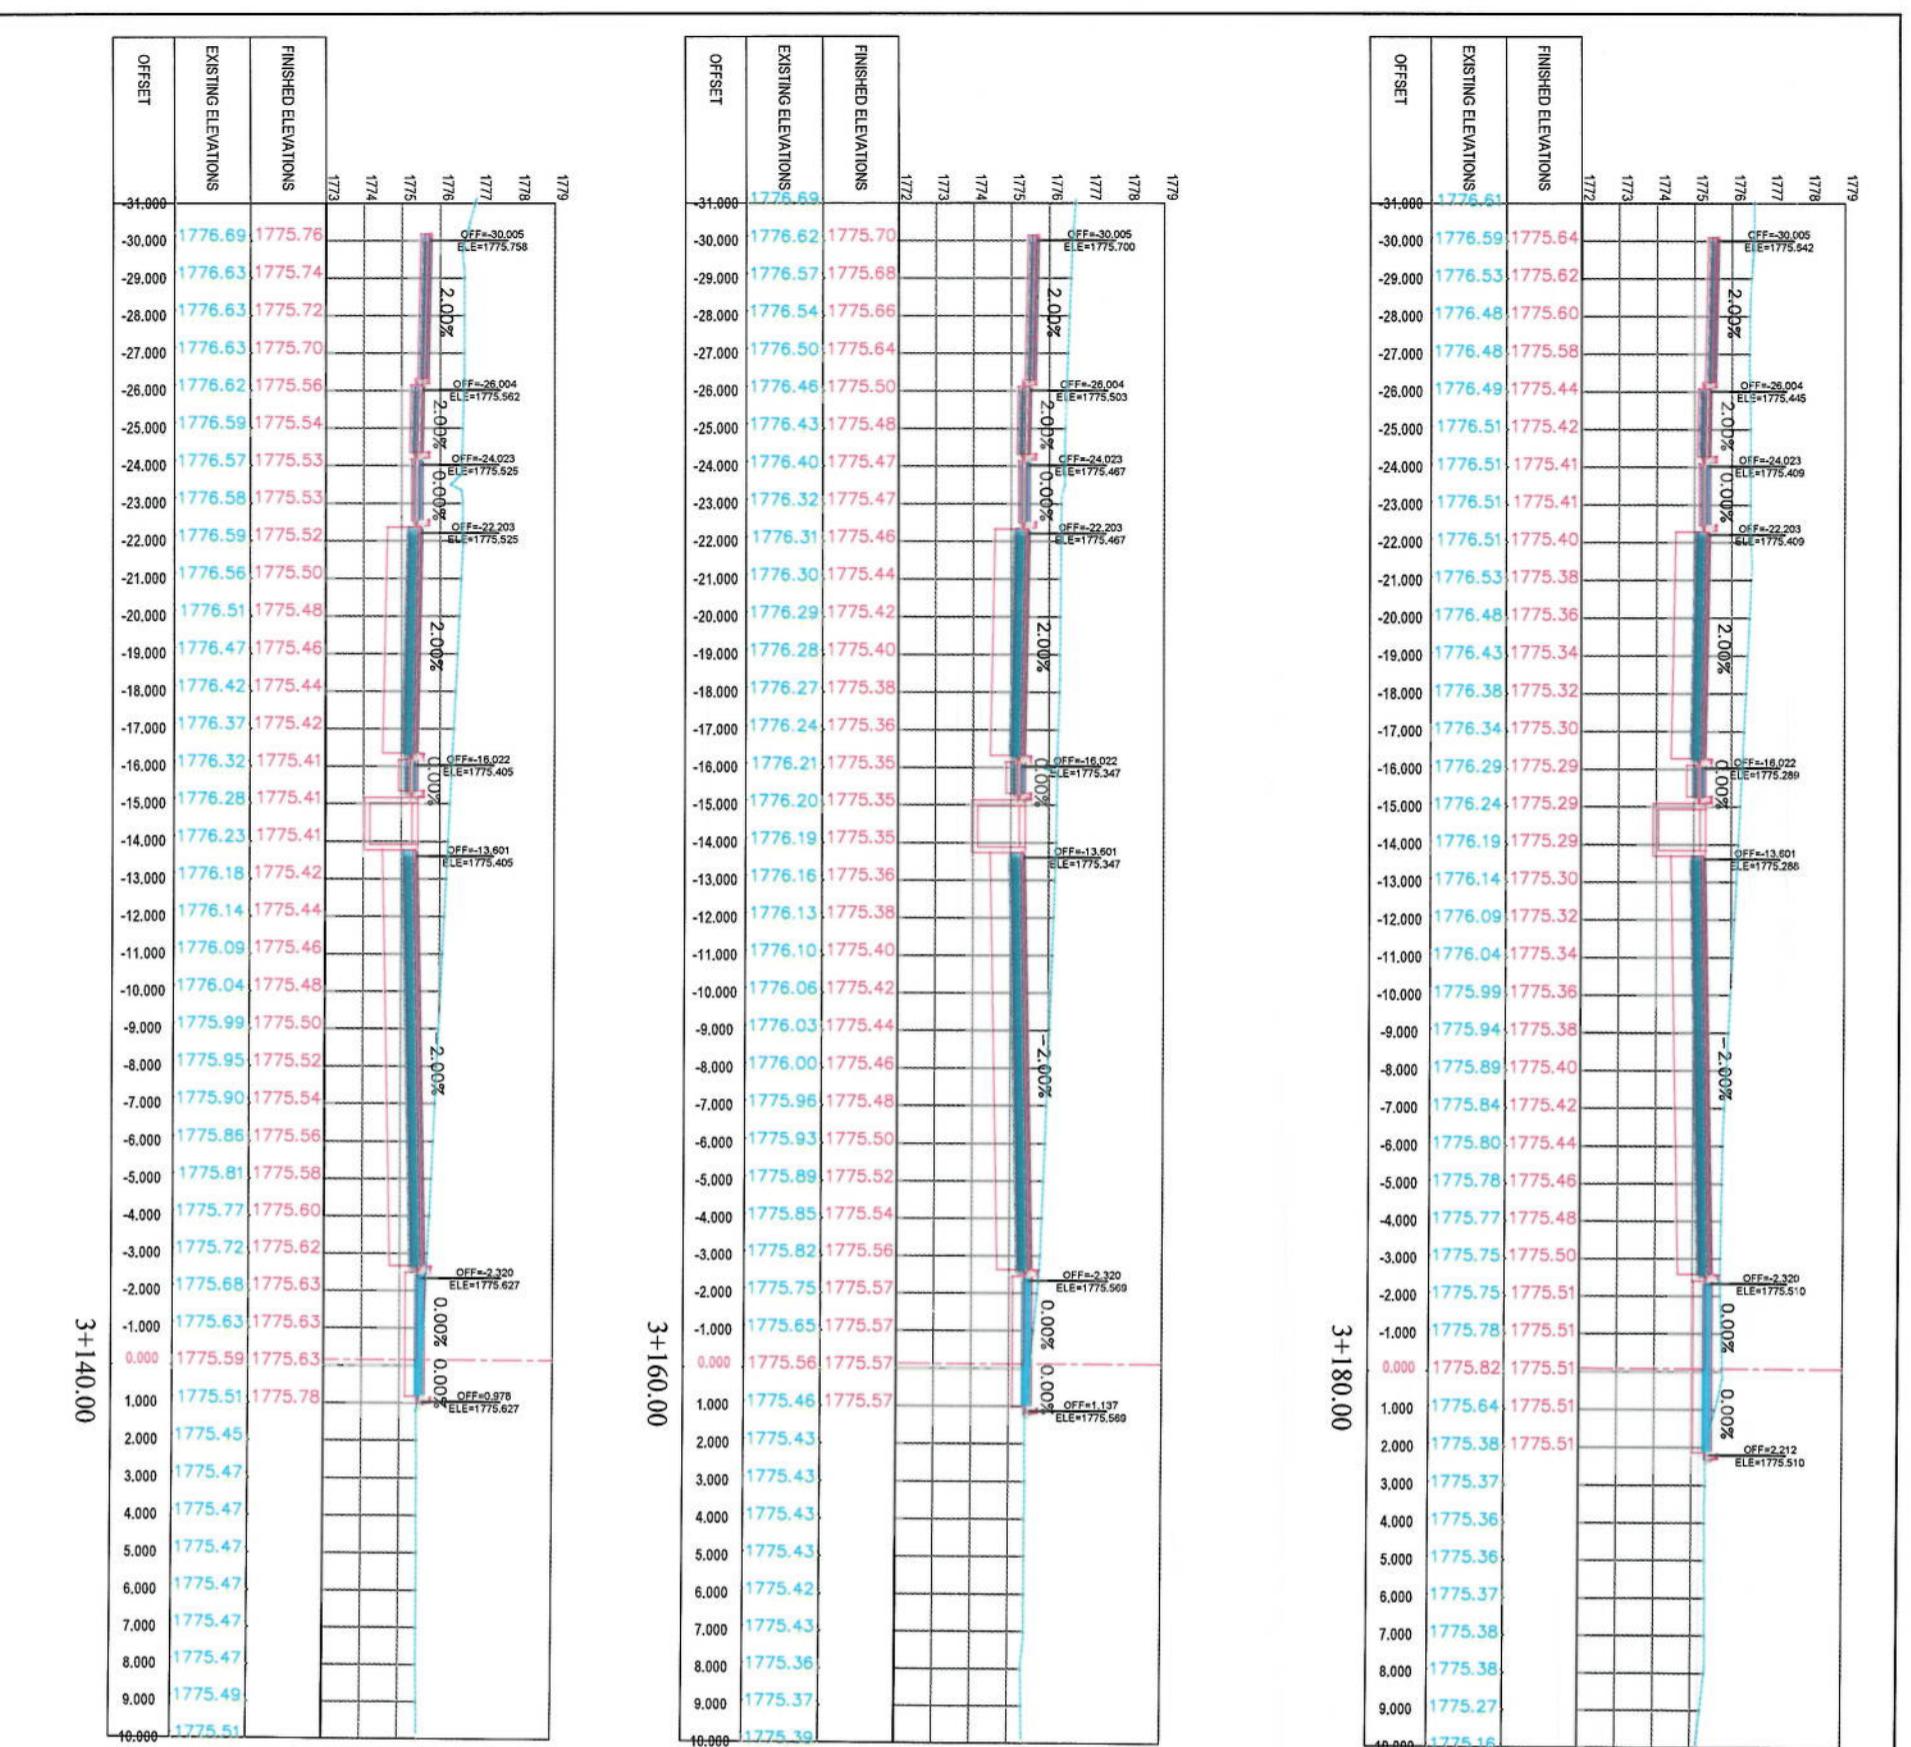

NOTE:

1. All dimensions are in meters unless otherwise indicated.

LEGENDS

- CENTER-LINE
- - - EXISTING SURFACE
- EXISTING SIDE-DITCH

Project Code:	CS-54
Drawing Number:	00
Date:	6/7/2023
Scale:	1:200
Status:	FINAL DESIGN

CROSS SECTIONS

Designed by:	KABUL MUNICIPALITY DESIGN TEAM
Project Name:	ISLAMIC EMIRATE OF AFGHANISTAN
Contractor:	KABUL MUNICIPALITY
Drawn by:	Client
Checked by:	
Approved by:	
Comments:	



Designed by:
KABUL MUNICIPALITY
DESIGN TEAM


Project Name:
Conc-Slag To Demazang
Road project
Drawing Title:
CROSS SECTIONS

Designed by:
ISLAMIC EMIRATE OF
AFGHANISTAN

Client
KABUL MUNICIPALITY

Signature:

<p

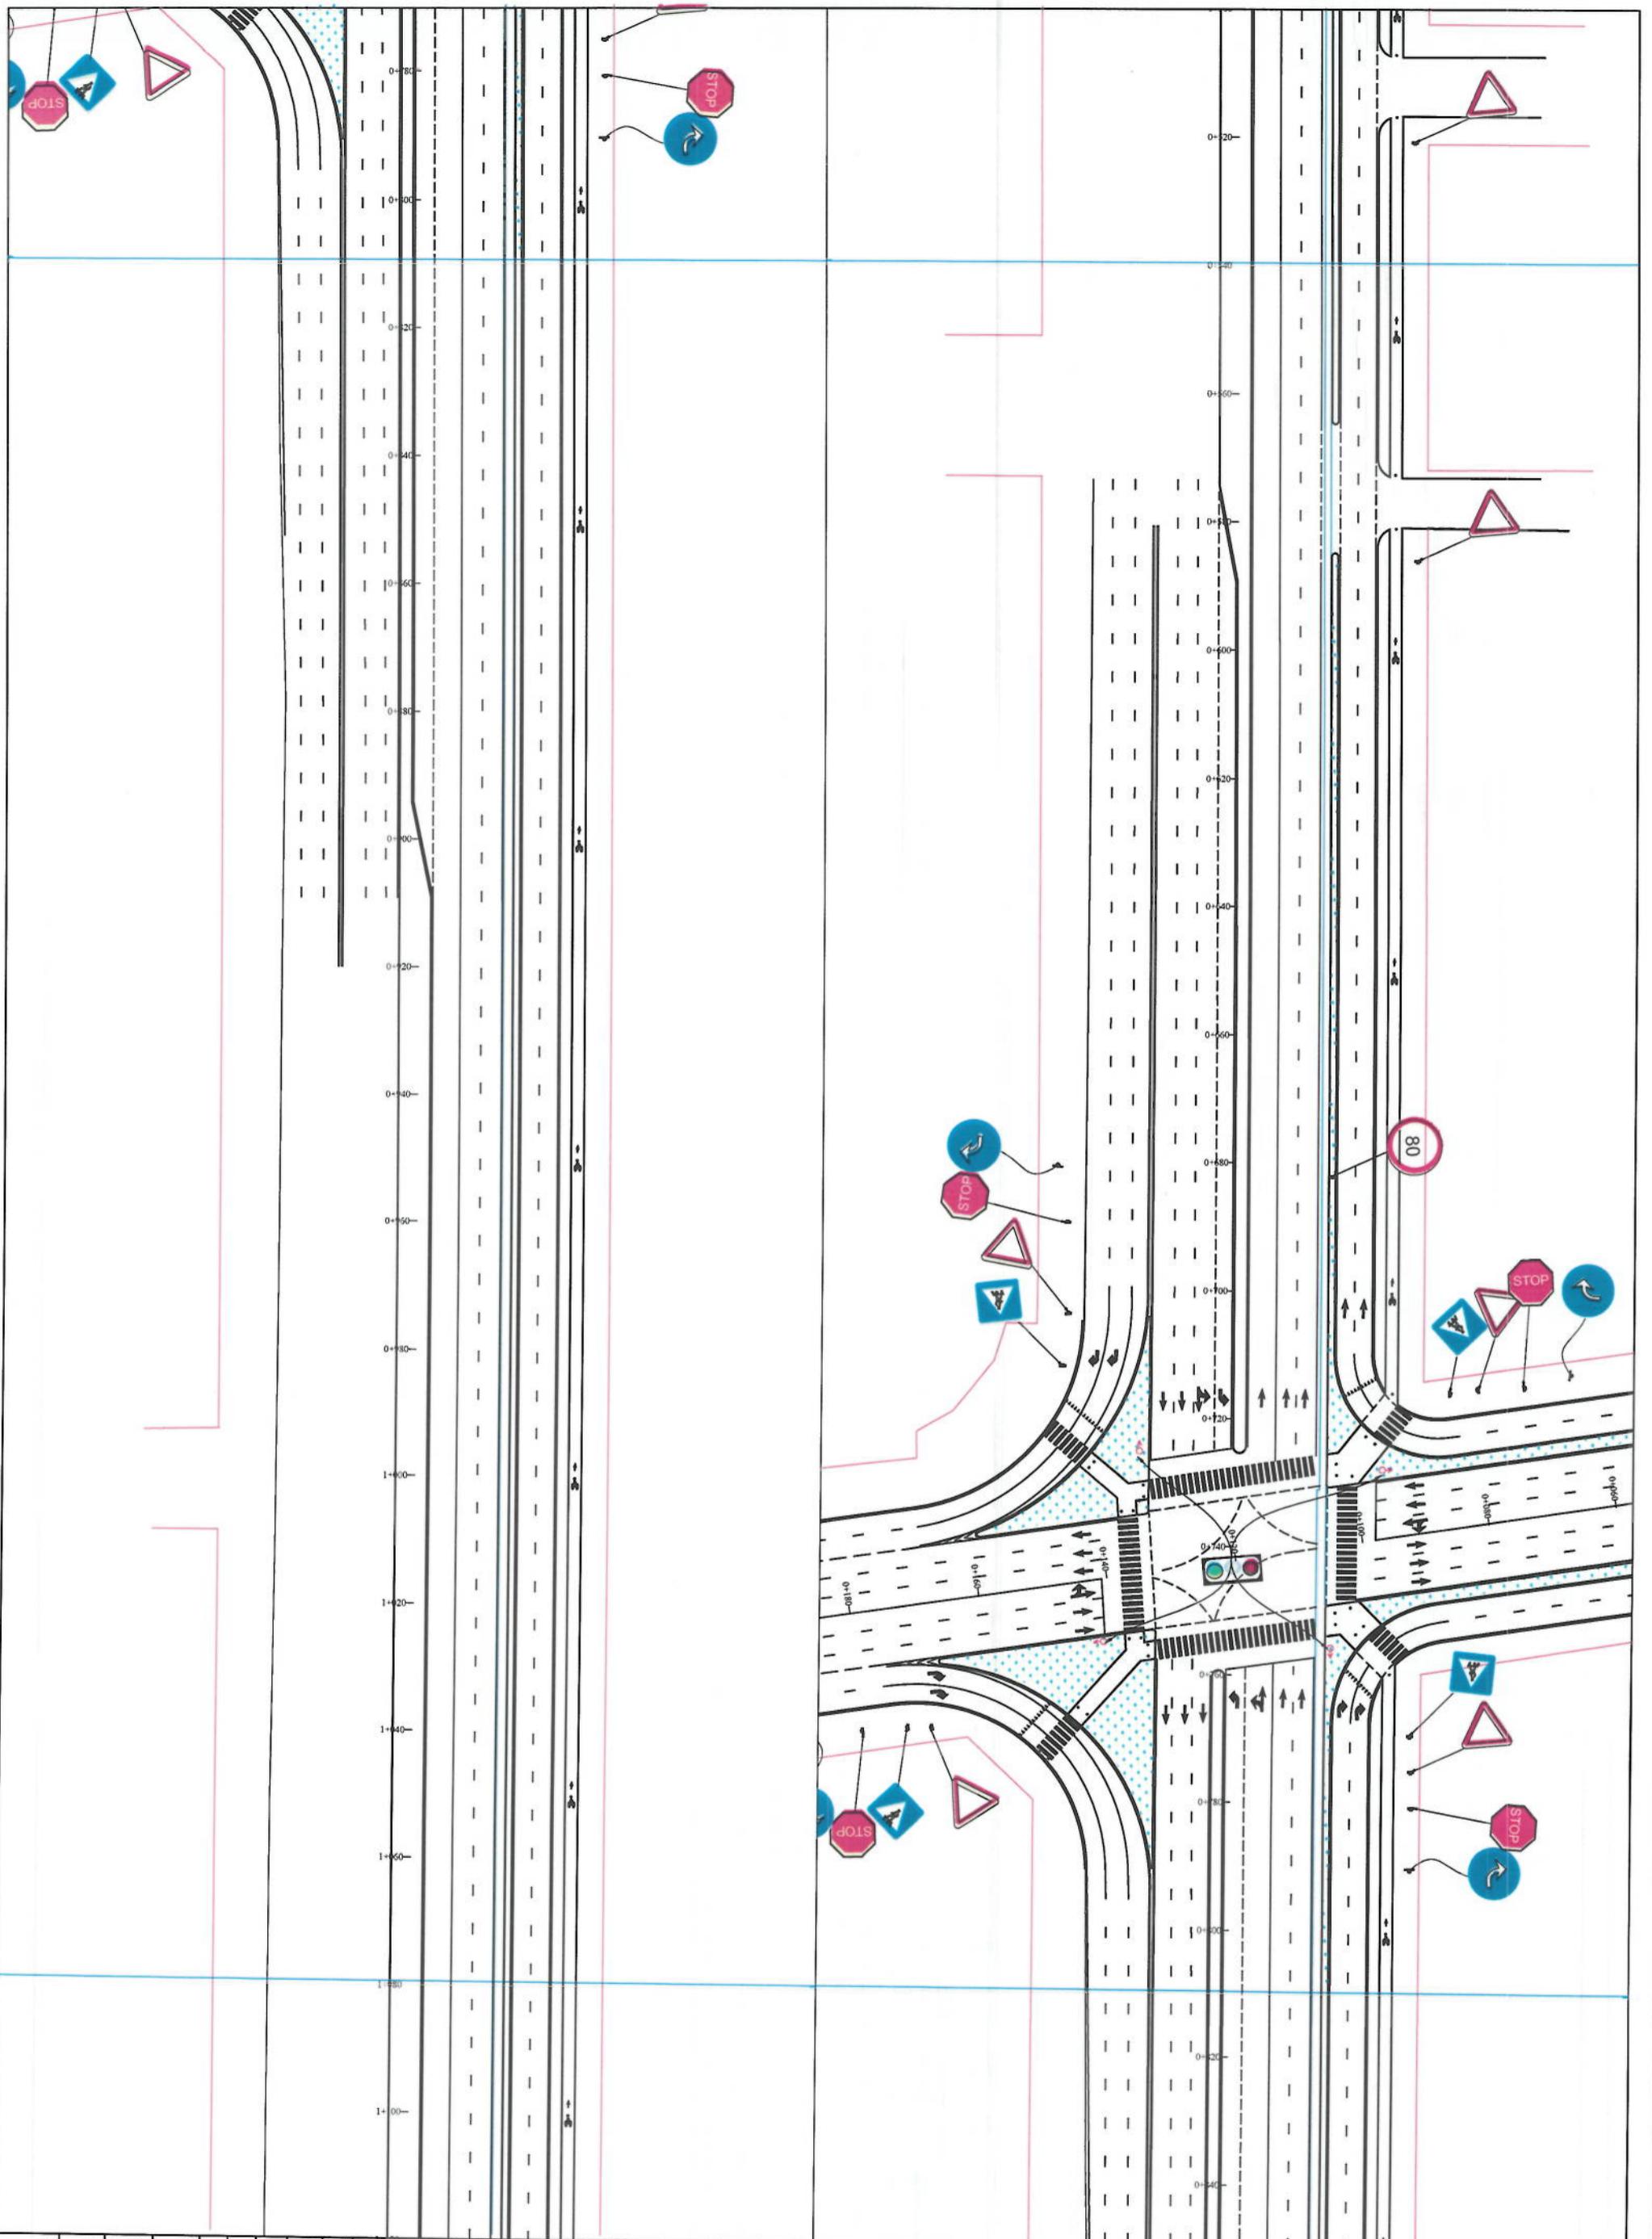

ROAD MARKING	
Designed by:	KABUL MUNICIPALITY DESIGN TEAM
Drawn by:	Mohammed Esa Sint
Checked by:	Hassanullah Shauzai
Date:	6/8/2023
Project Code:	FINAL DESIGN
Drawing Number	Rm-2
Revision	00



NOTE:
1. All dimensions are in meters unless otherwise indicated

LEGENDS	
	CENTER-LINE
	EXISTING SURFACE
	EXISTING SIDE DITCH



Date	Revision Details	Drawn

ISLAMIC EMIRATE OF
AFGHANISTAN

Designed by:
KABUL MUNICIPALITY
Client:

Project Name:
Co-e-Sang To Delamzang
Road Project

Drawing Title:

ROAD MARKING

Designed by:
Mohammad Esa Sial

Signature:

Drawn by:
Mohammad Esa Sial

Signature:

Checked by:
Hasbullah Shauzi

Signature:

Date: 6/8/2023
Scale: 1:1000
Status: FINAL DESIGN

Project Code: PPP-3
Drawing Number: 00
Revision:

NOTE:

1. All dimensions are in meters unless otherwise indicated.

LEGENDS

— CENTER-LINE

- - - EXISTING SURFACE

EXISTING SIDE DITCH



Date	Revision Details	Drawn By

ISLAMIC EMIRATE OF
AFGHANISTAN

Client:



Designed by:
KABUL MUNICIPALITY
DESIGN TEAM

Project Name:
Cite-e-Sangi To Delmangal

Road Project

Drawing Title:

ROAD MARKING

Designed by:
Mohammad Eesa Sirl

Signature:

Drawn by:
Signature:

Checked by:
Hasibullah Shairzai

Signature:

Date: 6/8/2023
Scale: 1:1000
Status: FINAL DESIGN

Project Code:

NOTE:

1. All dimensions are in meters unless otherwise indicated.

LEGENDS

CENTER-LINE

EXISTING SURFACE

EXISTING SIDE DITCH



ISLAMIC EMIRATE OF
AFGHANISTAN



Designed by:
KABUL MUNICIPALITY
DESIGN TEAM

Project Name:
Cote-Sangji To Dohmangan
Road Project

Drawing Title:

ROAD MARKING

Designed by:
Mohammad Esa Sifat

Signature:

Drawn by:
Mohammad Esa Sifat

Signature:

Checked by:
Hasbullah Shauzi

Signature:

Date:
6/8/2023

Scale:
1:1000

Status:
FINAL DESIGN

Project Code:

Drawing Number:

PP-5



Revision
00

NOTE:

1. All dimensions are in meters unless otherwise indicated

LEGENDS

— CENTER-LINE
- - - EXISTING SURFACE
— EXISTING SIDE DITCH

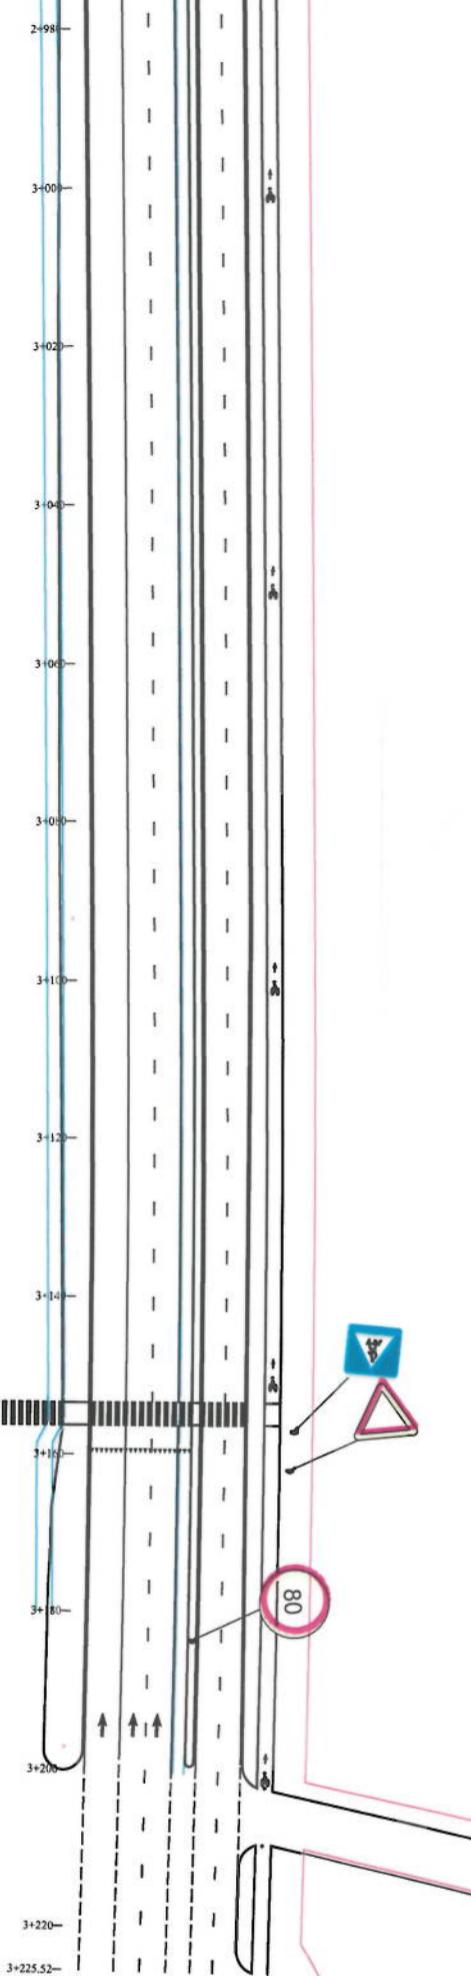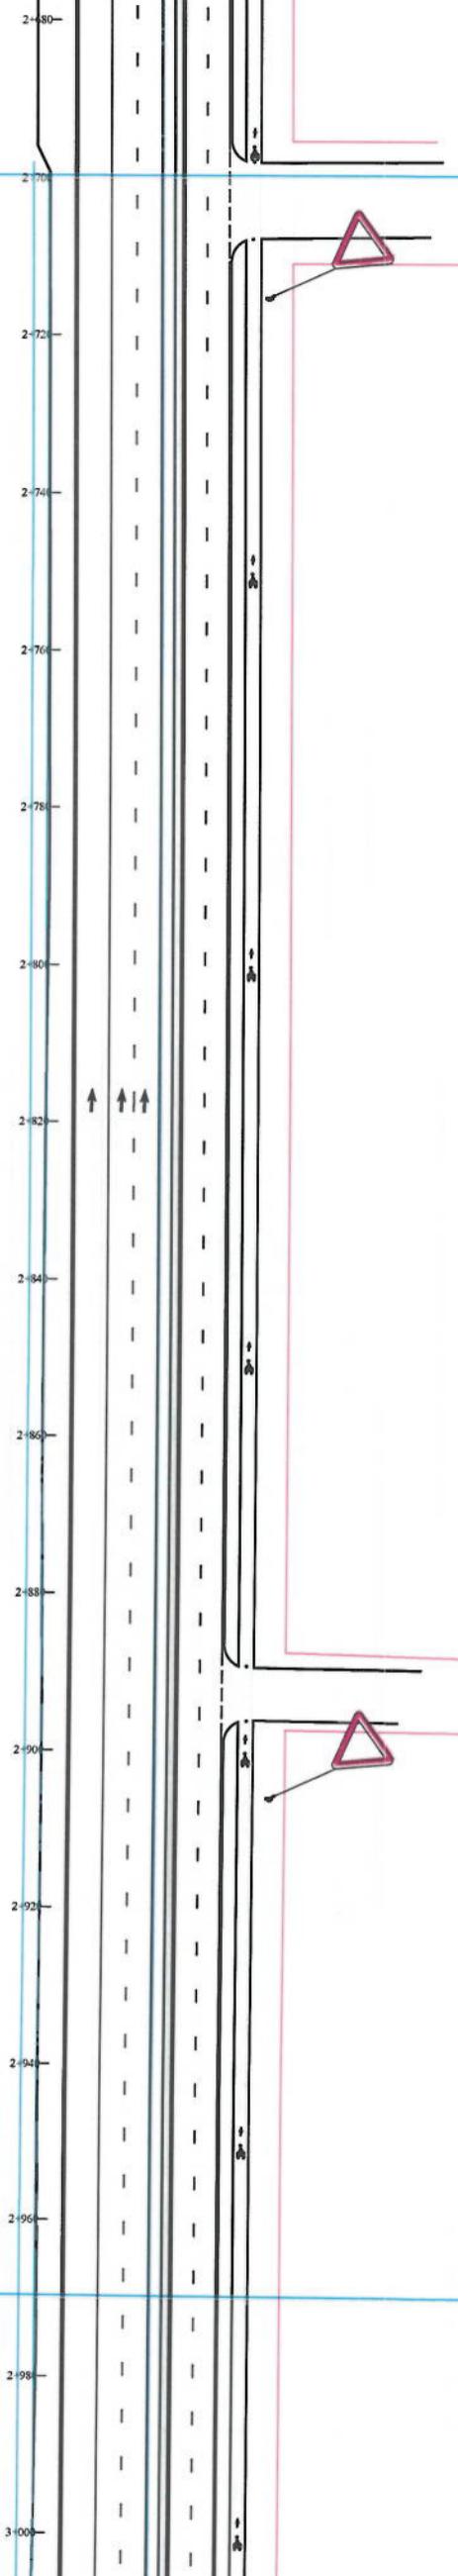


ROAD MARKING

Designed by:	Signature:
Mohammad Esa Sifat	
Drawn by:	Signature:
Mohammad Esa Sifat	
Checked by:	Signature:
Habibullah Stanizi	
Date:	Date:
6/8/2023	1:000
Status:	FINAL DESIGN
Project Code:	
Drawing Number:	PP-6
Revision:	00



نوت: ۱- ابعاد میزانهای متر است. ۲- مکان اشاره دهنده مسیر را باید توسط متخصص تغییرات در محدوده مسیر خود مشخص کرد. جهت تابل این محدوده مسیر ممکن باشند.

چهل راه از رو دارد

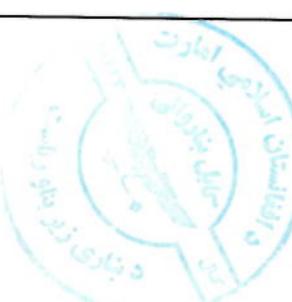


NOTE:

1. All dimensions are in metric unless otherwise indicated
2. Signal Location must be determined by Traffic Specialist

LEGENDS

- CENTER-LINE
- EXISTING SURFACE
- EXISTING SIDE DITCH

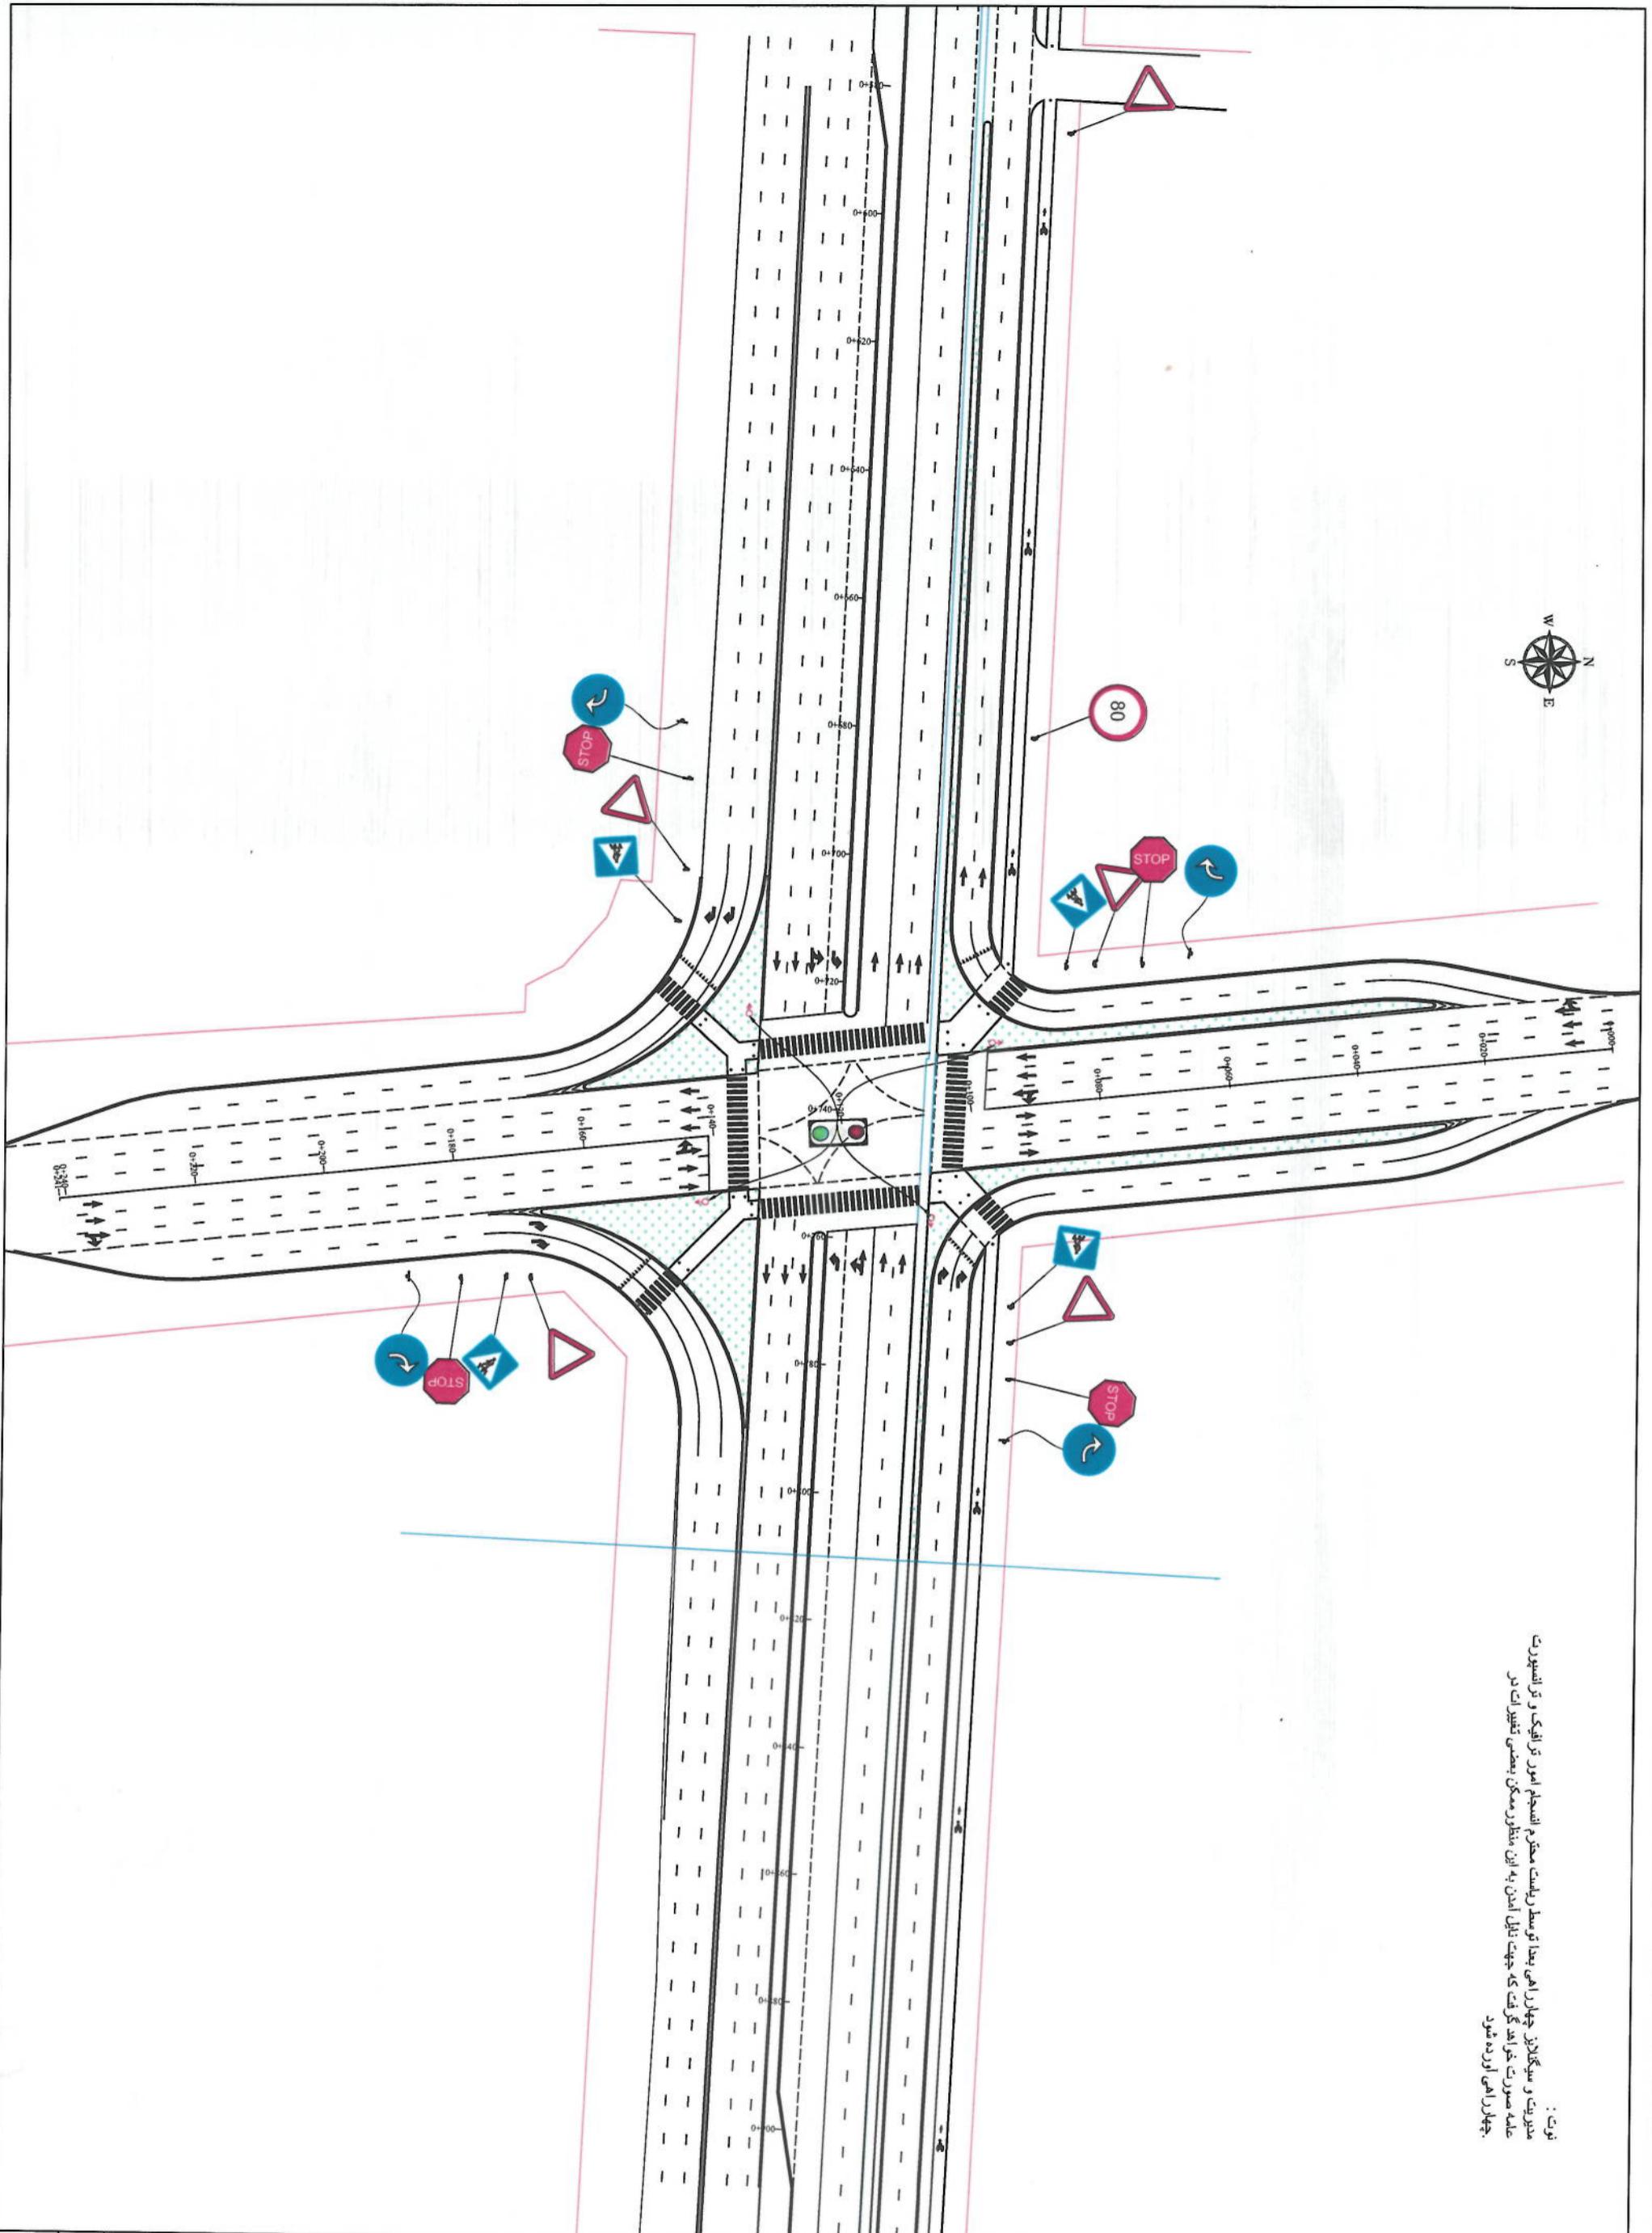

ROAD MARKING	
Designed by:	Mohammed Esa Sharif
Drawn by:	Mohammed Esa Sharif
Checked by:	Rasibullah Sharifi
Date:	6/7/2023
Status:	FINAL DESIGN
Project Code:	
Drawing Number:	RM-7
Revision:	00

ISLAMIC EMIRATE OF
AFGHANISTAN

KABUL MUNICIPALITY

NOTE:


1. All dimensions are in meters unless otherwise indicated.

LEGENDS	
	CENTER-LINE
	EXISTING SURFACE
	EXISTING SIDE DITCH




Smooth & curved
concrete finishing

Fastener bar
Dia 4=mm
Length300=mm

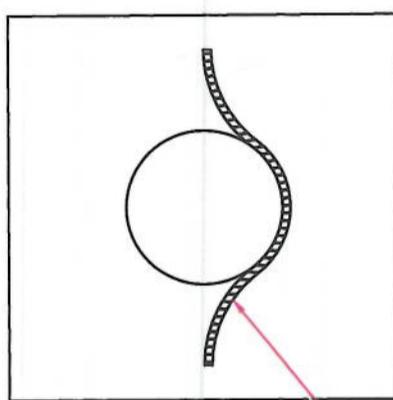


Steel Pipe(A)36
Dia 6=inch
Thickness3=mm

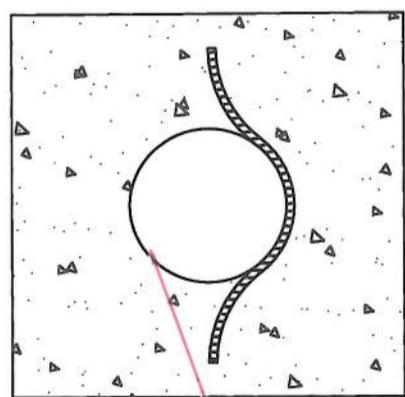

Footpath



Mass concrete footing
 $f_c=18\text{ MP}$

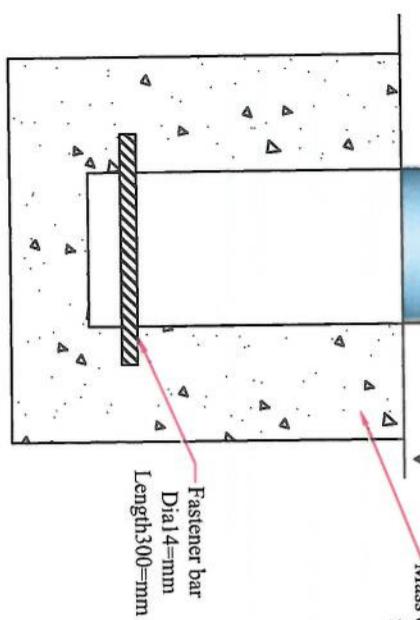

BOLLARD DETAILS, EACH @ 120cm C/C Based on Drawing
SCALE: NTS

Designed By: Mohammad Esa Sial	Signature:
Drawn by: Mohammad Esa Sial	Signature:
Checked by: Hasbullah Shafizi	Signature:
Date: 6/8/2023	Scale: 00
Status: FINAL DESIGN	
Project Code	
Drawing Number BD-1	Revision 00


NOTE:
All dimensions are in meters
unless mentioned.

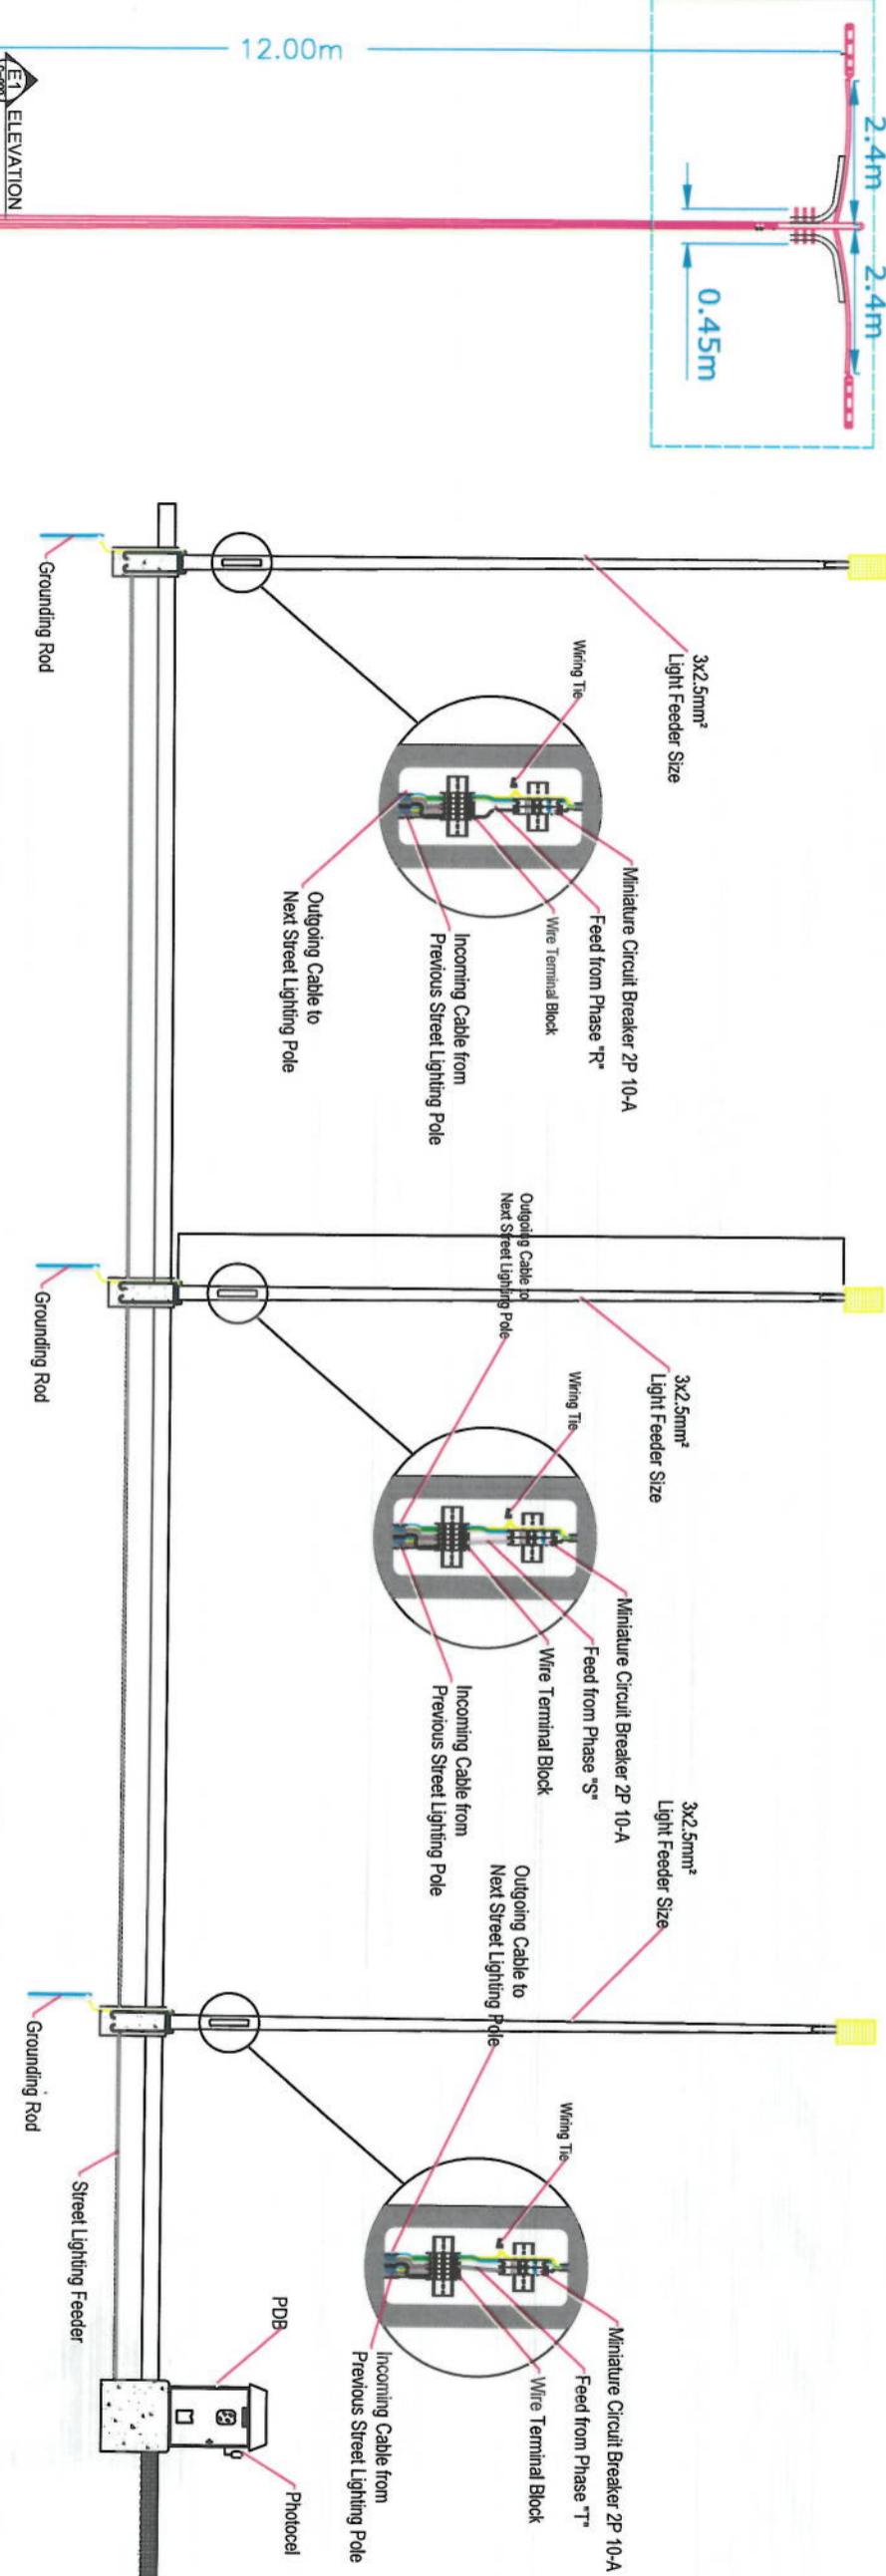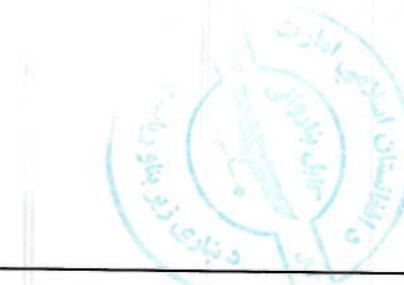

Street Light Poles Wiring System (Elevation)


128Extra Wide Street (EWS) Street Light
or approved equivalent
Lumin 15660min
wattage 128watt

Capping should be in proper way .

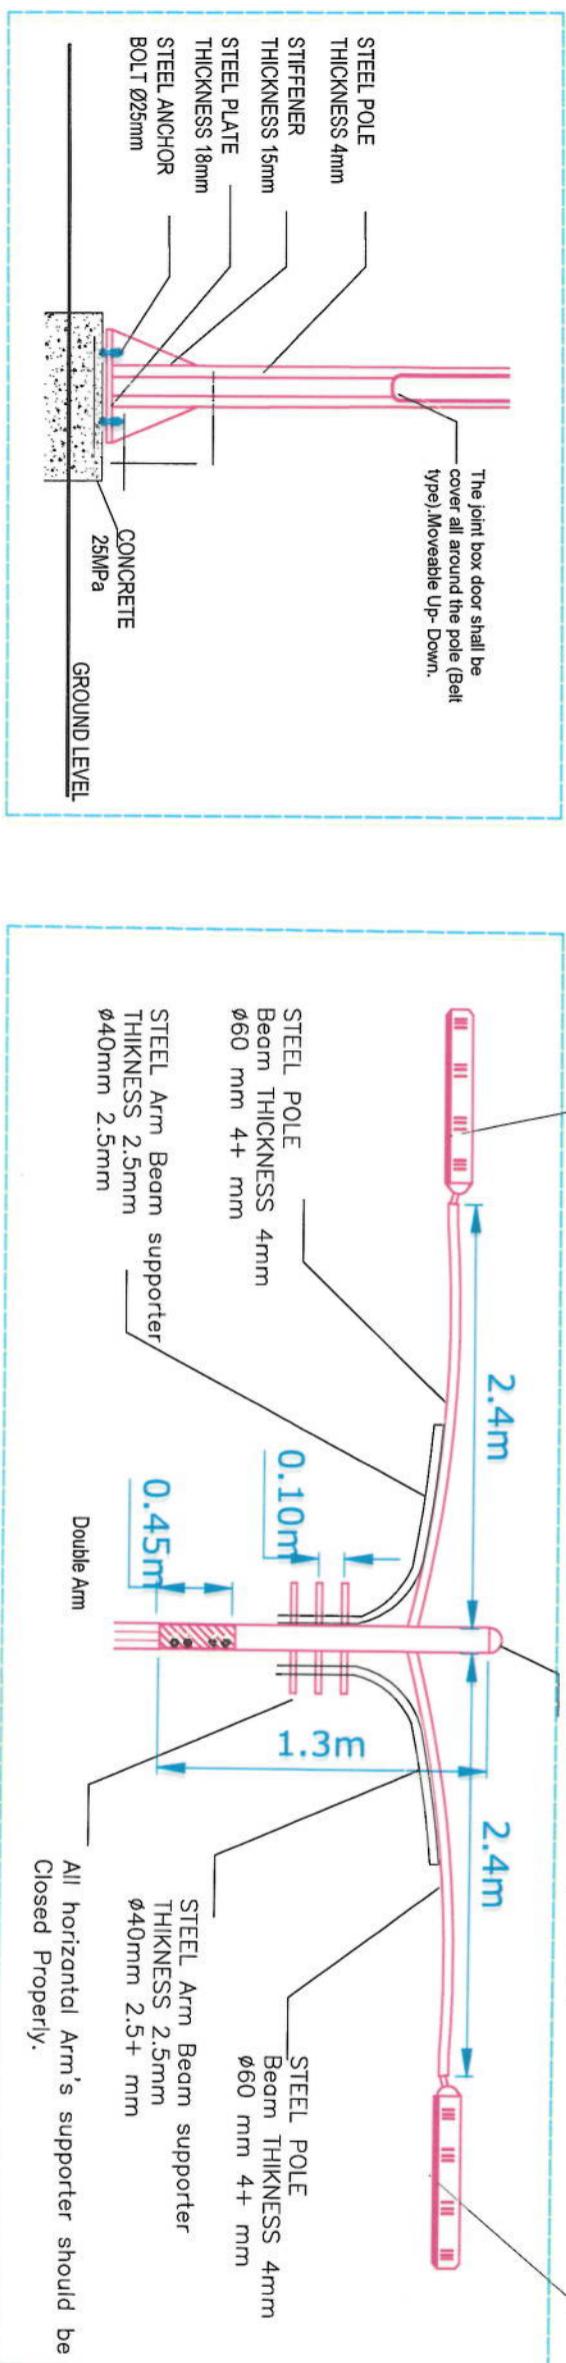

Street Light Pole Double Arm Detail

Project Name:	RAHMAN MINA ROAD		
Drawn by:	Signature	Checked by:	Signature
Mohammed Easa Sait		Hassanullah Shahzai	
Date:	6/7/2023	SCALE:	
Status:	FINAL DESIGN	Project Code:	
Drawing Number:	LD-01	Revision:	01

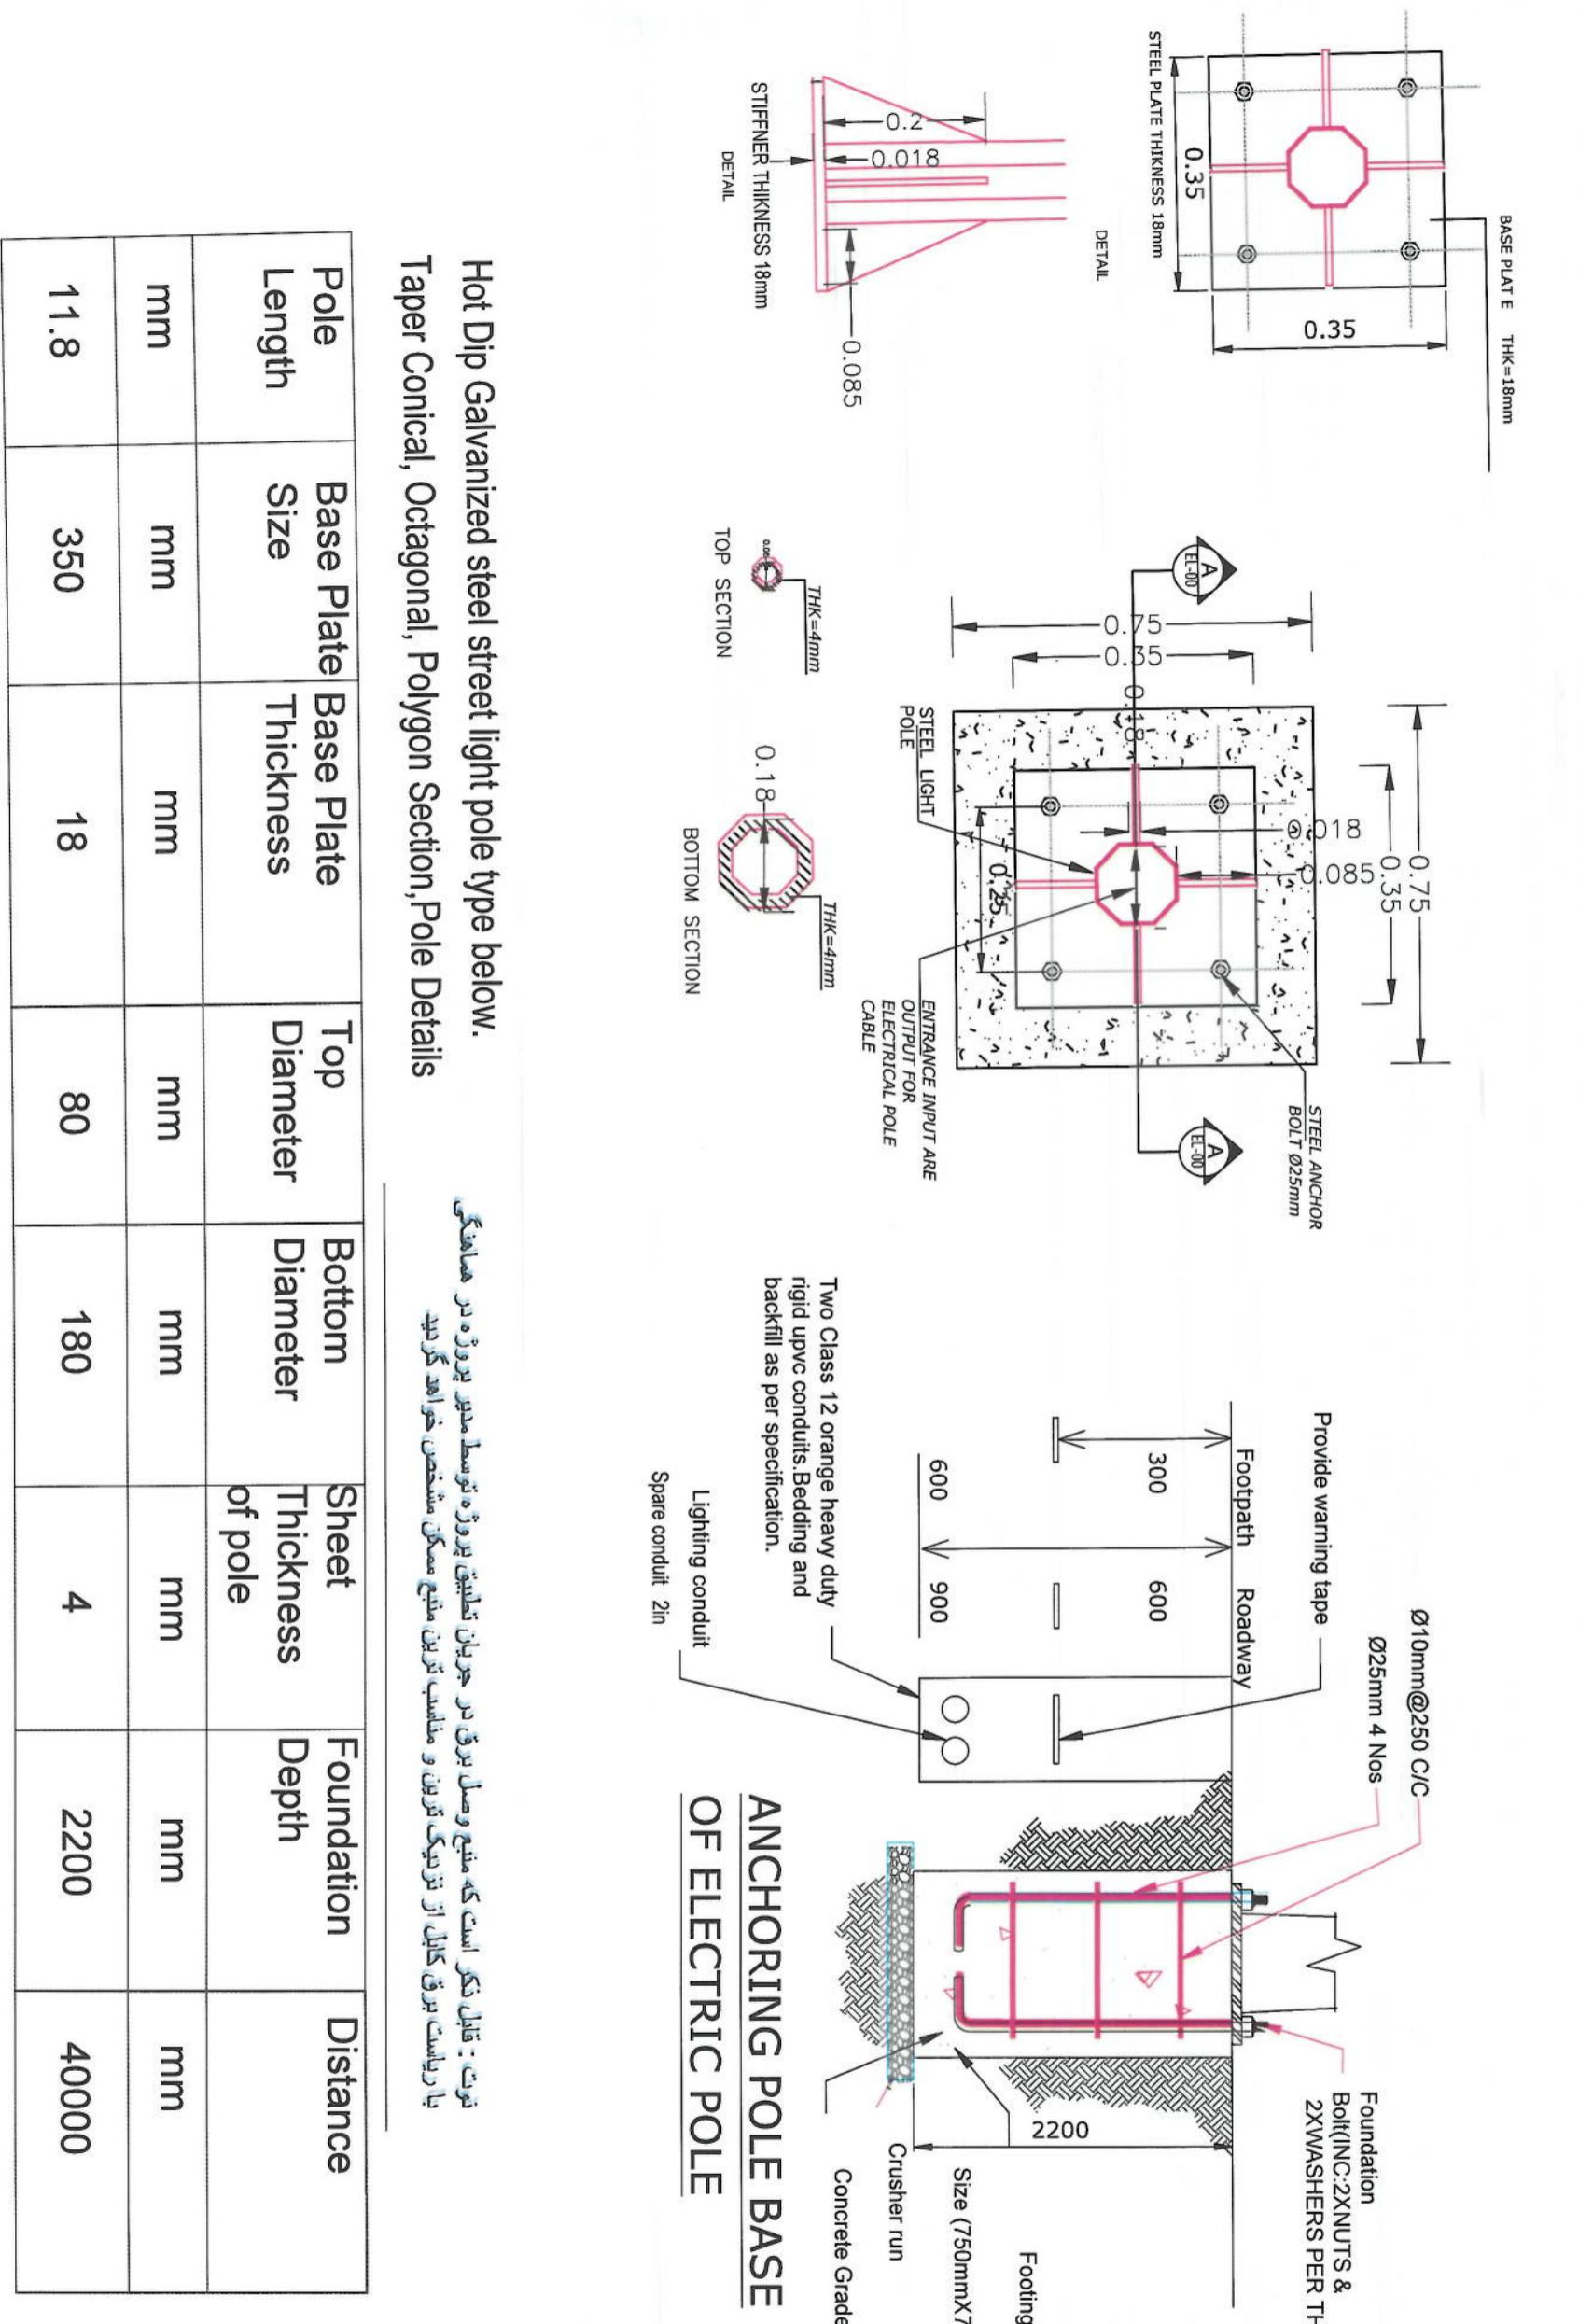

ANCHORING POLE BASE OF ELECTRIC POLE

نوت: قبل نکر است که منیج وصل برق در جریان تطبیق پیروزه توسعه مدیر پیروزه در همانگی
ای ریاست برق کالل از نزدیک آنل و مدلسیب آنل مملکت مشغول شده است. این دلیل

Hot Dip Galvanized steel street light pole type below.
Taper Conical, Octagonal, Polygon Section,Pole Details

Pole Length	Base Plate Size	Base Plate Thickness	Top Diameter	Bottom Diameter	Sheet Thickness of pole	Foundation Depth	Distance
mm	mm	mm	mm	mm	mm	mm	mm
11.8	350	18	80	180	4	2200	40000

Street Light Pole Double Arm Detail

Project Name:		RAHMAN MINA ROAD	
Drawing Title:		Lighting Detail	
Drawn by:			
Mohammad Fiaz Sial	Signature		
Checked by:			
Hashimullah Shahzai	Signature		
6/7/2023	SCALE:		
Status:		FINAL DESIGN	
Project Code:			
Drawing Number:	LD-02	Revision:	02
<p>NOTE: All dimensions are in meters unless mentioned.</p>			