





KABUL MUNICIPALITY  
URBAN INFRASTRUCTURE DIRECTORATE  
DESIGN DEPARTMENT




Cot-e-Sangi to Demazng Road Project  
پروژه سرک کوته سنگی الی دهمزنج

LOCATION : 3TH DISTRICT

LENGTH : 3226m

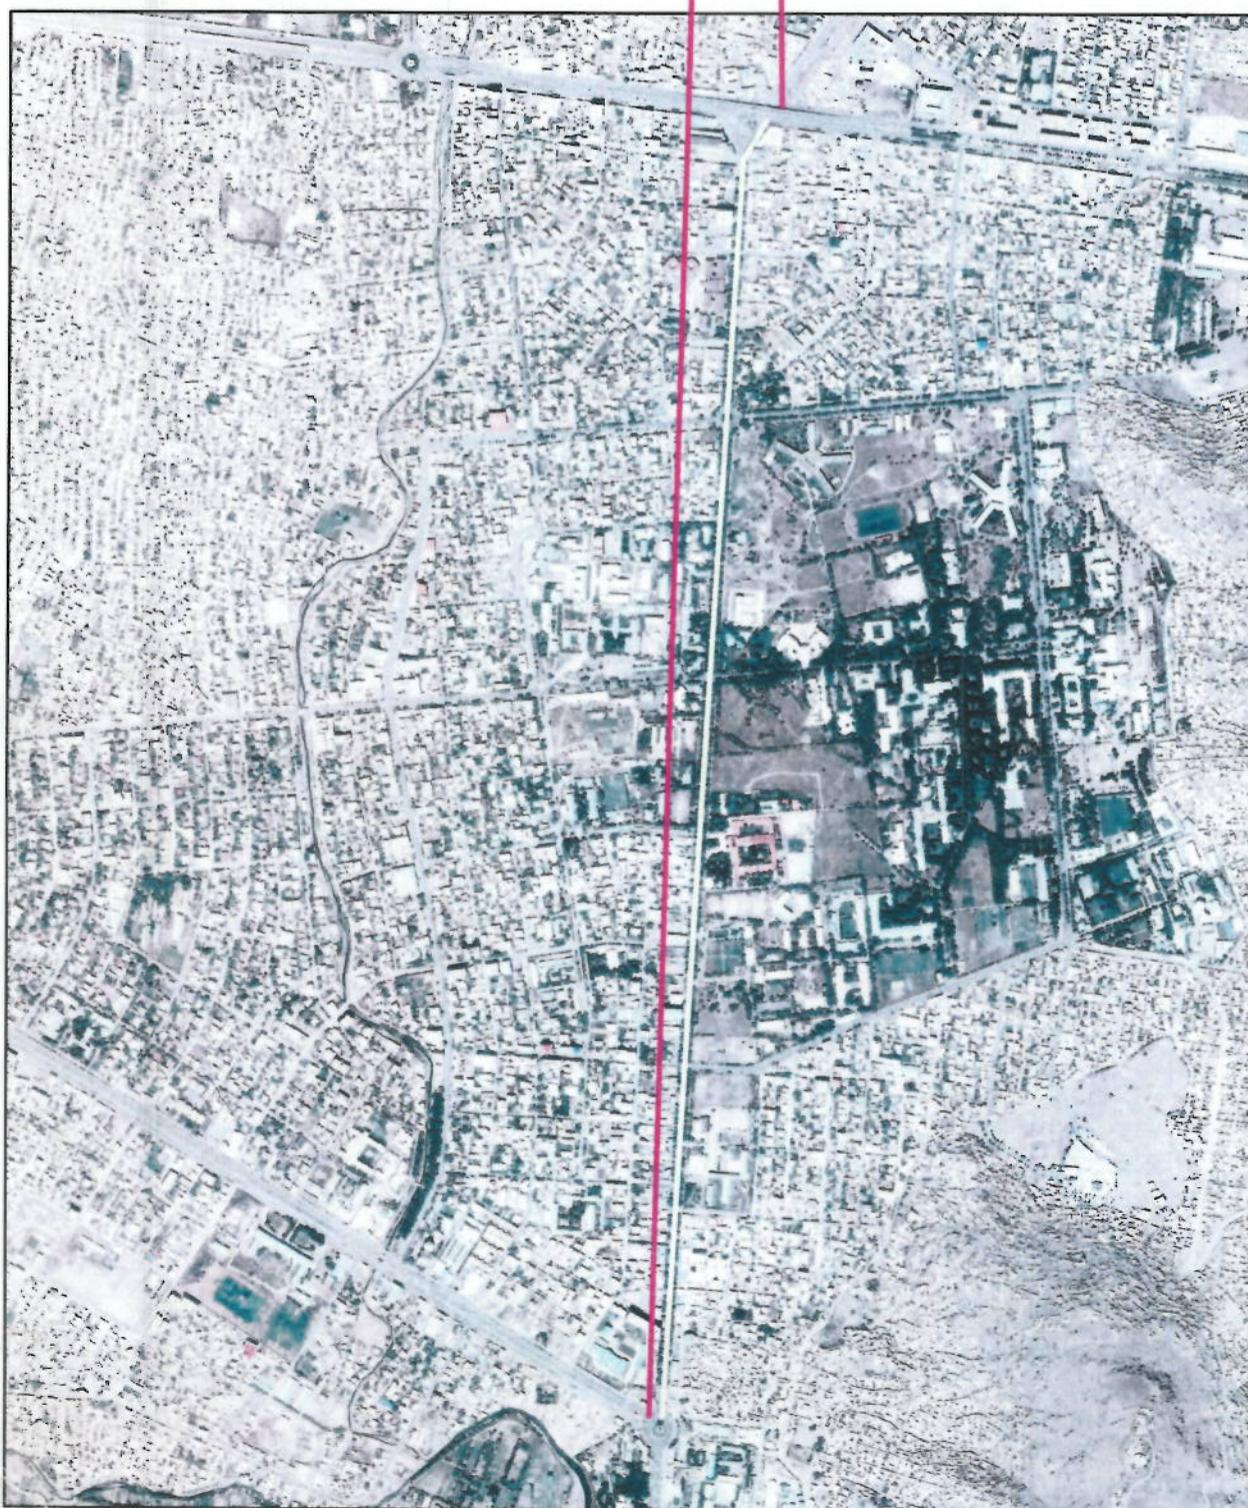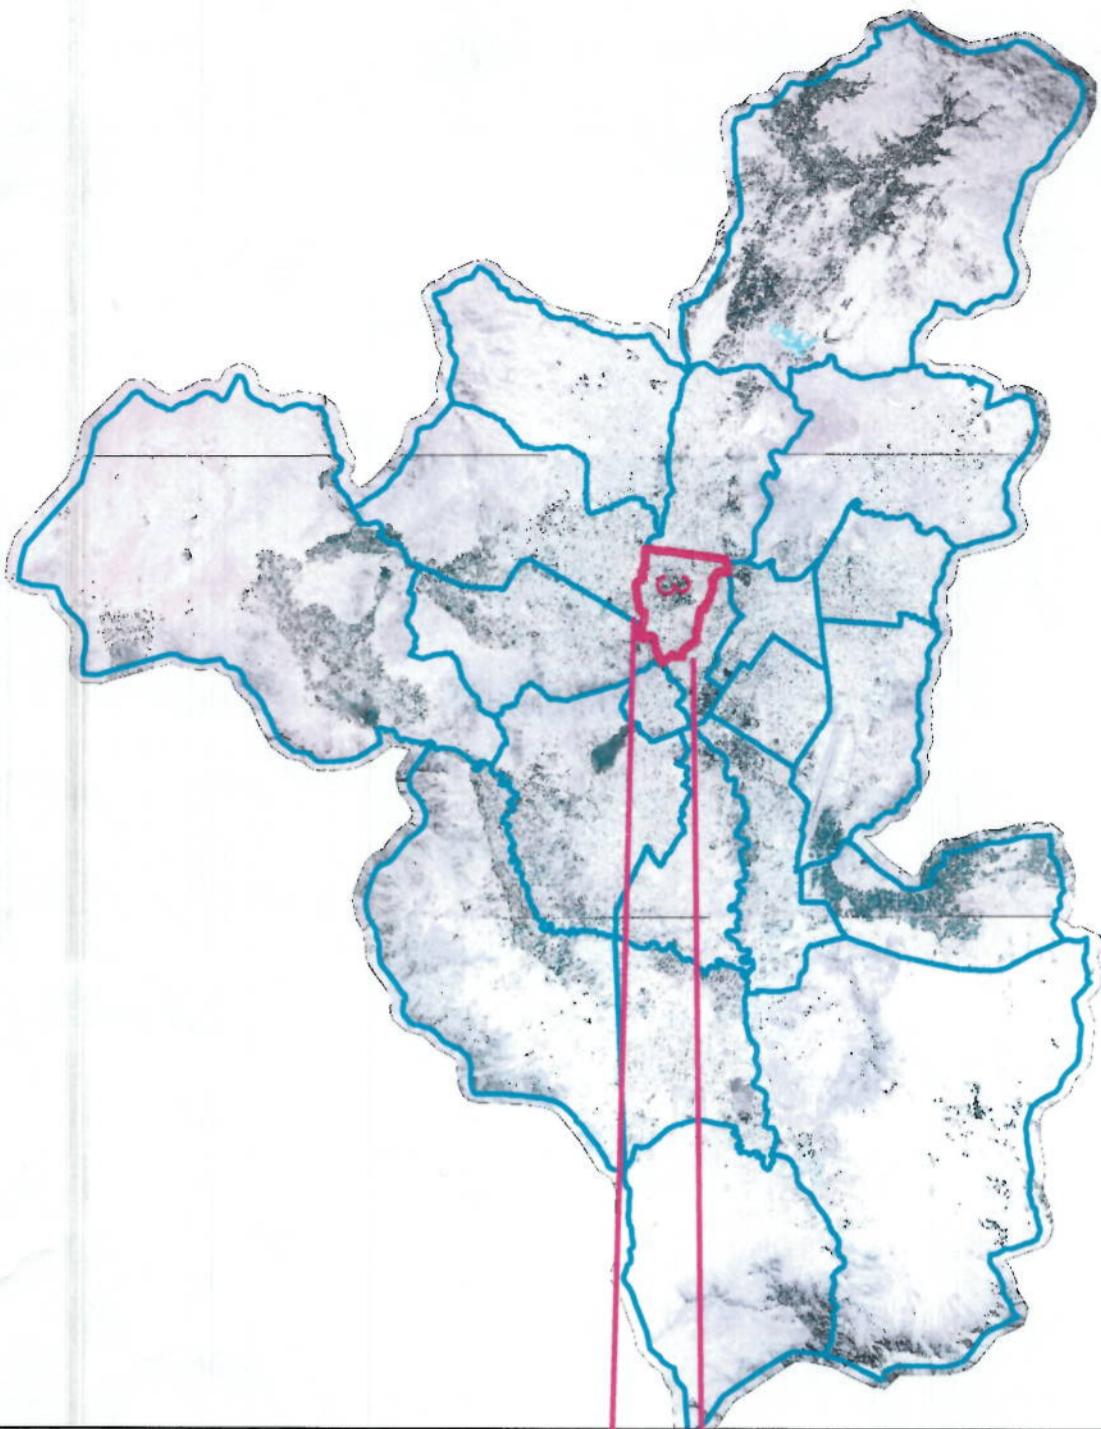

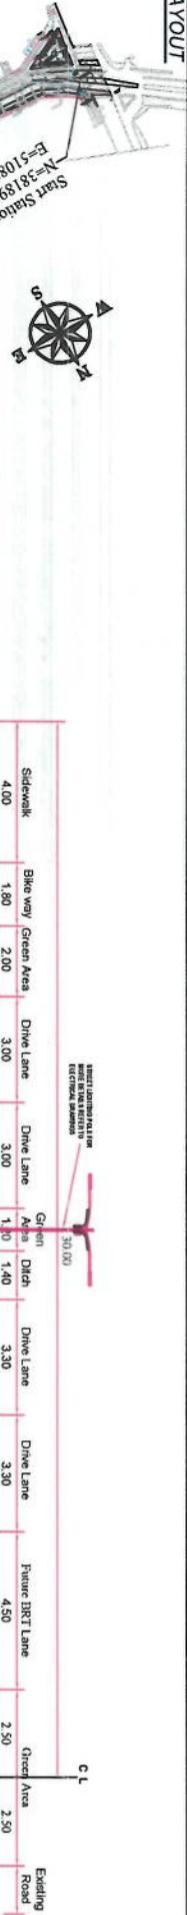

تصویر:

امانل تختنکی پرورده سرک کوتاه سنجی الی دهمندی ب عرض 60 متر نظر به  
پیلان پروره های اکتشافی بودجه داخلی سبل 1402 که تحت شمر 47 در پذیر

مشکر ثبت میشند، ترتیب گردیده است.


پیلان سرک مشکر به عرض 60 متر نظر گرفته شده است نظر به لزوم  
دید مقامات صالحه شدرو الی کابله و کاھش مصارف پروره، ساختمان های سرک  
موجوده (قسمت موتو رو، جوینیتی کابله و پیله و رو) بر حل حاضر جواب  
گوی نیازندی های قطبی میشند، لذا فضلا طرف چه سرک (قیمت توسعه باقیه  
آن) به جز چهار امی کوهی سنجی و دهوری، دلایل گردیده است تاگفته تبدیل  
کاشت که هر زمانی که تعمید به ذلیل پی تطبیق طرف راست از نظر به مقلمی  
عرضی جدید گرفته شود لازم است تا نظر به شرایط موجوده سرک و ساختمان ها)

موره بلکر قرار گیرد.

از اندیشه پروره مشکره بر پلزن الی چهارراهی دهمندیک بر نظر گرفته شده  
است برای مدیریت هرچه بیشتر تر افیک نر سرک مشکر و چهارراهی دهمندیک  
بهتر خواهد بود که سرک حد افق الی نوباد دھشم تکلیف داده شود.

4- تأسیس موانع همچون کیبل های برق، کیبل های شبکات مخابراتی، پیپ های  
شبکت آبرسانی، چاهه های سبیک و غیره مواسع قبل از شروع پروژه بر  
هاده های با نهادهای مسئول و نایحه سرویسه از سماوهه دور ساخته شده و ساخته  
برای تطبیق پروژه اسلامه گردد.

5- تطبیق درخت ها کل پنهان ها و ساختات سیز باید در همانگی بازیست سریز  
شارو الی کابله صورت گیرد.

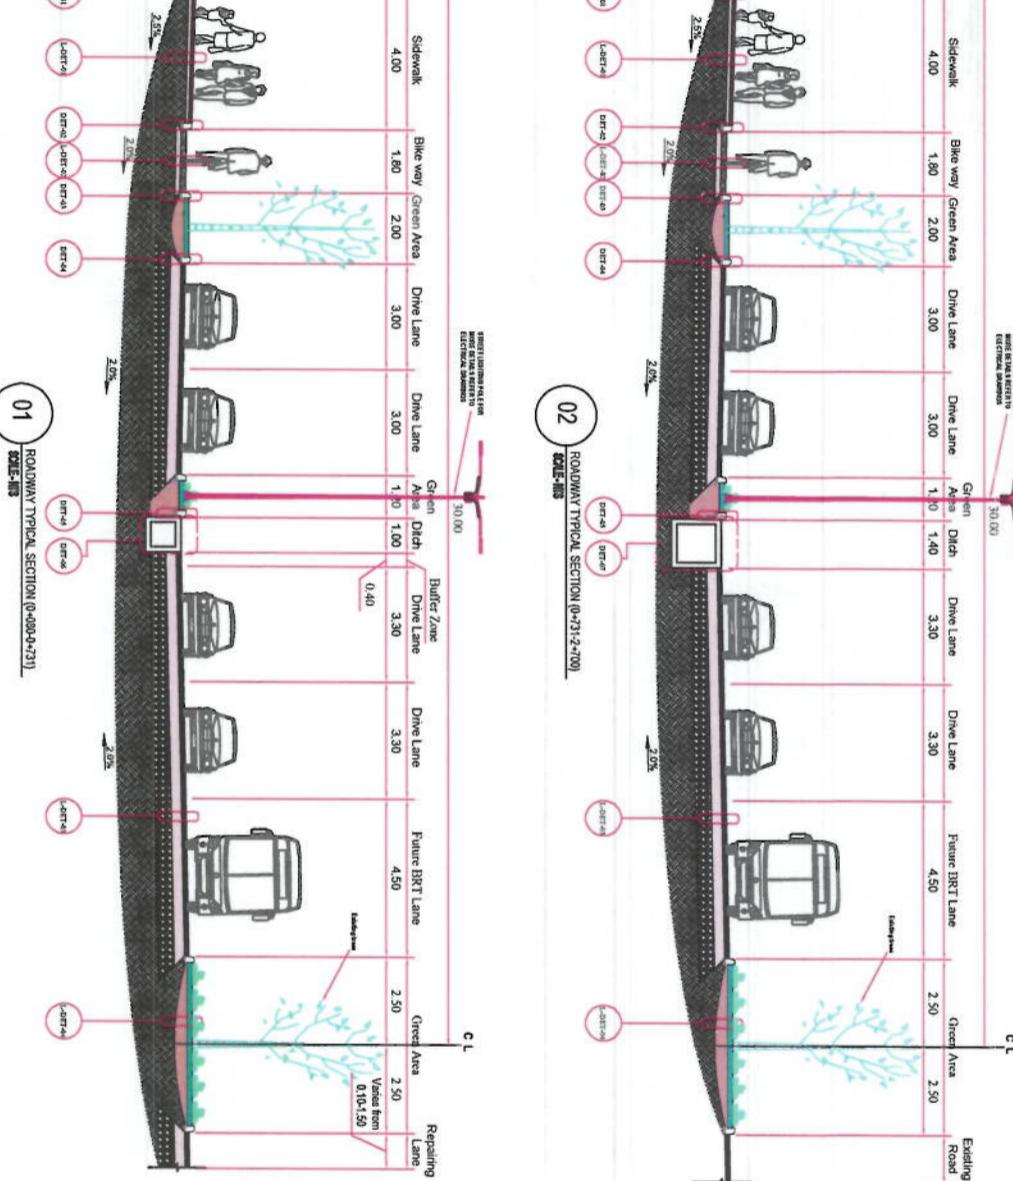

کتابه ۱۱۱۲۹ میزان ۱۱۱۲۹ کتابه ۱۱۱۲۹

#### امور ساختگانی پروره سرک کوتاه سنجی

نوشته: مختاری پروره های دهمندی که کننده از استانی ترسیم کننده، نیز این کننده، بررسی کننده، تأیید کننده  
و مستقره قائم سفرم شدرو الی کابله بررسی کننده، امضا تسلیمه کننده، قابلیت  
هر اجل بعدی بوده و تغییق میگردید.  
امضا عالم شدرو الی کابله بر این صفت دلیل کننده مظفوري تمام صفات بدین شناس

لو چند کننده امداده تذکری میگشتند.

امور ساختگانی پروره سرک کوتاه سنجی
فرسیم کننده: محمد عیسی مسیرو
جوز این کننده: محمد عیسی مسیرو
بررسی کننده: سید عباسی طیبی شورزی
بررسی کننده: احمد شفیعی

Location : 3rd District  
Right of Way: 60m,  
Length : 3220m  
Pavement Type : Asphalt  
Cross Section Elements :  
Drive way, Side Ditches, Bikeway, Median,Curbstones,  
,Sidewalks




مشترک پروره  
دهمندی کتابه

تأیید کننده:  
احمد شفیعی  
بررسی کننده:



AT STATION - 0+329.00  
PREVIOUS SHEET NUMBER - 1

SHOP

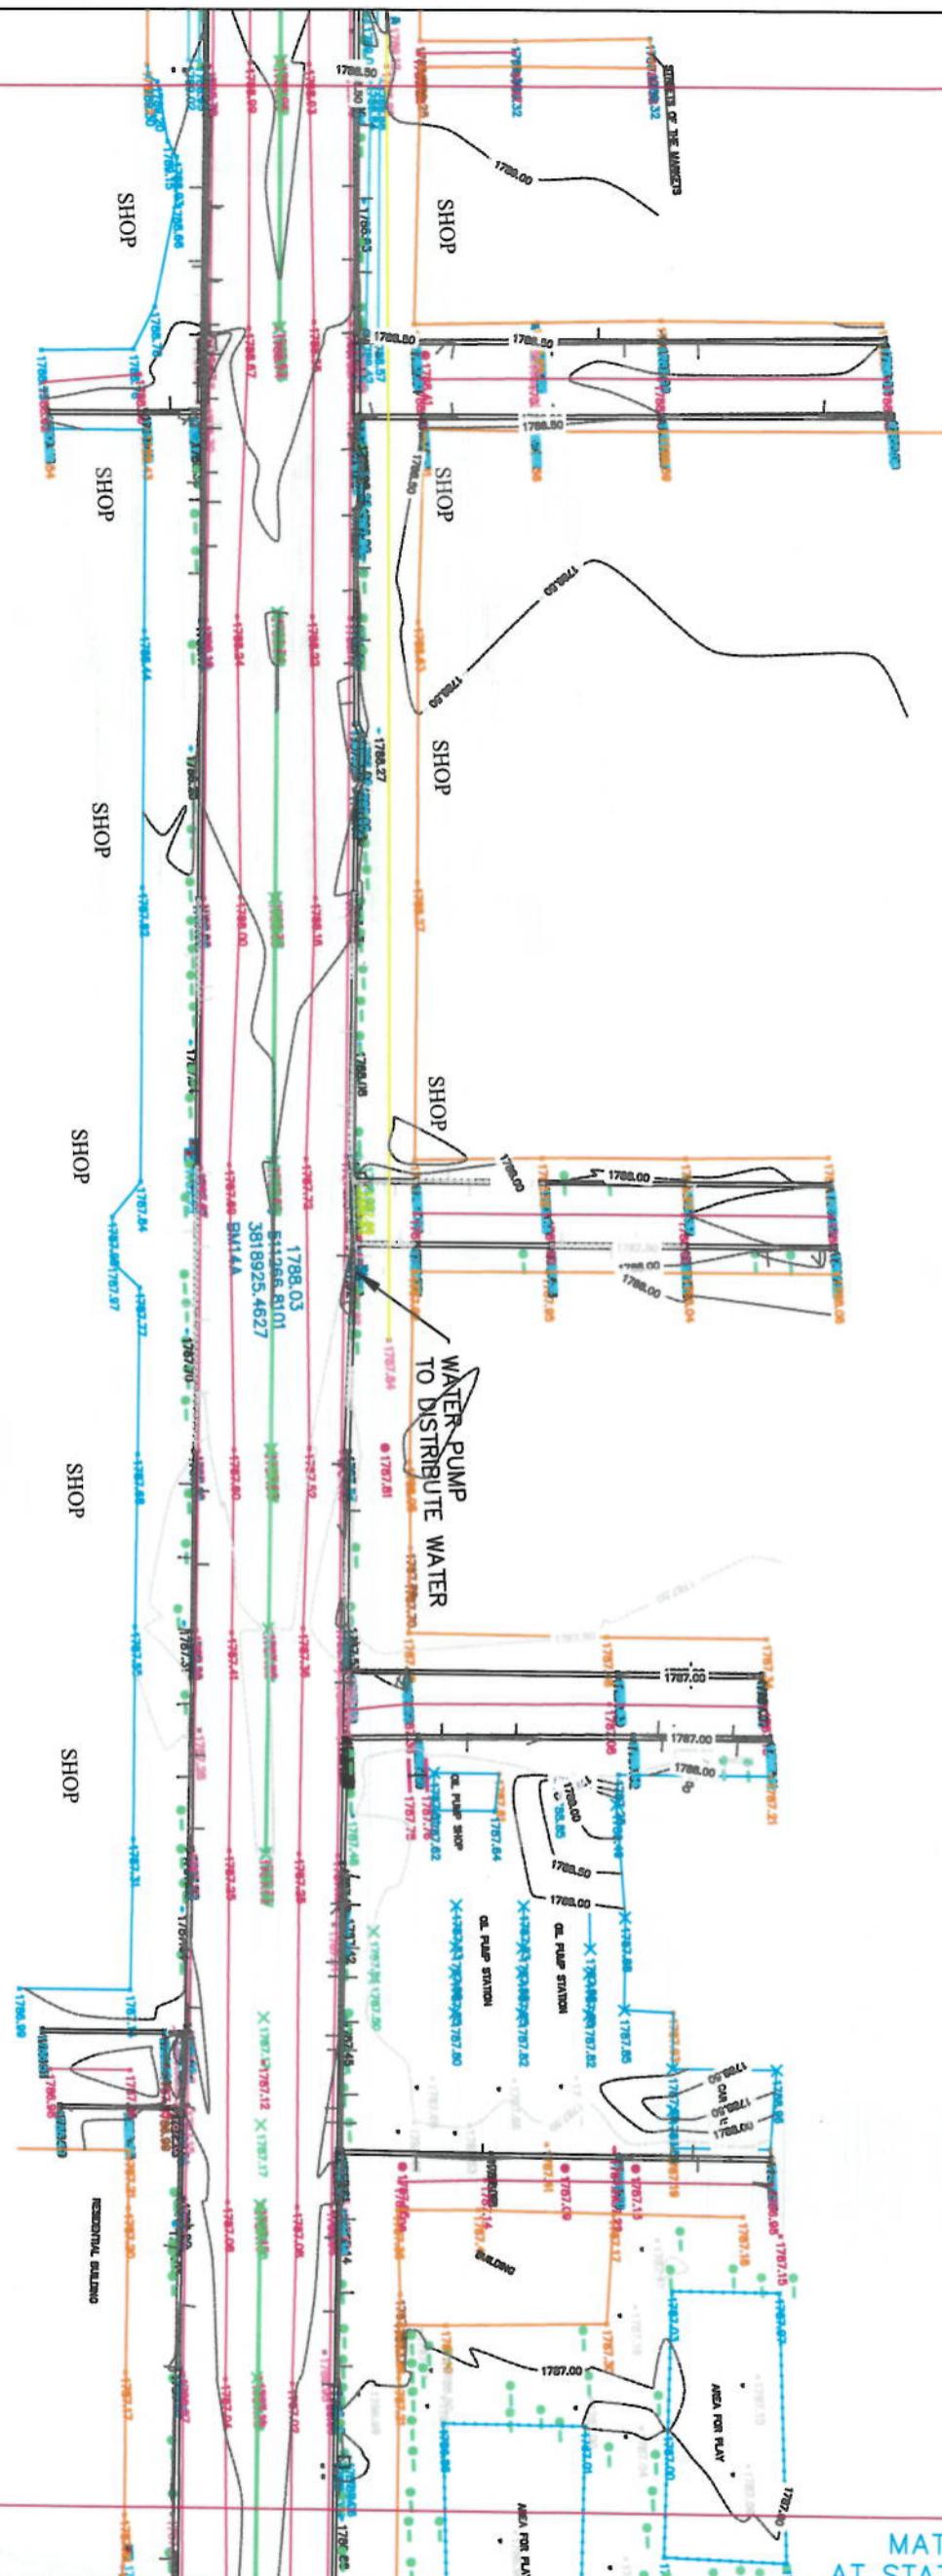


NOTE: ALL DIMENSIONS ARE IN METERS  
UNLESS OTHERWISE INDICATED

LEGEND

NO.	CODE	DETAIL	PICTURE
1	BL	Building	
2	RD	Road	
3	ST	Street	
4	AD	Area	
5	TD	Topography	
6	UD	Unseen Survey	
7	CLC	Control Line	
8	FC	Frontage	
9	PC	Plotting	
10	SC	Section	
11	TSN	True North	
12	DR	Distance	
13	MT	Mean Height	
14	TR	True Position	
15	TM	True Meridian	
16	TMN	True Meridian	
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18	TMN	True Meridian	
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AT STATION - 0+658.00  
PREVIOUS SHEET NUMBER - 2

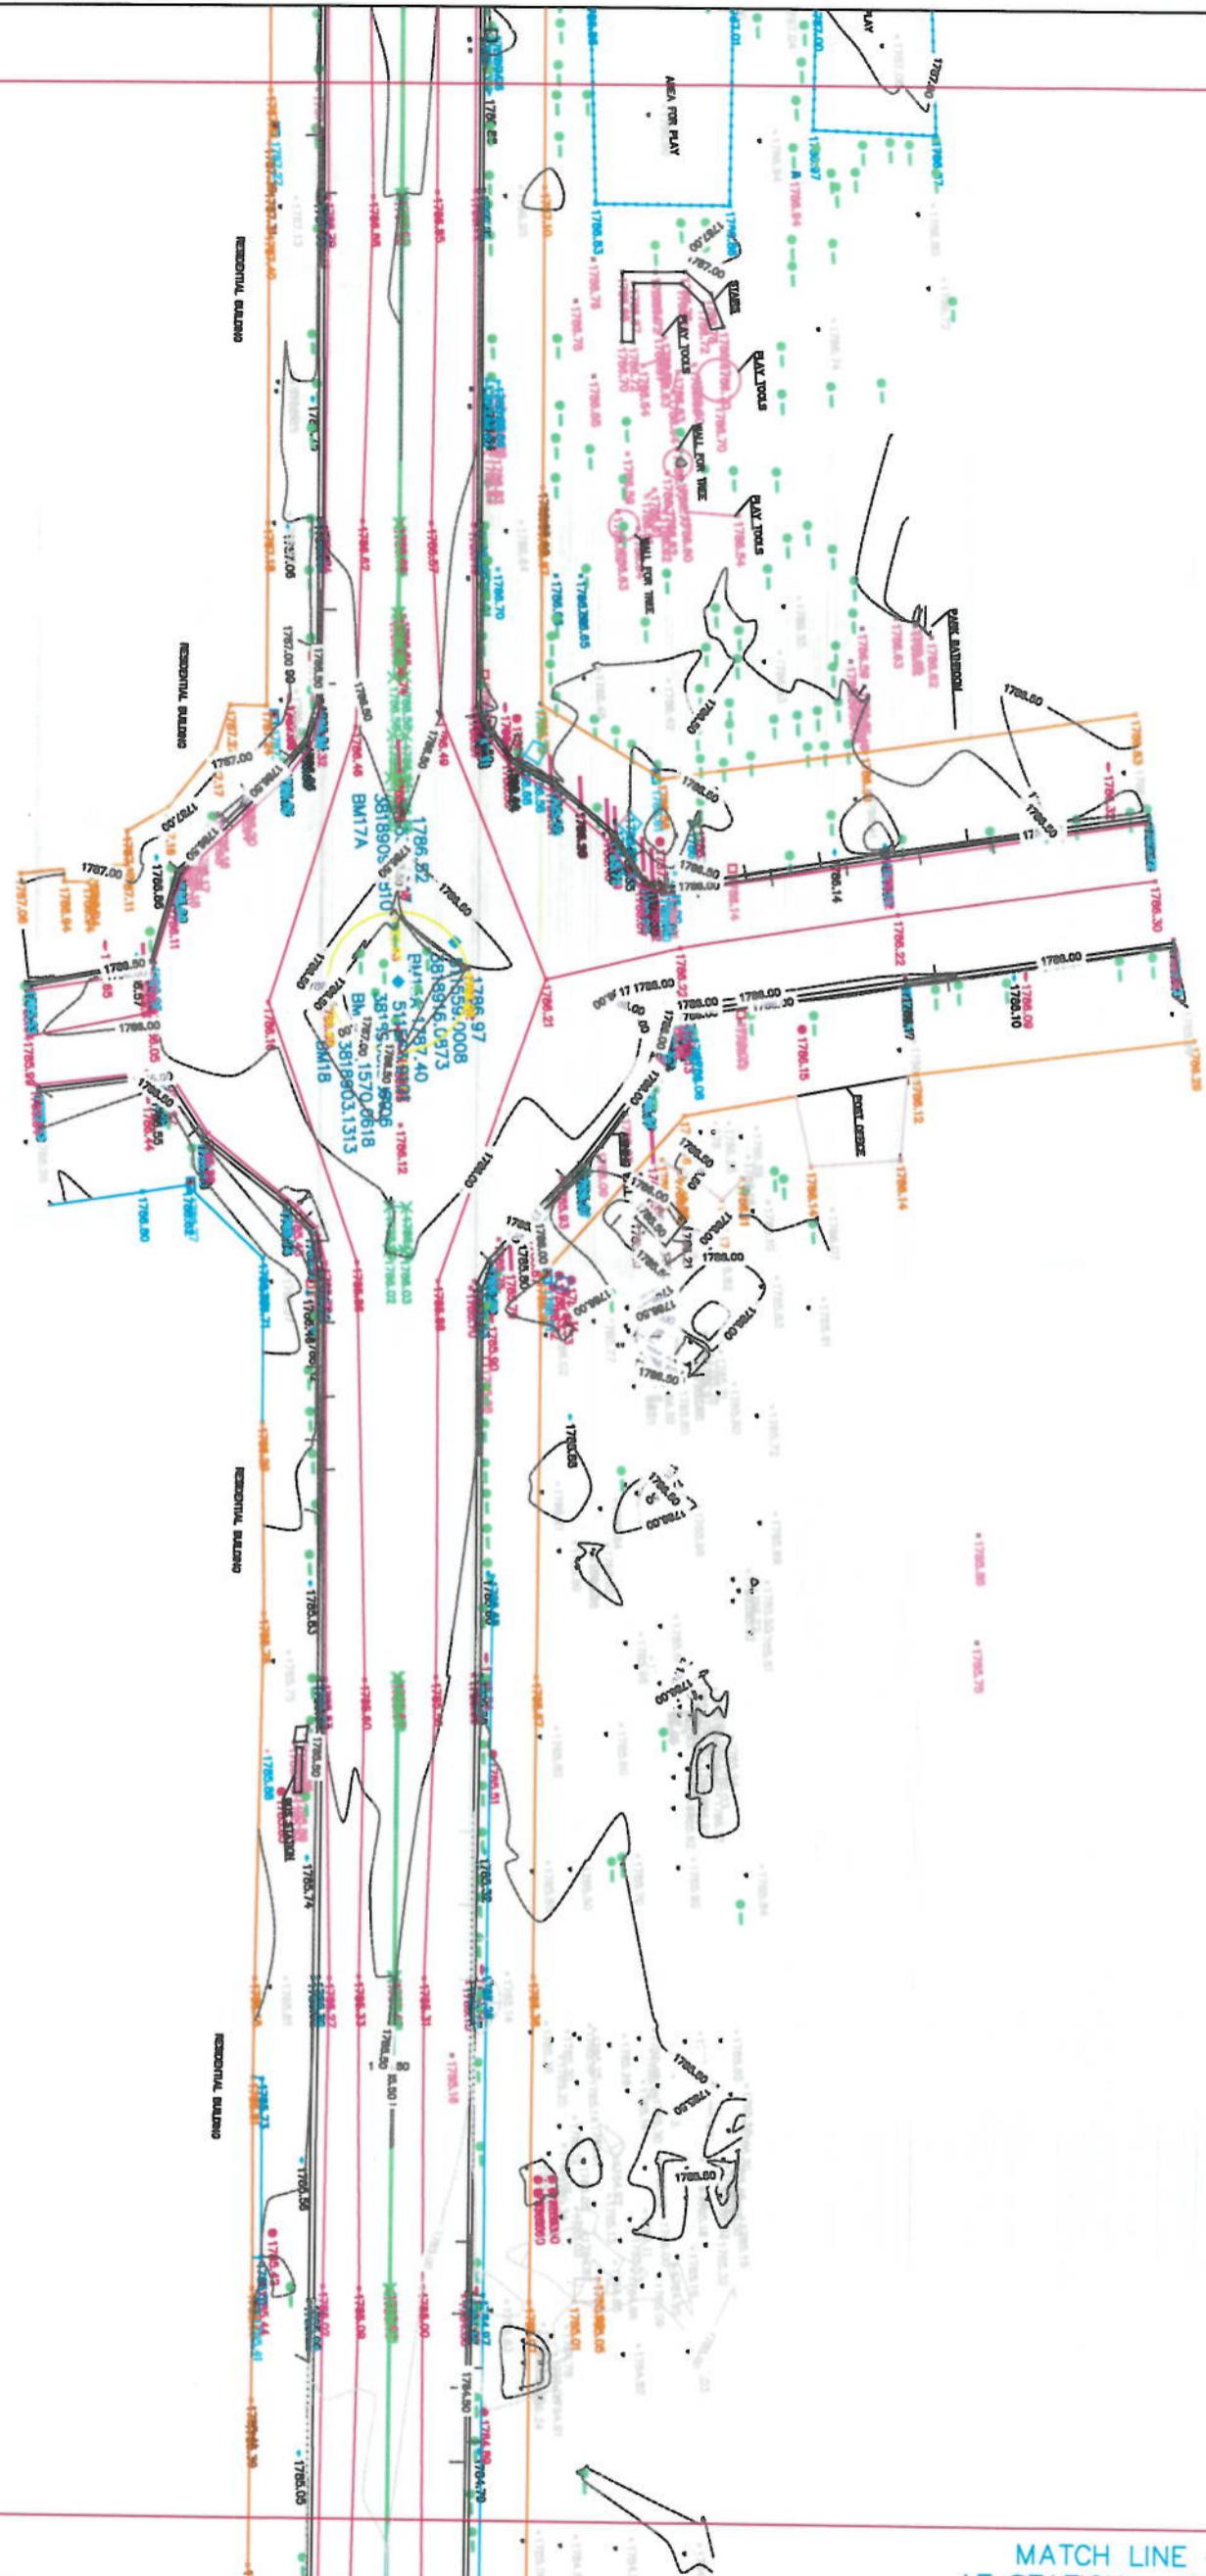

MATCH LINE - 3  
AT STATION - 0+987.00

**NOTE: ALL DIMENSIONS ARE IN METERS  
UNLESS OTHERWISE INDICATED**

AFGHANISTAN  
SURVEYED BY:  
KABUL MUNICIPALITY  
SURVEY TEAM

NOTE: (ALL DIMENSIONS ARE IN METERS UNLESS OTHERWISE INDICATED)	
LEGEND	
No. / Code / Detail	FIGURE
1. BL Building	
2. EH	
3. EW	
4. FW	
5. H	
6. HQ	
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9. L	
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SURVEY FROM DAMAZANG SQUIRE  
UP TO KOTASANGI BRIDGE

status:

TOPOGRAPHIC-SURVEY

PROJECT CODE:


DRAWING #: 10-1000

61

104

THE LIVID LAVENDER

AT STATION - 0+987.00  
PREVIOUS SHEET NUMBER - 3

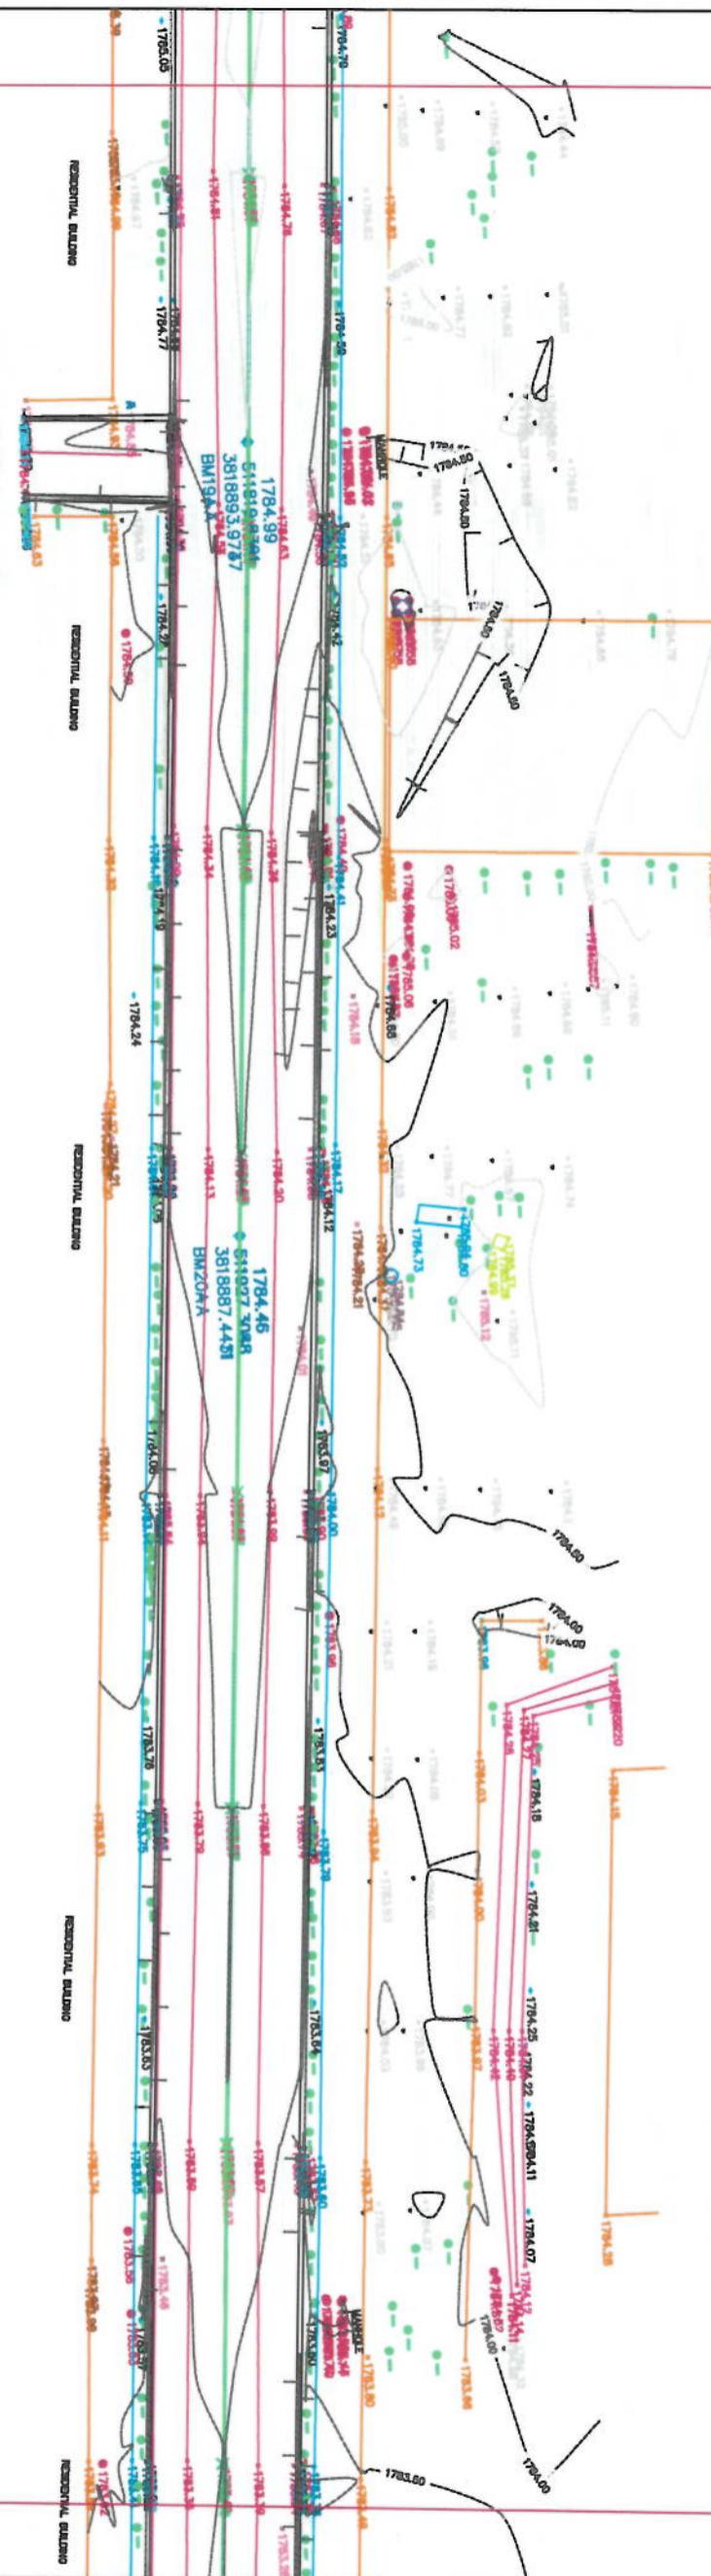


MATCH LINE - 4  
AT STATION - 1+316.00

**NOTE: ALL DIMENSIONS ARE IN METERS  
UNLESS OTHERWISE INDICATED**

PROJECT NAME: SURVEY FROM DAMAZANG SQUARE UP TO KOTASANGI BRIDGE	
DRAWING TITLE: SURVEY FROM DAMAZANG SQUARE UP TO KOTASANGI BRIDGE	
SURVEYED BY: ENG. ABDILAH BEN SURVEYED BY: ENG. ABDILAH BEN SURVEYED BY: ENG. ABDILAH BEN HEAD OF SURVEY: ENG. SAYED ATIQ	SURVEYED BY: ENG. ABDILAH BEN SURVEYED BY: ENG. ABDILAH BEN SURVEYED BY: ENG. ABDILAH BEN DATE: SCALE: 1:1000
STATUS: TOPOGRAPHIC SURVEY	
PROJECT CODE:	
DRAWING #: 4	REVISE




AT STATION - 1+316.00  
PREVIOUS SHEET NUMBER - 4

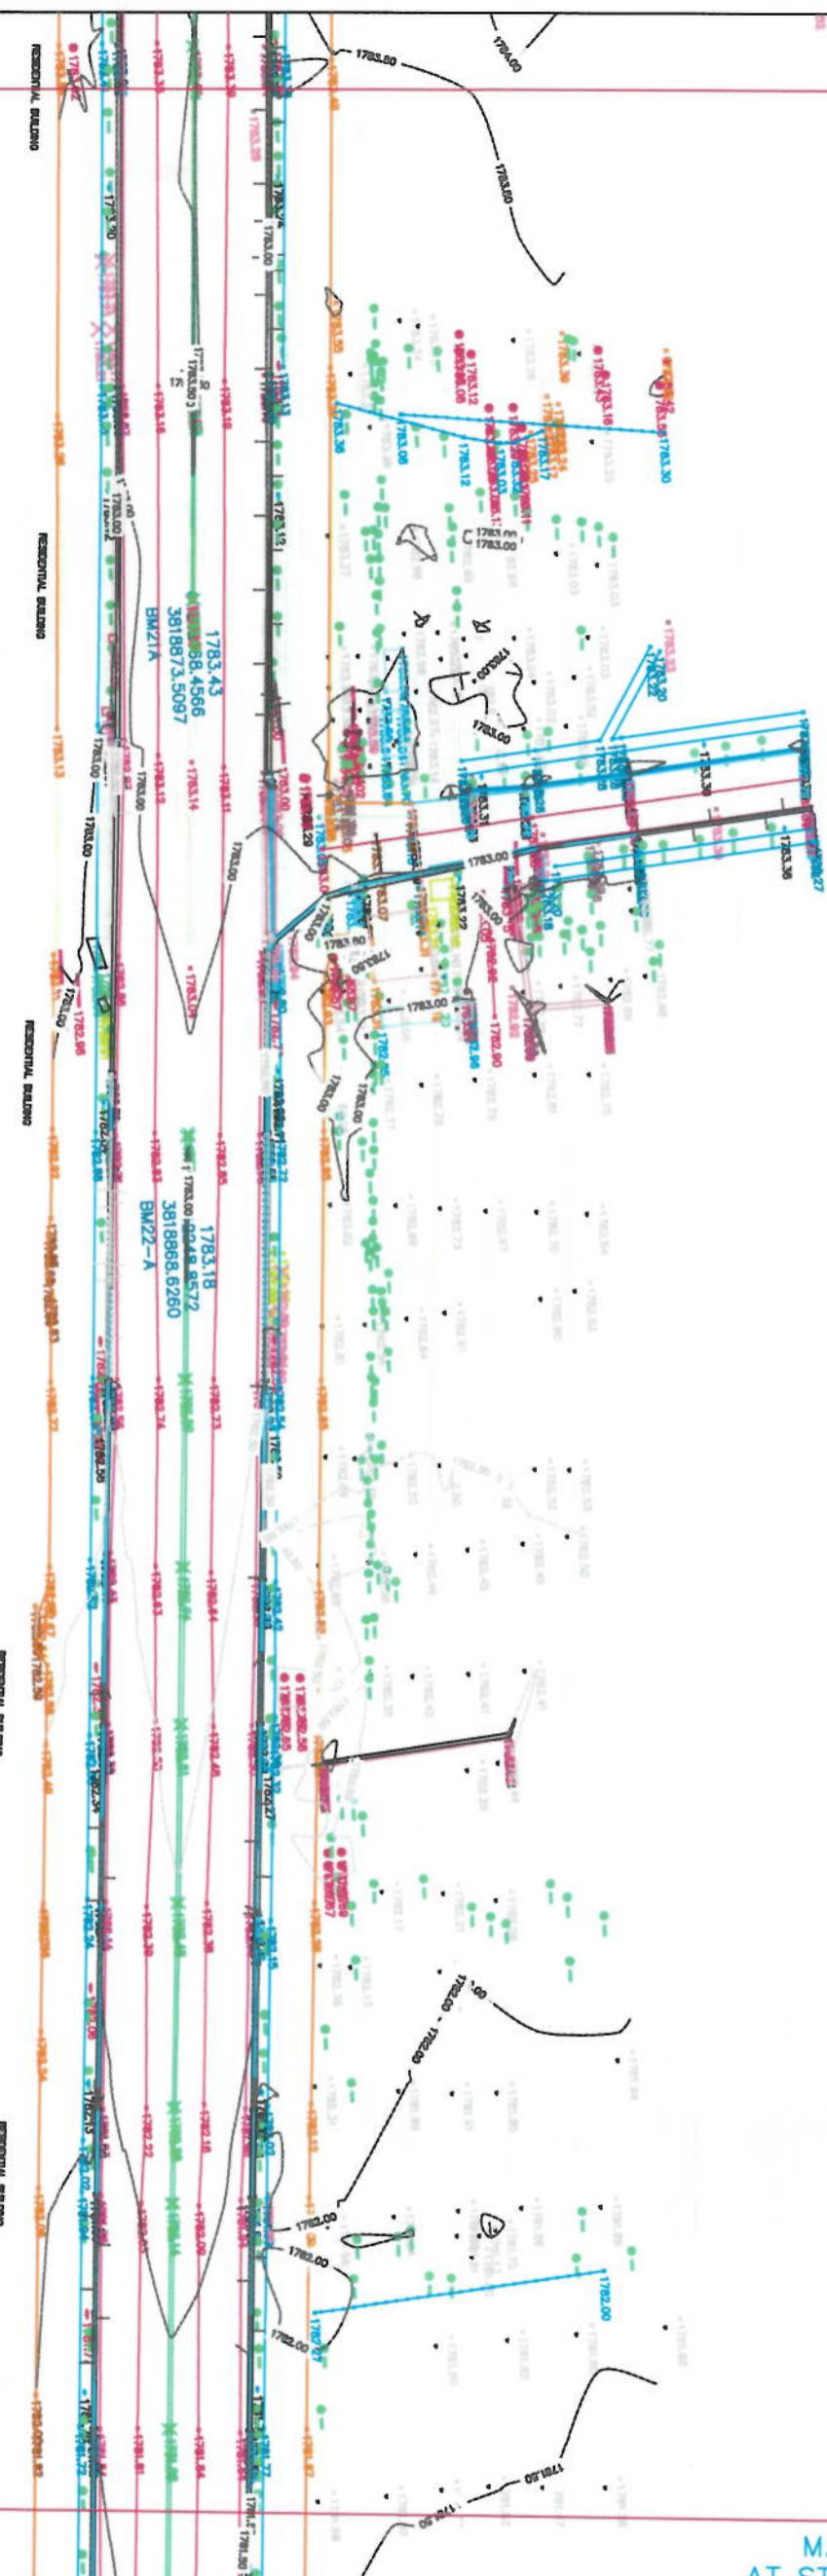

MATCH LINE - 5  
AT STATION - 1+645.00

**NOTE: ALL DIMENSIONS ARE IN METERS  
UNLESS OTHERWISE INDICATED**

AT STATION - 1+645.00  
PREVIOUS SHEET NUMBER - 5

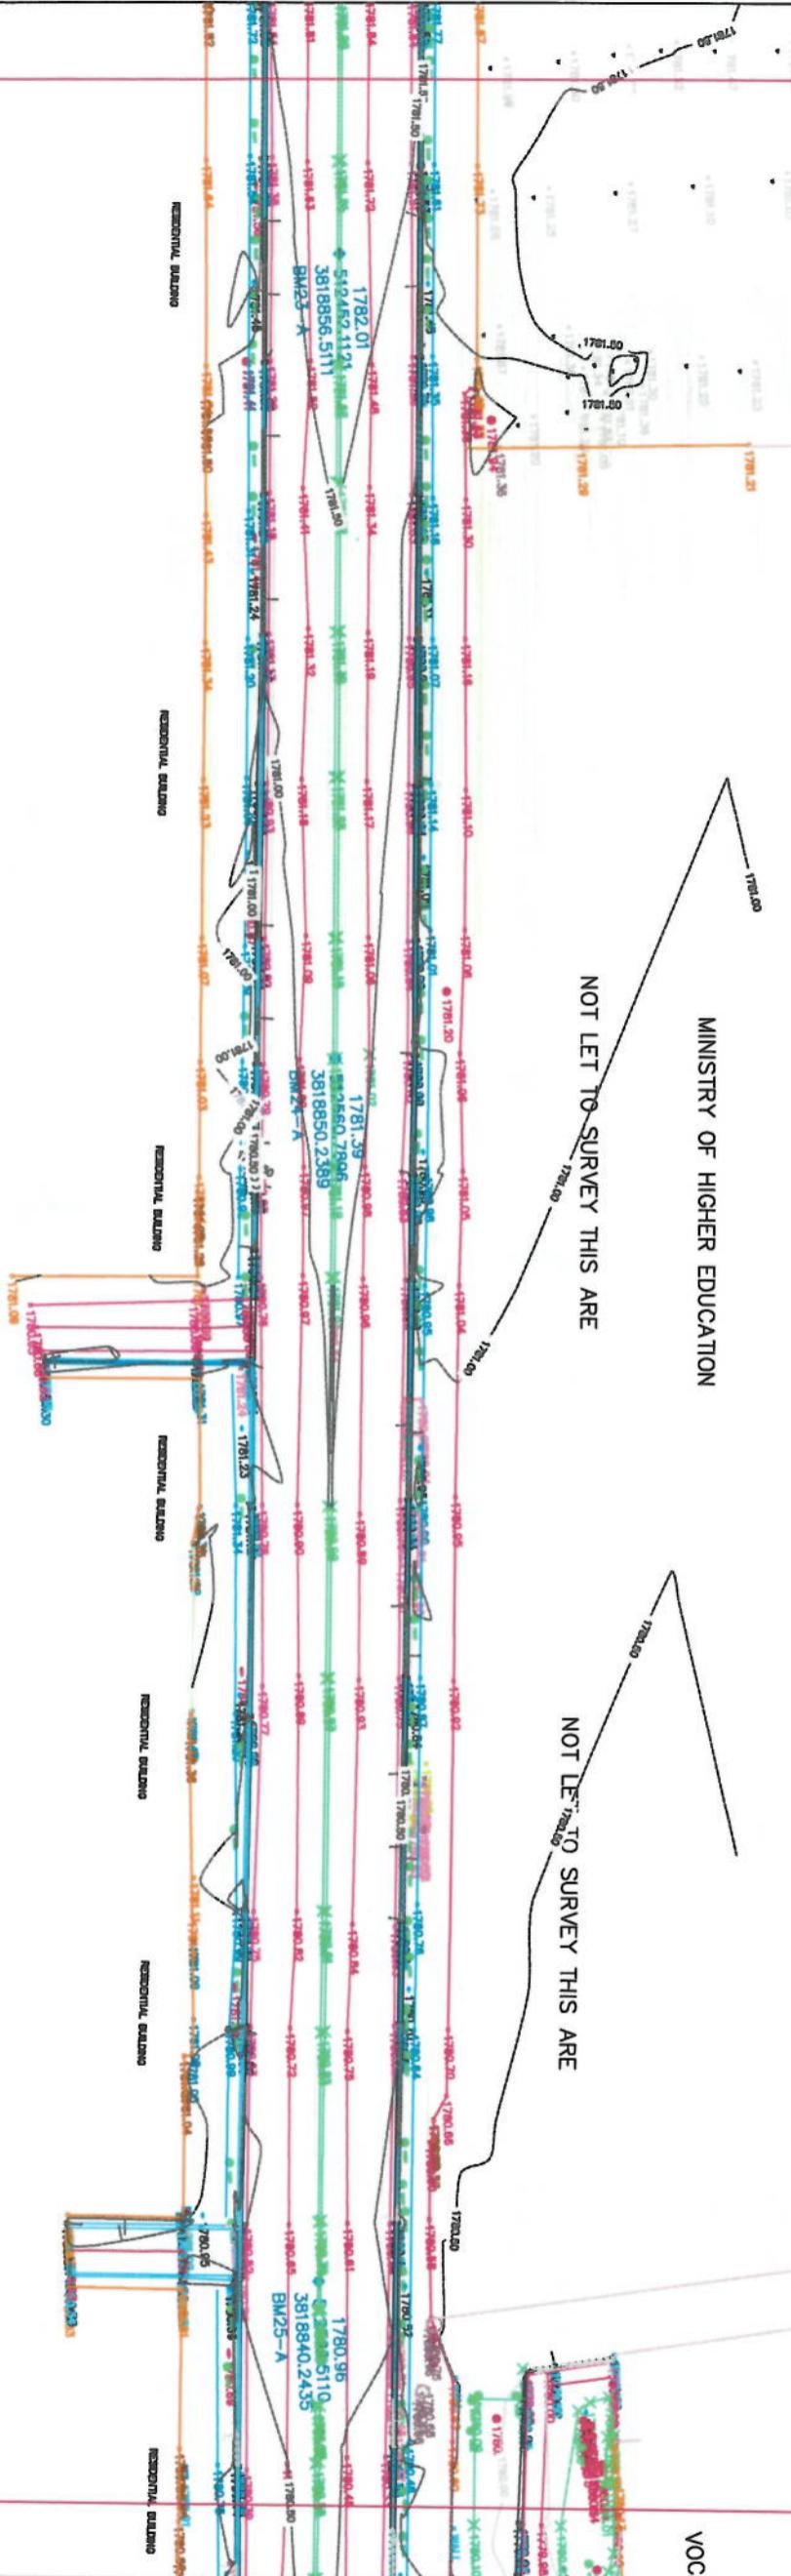


MATCH LINE - 6  
AT STATION - 1+974.00

**NOTE: 1. ALL DIMENSIONS ARE IN METERS  
UNLESS OTHERWISE INDICATED**

		PROJECT NAME: SURVEY FROM DAMAZANG SQUIRE UP TO KOTASANGI BRIDGE	
DRAWING TITLE:  SURVEY FROM DAMAZANG SQUIRE UP TO KOTASANGI BRIDGE			
SURVEYED BY:	ENG ABDILAH		
SURVEYED BY:	ENG ABDUL AHMAD		
SURVEYED BY:	ENG HASBULAH		
HEAD OF SURVEY:	ENG SAYED AHQ		
DATE:	SCALE: 1:1000		
STATUS:	TOPOGRAPHIC- SURVEY		
PROJECT CODE:			
DRAWING #:	6		
	REVERSE		



AT STATION - 1+974.00  
PREVIOUS SHEET NUMBER - 6

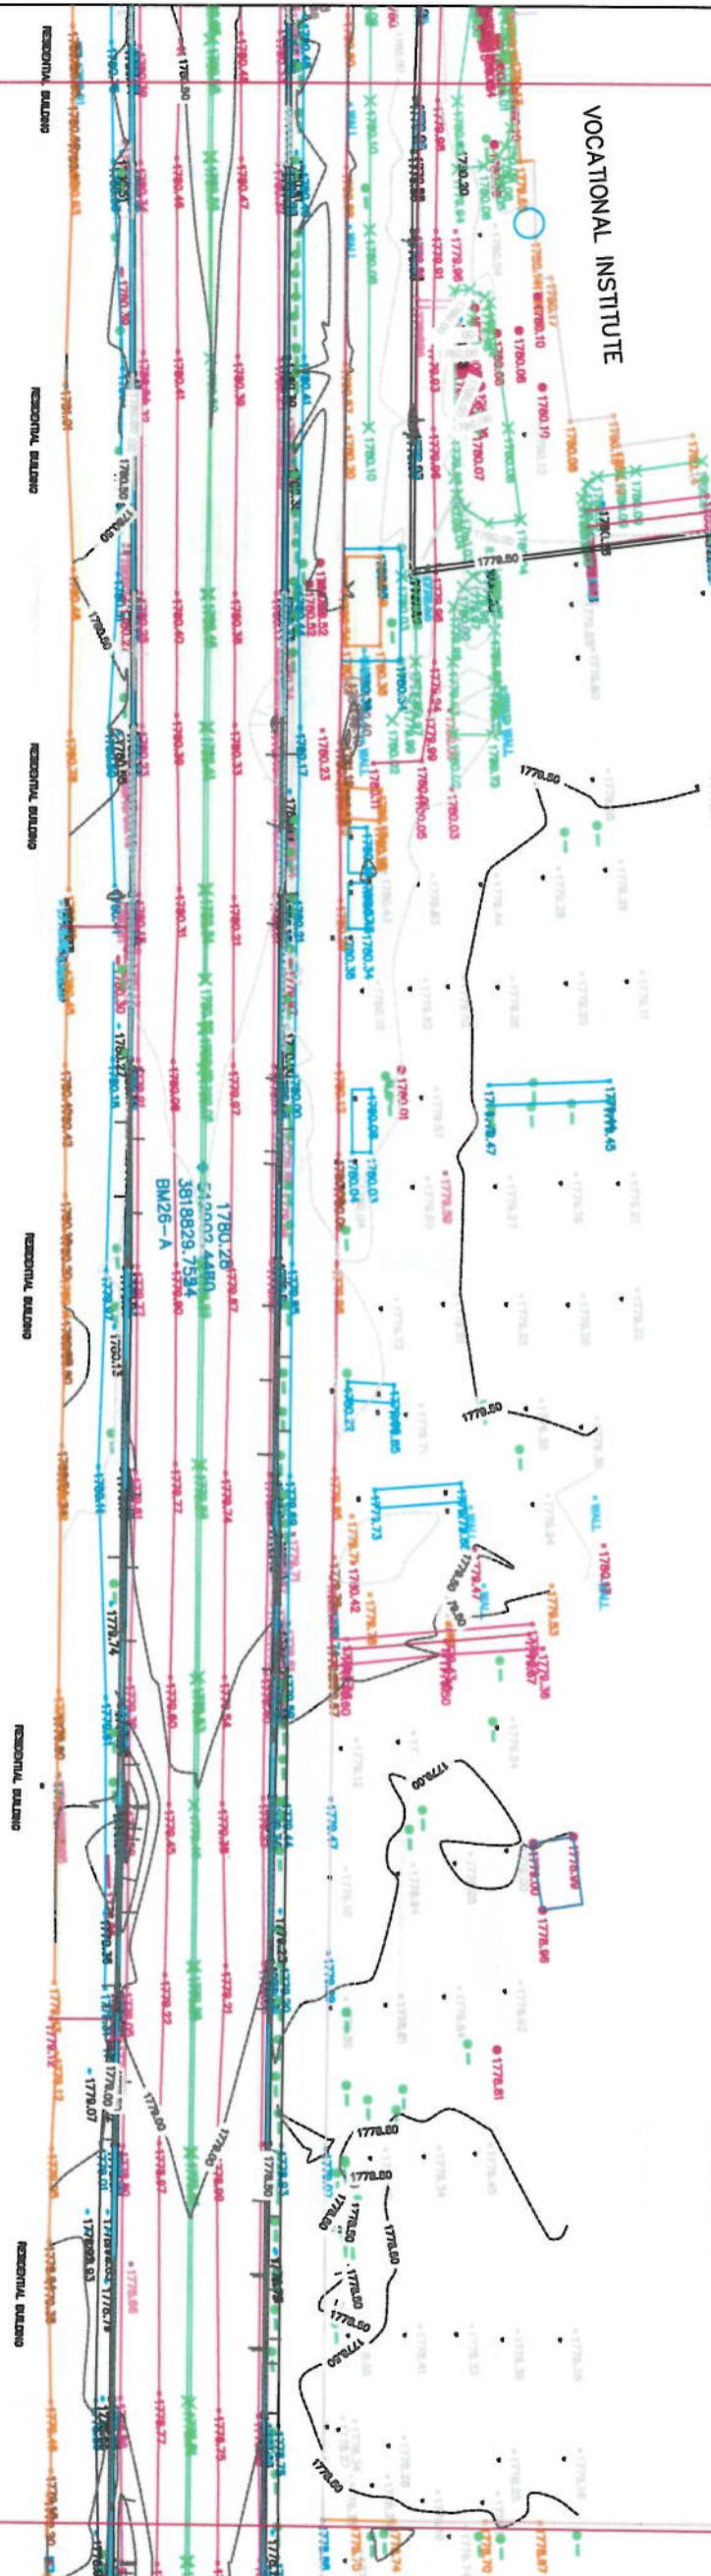

MATCH LINE - 7  
AT STATION - 2+303.00

**NOTE: 1. ALL DIMENSIONS ARE IN METERS  
UNLESS OTHERWISE INDICATED**

**DRAWING TITLE:**  
SURVEY FROM DAMAZANG SQUIRE  
UP TO KOTASANGI BRIDGE

AFGHANISTAN  
SURVEYED BY:  
KABUL MUNICIPALITY  
SURVEY TEAM

DRAWING #:		7	
ELEVATION:			
PROJECT CODE:			
TOPOGRAPHIC SURVEY		DATE:	
STATUS:		SCALE: 1:1000	
ENG. SAWED ATIQ		HEAD OF SURVEY:	
ENG. ABDULLAH		SURVEYED BY:	
ENG. HAMMAD ANASHD		ENG. ABDULLAH	
ENG. ABDULLAH		SURVEYED BY:	
ENG. HASSEEBULLAH		ENG. HASSEEBULLAH	
ENG. MAMATULLAH		ENG. MAMATULLAH	

AT STATION - 2+303.00  
PREVIOUS SHEET NUMBER - 7

### GHAZI HIGH SCHOOL

MATCH LINE - 8  
AT STATION - 2+632.00

NOTE: ALL DIMENSIONS ARE IN METERS  
UNLESS OTHERWISE INDICATED

LEGEND

TO CONVENTIONAL FIGURE

T-BL Building

T-RO Road

T-CAR Carriageway

C-MON Monorail

S-EDS Edible

E-HD House/House

F-CLC Construction Line

F-P River

F-L Canal


F-TR Trolley Rail

F-DS Ditch

F-MW Man-made

F-GR Gravel

AT STATION - 2+632.00  
PREVIOUS SHEET NUMBER - 8

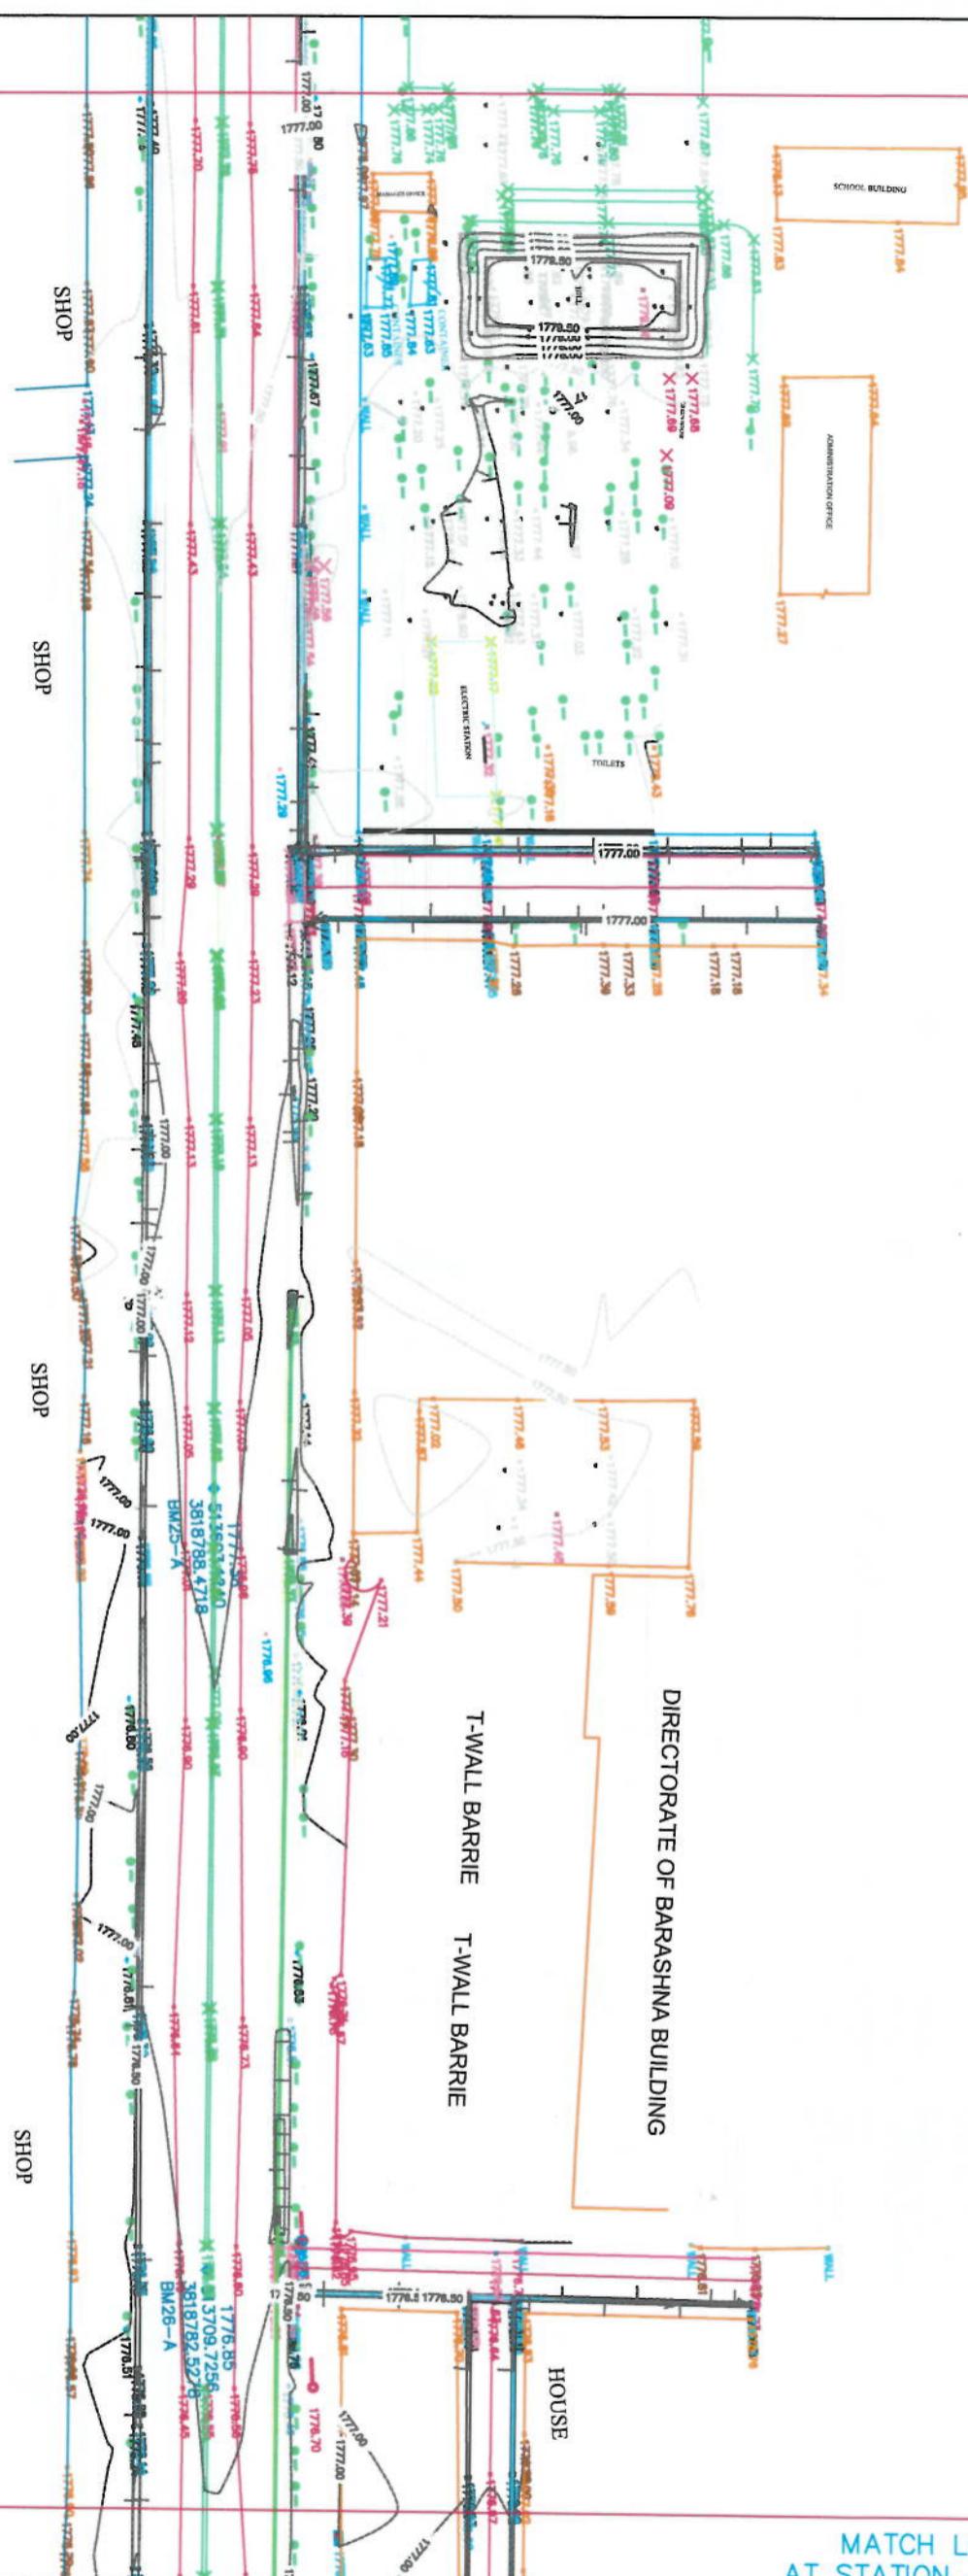


MATCH LINE - 9  
AT STATION - 2+961.00


NOTE: ALL DIMENSIONS ARE IN METERS  
UNLESS OTHERWISE INDICATED

LEGEND


NO.	CODE	DETAIL	FIGURE
1	CD	Control	
2	BL	Boundary	
3	BL	Boundary	
4	BD	Boundary	
5	TD	True Distance	
6	HD	House Number	
7	CL	Cross Line	
8	CC	Check Cross	
9	CS	Check Station	
10	CS	Check Station	
11	TCN	True Course	
12	HCN	House Course	
13	HCN	House Course	
14	HTA	House Number	
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241			

AT STATION - 2+961.00  
PREVIOUS SHEET NUMBER - 9

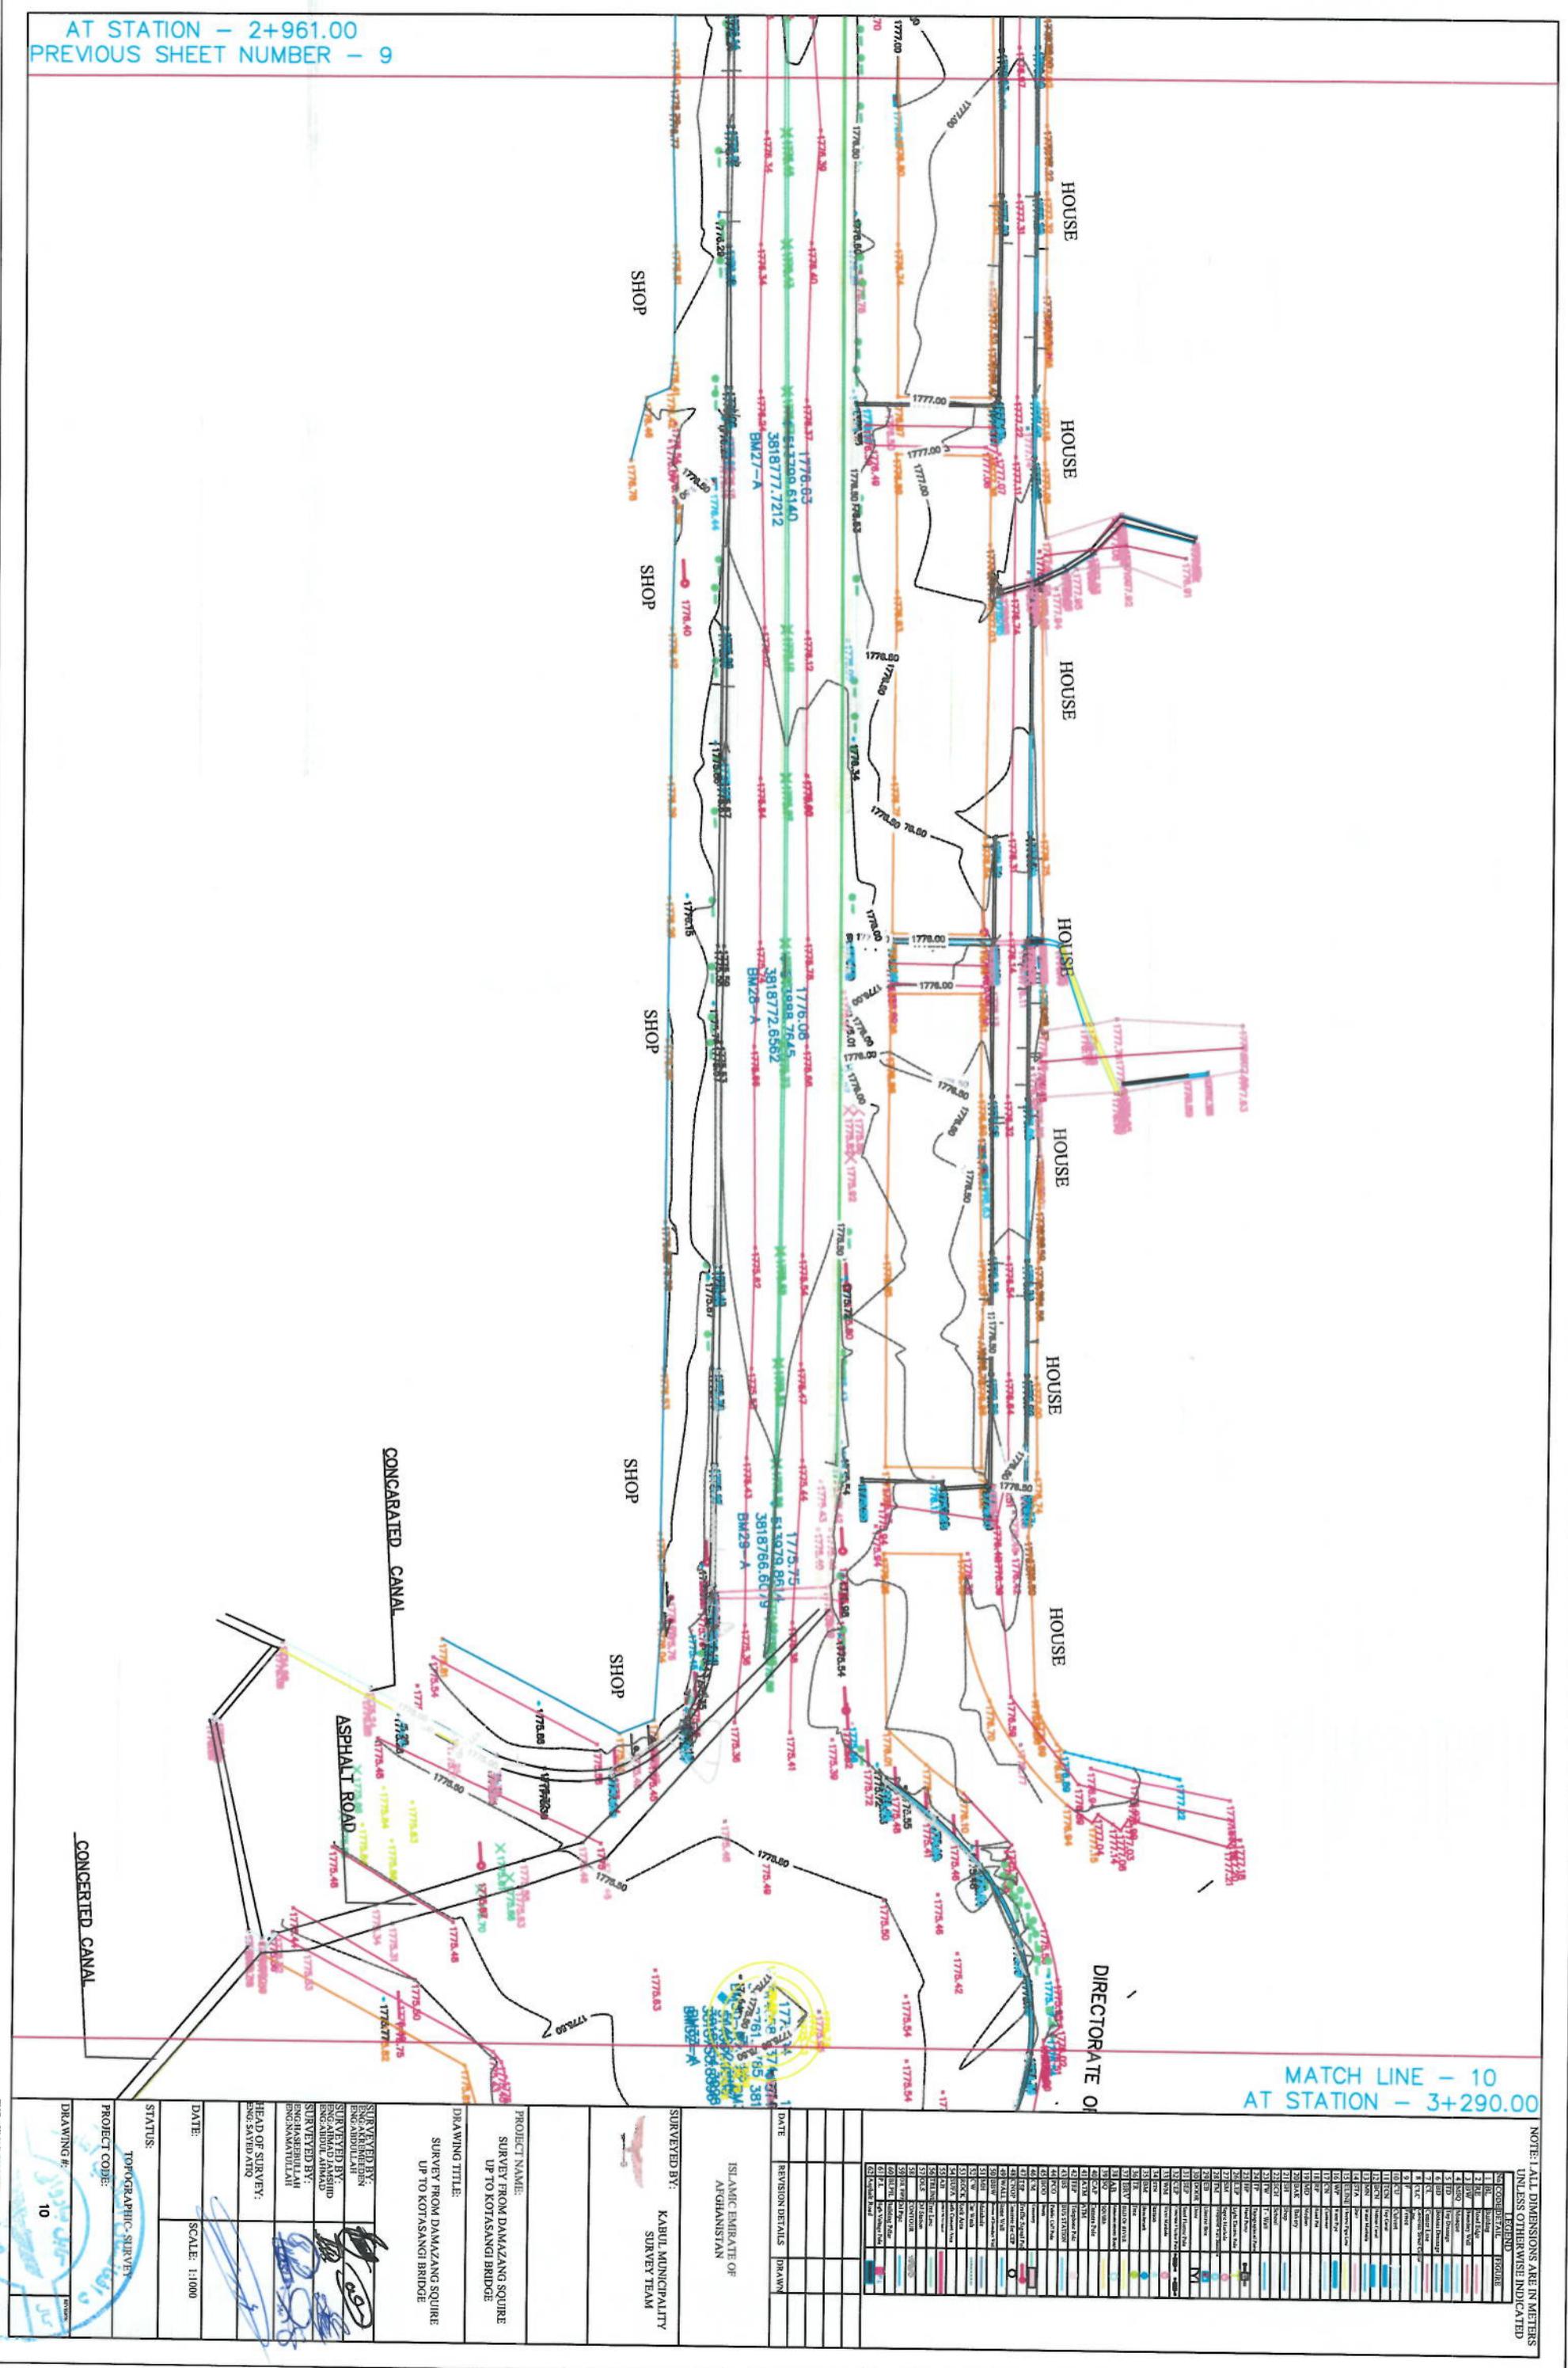

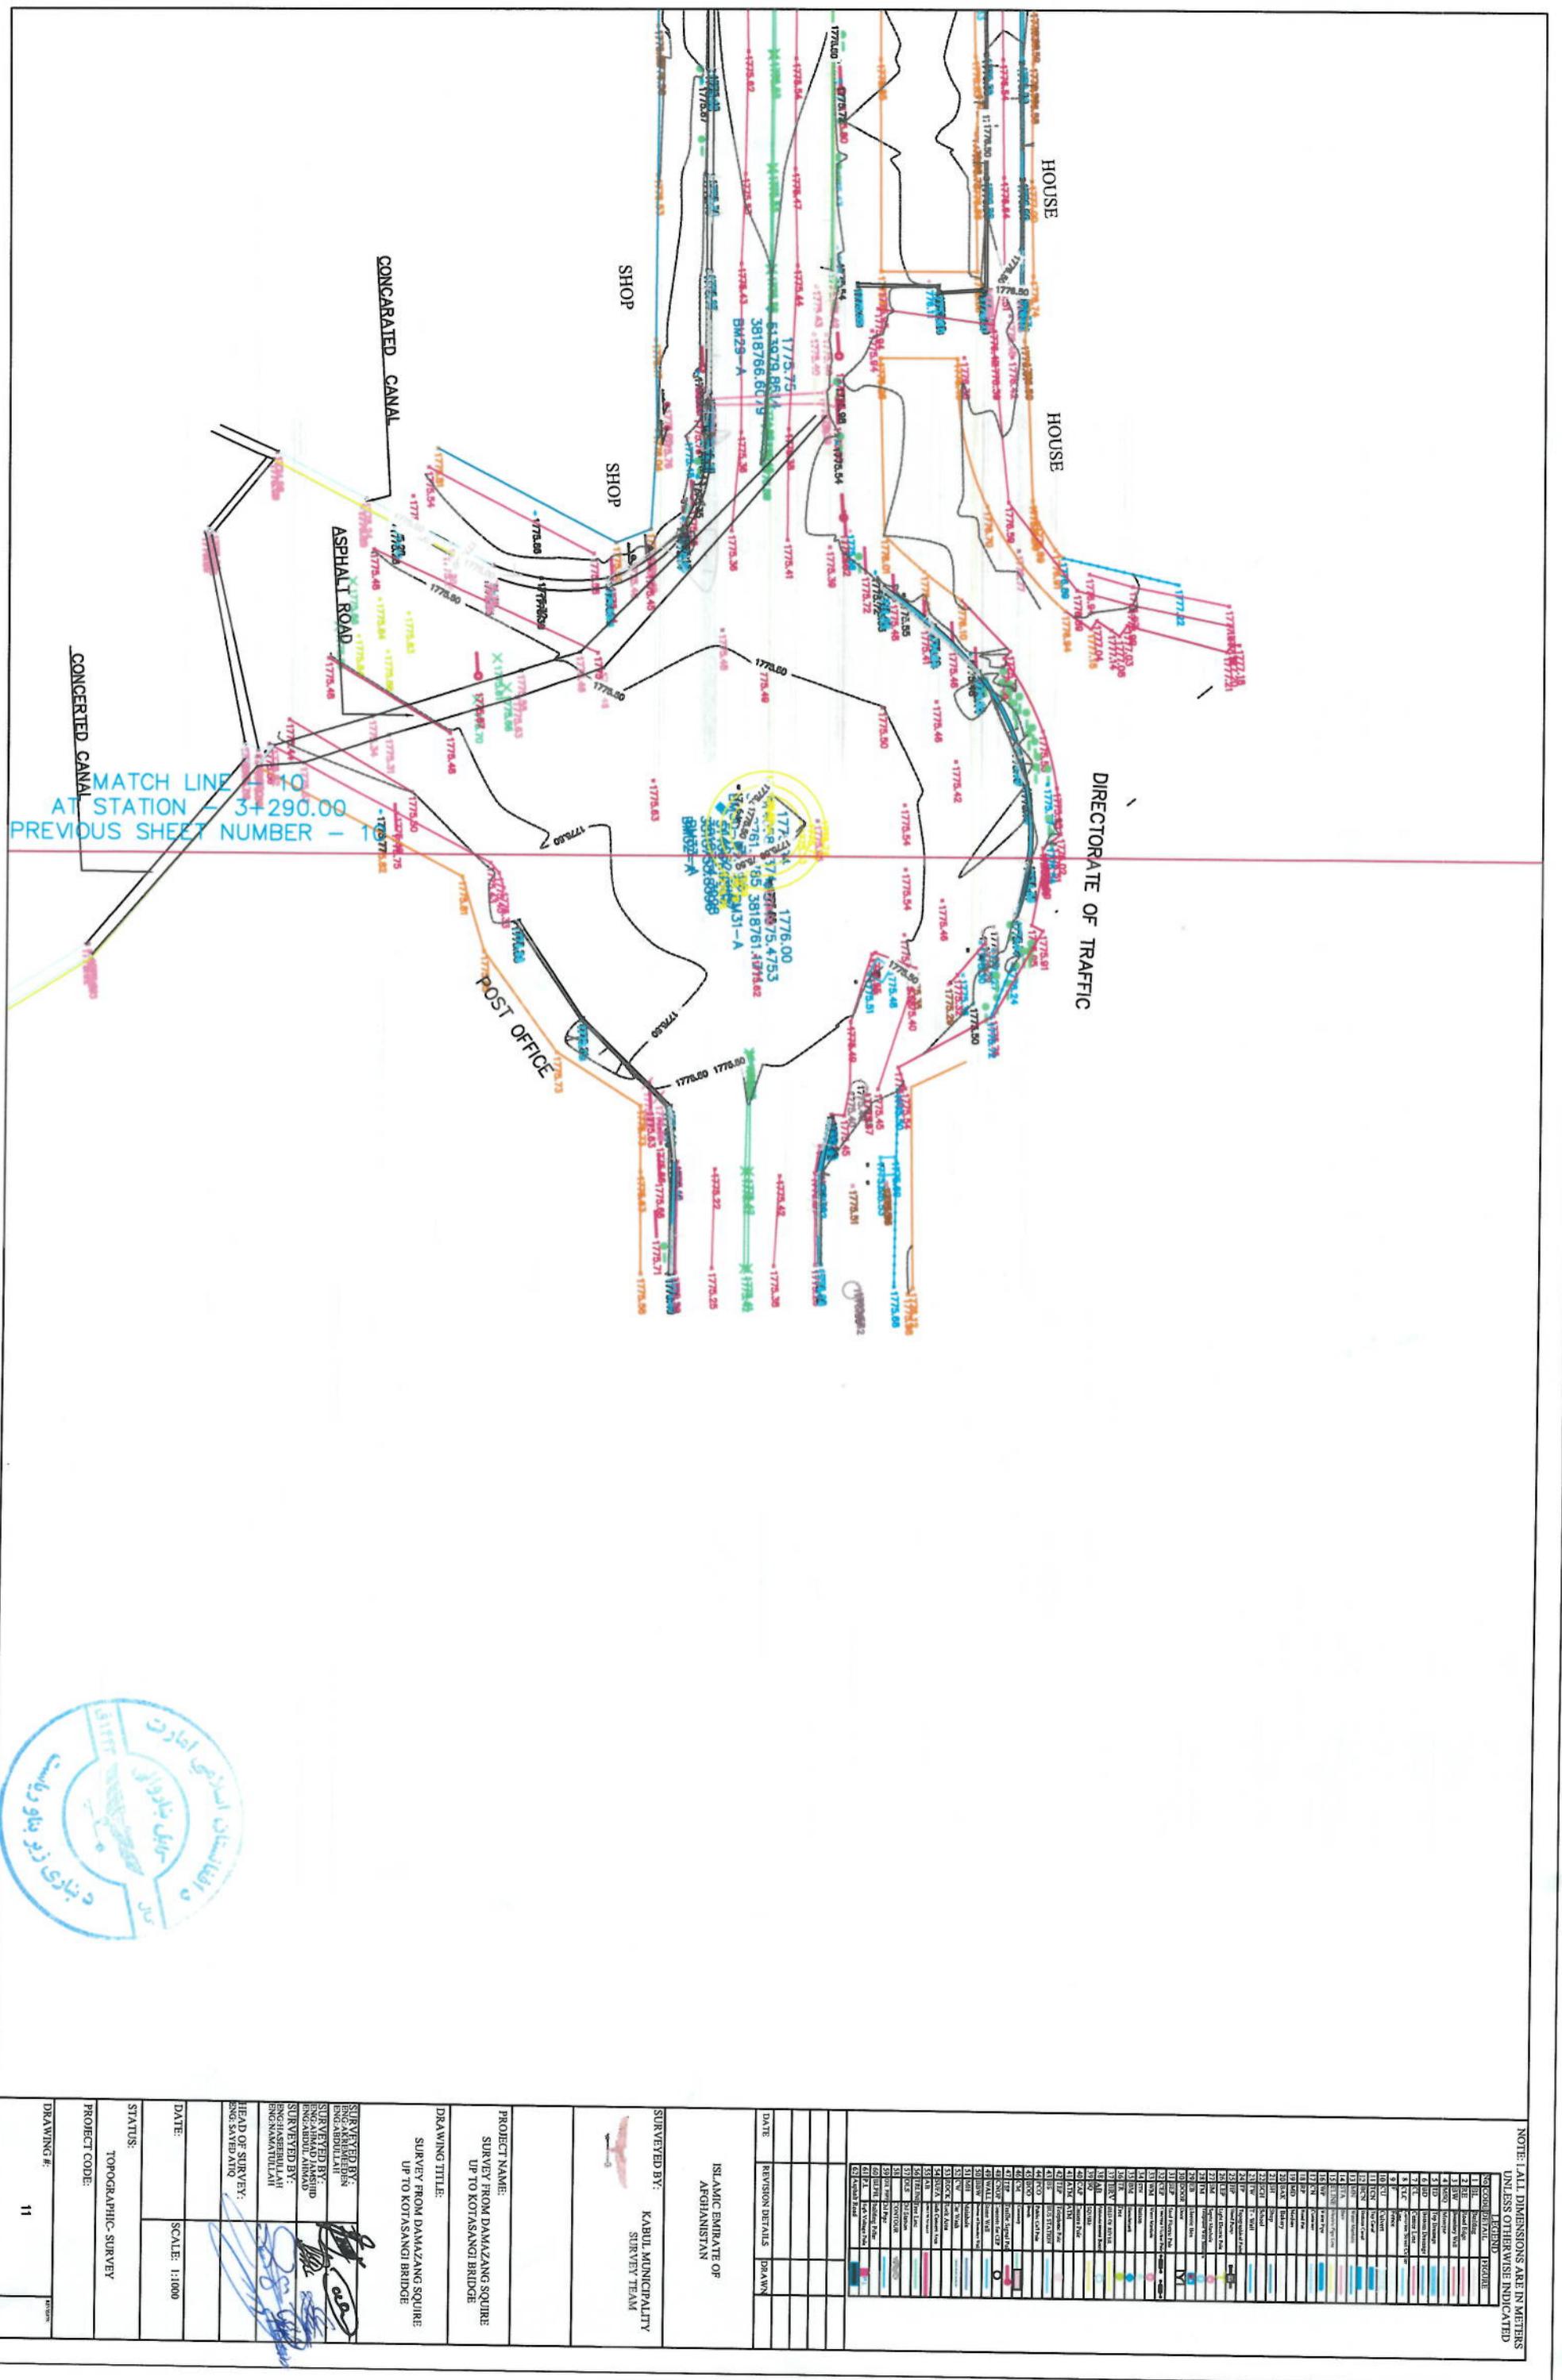

**NOTE: ALL DIMENSIONS ARE IN METERS**

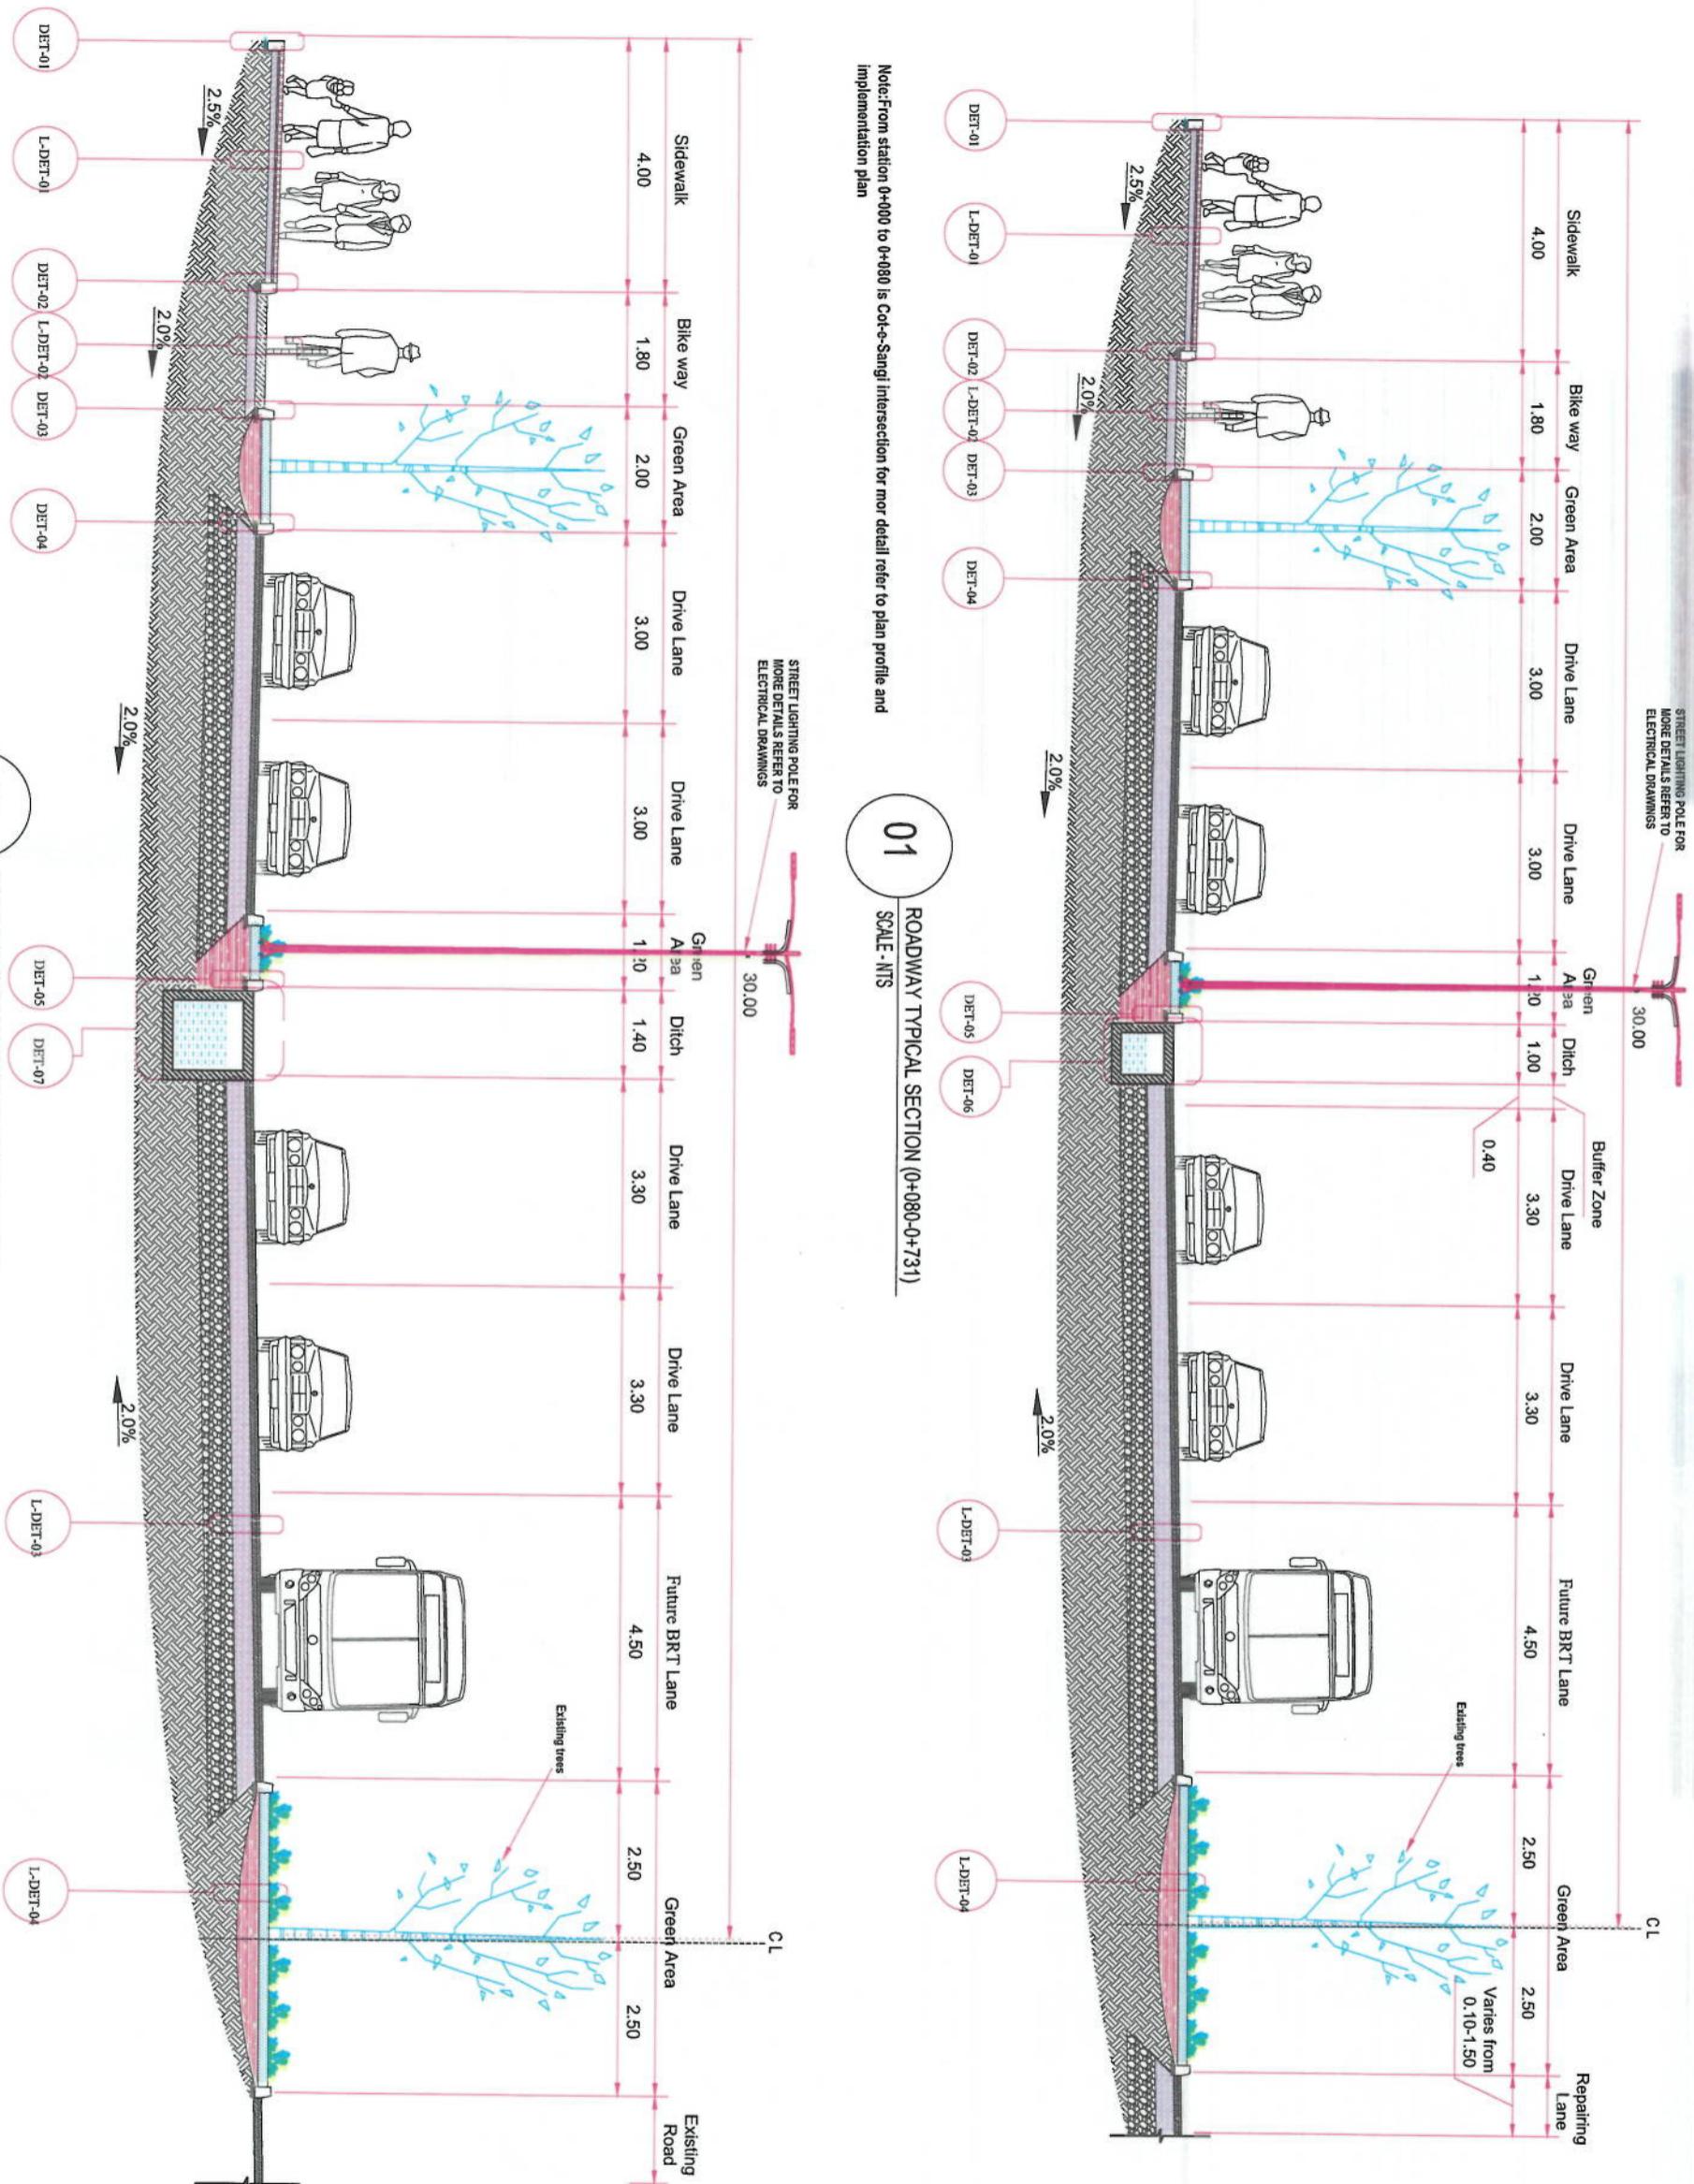

**NOTE:**

Islamic Emirate of  
Afghanistan

KABUL MUNICIPALITY  
DESIGN TEAM

Project Name:

### TYPICAL CROSS SECTION

2

Menhaju Rahman Signature: 

Mohammed Essa Sirat  
Signature

Reviewed: By John

100

卷之三

Date: 06-06-2023 Scale: 1:200


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Project Code


Drawing Number

TCS-01 00

卷之三

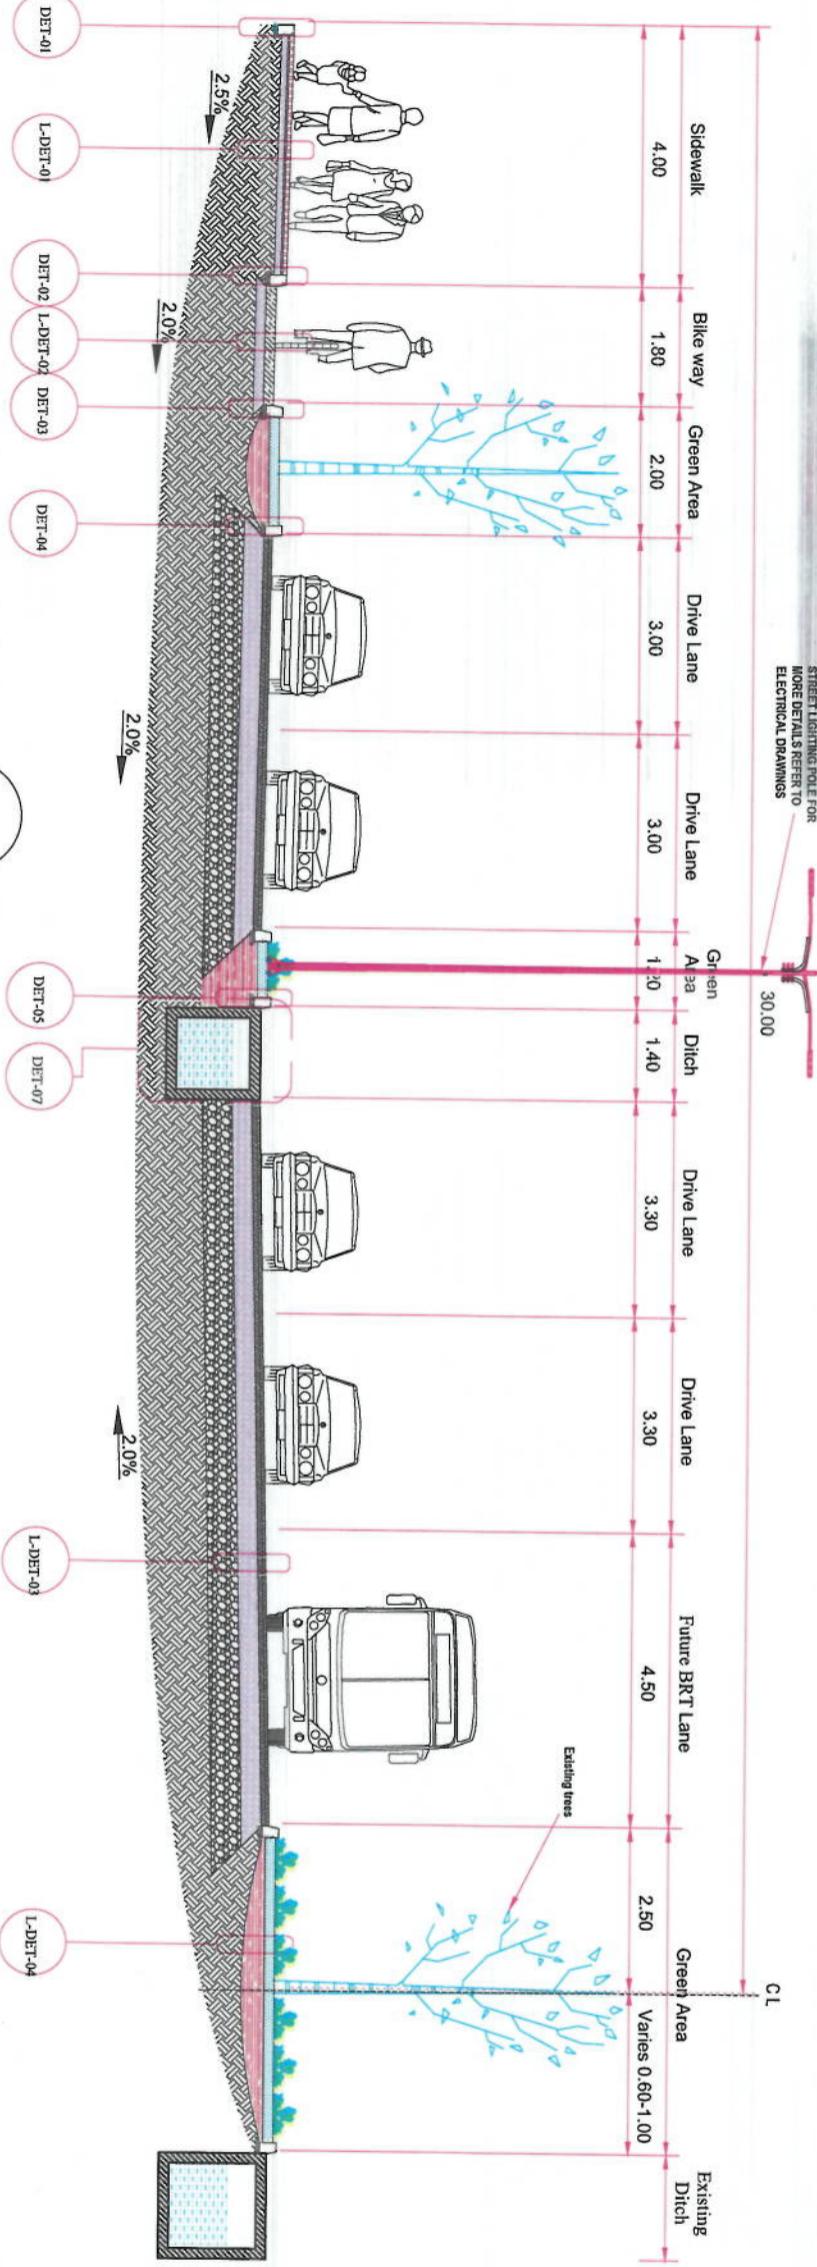

**03** ROADWAY TYPICAL SECTION (2+700-3+200)  
SCALE- MTS

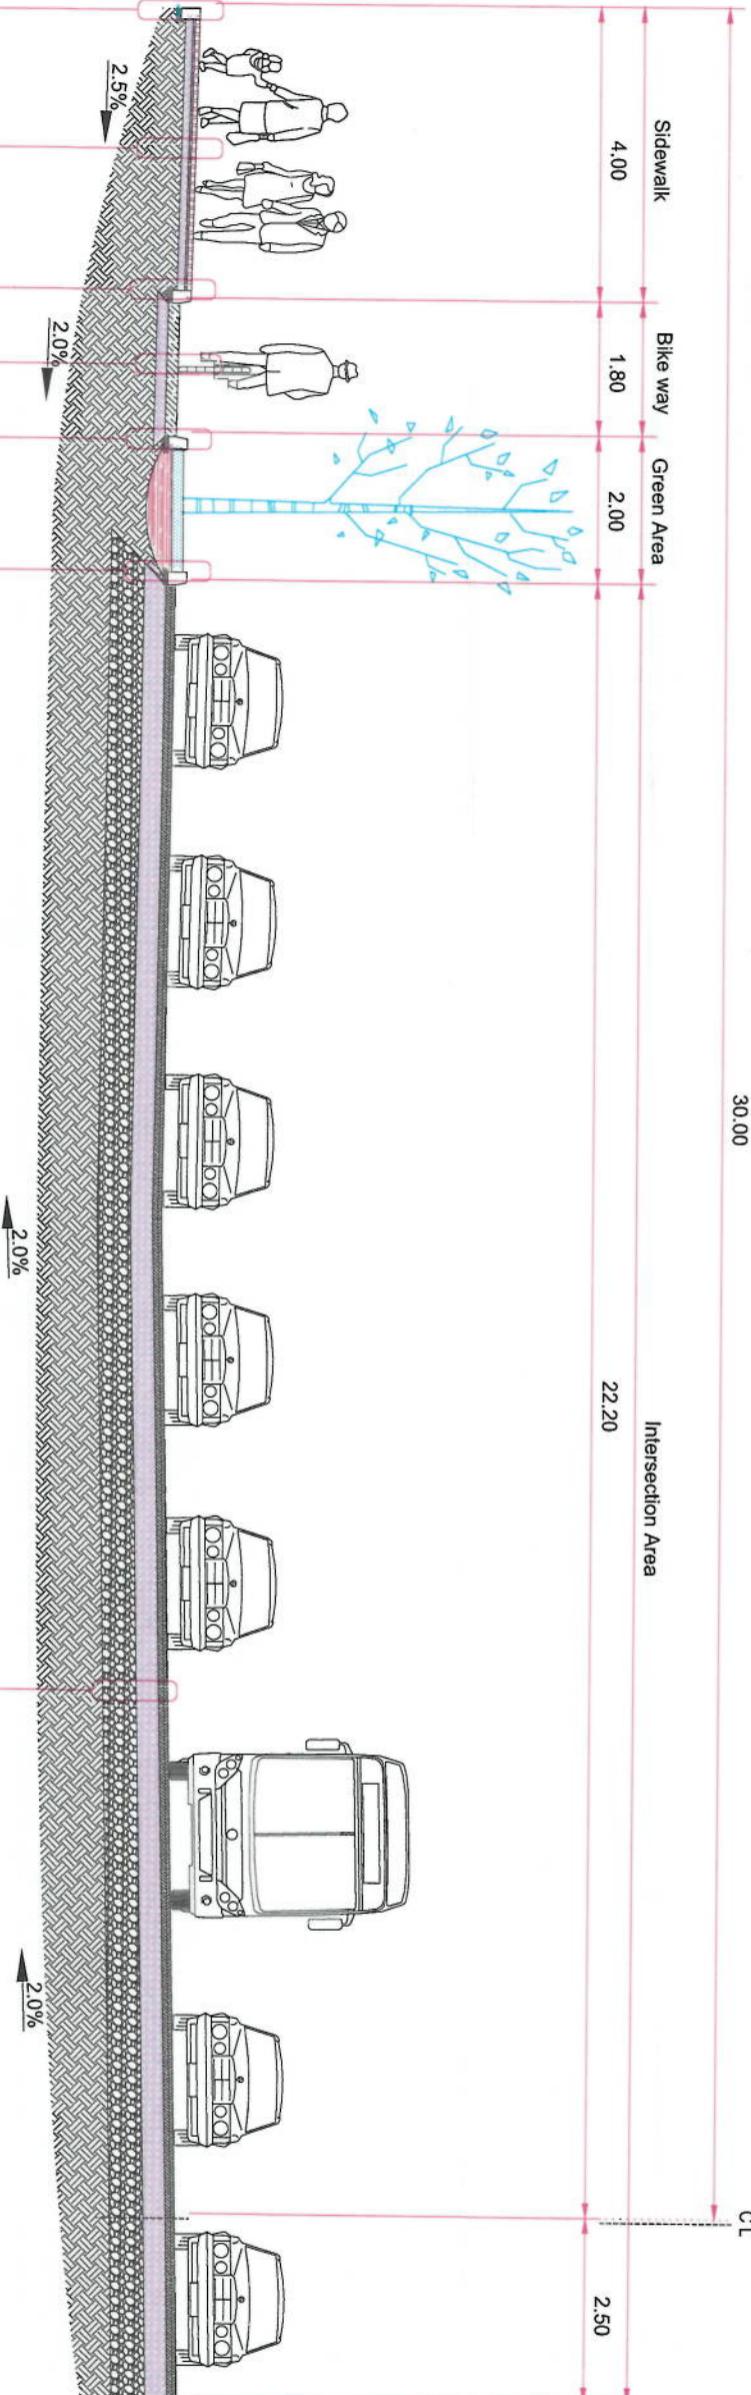

DEHMIZANG INTERSECTION TYPICAL SECTION (3+200-3+226)  
SCALE - MTS

**BEHMAZANG INTERSECTION TYPICAL SECTION (3+200-3+226)**

L-DET-03

**NOTE:**

1. All dimensions are in mm unless otherwise indicated.

1. All dimensions are in m unless otherwise indicated.


STREET LIGHTING POLE  
MORE DETAILS REFER TO  
**ELECTRICAL DRAWINGS**


1

2

Ne

1. All dimensions are in m unless otherwise indicated.

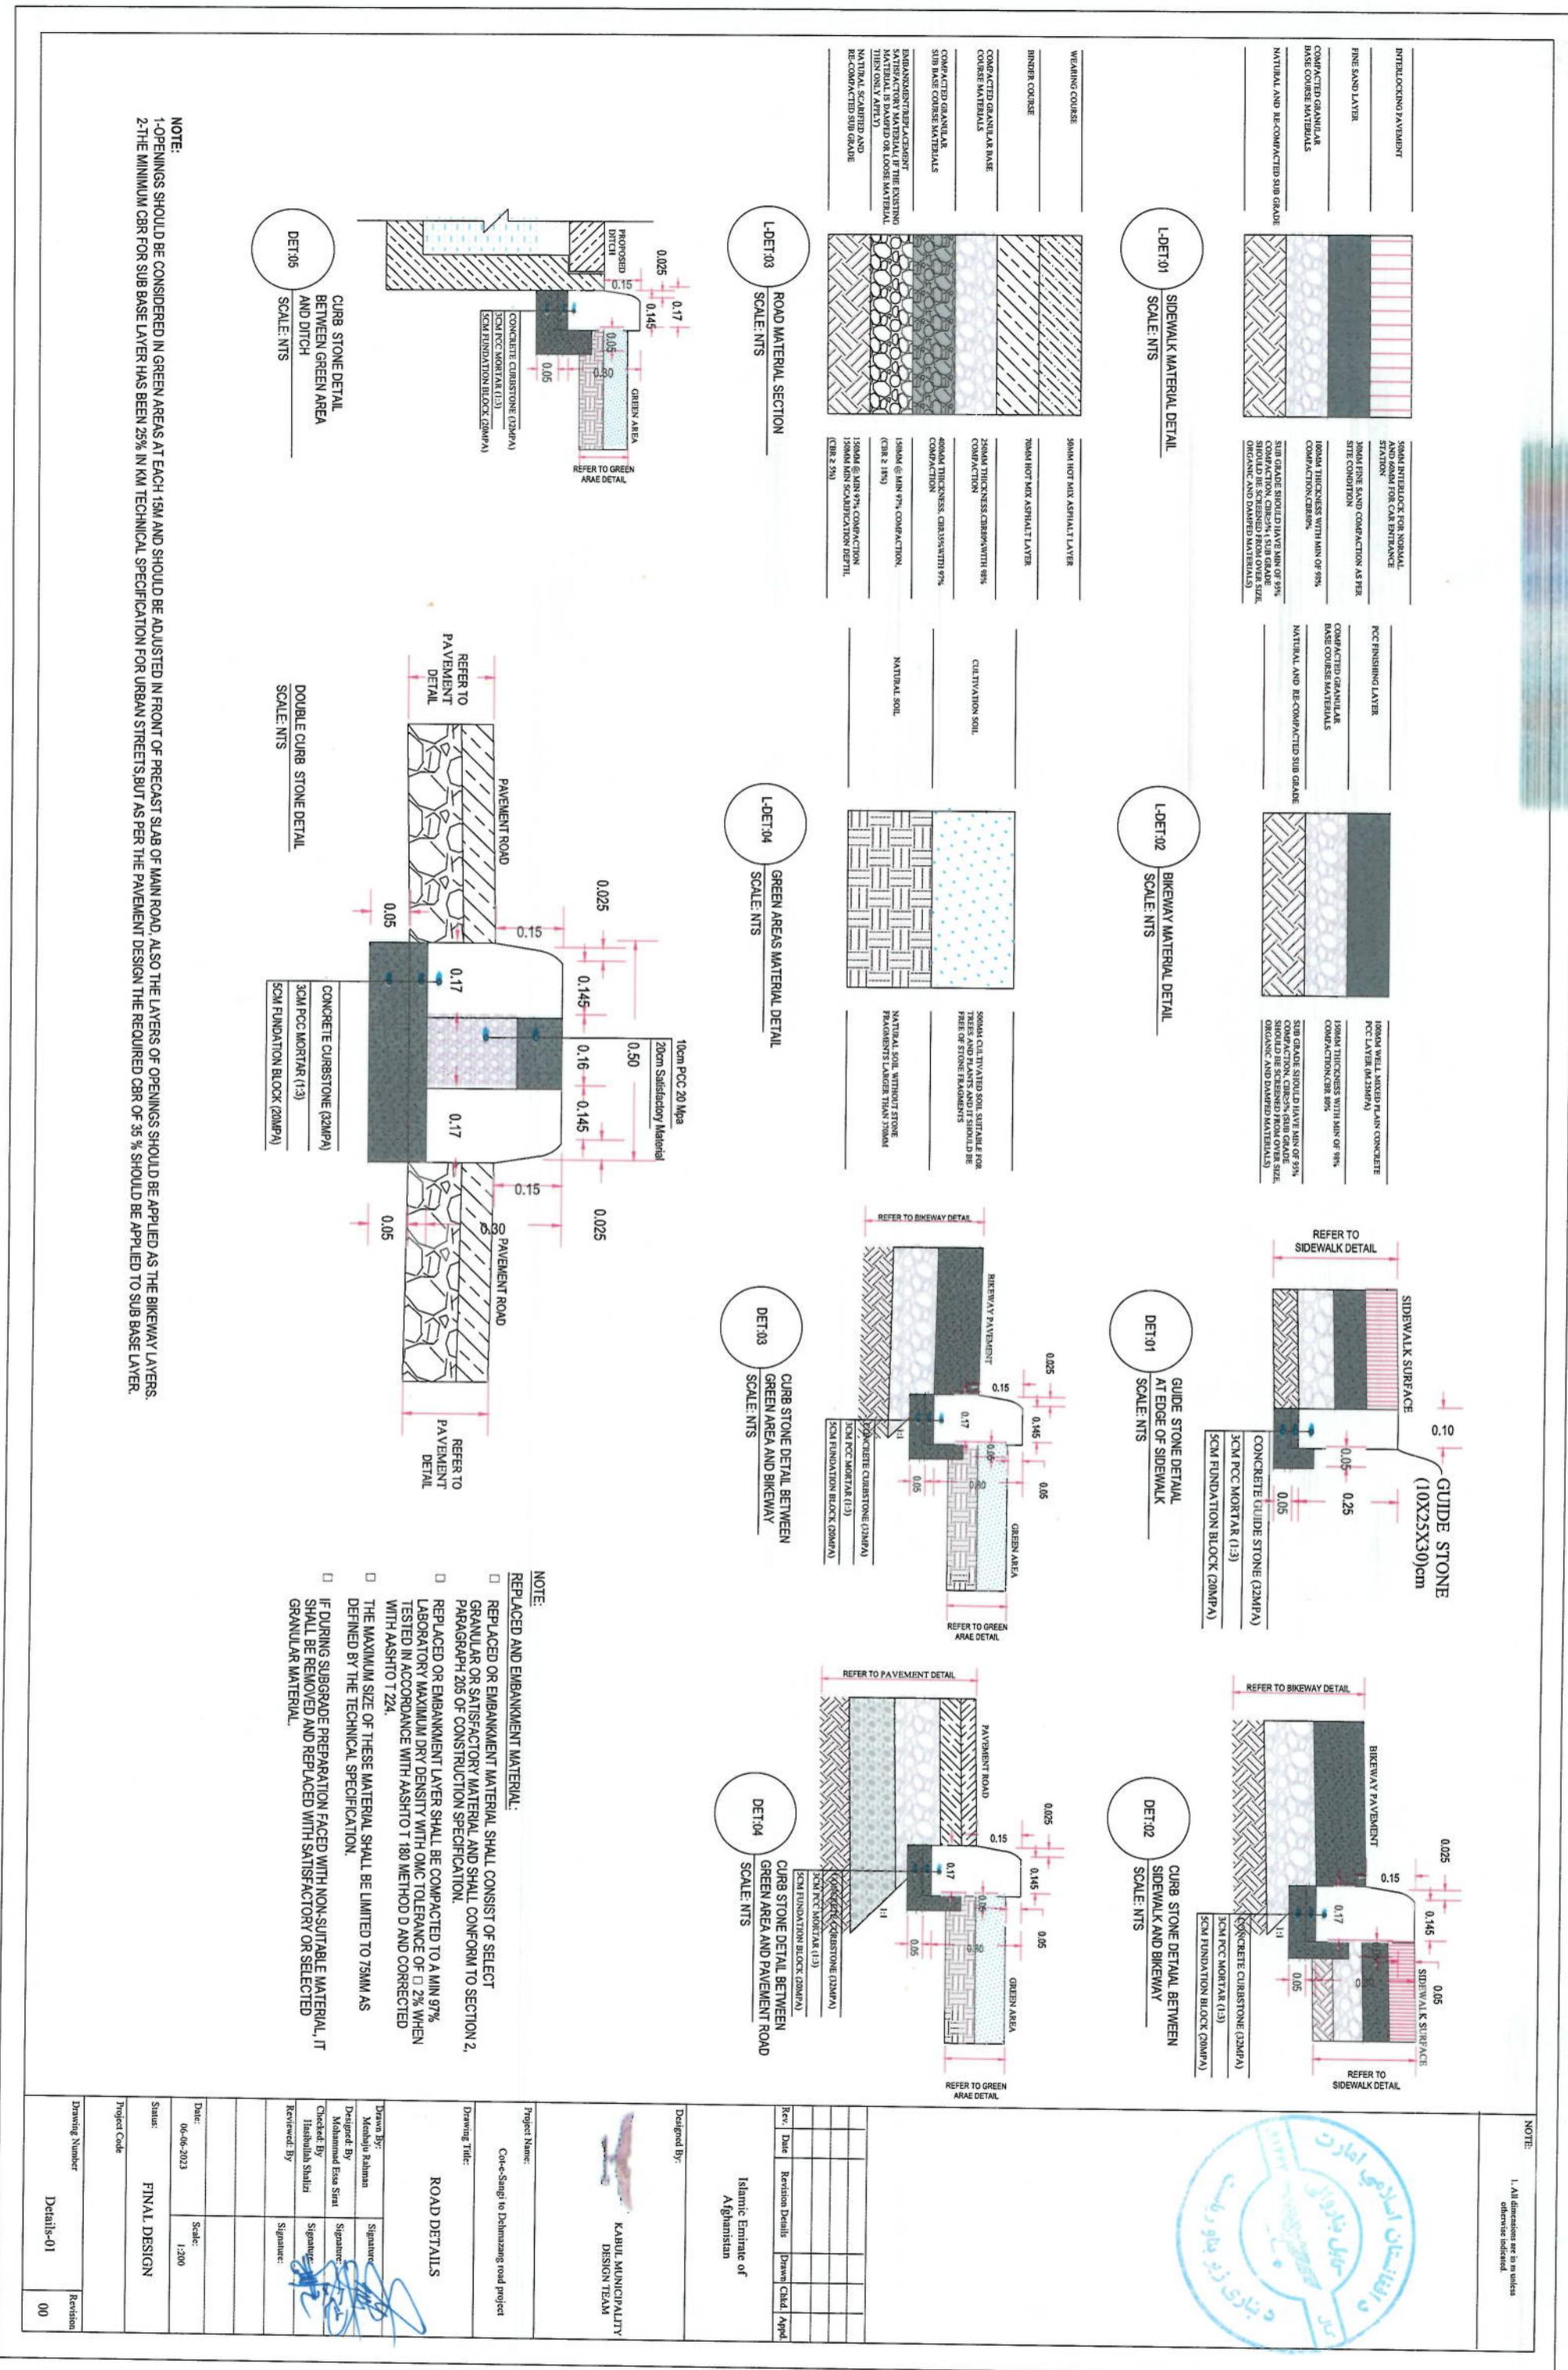

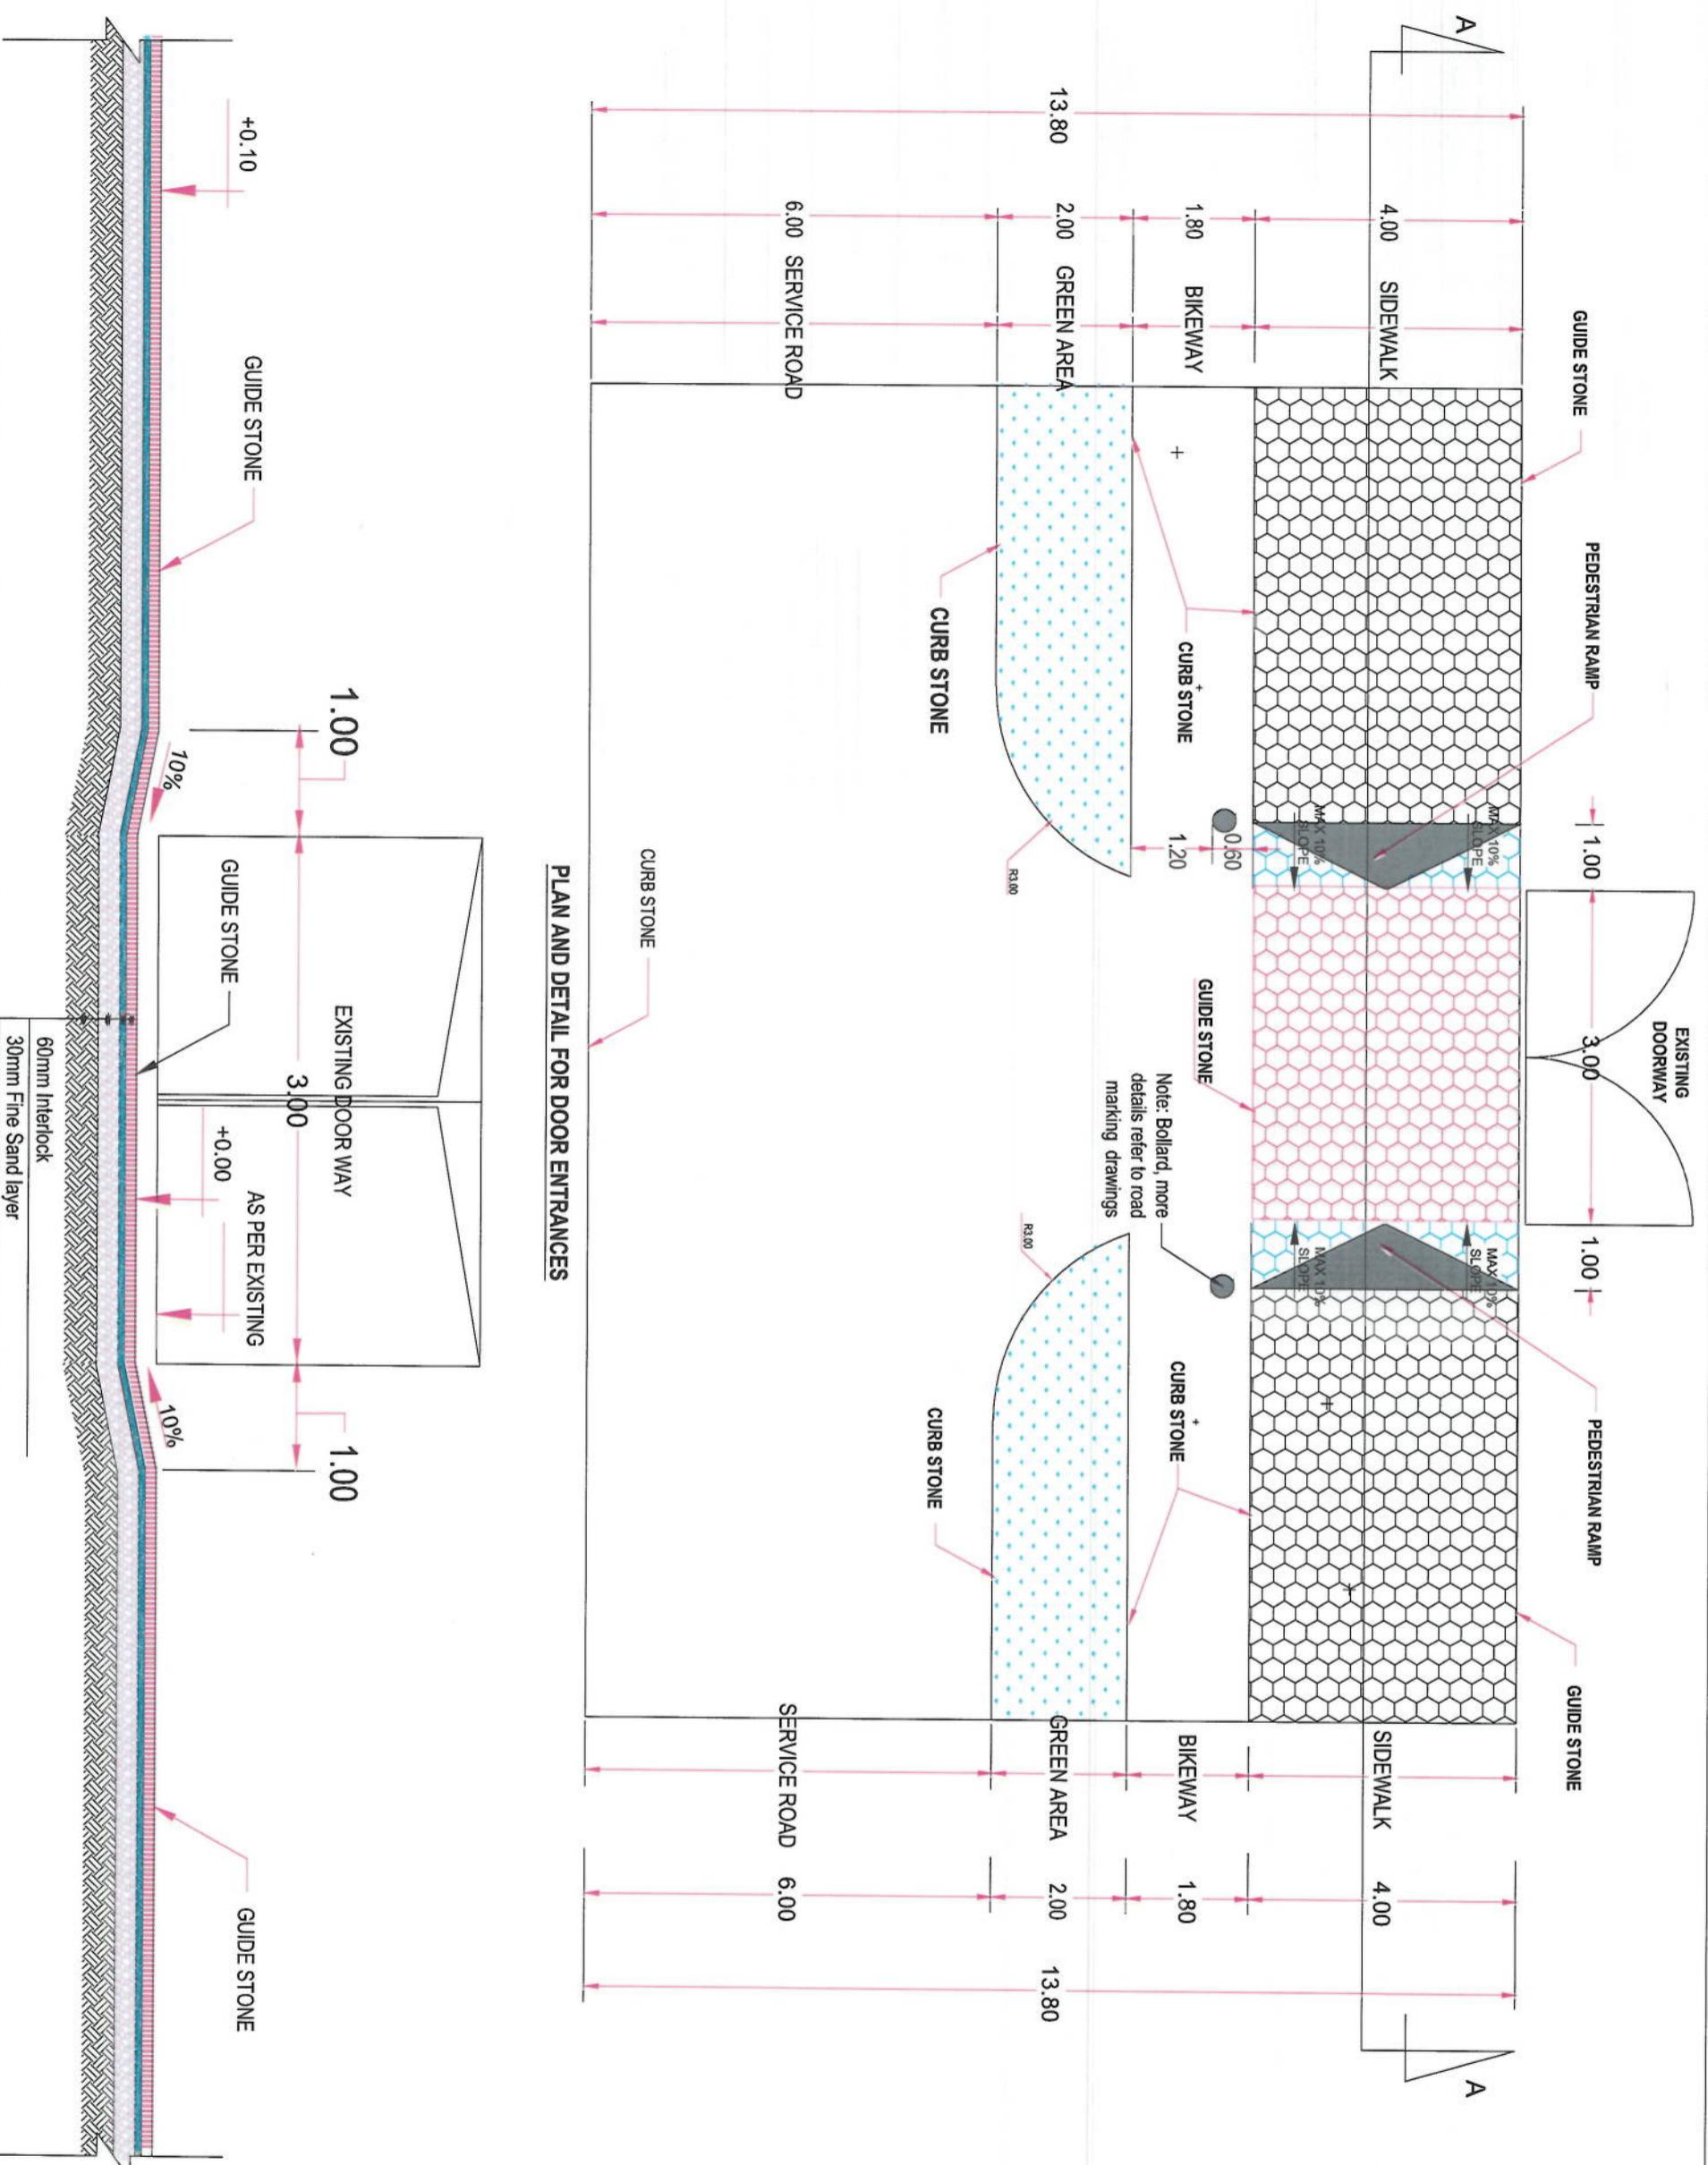

60mm Interlock  
30mm Fine Sand layer  
100mm Compacted Granular Base Course Materials  
Well Compacted Sub grade (Sub grade should be screened from over size, damped and organic materials)

## SECTION A-A FOR DOOR ENTRANCES

Project Name: Co-e-Sang to Dehuzang road project  
Drawing Title: Entrance Detail-01  
Drawn: Mehsud Rahim  
Signature: \_\_\_\_\_  
Designed: Mohammad Eesa Sirat  
Signature: \_\_\_\_\_  
Checked: Hashimullah Shalizi  
Signature: \_\_\_\_\_


KABUL MUNICIPALITY  
DESIGN TEAM

Rev.	Date	Revision Details	Drawn	Chkd.	Apvd

ISLAMIC EMIRATE OF  
AFGHANISTAN



Date: 06/06/2023 Scale: 1:75  
Status: FINAL DESIGN  
Project Code: Entrance Detail-01  
SHEET NO.: 01  
Revision: 01

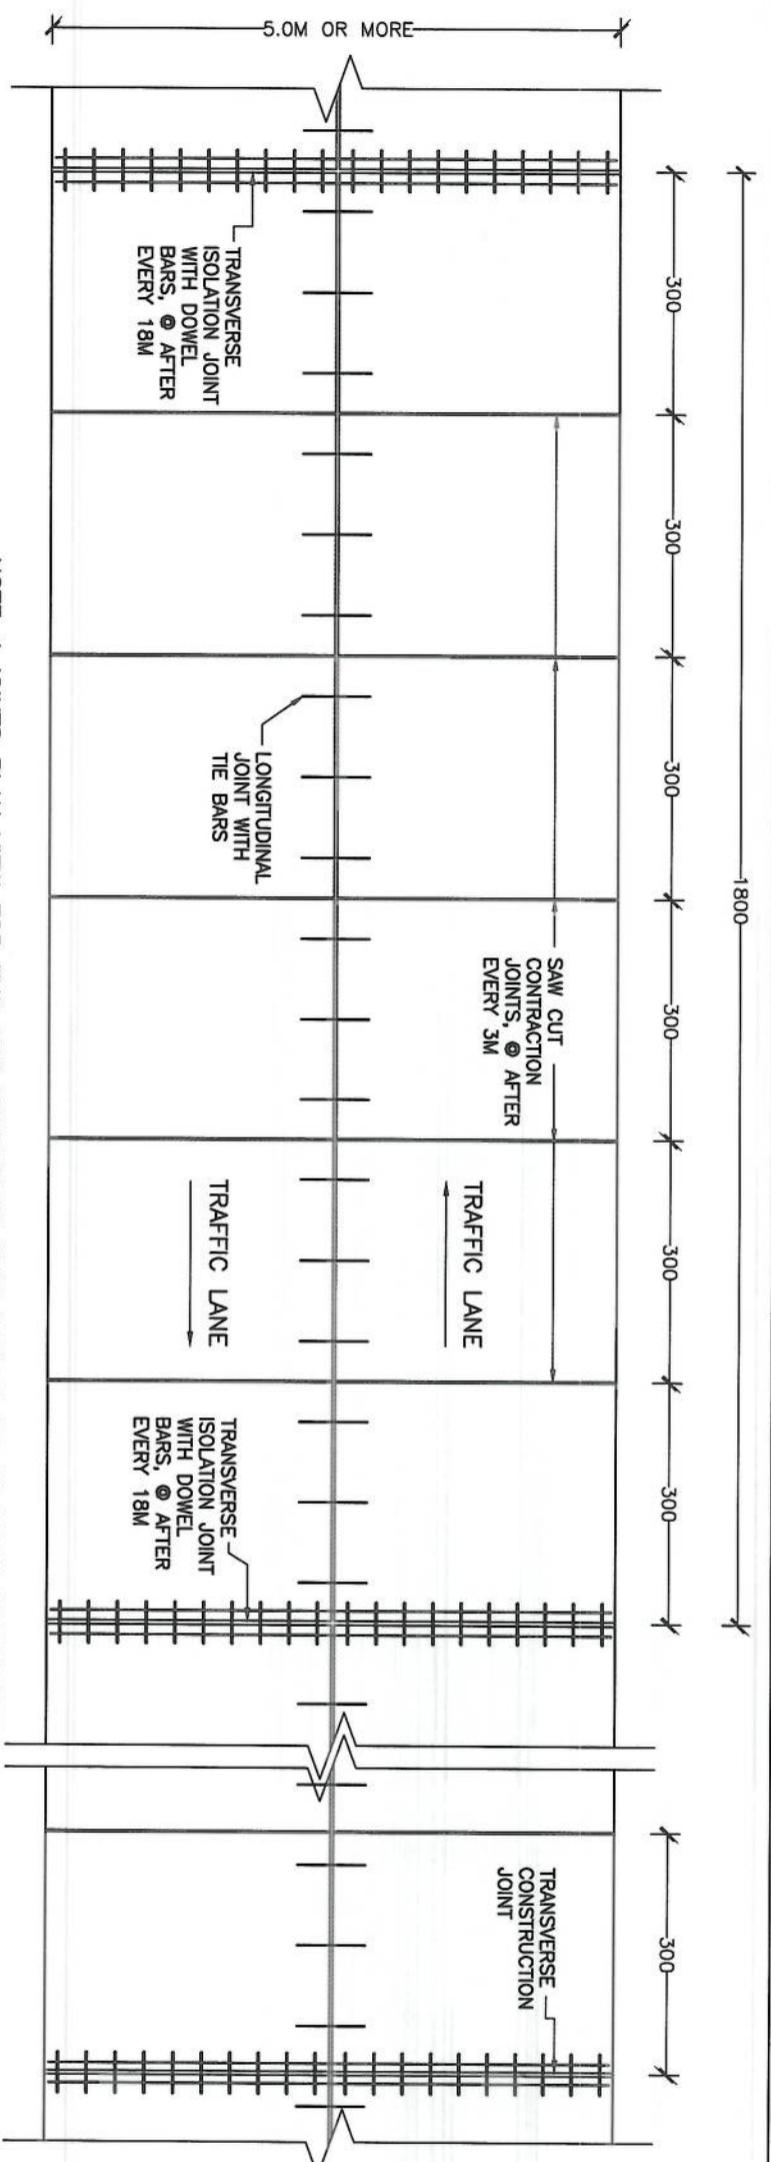


NOTE:

1. All dimensions are in meters unless otherwise indicated.


**02 ISOLATION JOINT REINFORCEMENT SCALE- AS SHOWN**

SCALE- AS SHOWN

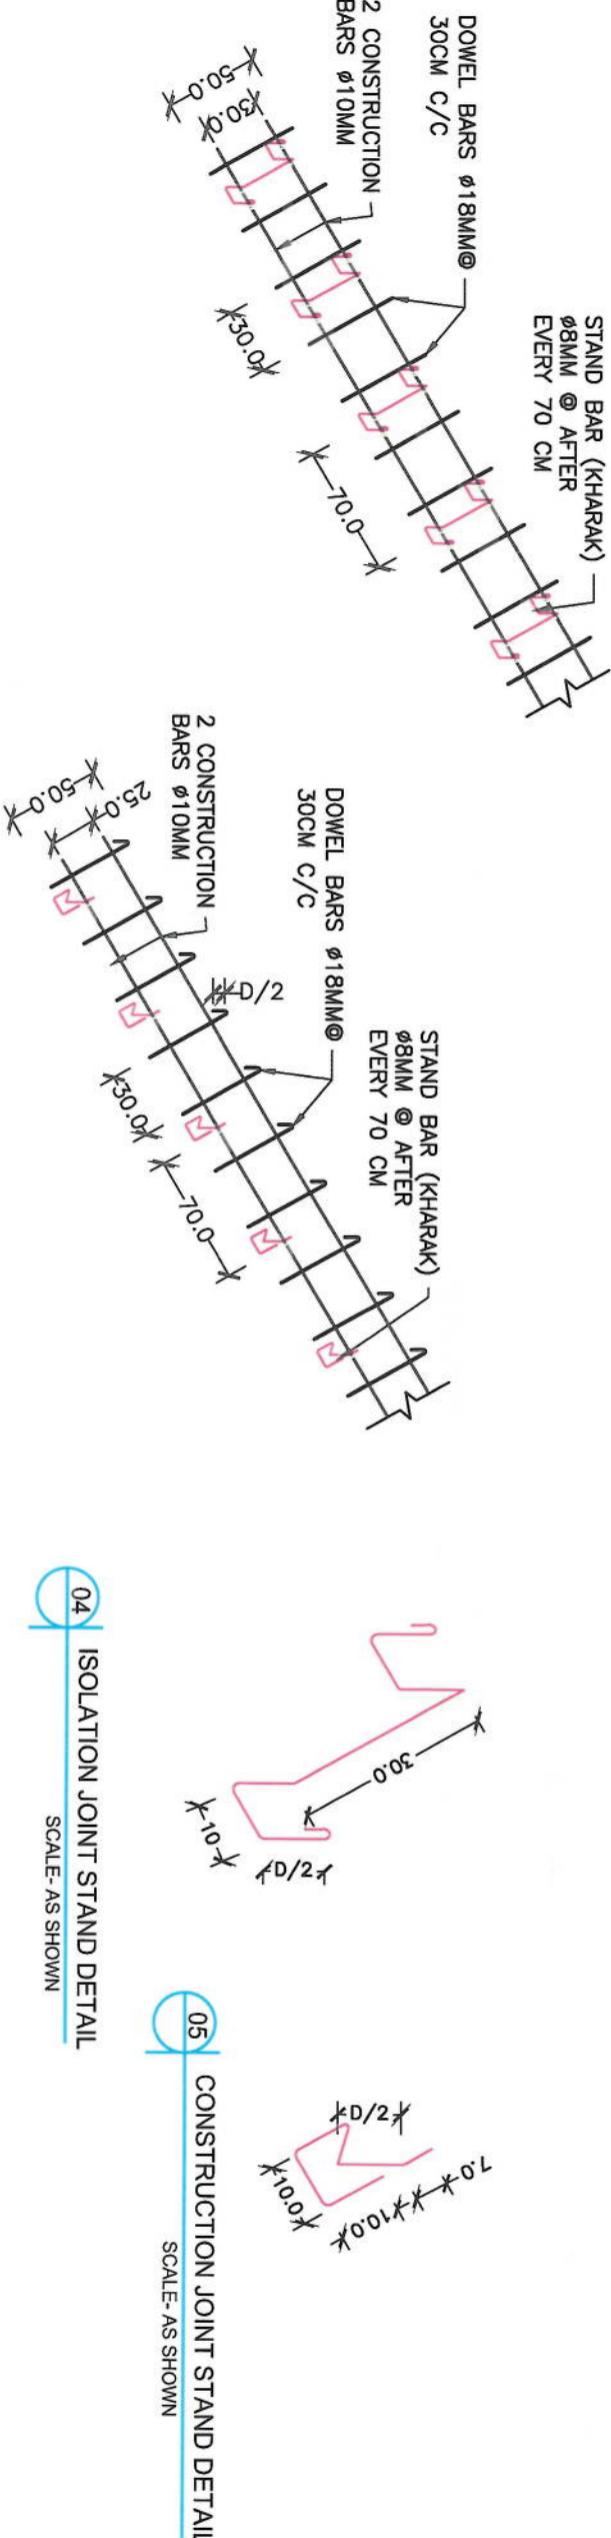

**03 CONSTRUCTION JOINT REINFORCEMENT**

NT REINFORCEMENT AS SHOWN

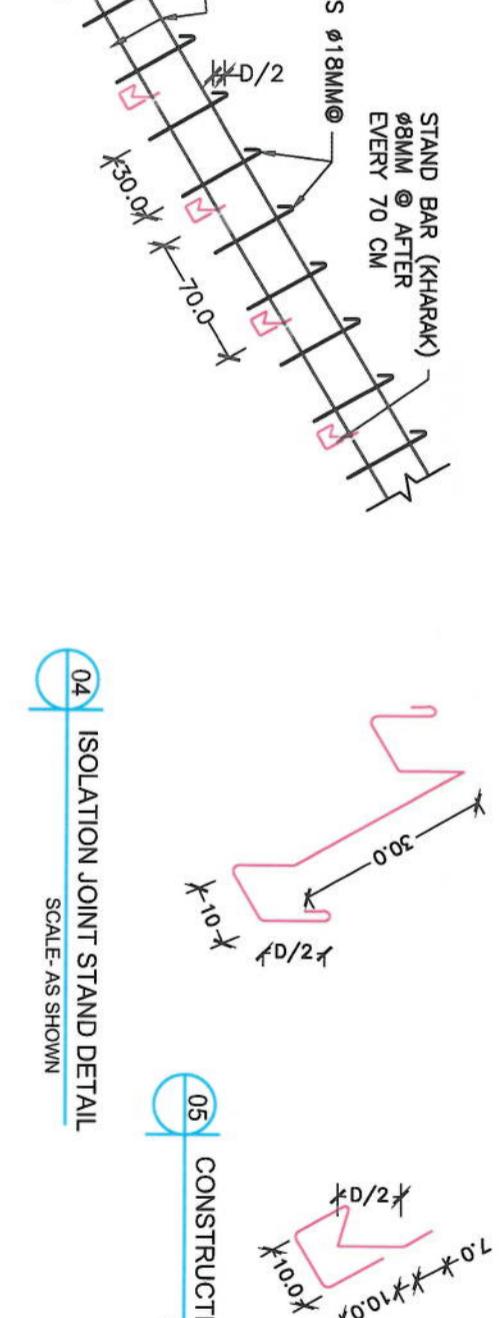

**NOTE:**

- 1) FOR MORE DETAILS PLEASE SEE PCC PAVEMENT JOINTS SECTION DETAILS.
- 2) TRANSVERSE JOINTS LENGTH MUST BE ACCORDING TO PAVEMENT CROSS WIDTH.


- 1) FOR MORE DETAILS PLEASE SEE PCC PAVEMENT JOINTS SECTION DETAILS.
- 2) TRANSVERSE JOINTS LENGTH MUST BE ACCORDING TO PAVEMENT CROSS WIDTH.

- 1) FOR MORE DETAILS PLEASE SEE PCC PAVEMENT JOINTS SECTION DETAILS.
  - 2) TRANSVERSE JOINTS LENGTH MUST BE ACCORDING TO PAVEMENT CROSS WIDTH.
  - 3) REMOVE WOODEN PANEL, ONE SIDE CONSTRUCTION BAR AND STAND (KHARAK) FROM CONSTRUCTION JOINT.
  - 4) ALL UNITS ARE IN CM.

ISLAMIC EMIRATE OF  
AFGHANISTAN


Designed By:	
 <b>KARUL MUNICIPALITY</b> DESIGN TEAM	
Project Name:	Co-e-Sangti to Dehmazang road project
Drawing Title:	

Project Code	DESIGN
SHEET NO.	Revision

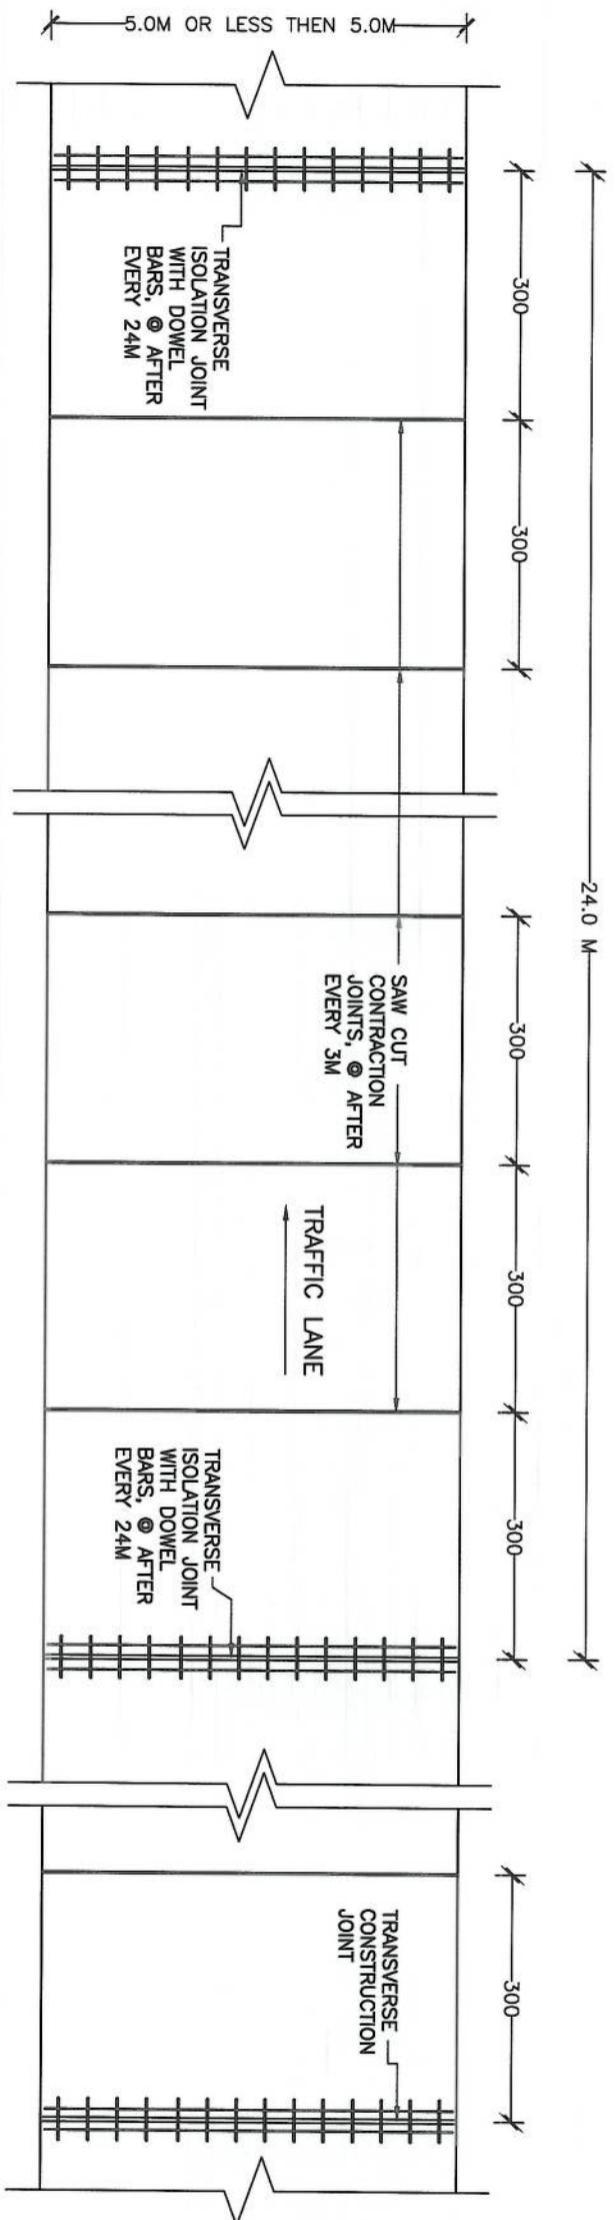

NOTE: JOINTS PLAN VIEW FOR THE PCC PAVEMENTS THAT HAVE LESS THAN 5.0M TRANSVERSE WIDTH


01 BIKEWAY PLAN VIEW  
SCALE: AS SHOWN

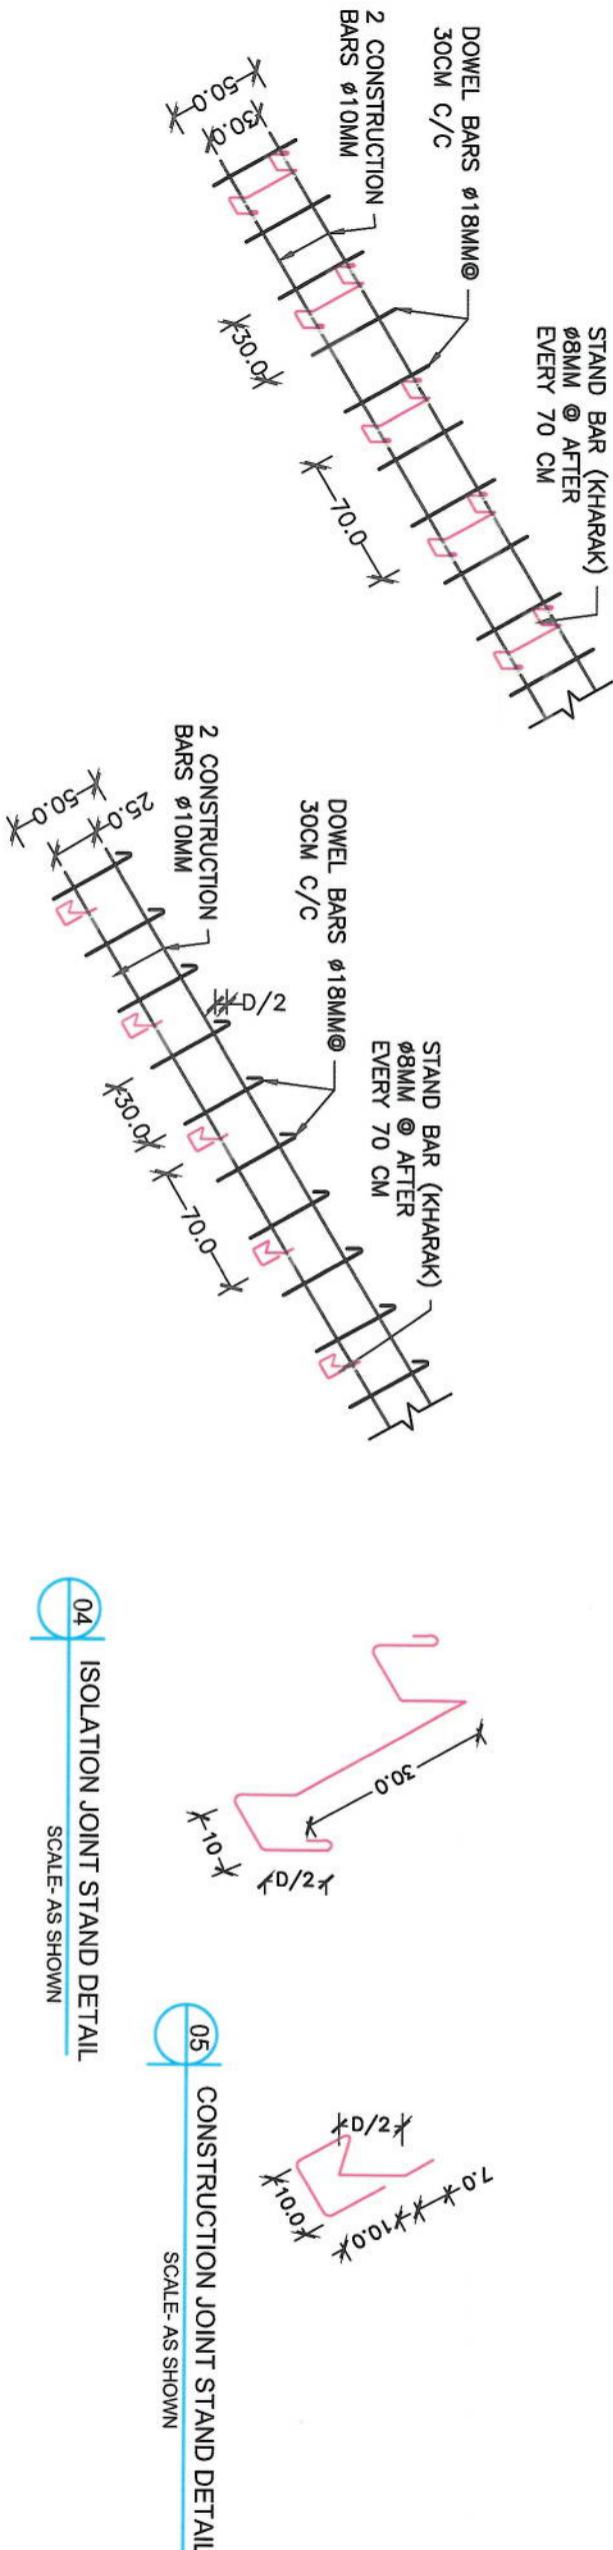

NOTE:  
1) FOR MORE DETAILS PLEASE SEE PCC PAVEMENT JOINTS SECTION DETAILS.  
2) TRANSVERSE JOINTS LENGTH MUST BE ACCORDING TO PAVEMENT CROSS WIDTH.  
3) REMOVE WOODEN PANEL, ONE SIDE CONSTRUCTION BAR AND STAND (KHARAK)  
FROM CONSTRUCTION JOINT.  
4) ALL UNITS ARE IN CM.

NOTE:					
1. All dimensions are in meters unless otherwise indicated					
Drawn:	Mehdiyu Rahman	Signature:			
Designed:	Mohammad Eisa Sial	Signature:			
Checked:	Heshmatullah Shabani	Signature:			
Reviewed:		Signature:			
Drawing Title:	JOINT DETAIL				
Project Name:	Cot-e-Sangi to Delmazang road project				
Date:	06/06/2023	Scale:			
Status:	FINAL DESIGN				
Project Code:					
SHEET NO.					
Revision No.					
01					

NOTE:  
1. All dimensions are in meters unless  
otherwise indicated.

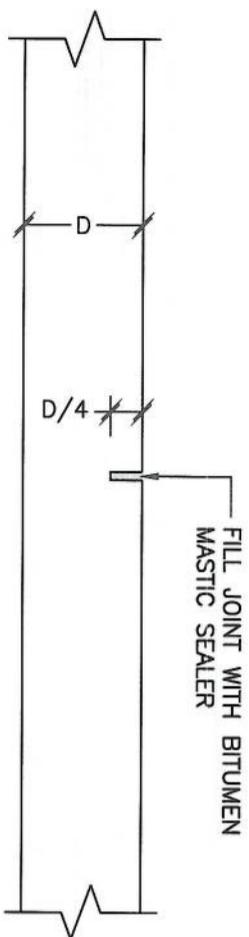


### 01 TRANSVERSE CONTRACTION JOINT DETAIL

SCALE- N.T.S

NOTE-1:

- 1) FORM JOINTS BY SAW CUTTING
- 2) SPACING OF CONTRACTION JOINTS @ AFTER EVERY 3 METER
- 3) FILL JOINTS WITH BITUMEN MASTIC SEALER TO PREVENT WATER PENETRATION IN TO PAVEMENTS
- 4) JOINT WIDTH = 0.5–1.0 CM

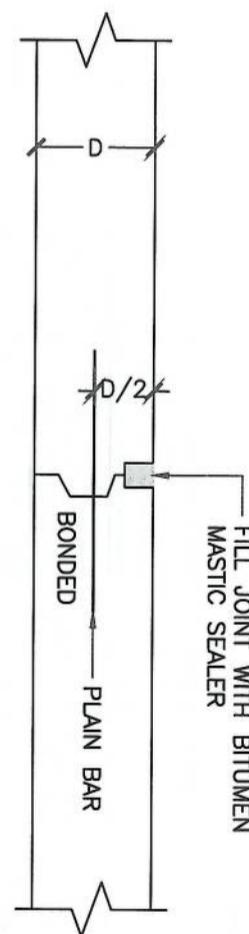


### 02 TRANSVERSE EXPANSION CONSTRUCTION JOINT DETAIL

SCALE- N.T.S

NOTE-2:

- 1) FORM JOINT WITH WOODEN PANEL, AND REMOVED IT AFTER JOINT FORMED.
- 2) USE DOWEL BARS  $\phi 18\text{MM}$ , @30CM C/C & 50 CM LONG
- 3) PROVIDE CONSTRUCTION JOINT @ THE END OF EVERY DAILY WORK AND WHEN THE WORK STOP FOR ONE HOUR OR MORE BECAUSE' OF SOME.
- 4) FILL JOINTS WITH BITUMEN MASTIC SEALER TO PREVENT WATER PENETRATION IN TO PAVEMENTS.
- 5) JOINT WIDTH = 3MM–6MM

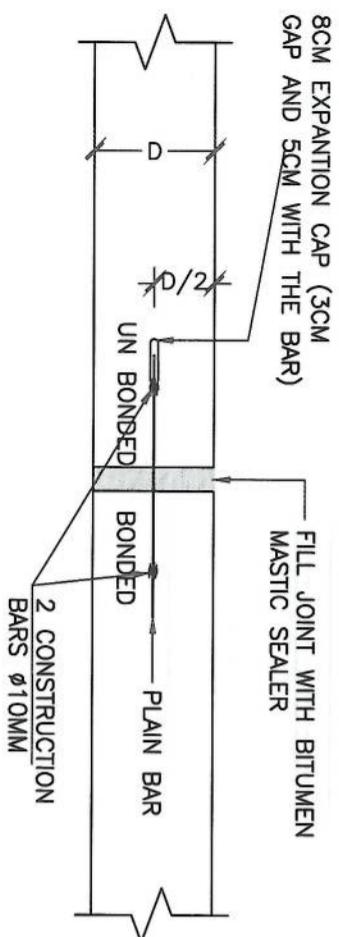

### 03 TRANSVERSE EXPANSION ISOLATION JOINT DETAIL

SCALE- N.T.S

NOTE-3:

- 1) FORM JOINT WITH POLYSTYRENE PANEL, AND REMOVED IT AFTER JOINT FORMED.
- 2) USE DOWEL BARS  $\phi 18\text{MM}$ , @30CM C/C & 50 CM LONG
- 3) SPACING MUST BE ACCORDING TO RELATED JOINTS PLAN VIEW.
- 4) FILL JOINTS WITH BITUMEN MASTIC SEALER TO PREVENT WATER PENETRATION IN TO PAVEMENTS.
- 5) JOINT WIDTH = 2.0CM–2.5CM
- 6) FROM THE MIDDLE POINT OF DOWEL BAR ONE SIDE SHOULD BE BONDED WITH PCC, BUT THE OTHER ONE SHOULD BE COATED WITH GREASE & WRAPPED WITH PLASTIC TO MAKE UN BONDED WITH PCC,

Rev.	Date	Revision Details	Drawn	Chkd	Apcd

ISLAMIC EMIRATE OF  
AFGHANISTAN

Designed By:



Project Name:  
Cave-Sangi to Delmazang road project

Drawing Title:

JOINT DETAIL

Drawn:	Mohajir Rahman	Signature:
Designed:	Mohammad Ehsan Sharif	Signature:
Checked:	Habibullah Shahzai	Signature:
Rechecked:		Signature:
Date:	06/06/2023	Seal:

FINAL  
DESIGN

Project Code


SHEET NO.

Revision No.


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NOTE:

1. All dimensions are in mm unless otherwise indicated.

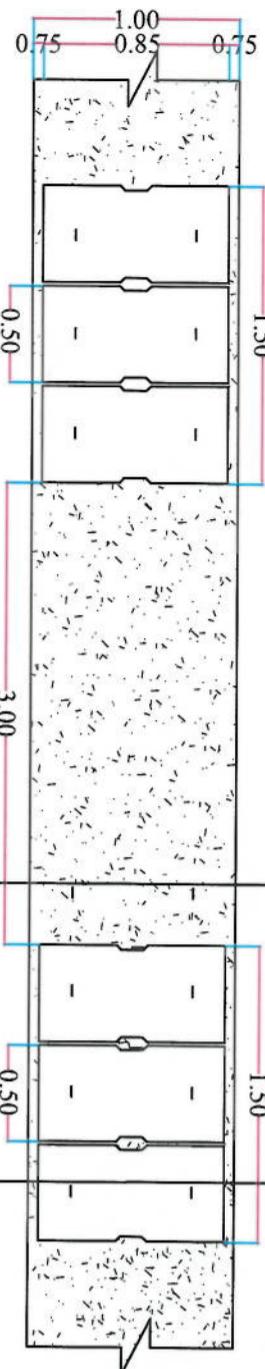


PLAN OF SIDE DITCH (1.0X1.0M)

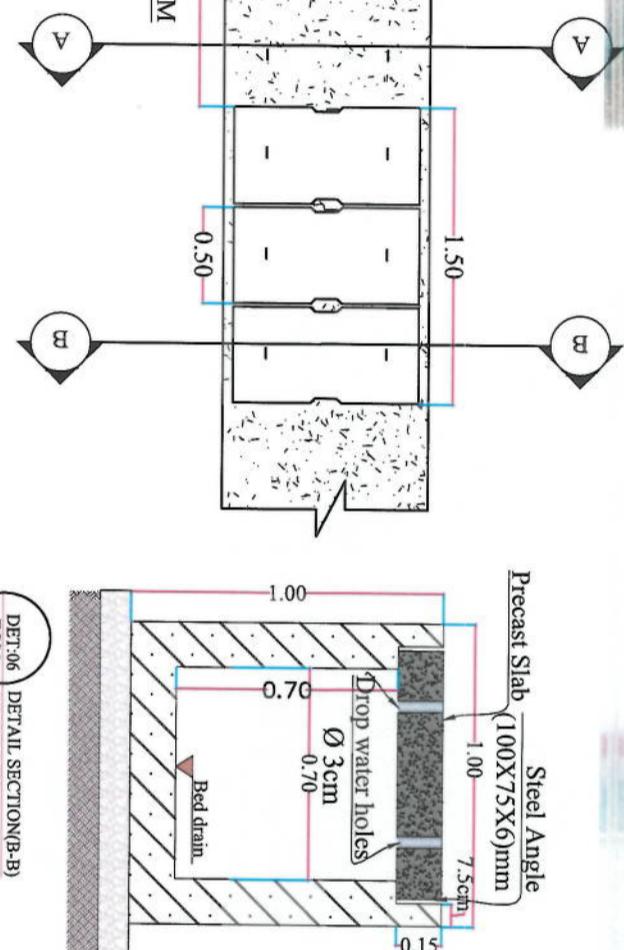


DET:06 DETAIL SECTION(A-A)  
TCS0 SCALE: NTS

RCC 15 CM (25MPA)  
10CM GRANULAR AGGREGATE SUB BASE  
MATERIAL WITH 98% COMPACTION  
(RE-COMPACTED SOIL  
(COMPACTION-97%)

DET:06 DETAIL SECTION(A-A)  
TCS0 SCALE: NTS

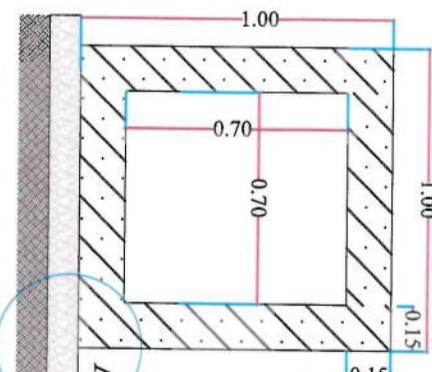

DET:06 DETAIL SECTION(A-A)  
TCS0 SCALE: NTS

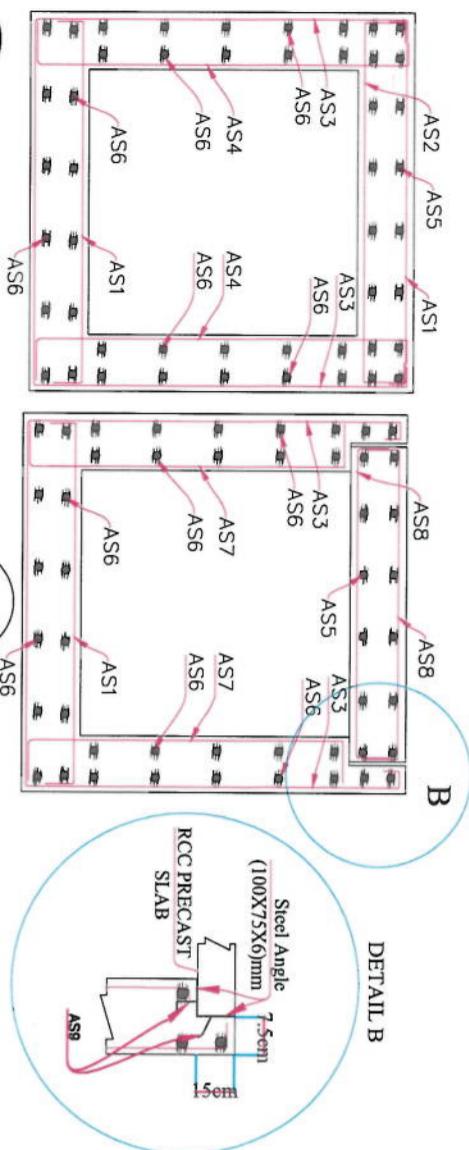

DET:06 DETAIL OF REINFORCING SECTION(A-A)  
TCS0 SCALE: NTS

DITCH (100X100) CM REINFORCEMENT SCHEDULE				
Bar No	Bar Shape	Ø (mm)	Spacing (mm)	Remark
As1		12	160	
As2		12	160	
As3		12	160	
As4		12	160	
As5		10	150	
As6		10	150	
As7		12	150	
As8		12	150	
As9		8	200	

ISLAMIC EMARATE OF  
AFGHANISTAN

Designed By:  
KABUL MUNICIPALITY  
DESIGN TEAM

Project Name:  
KOT-E-SANGI TO DEHMIZANG  
ROAD PROJECT

Drawing Title:  
SIDE DRAIN06 TYPICAL CROSS  
SECTION

Drawn By:  
Nematullah Naseri  
Signature

Designed By:  
Abdul Shokouh Mansour  
Signature


Checked By:  
Habibullah Sulzi  
Signature

Reviewed By:  
Signature

Date: 02/06/2023 Scale:  
FINAL DESIGN


Status:  
Project Code

Drawing Number:  
S-D-01 Revision:  
00



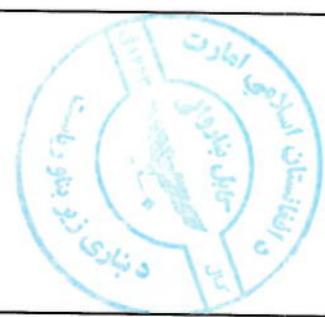


NOTE:



1. All dimensions are in meters unless otherwise indicated.

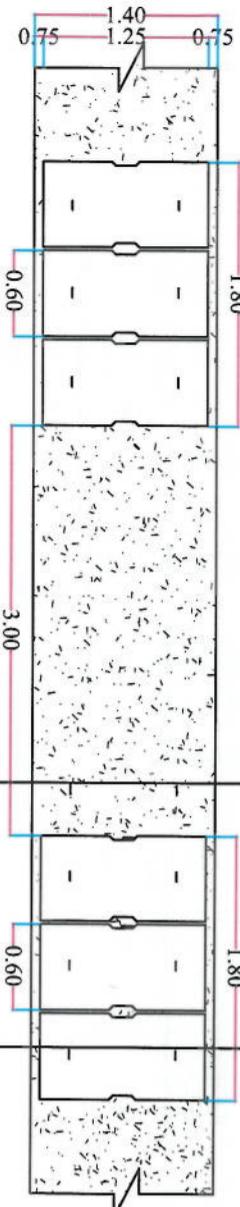


PLAN OF SIDE (1.40X1.40)M

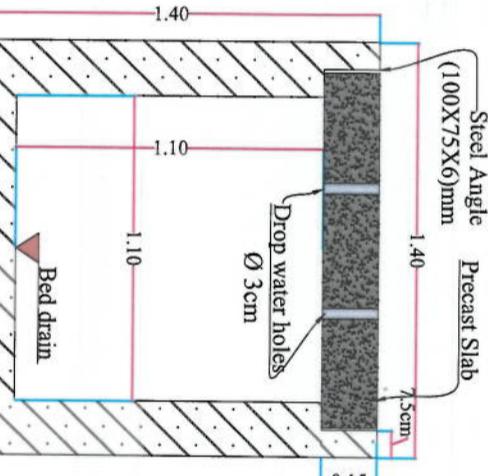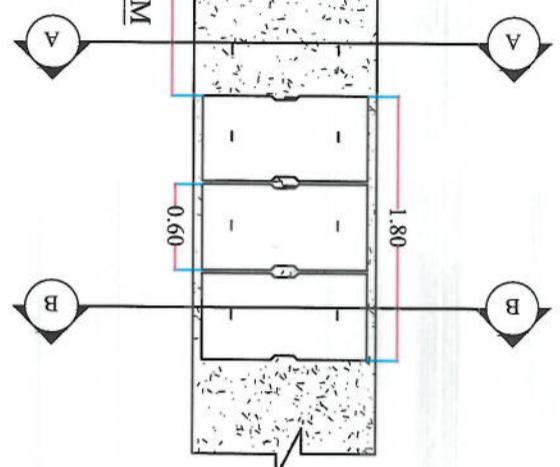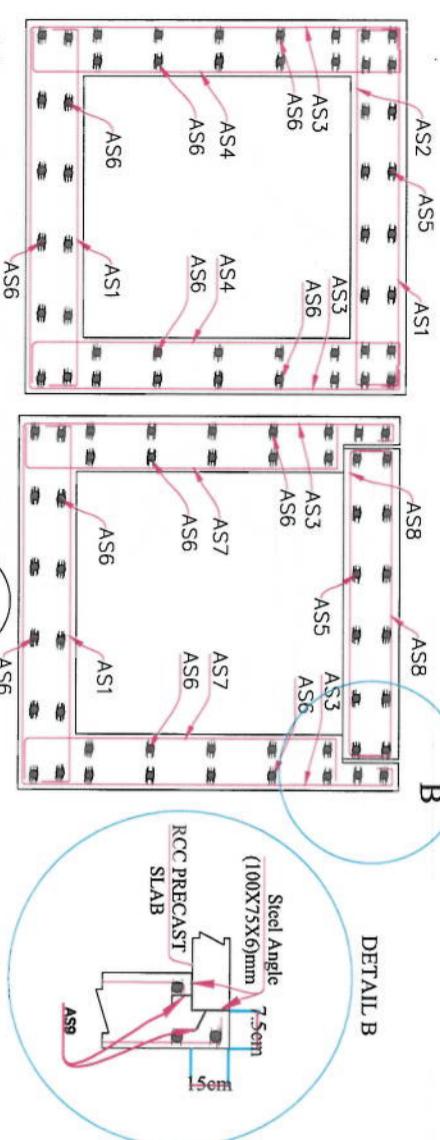DET:07 DETAIL SECTION(B-B)  
TCS0 SCALE: NTSDET:07 DETAIL SECTION(A-A)  
TCS0 SCALE: NTS

DETAIL B

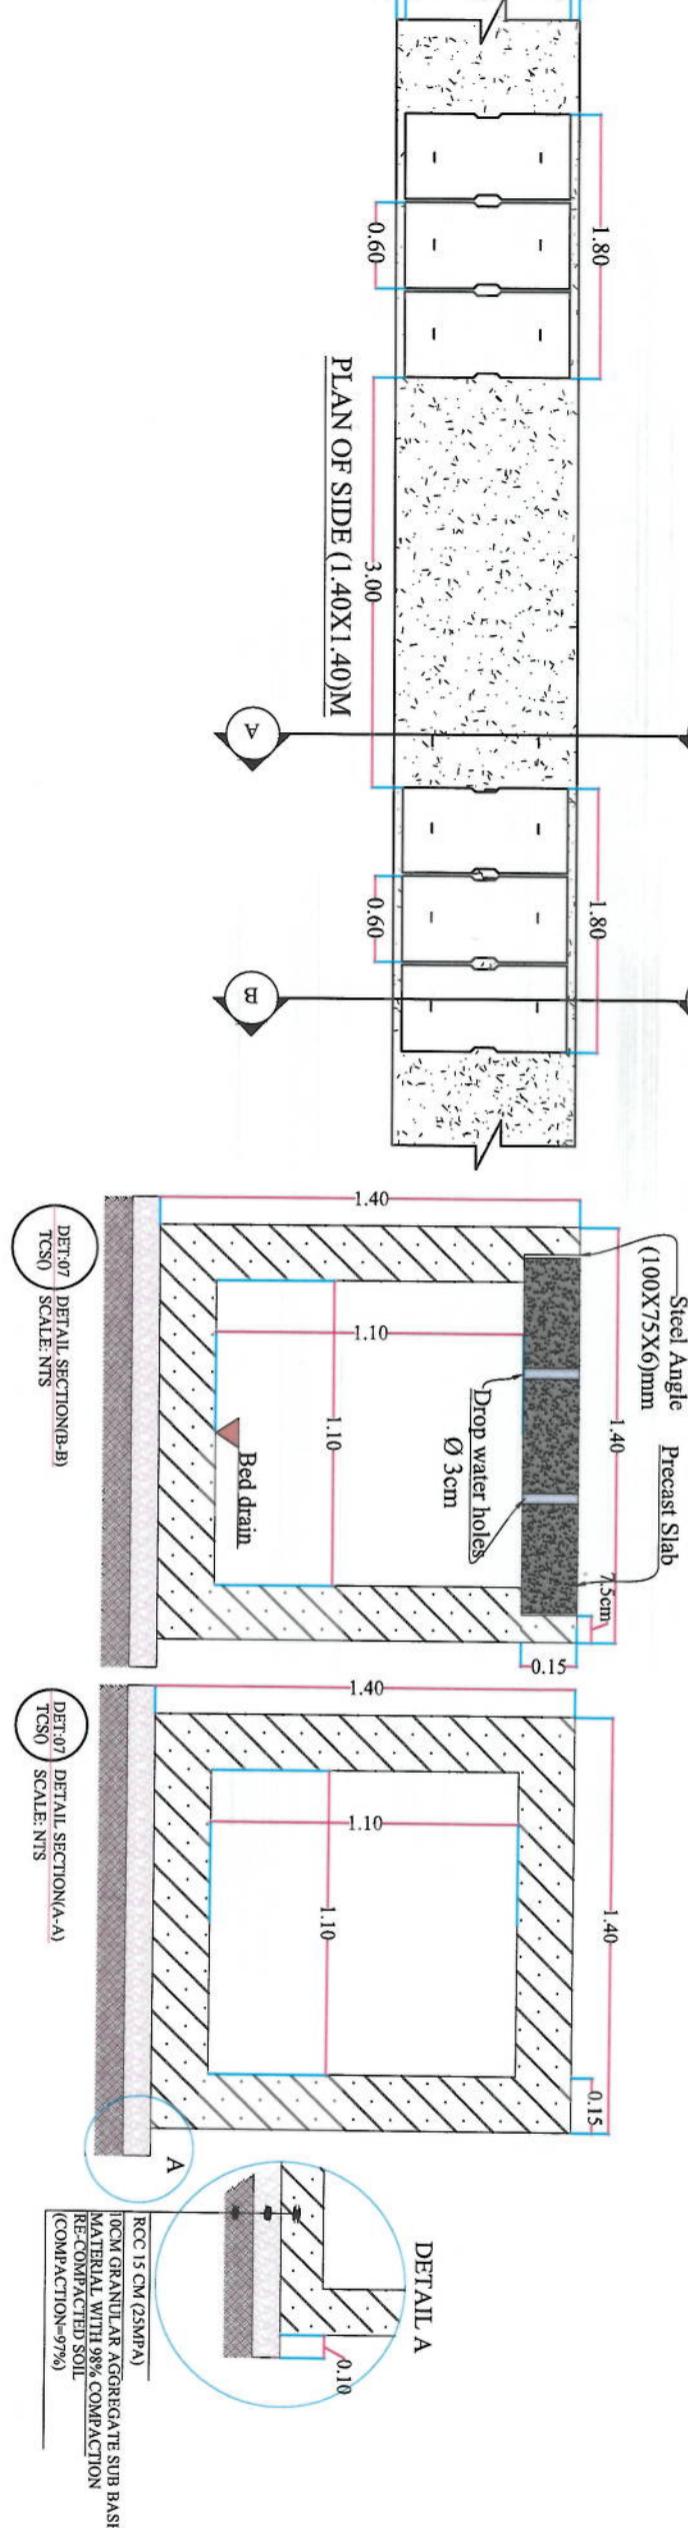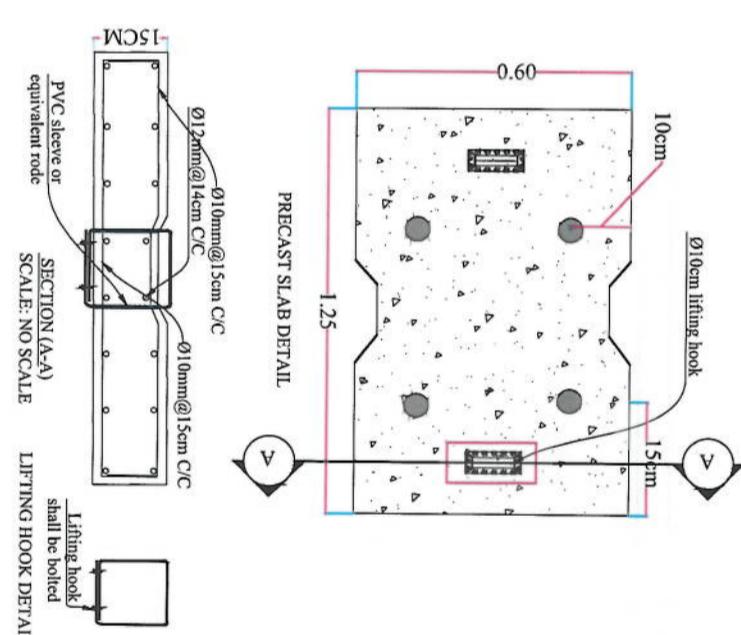


Drawn by	Signature
Nasoya Nasri	
Designed By	
Abul Shakoor Mansour	
Checked By	
Habibullah Shafizi	
Reviewed by	
Date: 02/06/2023	Signature:
Status: FINAL DESIGN	
Project Code:	
Drawing Number	
S.D-02	
Revision	
00	

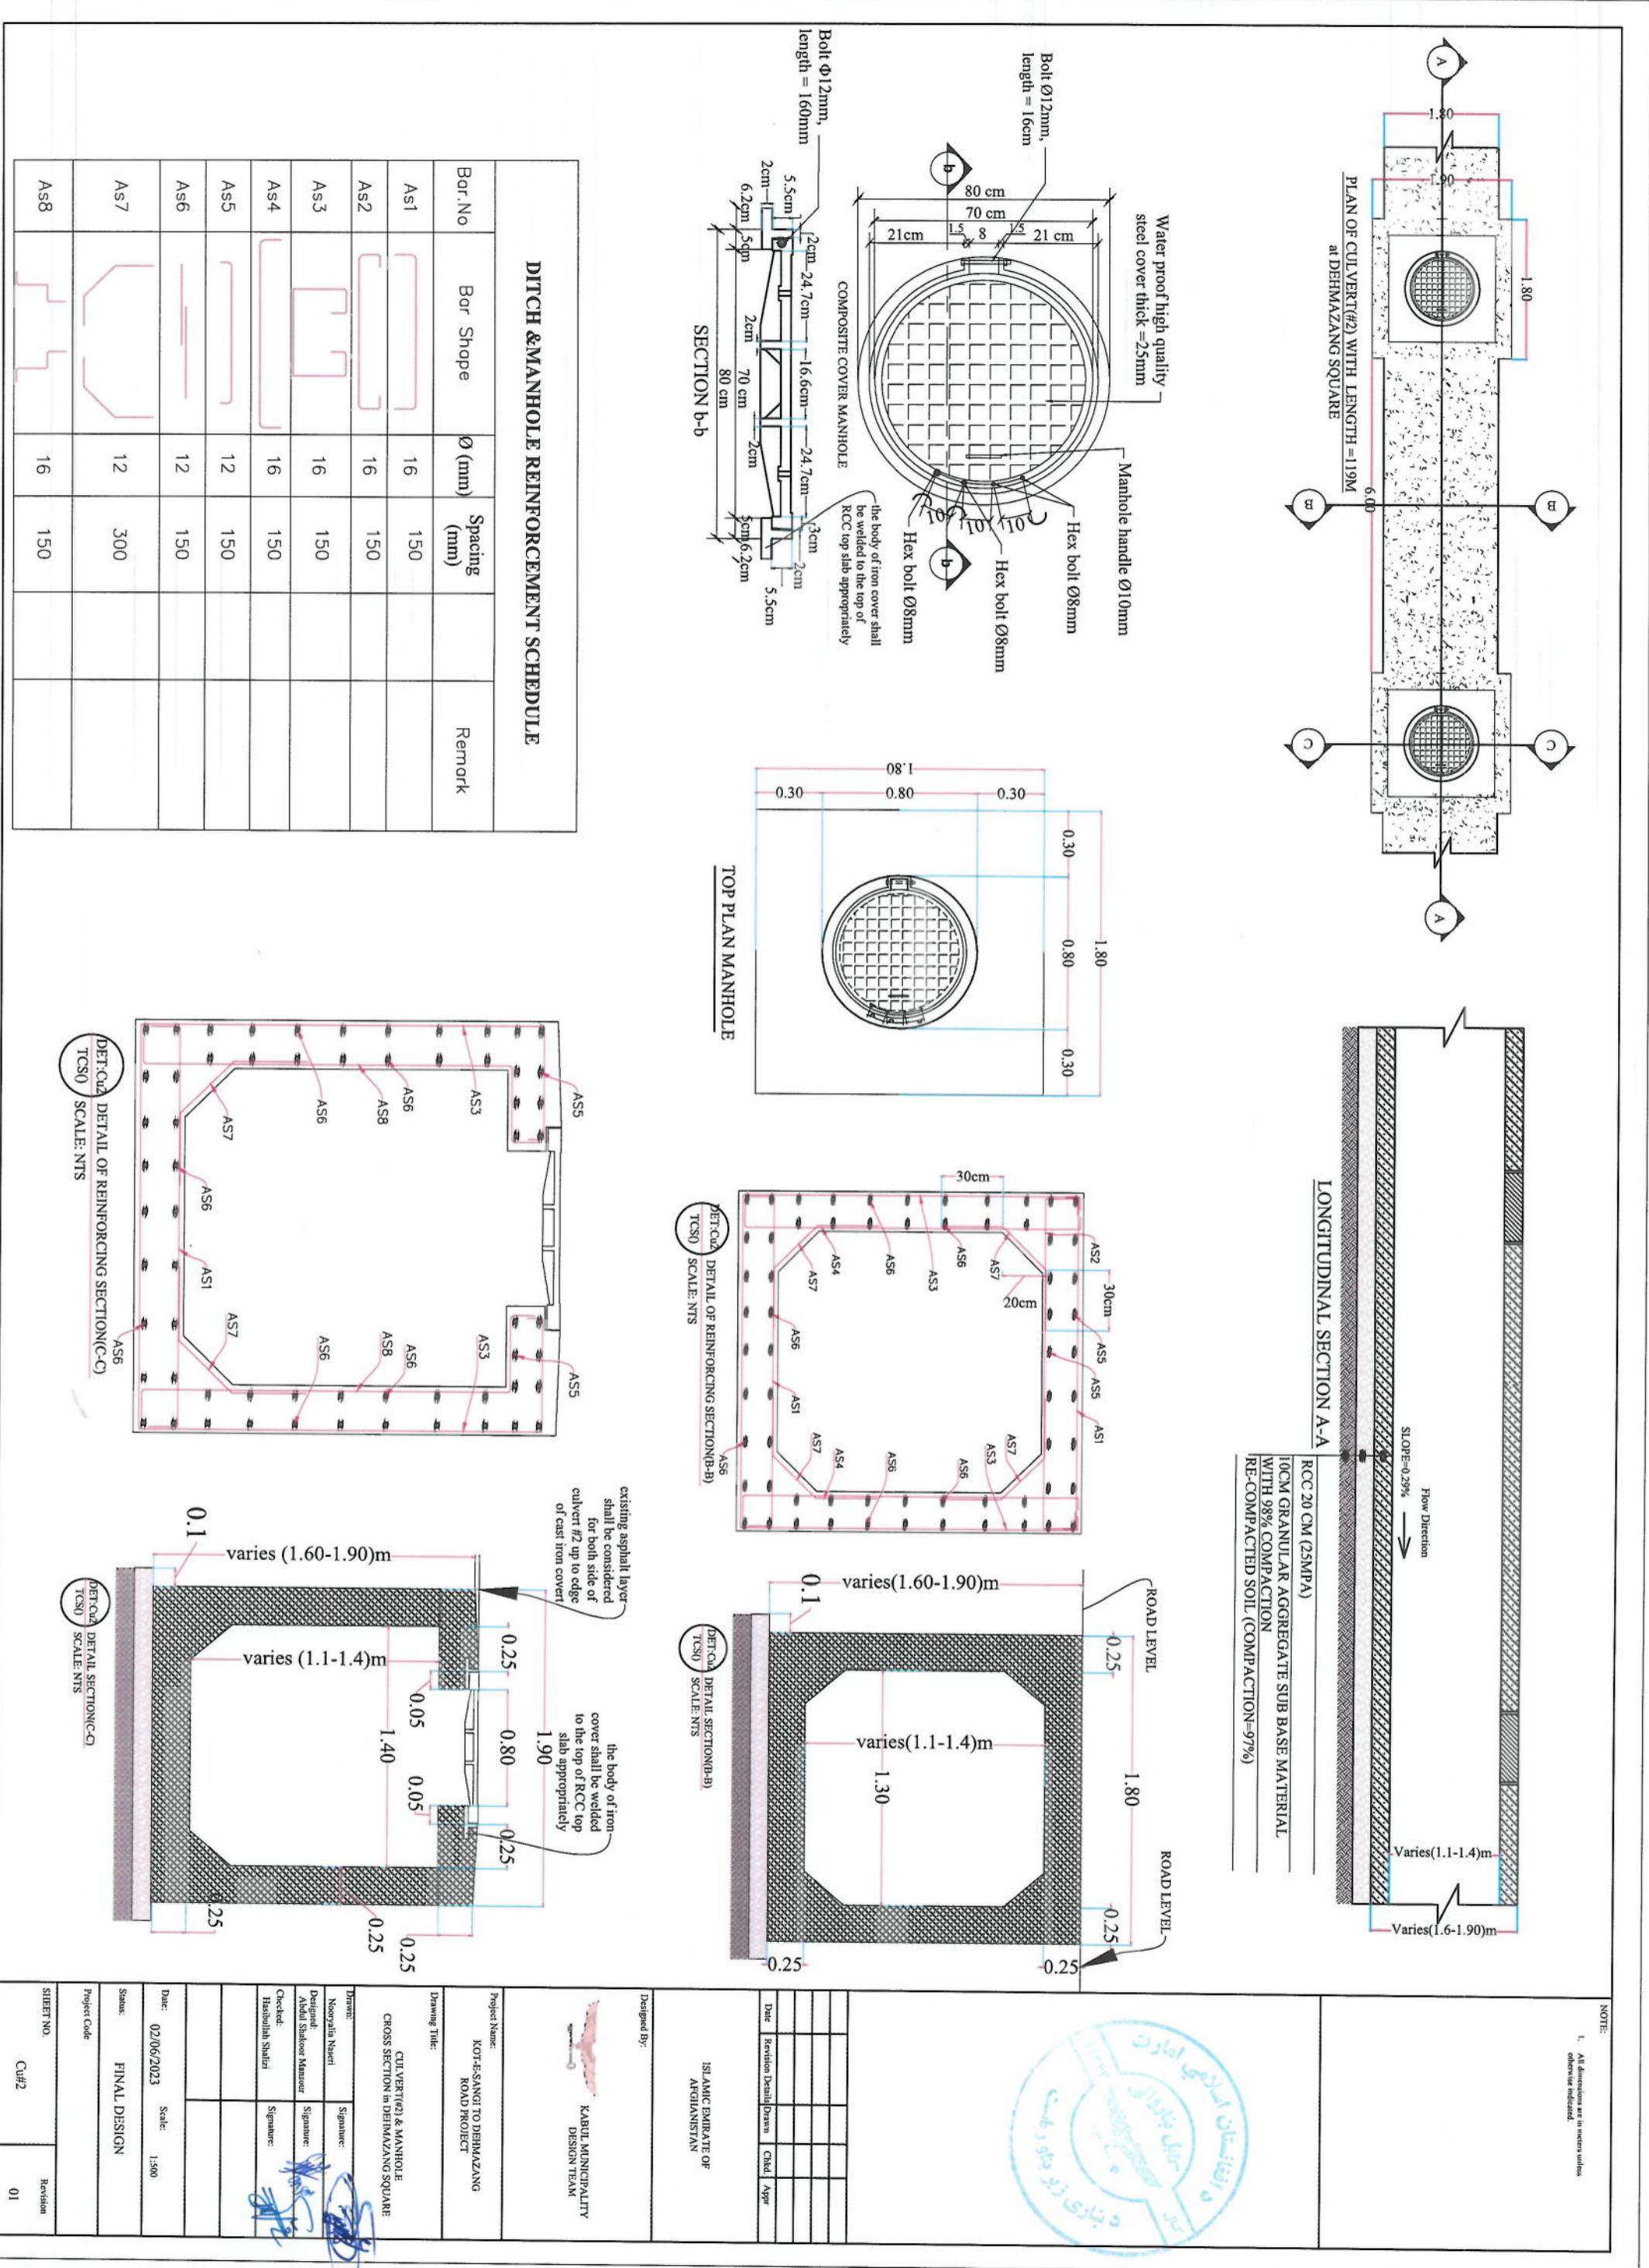

LINK ROAD DITCH TABLE

NUMBER OF LINK ROAD	LINK DITCH TYPE	LOCATION OF LINK DITCH
1	A	BOTH SIDE
2	B	BOTH SIDE
3	B	BOTH SIDE
4	B	ONE SIDE
5	C	BOTH SIDE
6	A	BOTH SIDE
7	D	BOTH SIDE
8	C	BOTH SIDE
9	A	ONE SIDE
10	A	ONE SIDE
11	D	ONE SIDE
12	D	ONE SIDE
13	D	BOTH SIDE


B

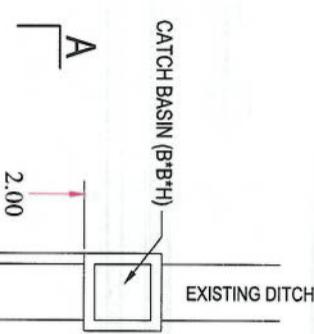

C



B

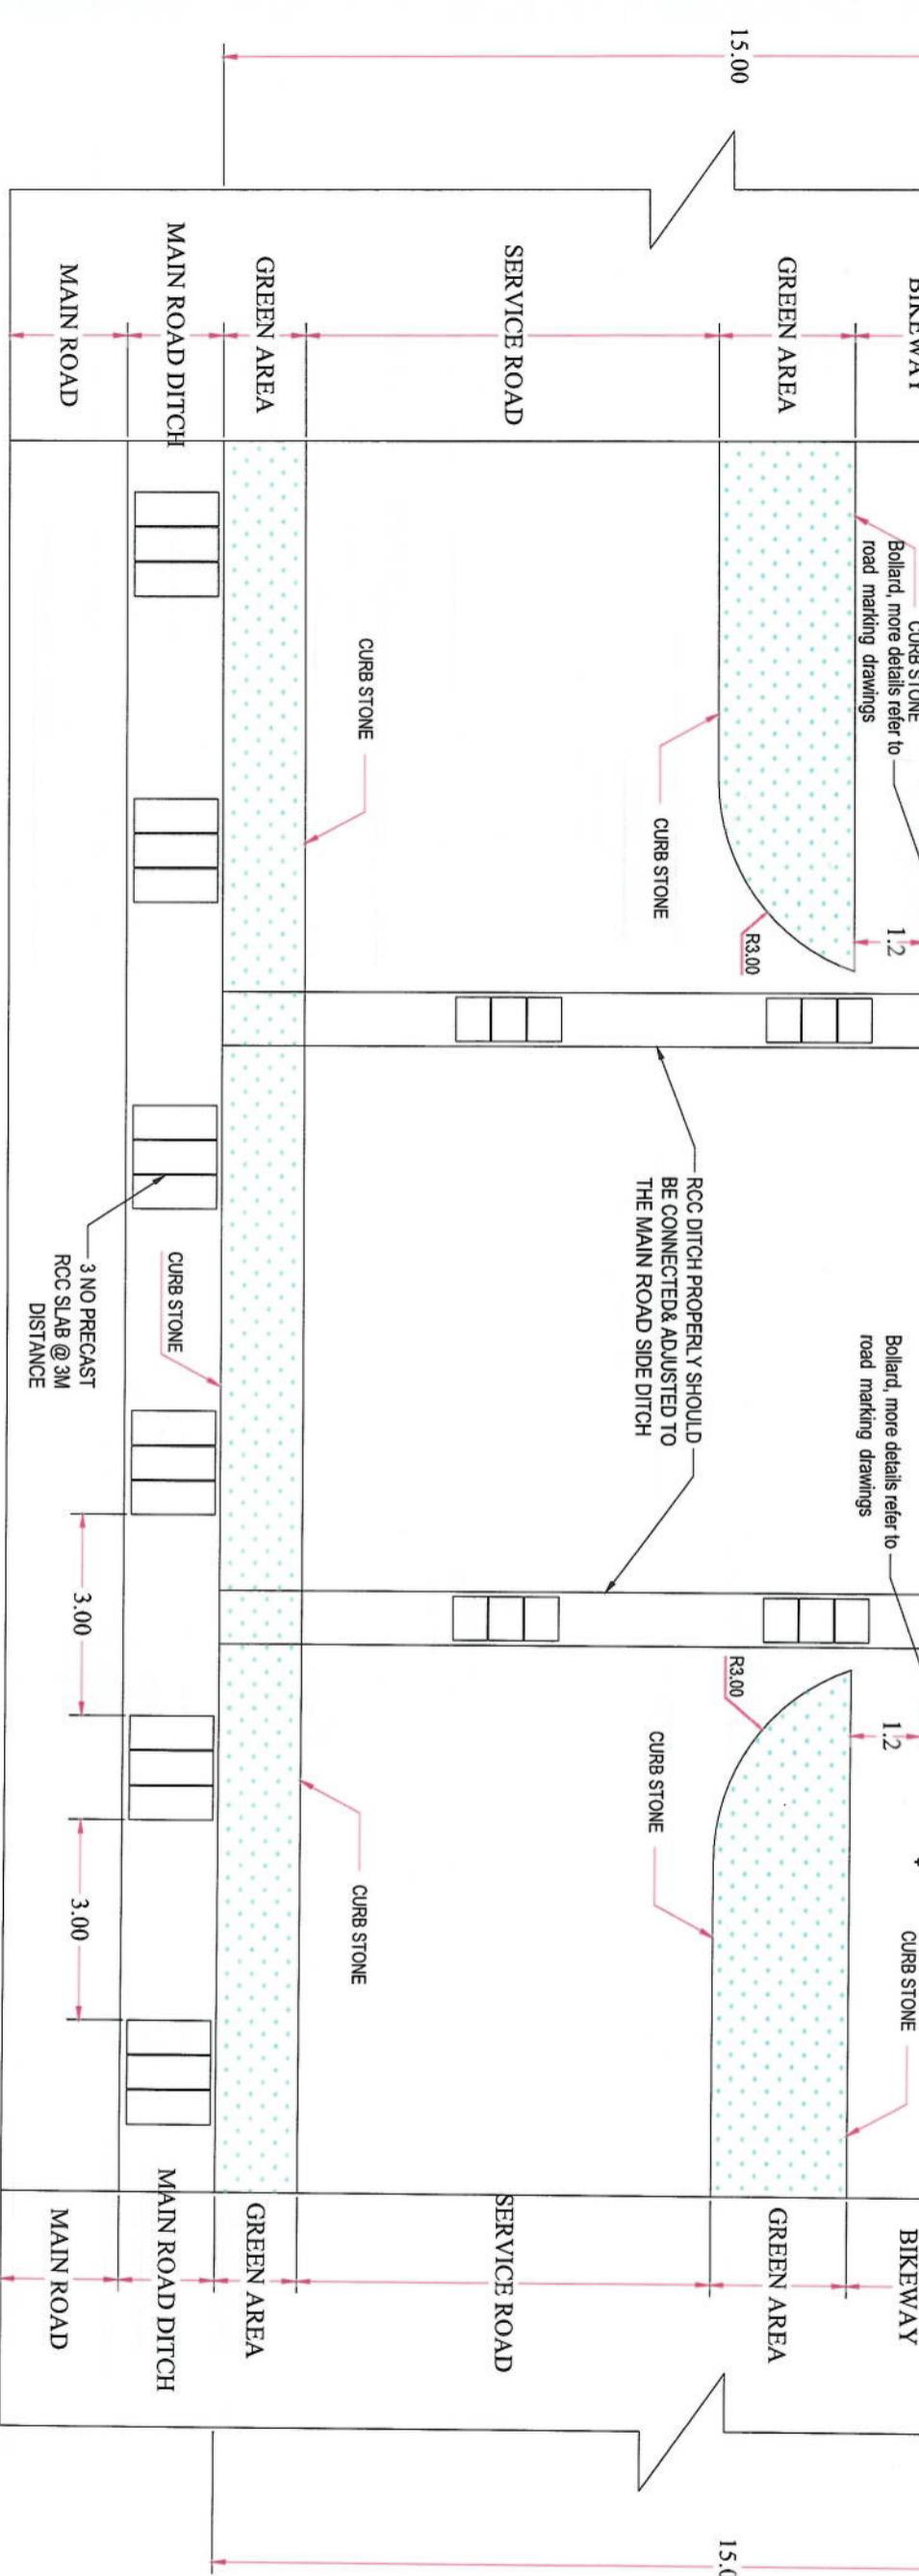NOTE:  
1. All dimensions are in m unless otherwise indicated.

ISLAMIC EMIRATE OF  
AFGHANISTAN  
KABUL MUNICIPALITY  
DESIGN TEAM

Project Name:  
KOT-E-SANGI TO DEMMAZANG  
ROAD PROJECT

Drawing Title:

LINK ROAD-Both Side

Drawn:

Signature:

Mehmaju Rahman

Designed:

Signature:

M.Fessa Sharif

Checked:

Signature:

Hasibullah Shaiqi

Drawing No.:

Signature:

ED DETAIL-01

Revision 01

Date:

02/06/2023

Status:

FINAL DESIGN

Project Code:


Sheet No.:

ED DETAIL-01


Revision 01

NOTE:

1. All dimensions are in m unless otherwise indicated

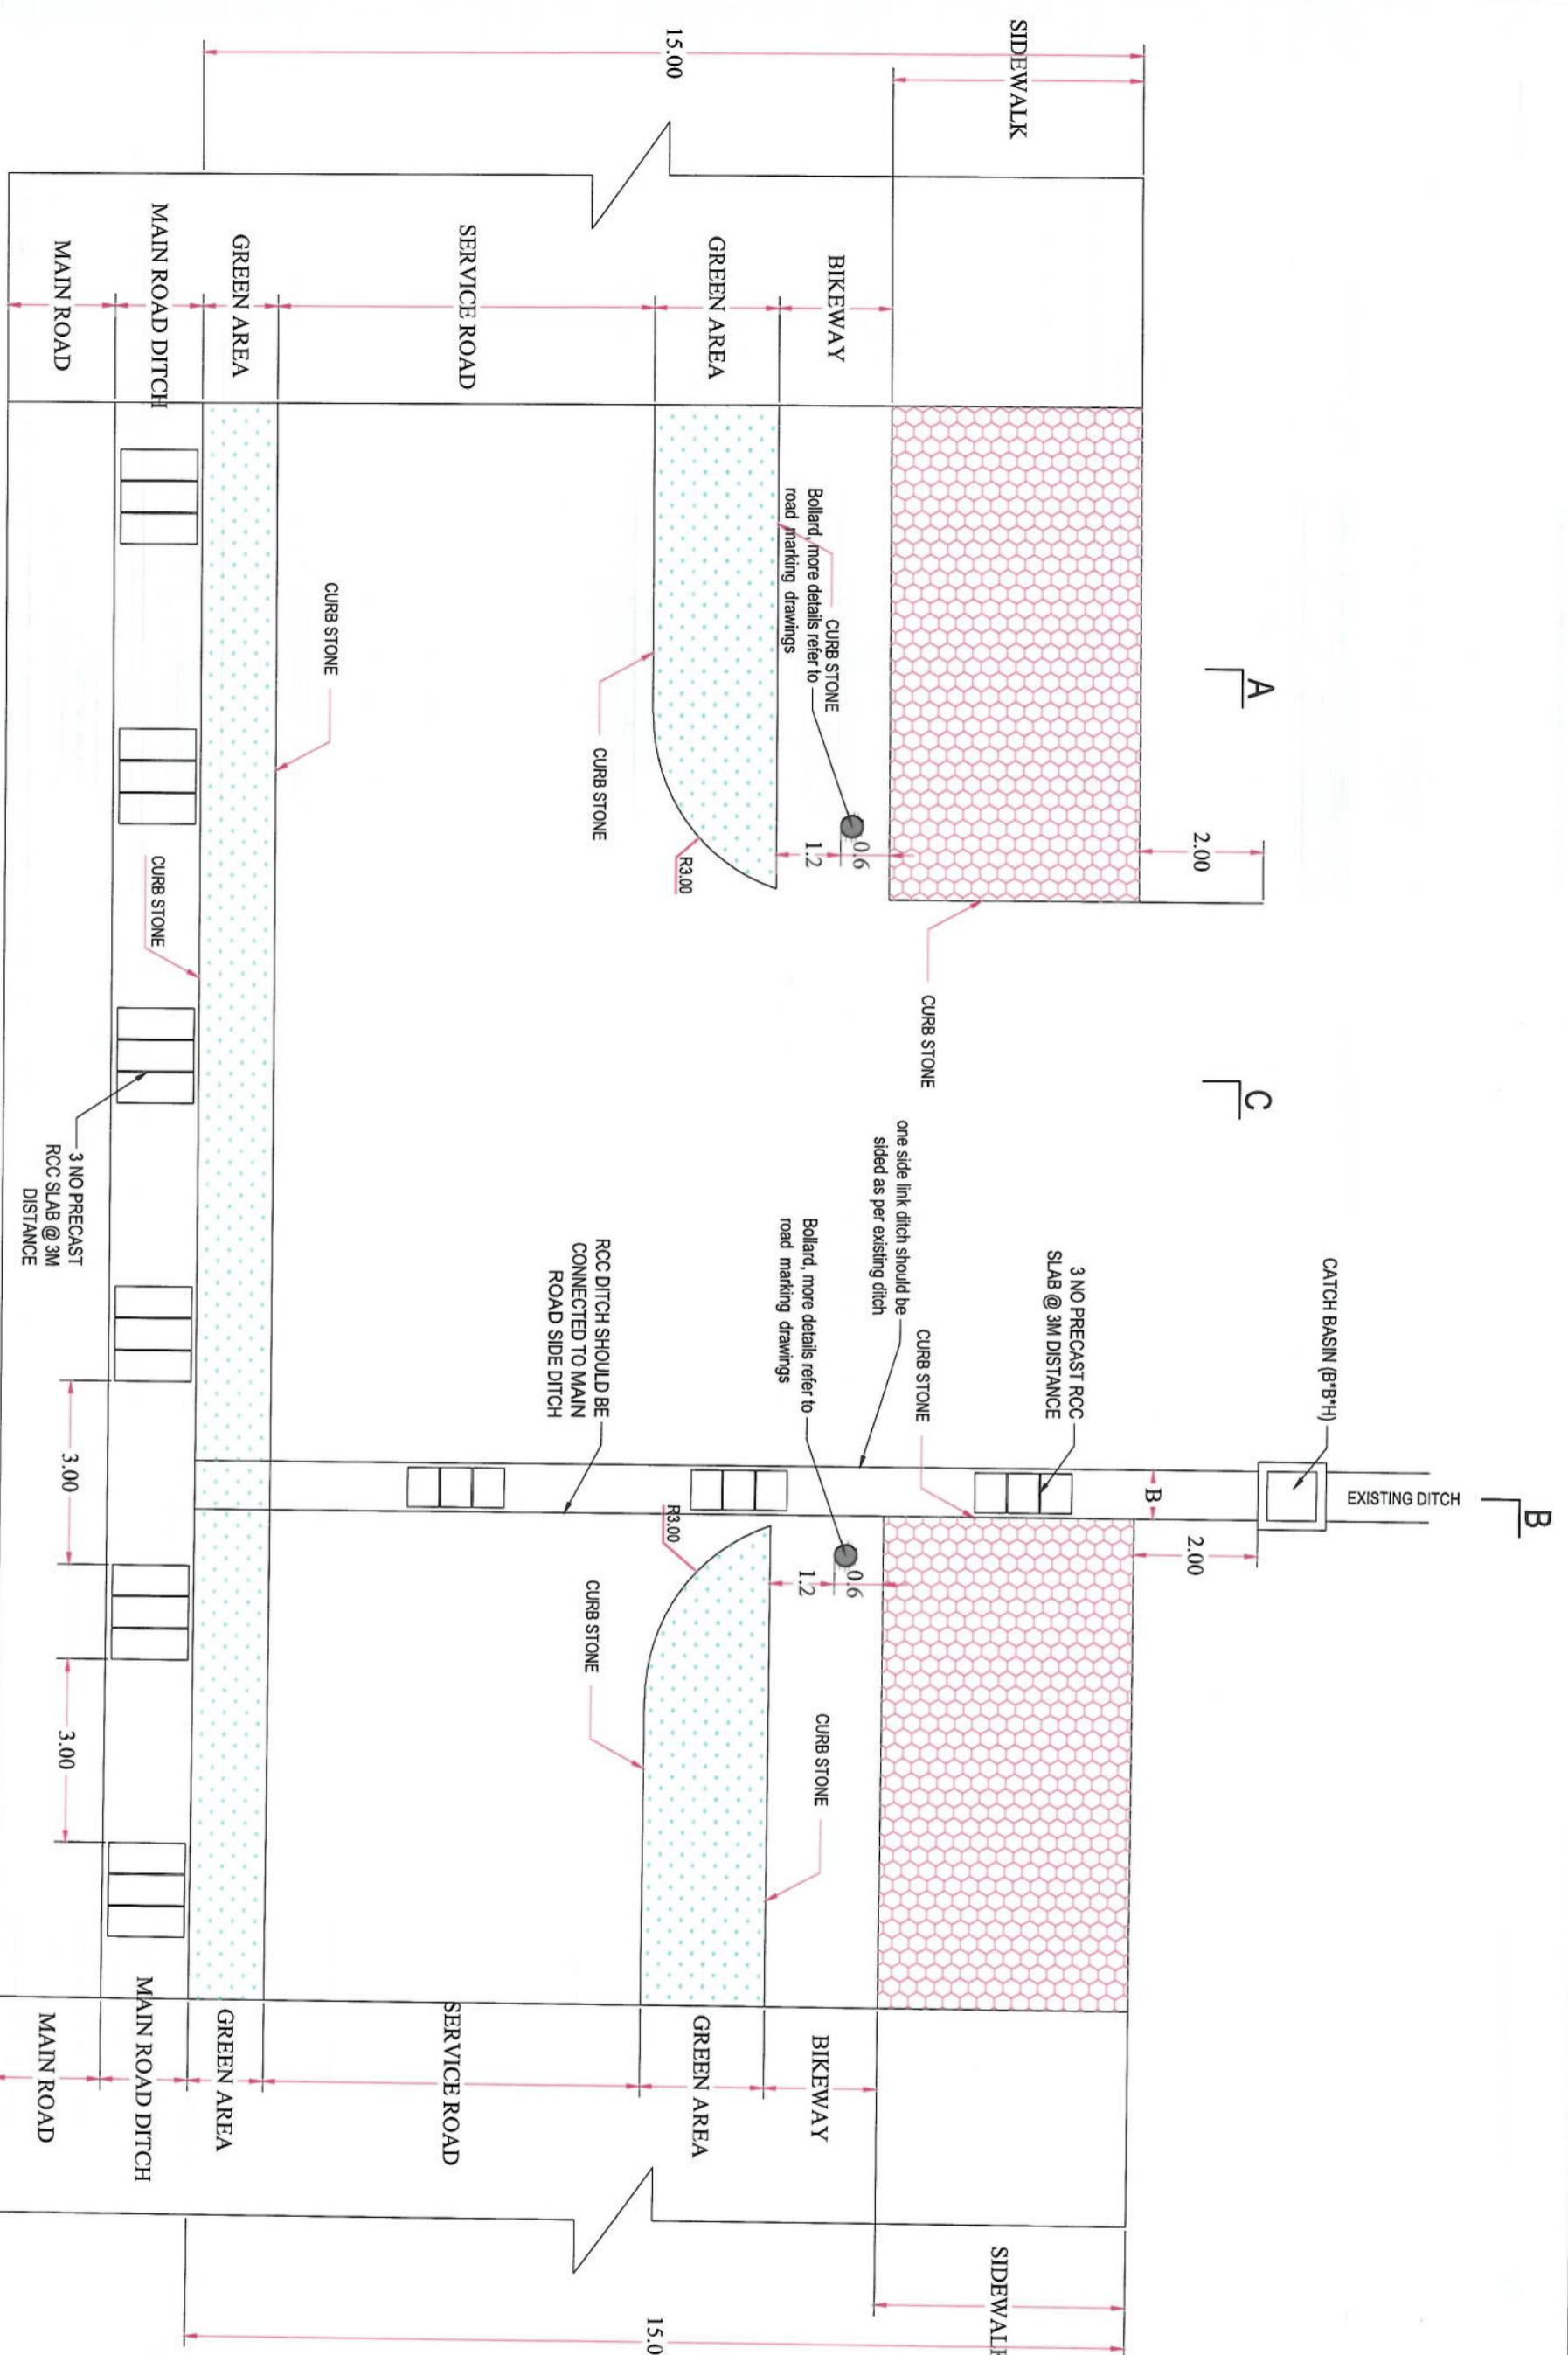


LINK ROAD-One side	
Drawn: Muhammad Rahman Signature:	Signature:
Designed: M. Esa Sial Checked: Hasbullah Shahzai Signature:	Signature:
Drawing Title: KOTE-SANGI TO DEHMAGZANG ROAD PROJECT	
Project Name: ISLAMIC EMIRATE OF AFGHANISTAN KABUL MUNICIPALITY DESIGN TEAM	
Drawing No.: 02/06/2023 Scale: 1:75 Status: FINAL DESIGN Project Code: ED DETAIL-02 Revision: 01	

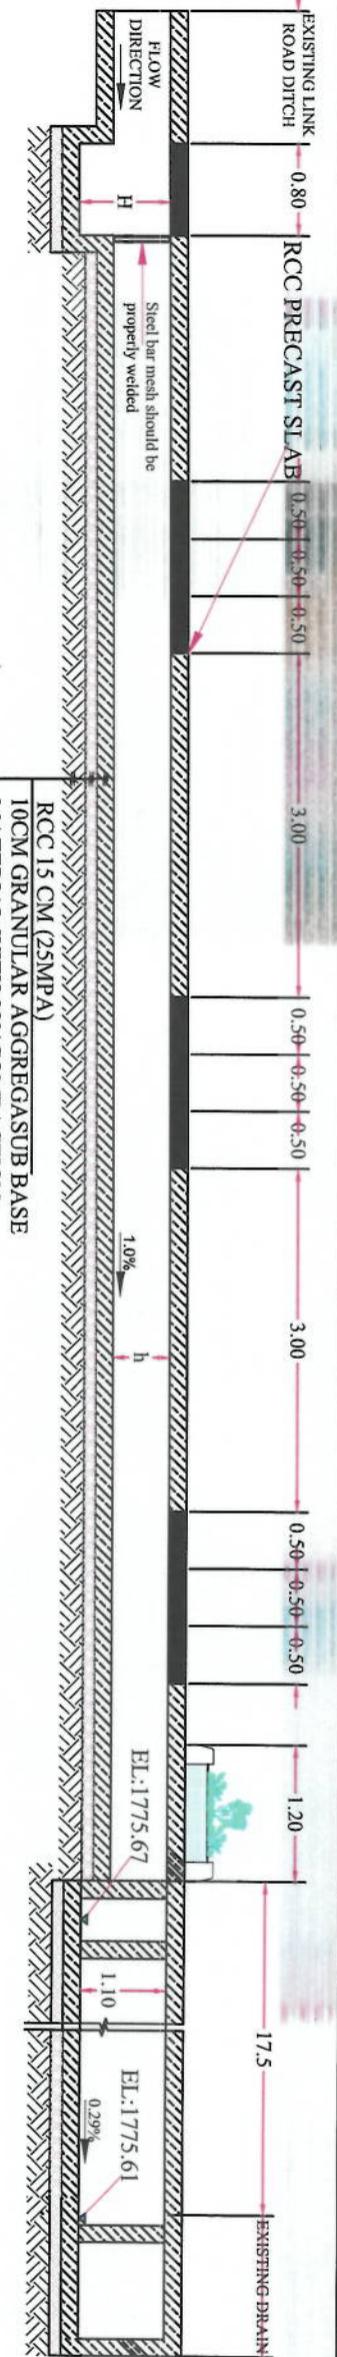

**RCC 15 CM (25MPA)**  
**10CM GRANULAR AGGREGATE BASE**  
**MATERIAL WITH 98% COMPACTION**  
**RE-COMPAKTED SOIL (COMPACTON=97%)**

### SECTION D-D FOR LINK ROADS

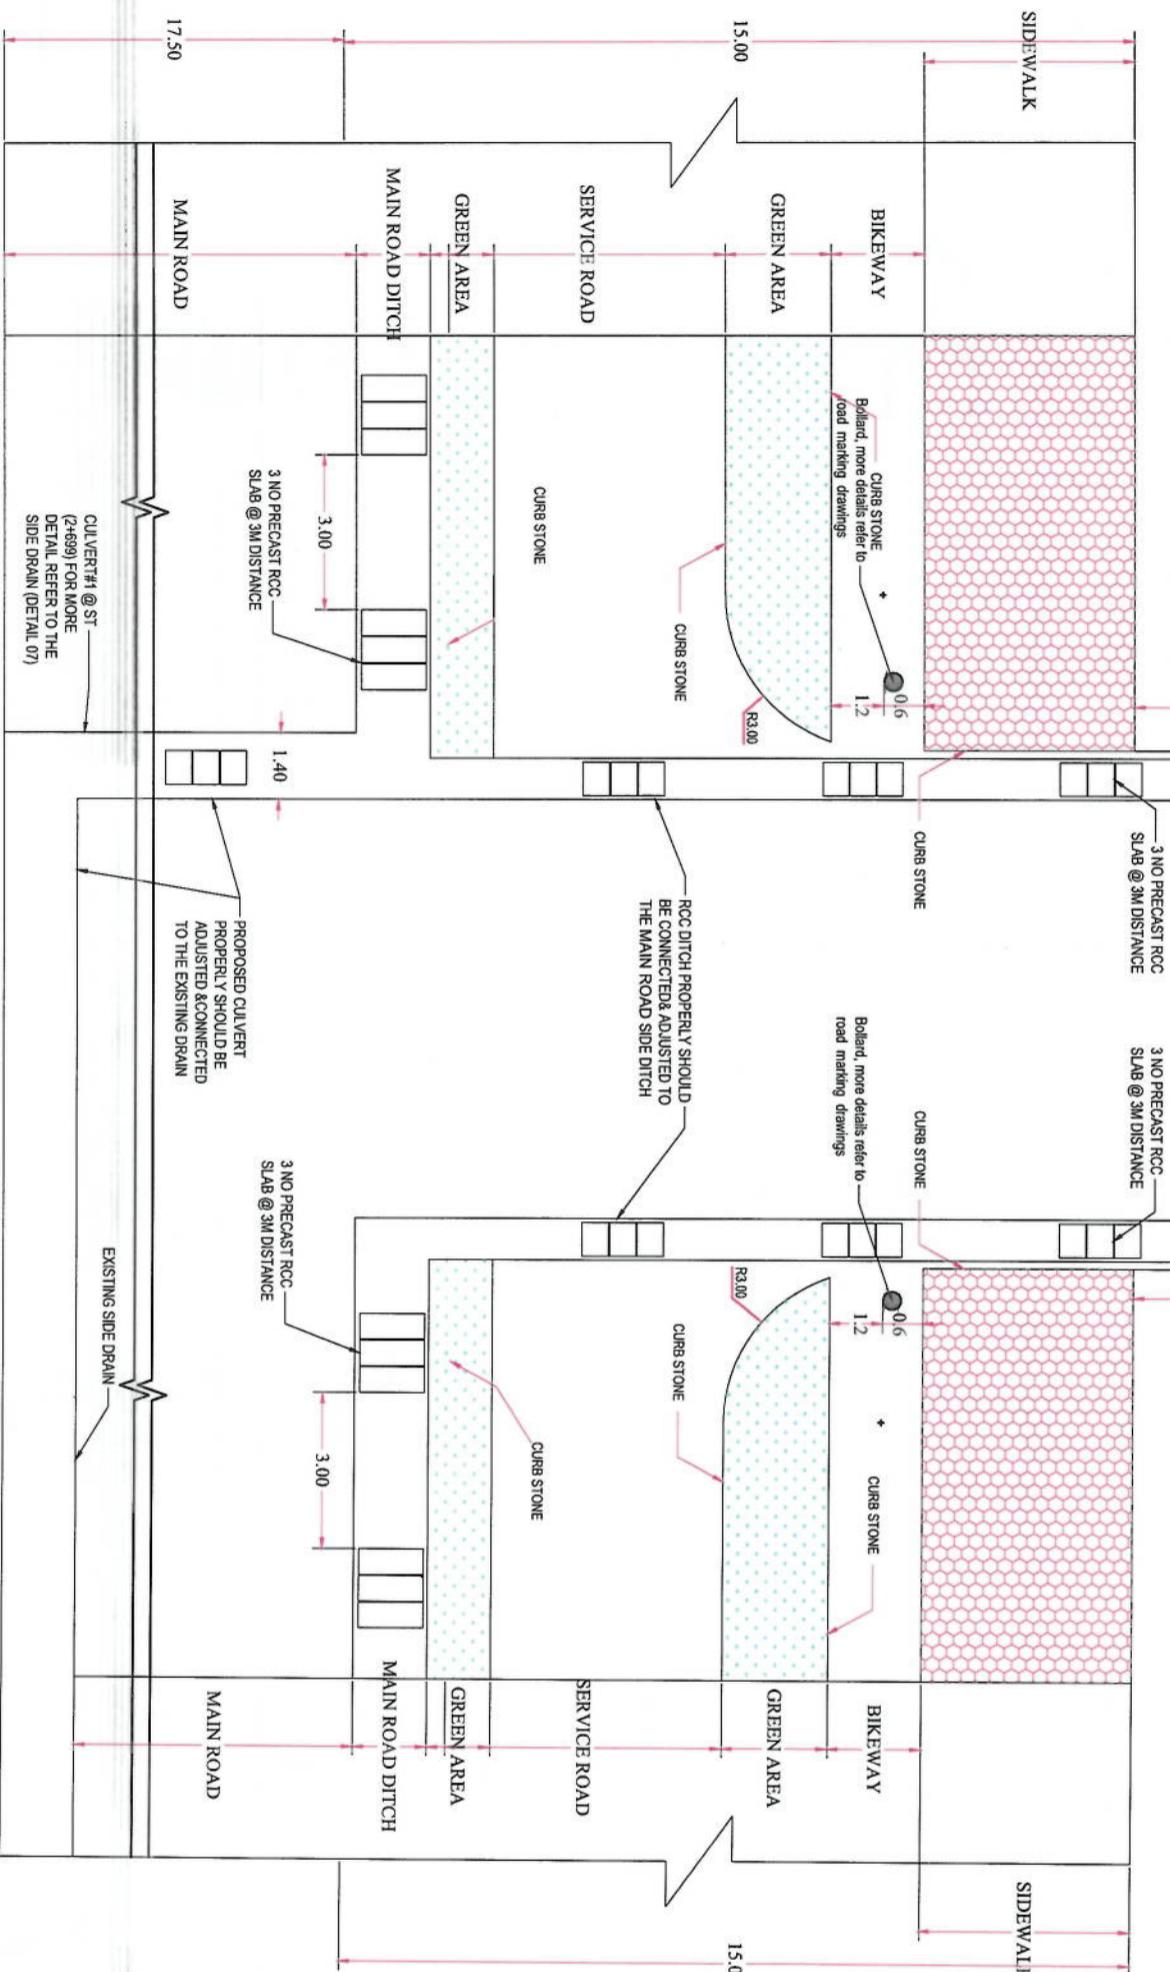

**PLAN OF LINK ROADS TYPE C**


NOTE:  
1. All dimensions are in meters unless otherwise indicated.




Project Name: KOT-E-SANGI TO DEHMAZANG  
Designed By: KABUL MUNICIPALITY DESIGN TEAM  
Drawing Title: LINK ROAD Both side WITH CULVERT #1  
Drawn: Mehabiu Ramman Signature: \_\_\_\_\_  
Designed: M. Ihsan Srat Signature: \_\_\_\_\_  
Checked: Hashbulan Shahzai Signature: \_\_\_\_\_  
Status: FINEL DESIGN  
Project Code: ED DETAIL-03 Revision: 01

Date: 02/06/2023 Scale: 1:500  
SHEET NO. ED DETAIL-03 Revision: 01

NOTE:  
1. All dimensions are in m unless  
otherwise indicated.

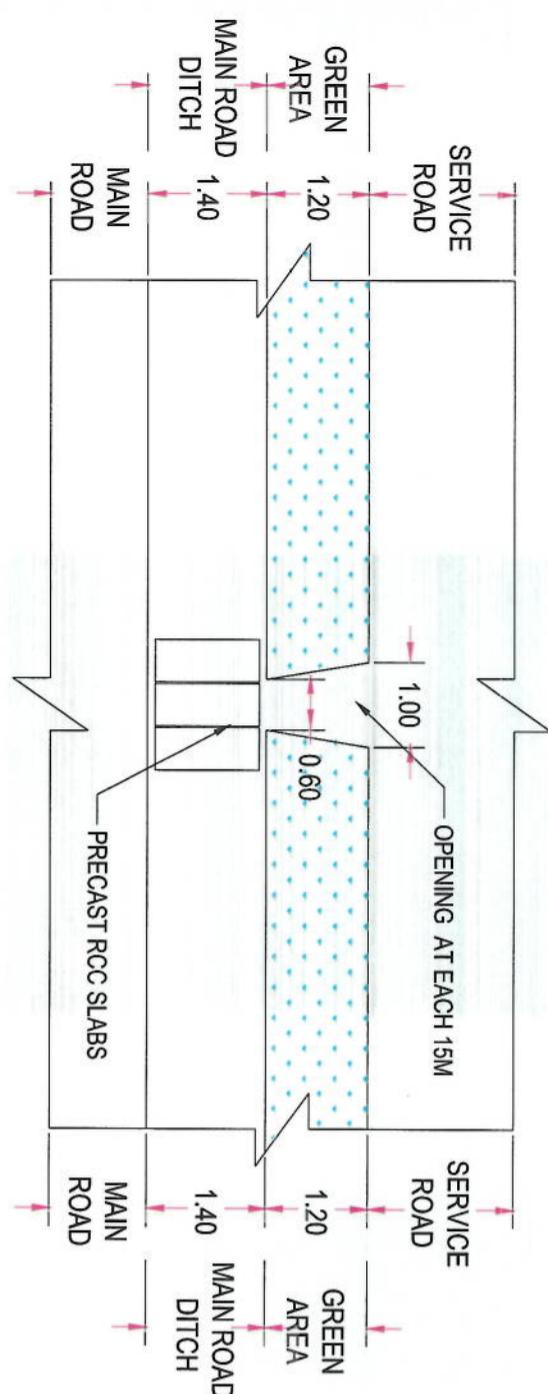

OPENING DETAIL IN MEDIUM  
SCALE: NTS

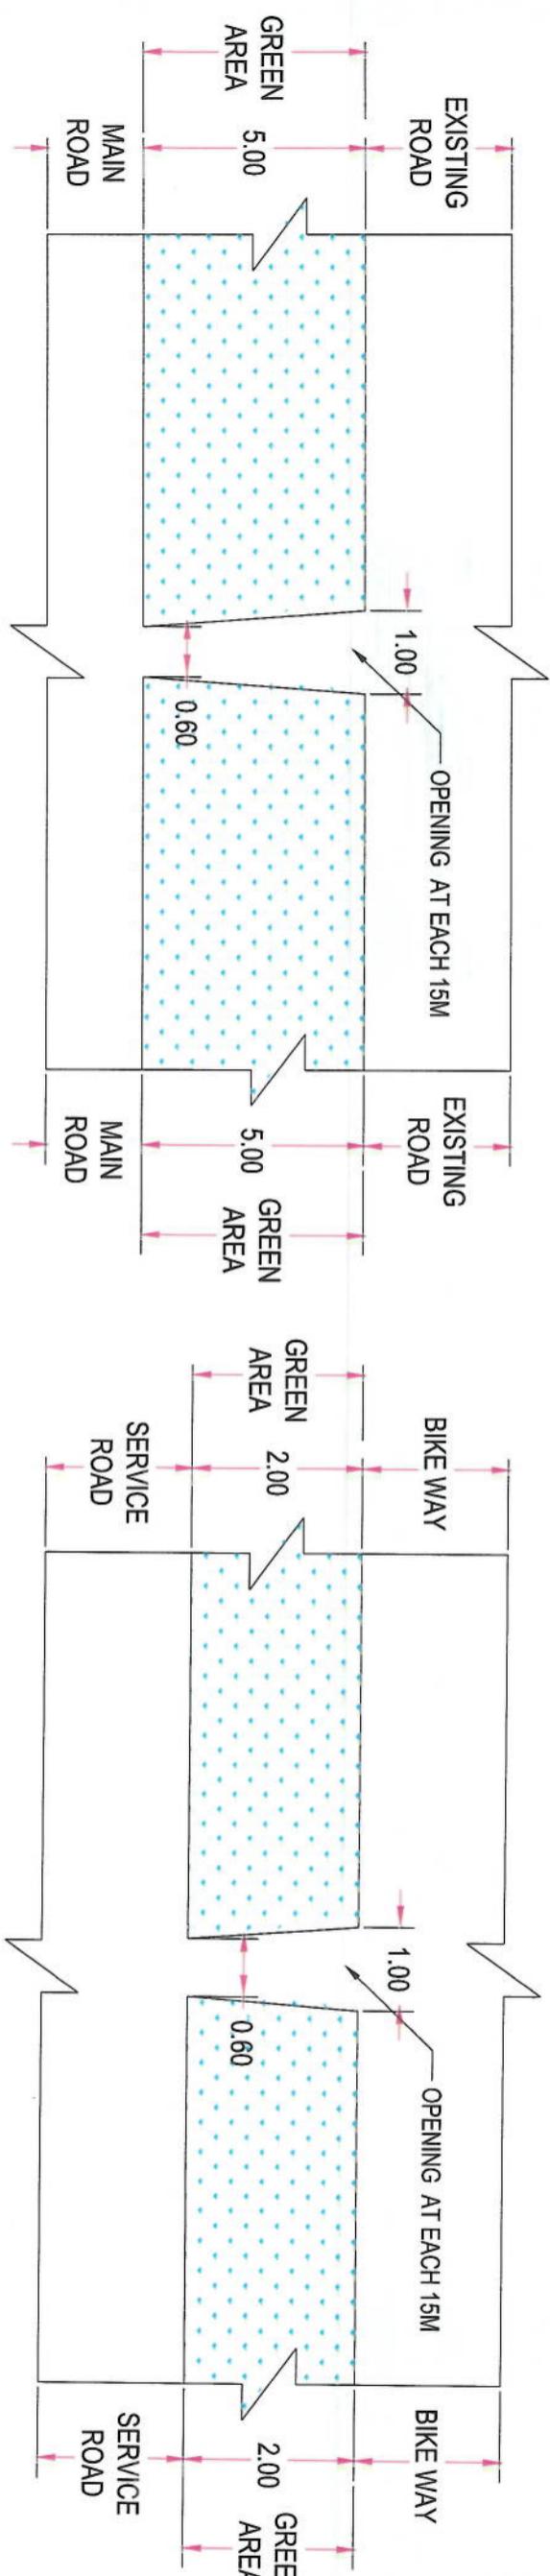

OPENING DETAIL IN RIGHT SIDE GREEN AREA  
SCALE: NTS

OPENING DETAIL IN LEFT SIDE GREEN AREA  
SCALE: NTS

Rev.	Date	Revision Details	Drawn/Chkd/Avpd

ISLAMIC EMIRATE OF  
AFGHANISTAN

KARUL MUNICIPALITY  
DESIGN TEAM

Project Name:  
Cote-Sangi to Demazang road project

Drawing Title:  
Green areas opening detail


Drawn: Mehnajul Rahman  
Signature:

Designed: Mohammad Eisa Saeed  
Checked: Hashibullah Shabizi  
Signature:

Date: 06/06/2023  
Scale: 1:75

Status: FINAL DESIGN



Project Code:

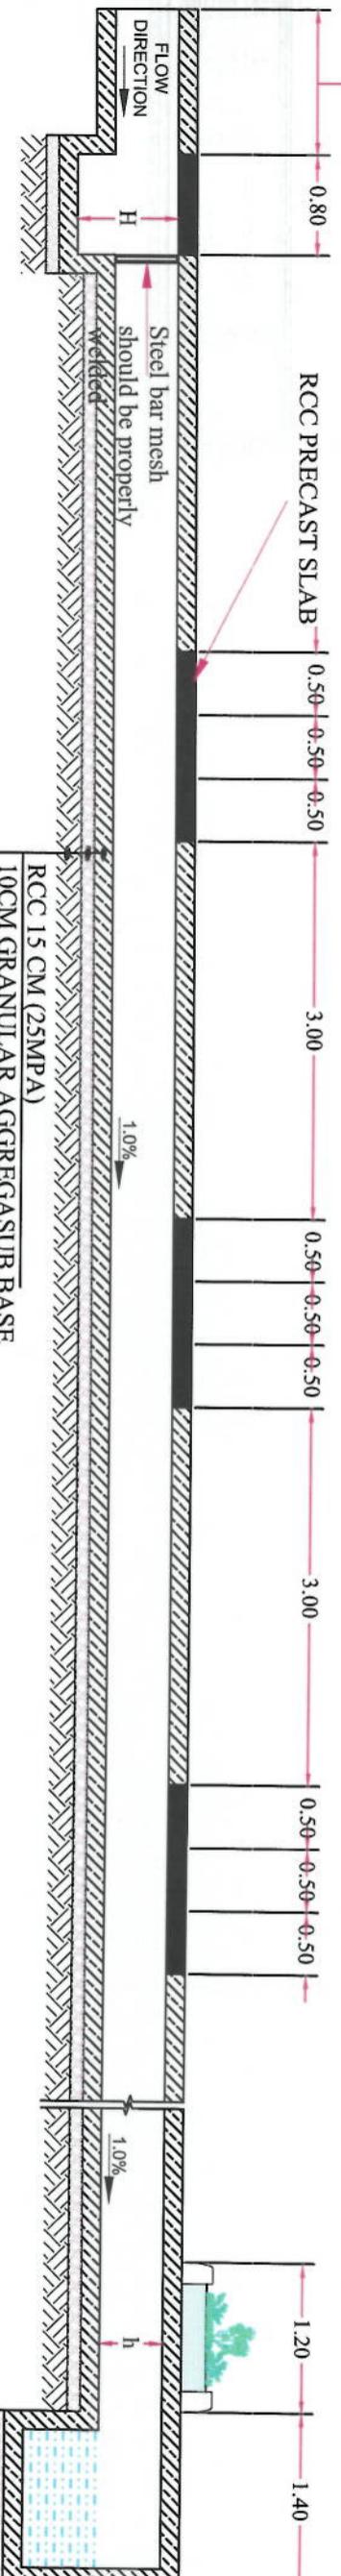


RCC 15 CM (25MPA)  
10CM GRANULAR AGGREGATE BASE  
MATERIAL WITH 98% COMPACTION  
RE-COMPAKTED SOIL  
(COMPACTION=97%)

### SECTION B-B FOR LINK ROADS

- Note:  
 1-All linking roads should connected and adjusted properly to the new designed road as per site  
 2- the location of RCC ditch should be followed the existing ditch in each link road and should be properly adjusted.

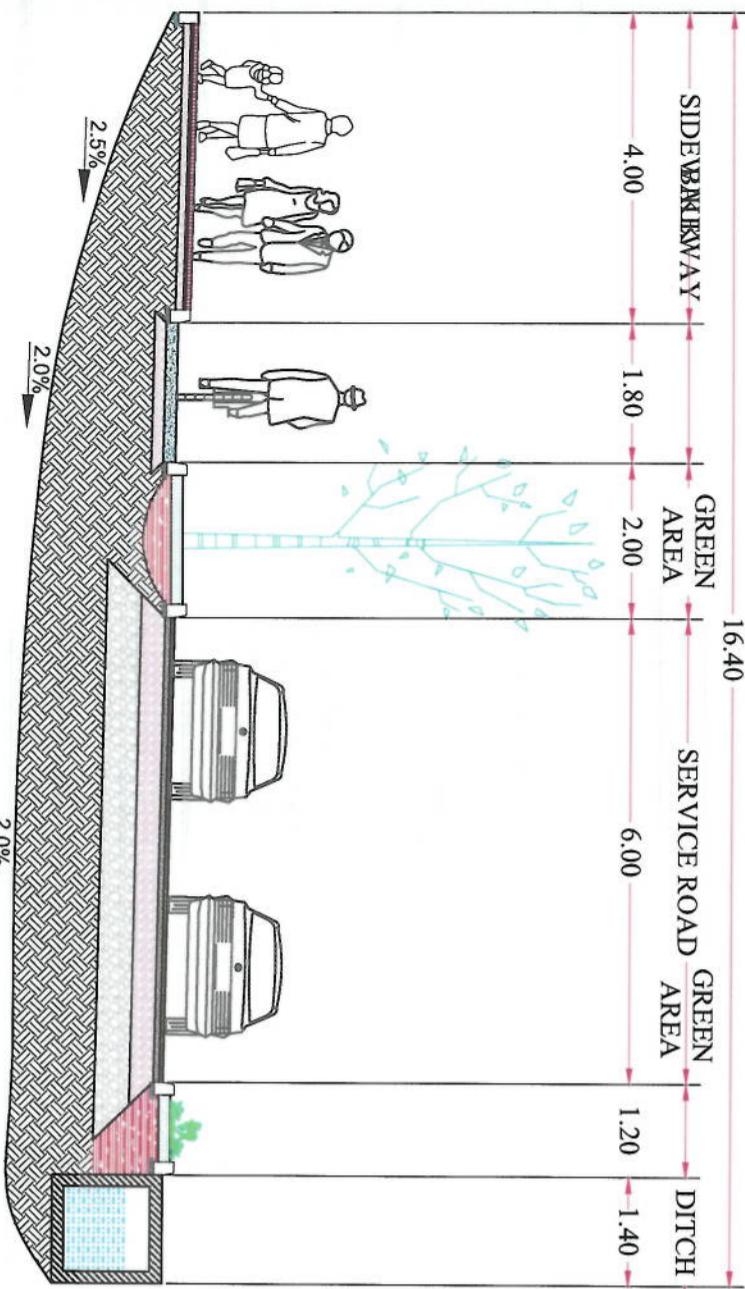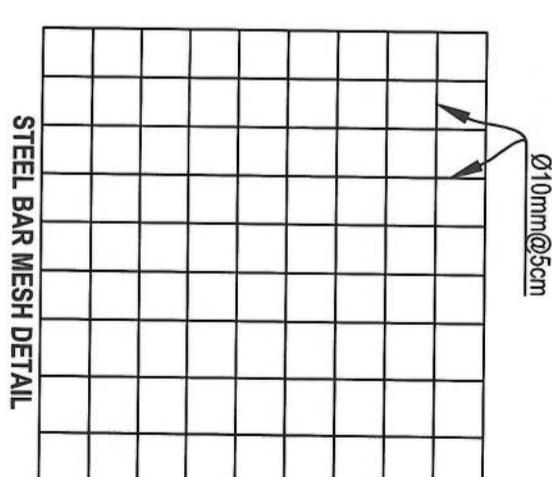

### SECTION A-A FOR LINK ROADS

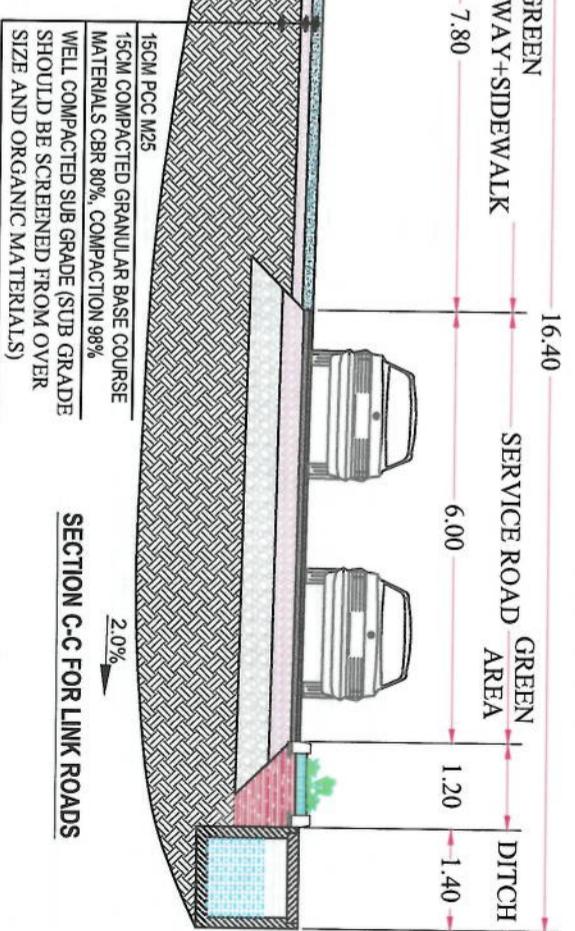


### SECTION C-C FOR LINK ROADS

15CM PCC M25  
15CM COMPACTED GRANULAR BASE COURSE  
MATERIALS CBR 80%, COMPACTION 98%  
WELL COMPACTED SUB GRADE (SUB GRADE  
SHOULD BE SCREENED FROM OVER  
SIZE AND ORGANIC MATERIALS)


NOTE: 1. All dimensions are in m unless otherwise indicated.




Project Name:	KOT-E-SANG TO DEMAZANG ROAD PROJECT
Designed Link Road:	Signature: _____
M.Eesa Sharif	Signature: _____
Designed Link Ditch:	Signature: _____
Abdu Shakoor Mansour	Signature: _____
Checked:	Signature: _____
Hassibullah Shabizi	Signature: _____
Project Code:	
SHEET NO.	EID DETAIL-01
Revision	01
Date:	02/06/2023
Scale:	1:75
Status:	

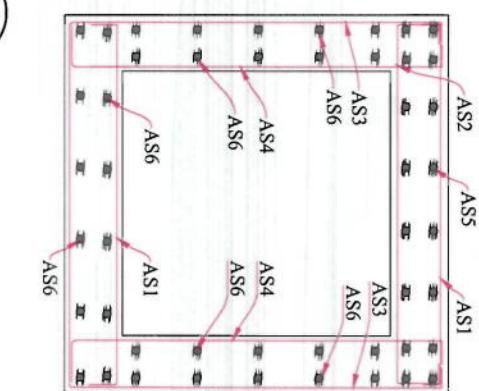


DET: LRD(A)  
DETAIL OF REINFORCING SECTION(A-A)  
SCALE: NTS

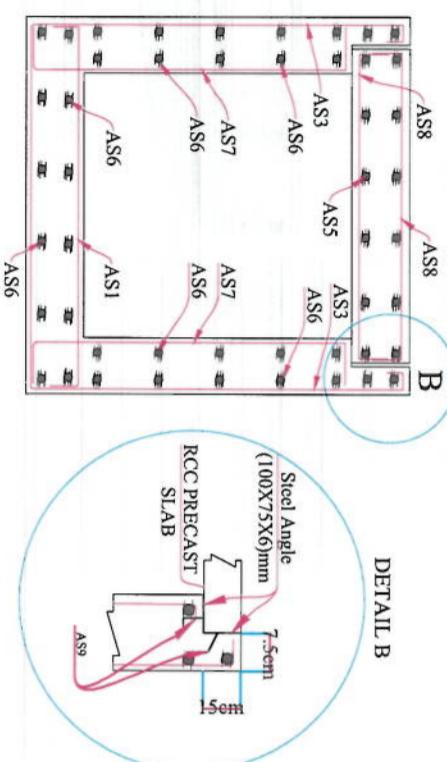


DET: LRD(A)  
DETAIL OF REINFORCING SECTION (B-B)  
SCALE: NTS

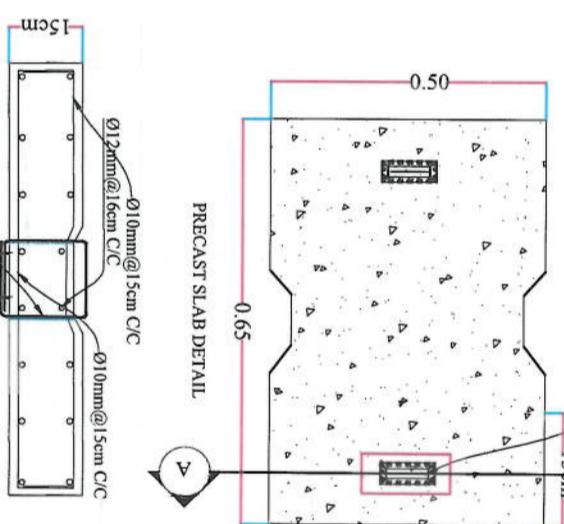


SECTION (A-A)  
SCALE: NO SCALE  
LIFTING HOOK DETAIL

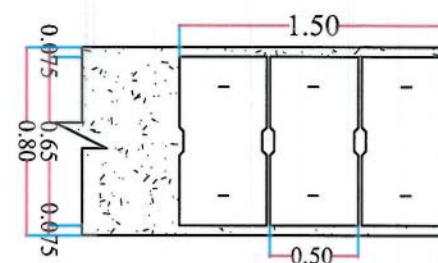


LINK ROAD DITCH PLAN TYPE (A)

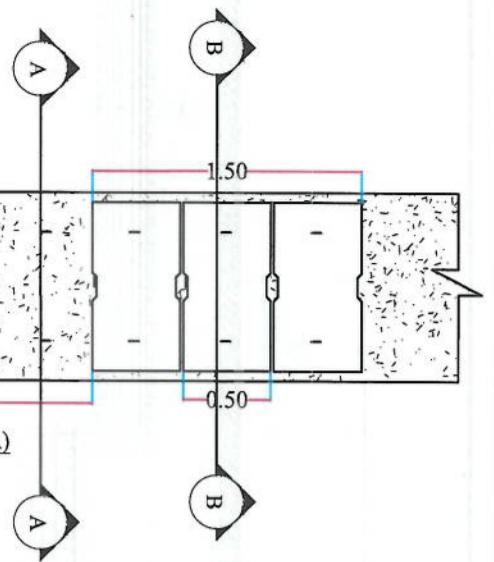

DET: LRD(A)  
DETAIL SECTION(B-B)  
SCALE: NTS

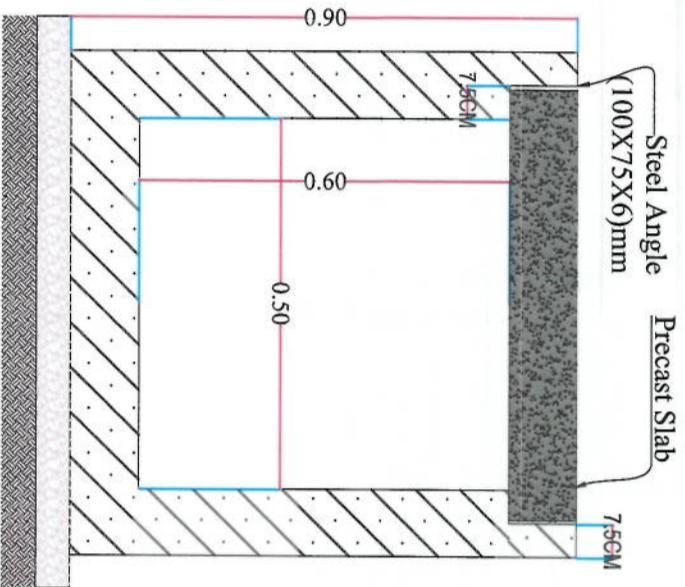

DET: LRD(A)  
DETAIL SECTION(A-A)  
SCALE: NTS

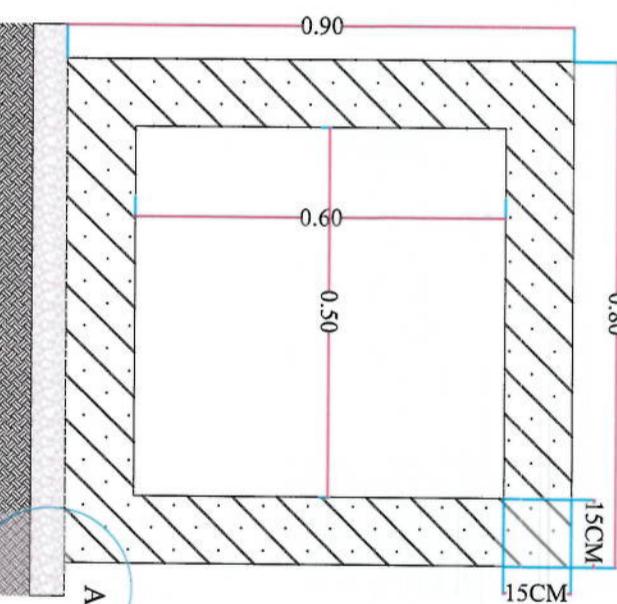

RCC 15 CM (25MPA)  
10CM GRANULAR AGGREGATE SUB BASE  
MATERIAL WITH 98% COMPACTION  
RE-COMPACTED SOIL  
(COMPACTION=97%)



DITCH (80X90)CM REINFORCEMENT SCHEDULE

Bar No.	Bar Shape	$\varnothing$ (mm)	Spacing (mm)	Remark
As1		12	60	
As2		12	160	
As3		12	160	
As4		12	160	
As5		10	150	
As6		10	150	
As7		12	160	
As8		12	160	
As9		8	200	

NOTE:


- All dimensions are in meters unless otherwise indicated.

Date: 02/06/2023 Scale:  
Status: FINEL DESIGN  
Project Code:



SHEET NO. LRD(1) Revision 01

NOTE:


1. All dimensions are in meters unless otherwise indicated.

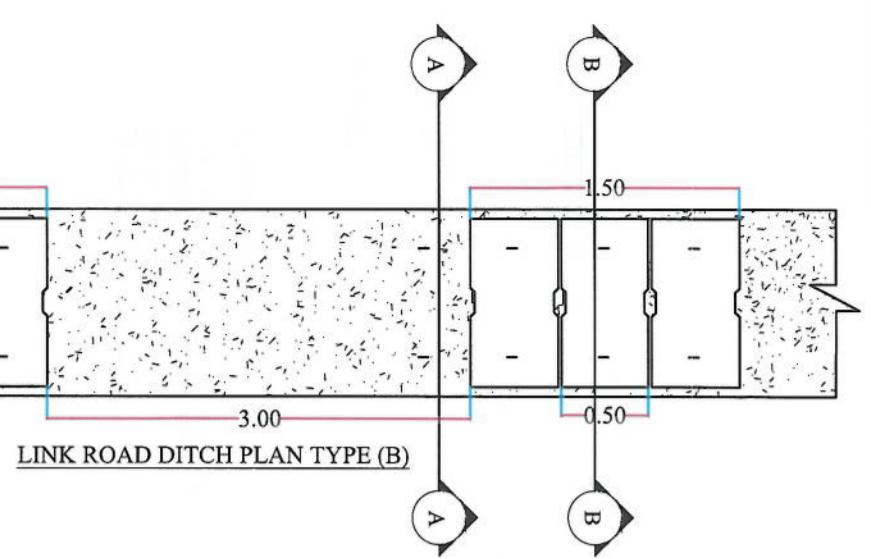

LINK ROAD DITCH PLAN TYPE (B)

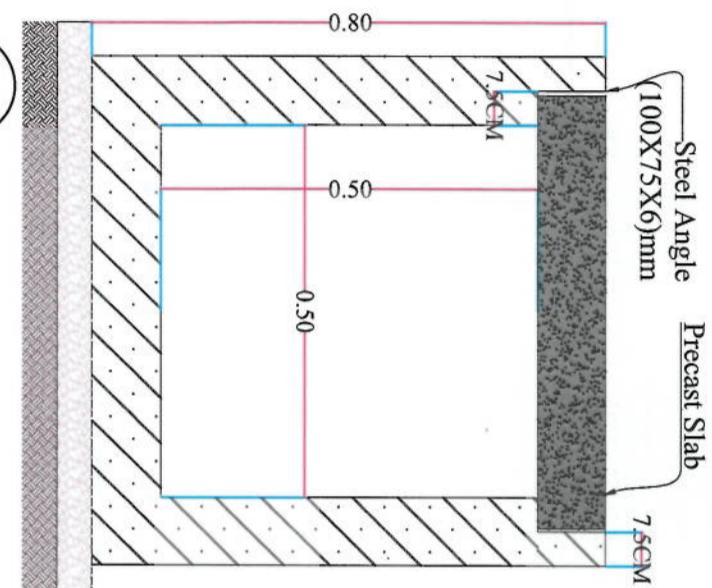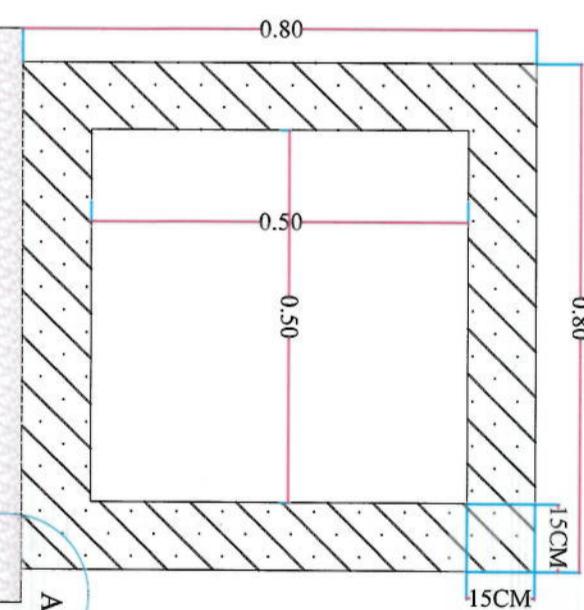DET: LRD(TB)  
DETAIL SECTION(B-B)  
SCALE: NTSDET: LRD(TB)  
DETAIL SECTION(A-A)  
SCALE: NTS

RCC 15 CM (25MPA)  
10CM GRANULAR AGGREGATE SUB BASE  
MATERIAL WITH 98% COMPACTION  
RE-COMPACTED SOIL  
(COMPACTION=97%)



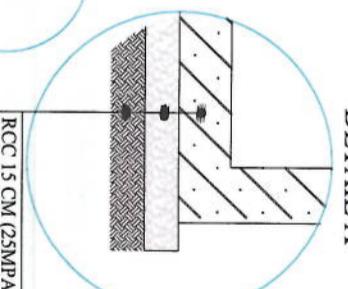


DETAIL A


## DITCH (80X30) CM REINFORCEMENT SCHEDULE

Project Name: KOT-E-SANGI TO DEMAWANG  
ROAD PROJECT  
Drawing Title: LINK ROADS DRAIN TYPICAL CROSS  
SECTION TYPE(B)  
Drawn: Naseeb ul Nabi Signature:  
Designed: Abdul Shakoor Mansour Signature:  
Checked: Habibullah Sulzai Signature:  
Date: 02/06/2023 Seal:

KABUL MUNICIPALITY  
DESIGN TEAM

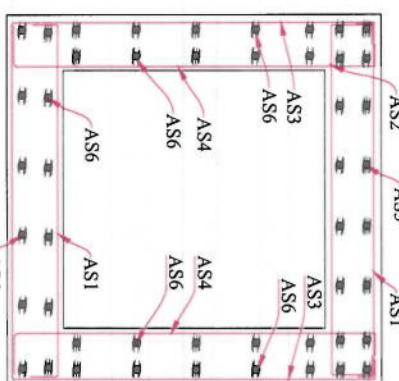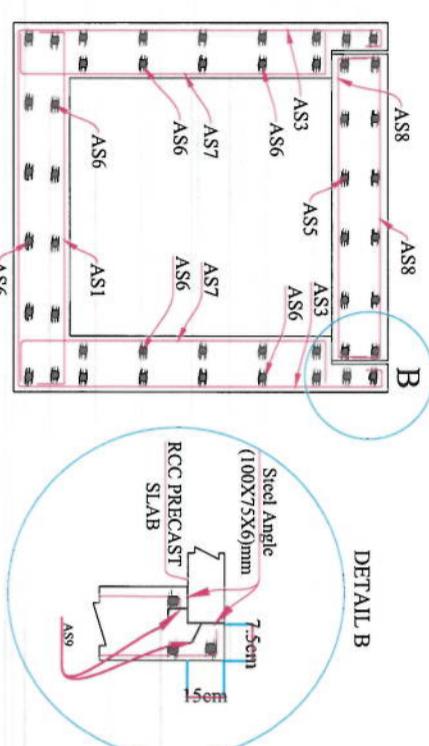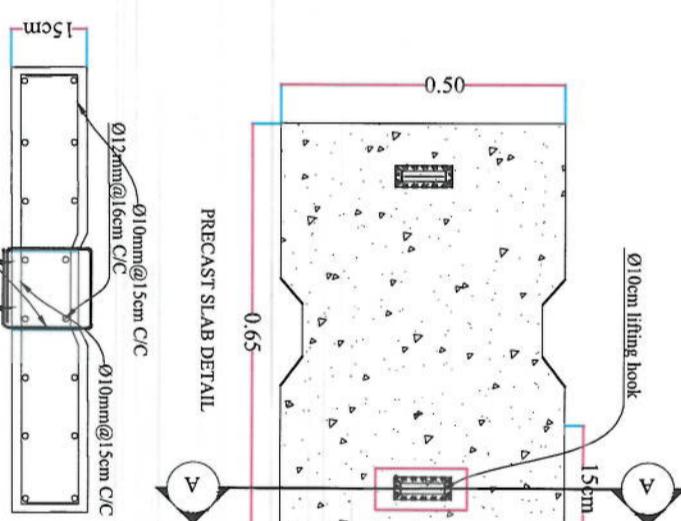DET: DETAIL OF REINFORCING SECTION(A-A)  
SCALE: NTSDET: DETAIL OF REINFORCING SECTION (B-B)  
SCALE: NTSDET: PRECAST SLAB DETAIL  
SCALE: NO SCALE


LIFTING HOOK DETAIL

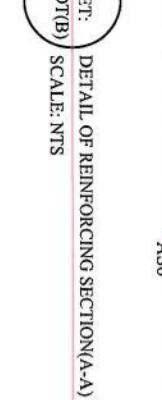DET: PVC SLEEVE OR  
EQUIVALENT ROD  
SECTION (A-A)  
SCALE: NO SCALE

LIFTING HOOK DETAIL

Status: FINEL DESIGN	Project Code: Project Code	Date: 02/06/2023	Seal:
SHEET NO.: LRD(2)	Revision: 01		

NOTE:  
1. All dimensions are in meters unless otherwise indicated.

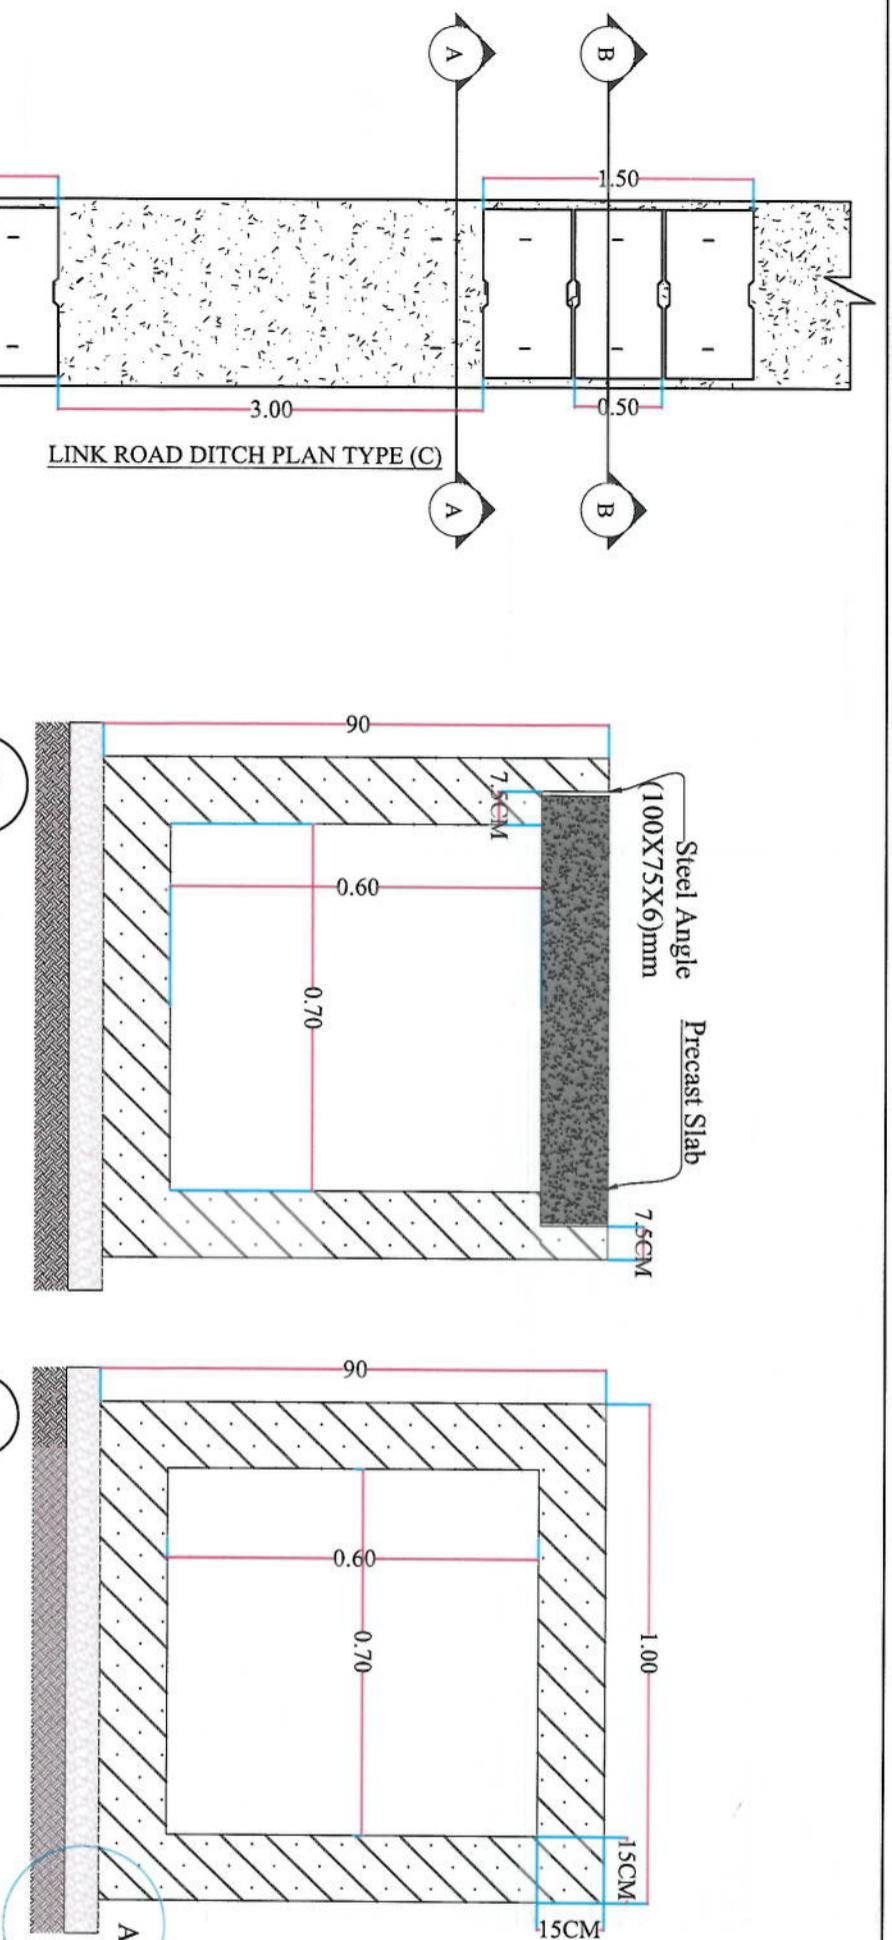

LINK ROAD DITCH PLAN TYPE (C)

DET: LRDTC  
DETAIL SECTION(B-B)  
SCALE: NTS

DET: LRDTC  
DETAIL SECTION(A-A)  
SCALE: NTS

RCC 15 CM (25MPA)  
10CM GRANULAR AGGREGATE SUB BASE  
MATERIAL WITH 98% COMPACTION  
RE-COMPACTED SOIL  
(COMPACTION=97%)



DITCH (100X90)CM REINFORCEMENT SCHEDULE

Drawing Title:  
LINK ROADS DRAIN TYPICAL CROSS  
SECTION TYPE(C)

Project Name:  
KOT-E-SANGI TO DEMAZANG  
ROAD PROJECT




KABUL MUNICIPALITY  
DESIGN TEAM

Drawn:  
Nasirul Nasir  
Signature:

Designed:  
Abdu Shakoor Mansour  
Signature:

Checked:  
Hamidullah Shaiqi  
Signature:

Date:  
02/06/2023  
Scale:

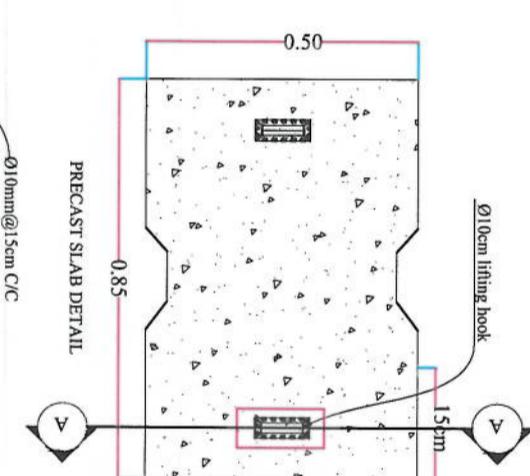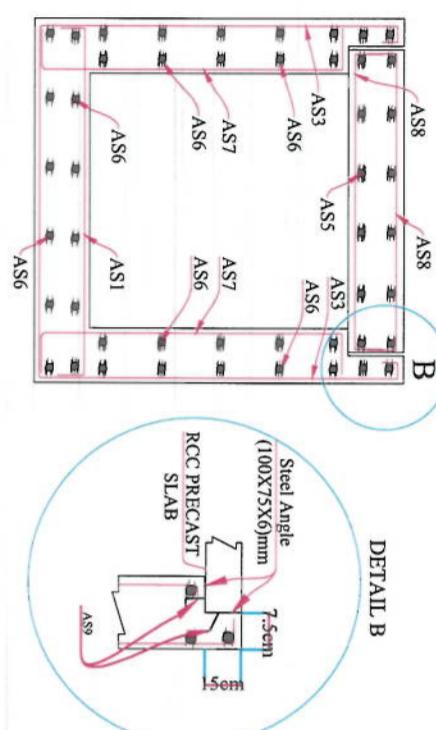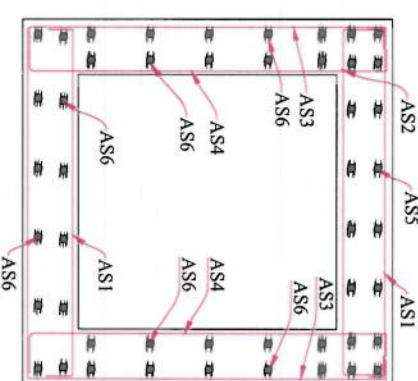




DET: LRDTC  
DETAIL OF REINFORCING SECTION(A-A)  
SCALE: NTS

DET: LRDTC  
DETAIL OF REINFORCING SECTION (B-B)  
SCALE: NTS

SECTION (A-A)  
LIFTING HOOK DETAIL  
shall be bolted  
PVC sleeve or  
equivalent rod

SHEET NO. LRD(3) Revision 01  
Status: FINEL DESIGN  
Project Code



NOTE:  
1. All dimensions are in meter unless  
otherwise indicated.

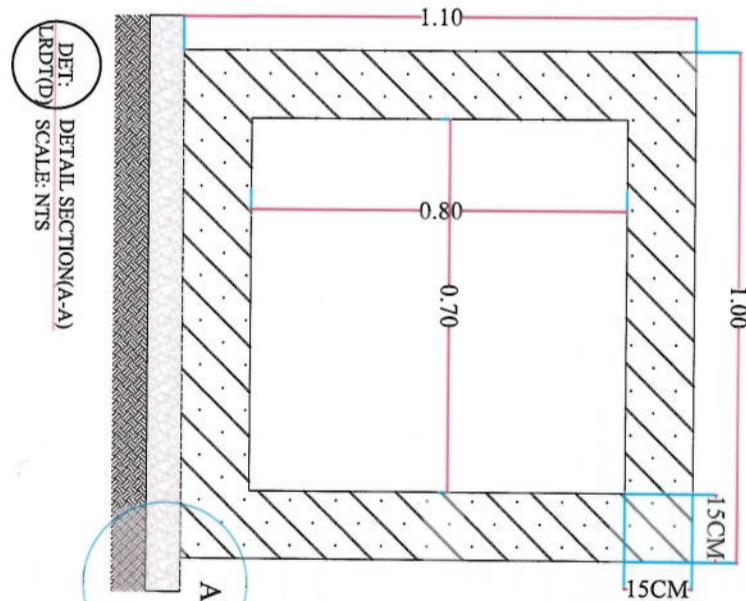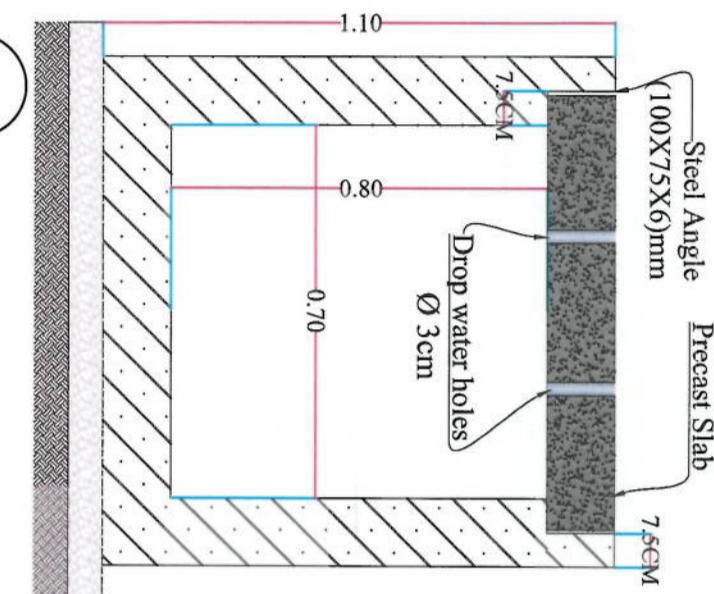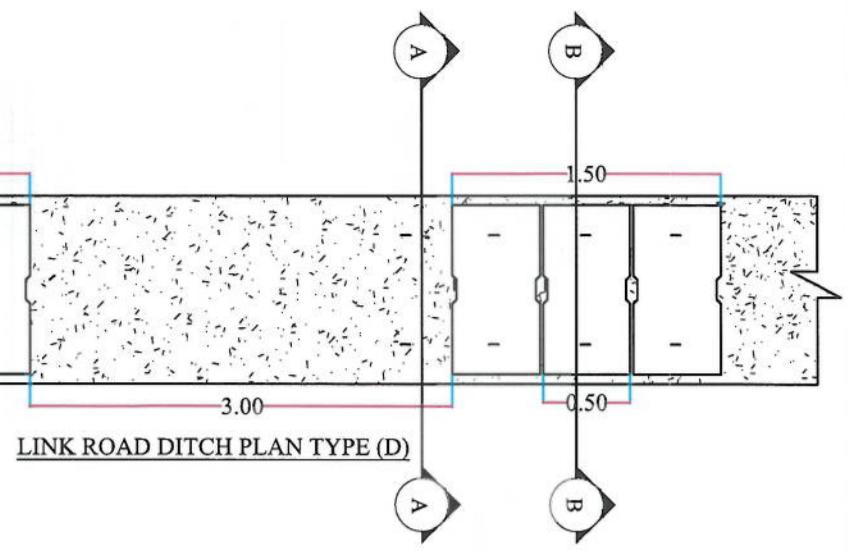

RCC 15 CM (25MPA)  
10CM GRANULAR AGGREGATE SUB BASE  
MATERIAL WITH 98% COMPACTION  
RE-COMPACTED SOIL  
(COMPACTON=97%)


DITCH (100X10)CM REINFORCEMENT SCHEDULE

Bar No.	Bar Shape	$\varnothing$ (mm)	Spacing (mm)	Remark
A1	[L-shaped]	12	145	
A2	[L-shaped]	12	145	
A3	[L-shaped]	12	145	
A4	[L-shaped]	12	145	
A5	[L-shaped]	10	150	
A6	[L-shaped]	10	150	
A7	[L-shaped]	12	145	
A8	[L-shaped]	12	145	
A9	[L-shaped]	8	200	

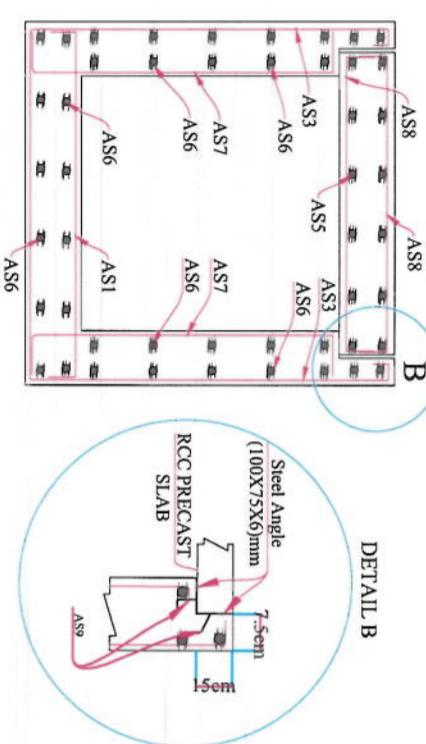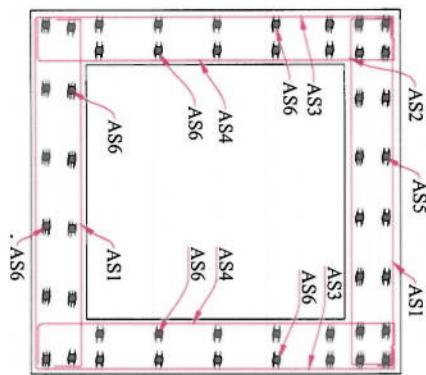

DET: LRD(D)  
DETAIL OF REINFORCING SECTION(A-A)  
SCALE: NTS

DET: LRD(D)  
DETAIL OF REINFORCING SECTION (B-B)  
SCALE: NTS

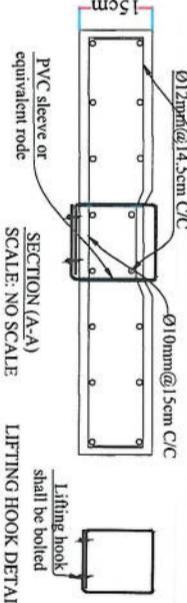

SECTION (A-A)  
LIFTING HOOK DETAIL  
SCALE: NO SCALE

Lifting hook shall be bolted



Project Name: KOT-E-SANGI TO DEMAZANG ROAD PROJECT  
Drawing Title: LINK ROADS DRAIN TYPICAL CROSS SECTION TYPE(D)  
Drawn: Noorulai Nasri Signature: \_\_\_\_\_  
Designed By: Abdal Shakoor Munawar Signature: \_\_\_\_\_  
Checked: Hasbullah Shahzai Signature: \_\_\_\_\_  
Date: 02/06/2023 Scale: \_\_\_\_\_  
Status: FINEL DESIGN  
Project Code: \_\_\_\_\_  
SHEET NO. LRD(4) Revision 01







LINK ROAD CATCH BASIN PLAN TYPE (A)

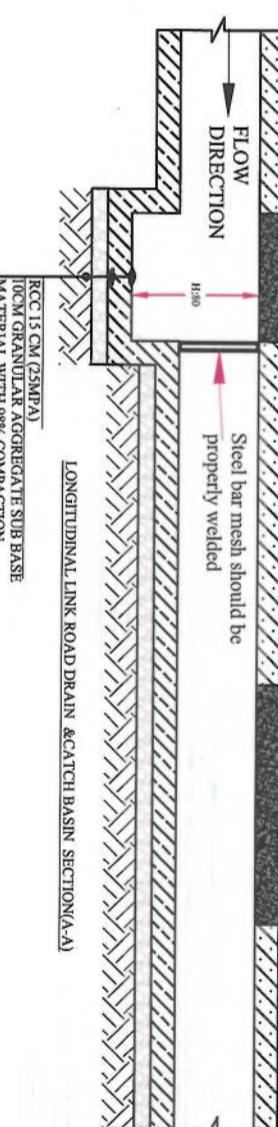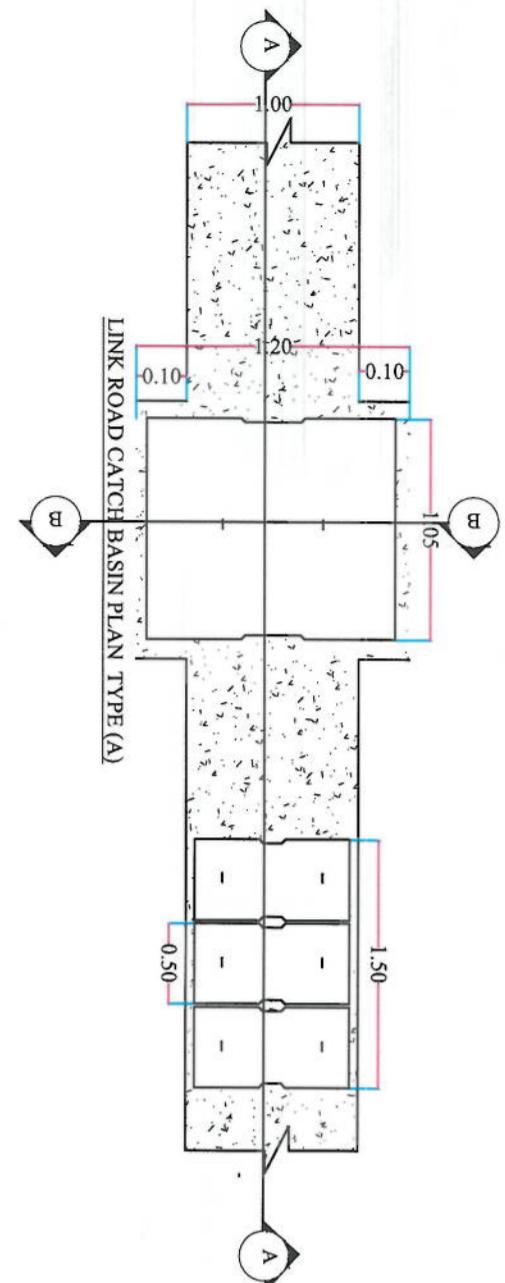

Ø10cm Lifting hook

Steel Angle  
(100X75X6)mm  
Precast Slab

1.20

7.5cm

1.10

0.80

0.90

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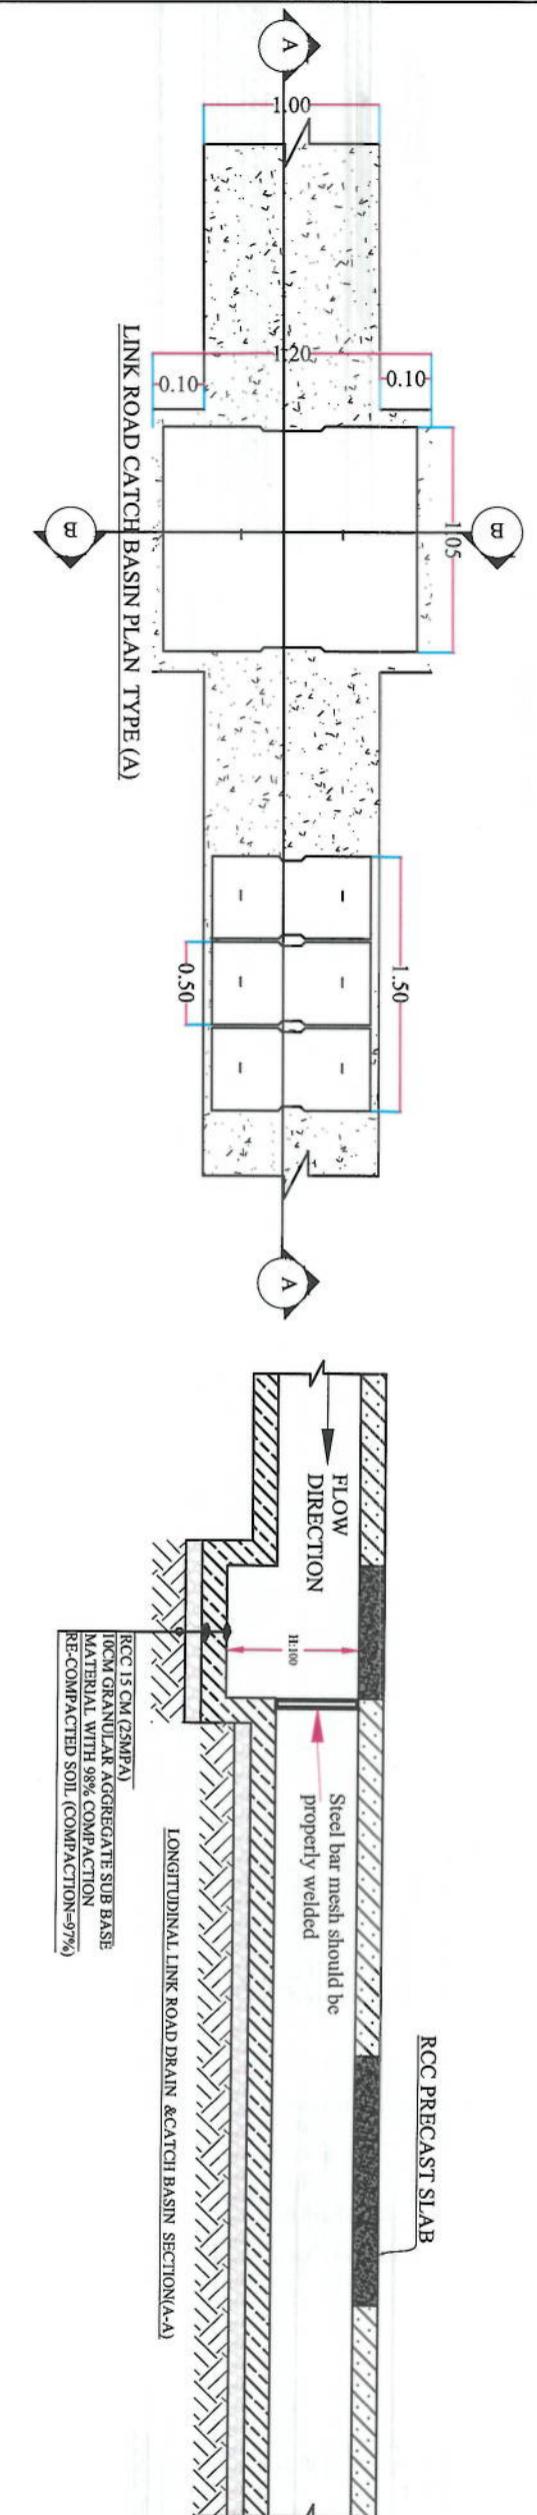
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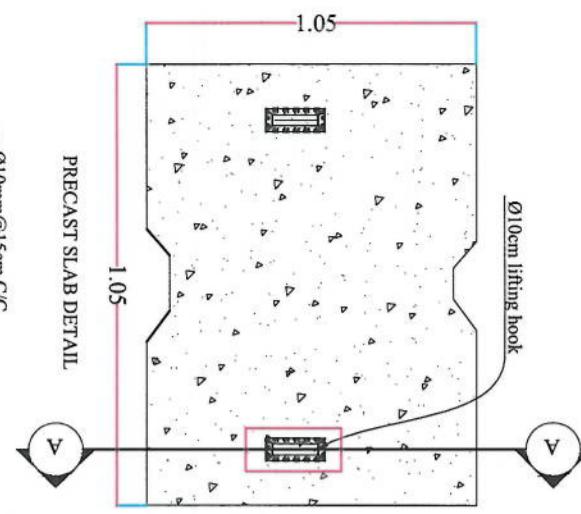
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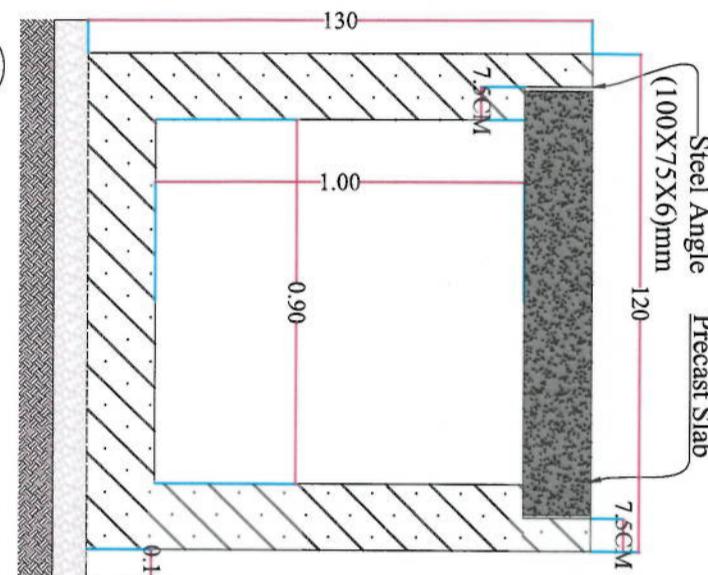
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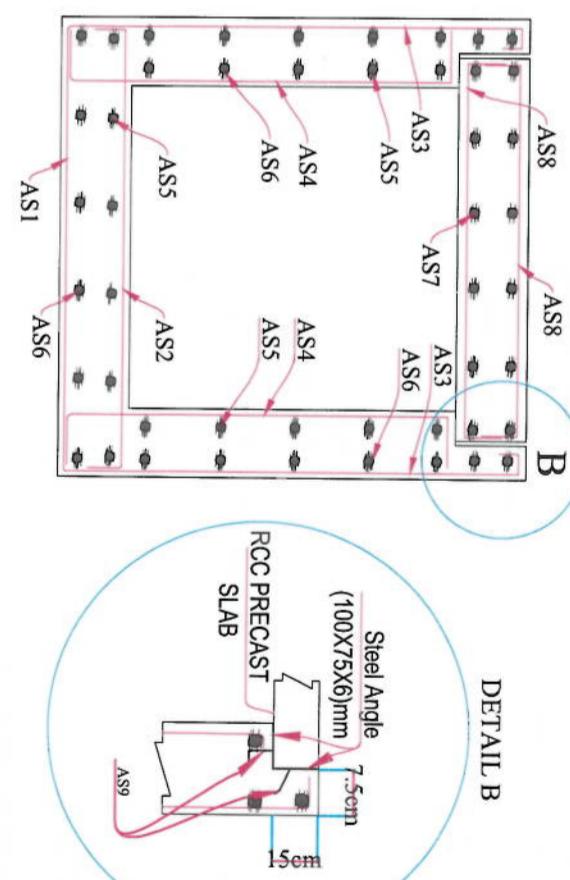
LINK ROAD CATCH BASIN PLAN TYPE (A)




PRECAST SLAB DETAIL  
SECTION (A-A)  
SCALE: NO SCALE  
LIFTING HOOK DETAIL



DEF: DETAIL SECTION(B-B)  
LRDC(D) SCALE: NTS



DET: DETAIL OF REINFORCING SECTION (B-B)  
LRDC(D) SCALE: NTS

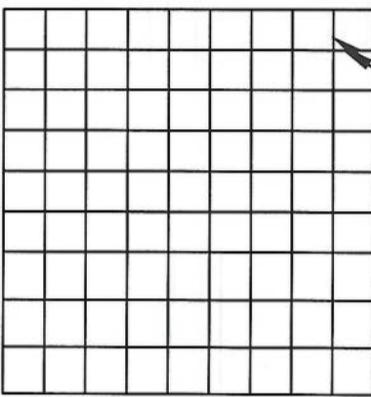

DITCH (120X130CM) REINFORCEMENT SCHEDULE

Bar No.	Bar Shape	Ø (mm)	Spacing (mm)	Remark
A1		12	145	
A2		12	145	
A3		12	145	
A4		12	145	
A5		10	150	
A6		10	150	
A7		12	145	
A8		12	145	
A9		8	200	

ISLAMIC EMIRATE OF  
AFGHANISTAN  
KABUL MUNICIPALITY  
DESIGN TEAM

Project Name:  
KOTE-SANGI TO DEMNAZANG  
ROAD PROJECT

Drawing Title:

CATCH BASIN DETAIL

Detail:

TYPE (D)

DATE:

02/06/2023

Scale:

1:500

Status:

FINAL DESIGN

Project Code:

CBDD(4)

Revision:

01


NOTE:  
1. All dimensions are in meters unless otherwise indicated.

Note:  
 1- where ever the level of design profile is upper than existing road edge it is recommended to follow the existing road edge as control level.  
 2- where ever the design profile is lower than existing road edge, then right side curb stone of center median should follow the design profile as the control level.



3- In case of changing in typical cross section type all components should be adjusted properly.  
 4- All bed levels of new ditches should be adjusted to the existing paved roads both at start and at the end property.

NOTE:  
 1- The lengths of all new side ditches have shown on the plan.  
 2- The finished level of new roads should be adjusted to the existing paved roads both at start and at the end property.  
 3- In case of changing in typical cross section type all components should be adjusted properly.  
 4- All bed levels of new ditches should be adjusted to the existing paved roads both at start and at the end property.  
 5- Because of residential area on the site, the survey design has done based on the survey with less accuracy and it is necessary to re-survey the area after the demolition of houses.

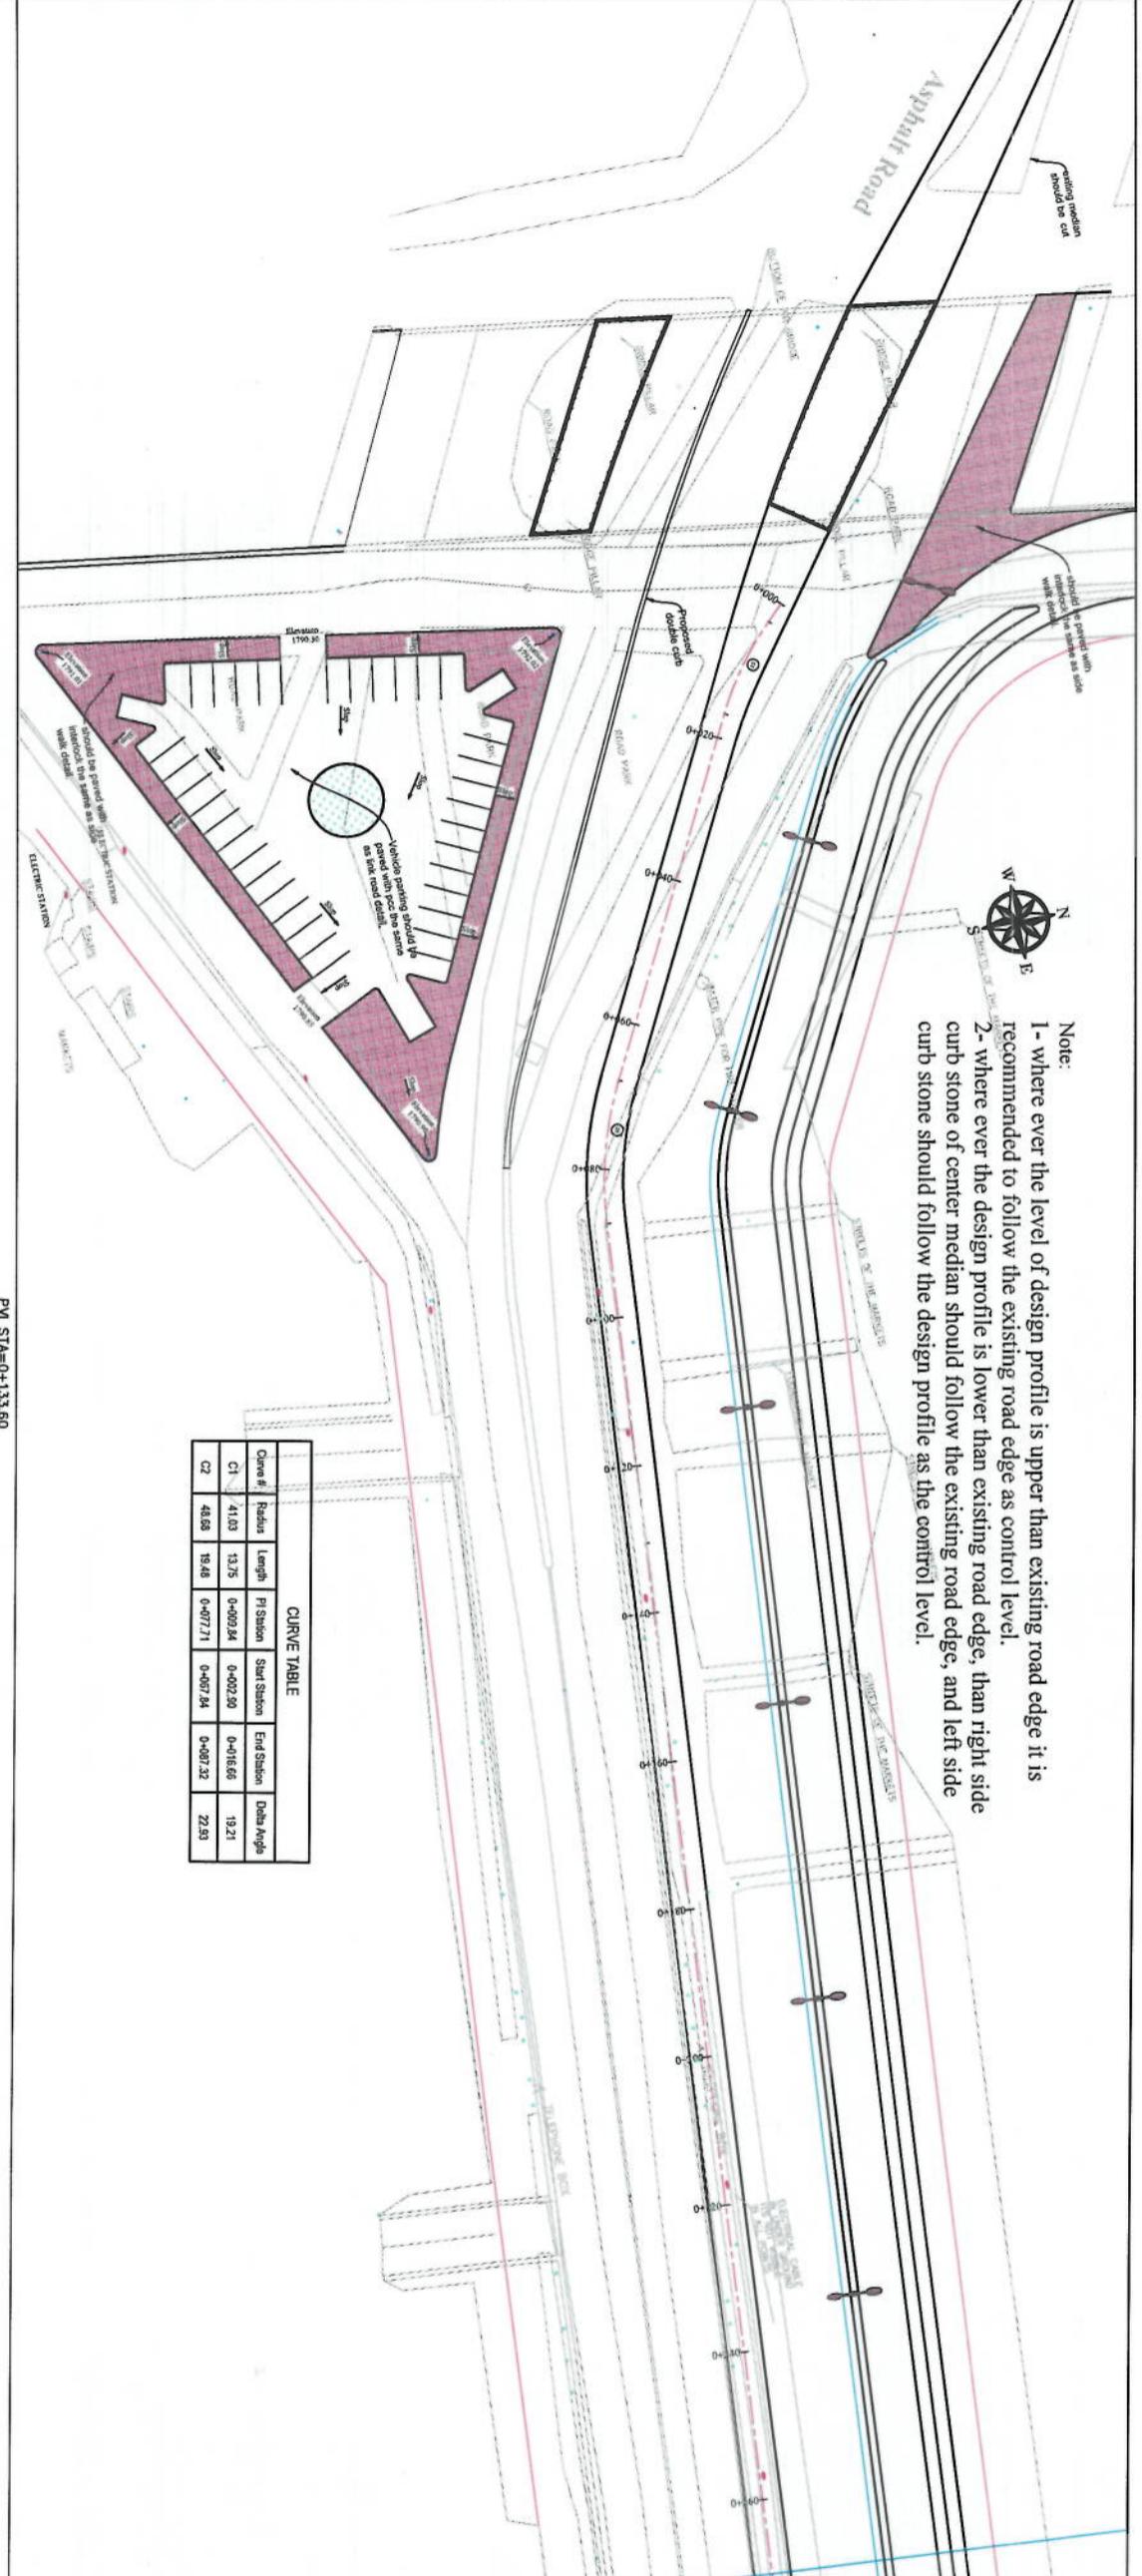

CURVE TABLE					
Curve #	Radius	Length	Pt Station	Start Station	End Station
C1	41.03	13.75	0+09.34	0+02.50	0+16.65
C2	48.68	18.48	0+07.71	0+07.84	0+07.32

PVI STA=0+133.60  
PVI ELEV=789.95  
LVC=94.19  
K=278.47

Date	Revision Details	Drawn

#### ISLAMIC EMIRATE OF AFGHANISTAN

KABUL MUNICIPALITY  
KABUL MUNICIPALITY

Client:

Mohammad Eesa Sharif  
Signature:

Project Name:  
Gore-Sangi To Dehmazang  
Road Project


Drawing Title:

#### PLAN & PROFILE

Designed by:	Signature:
KABUL MUNICIPALITY	
Project Name:	
Gore-Sangi To Dehmazang	
Road Project	

Date:	6/10/2023	Scale:	1:1000
Site No:	FINAL DESIGN	Project Code:	
Drawing Number:	PP-1	Revision:	00




VERTICAL GEOMETRY	
G= -0.70%	
K=278.47	
L=94.19	

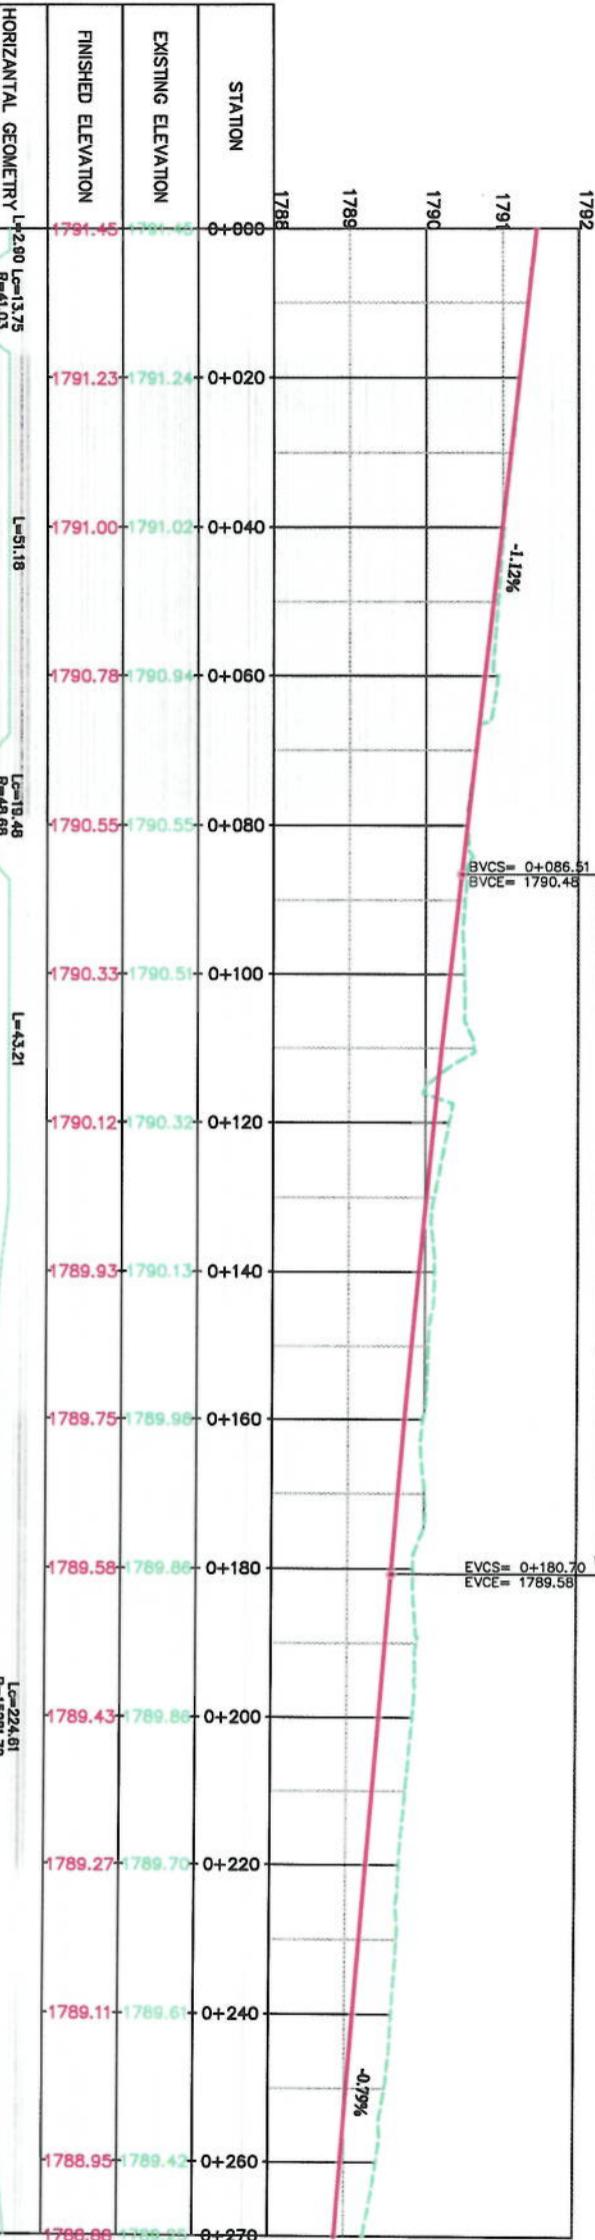




Note:  
 1- where ever the level of design profile is upper than existing road edge it is recommended to follow the existing road edge as control level.  
 2- where ever the design profile is lower than existing road edge, than right side curb stone of center median should follow the design profile as the control level.

NOTE:  
 1- The heights of all new side ditches have shown on the plan.  
 2- The finished level of new roads should be adjusted to the existing paved roads both at start and at the end properly.  
 3- In case of changing in optical cross section type all components should be adjusted properly.  
 4- All Bed levels of new ditches should be adjusted to the existing ditch bed levels to reflect survey works properly.  
 5- Because of residential area on the site, the survey team was not allowed to enter the houses; therefore, the design has been based on the survey with less accuracy and it is necessary to re-survey the area after the demolition of houses.

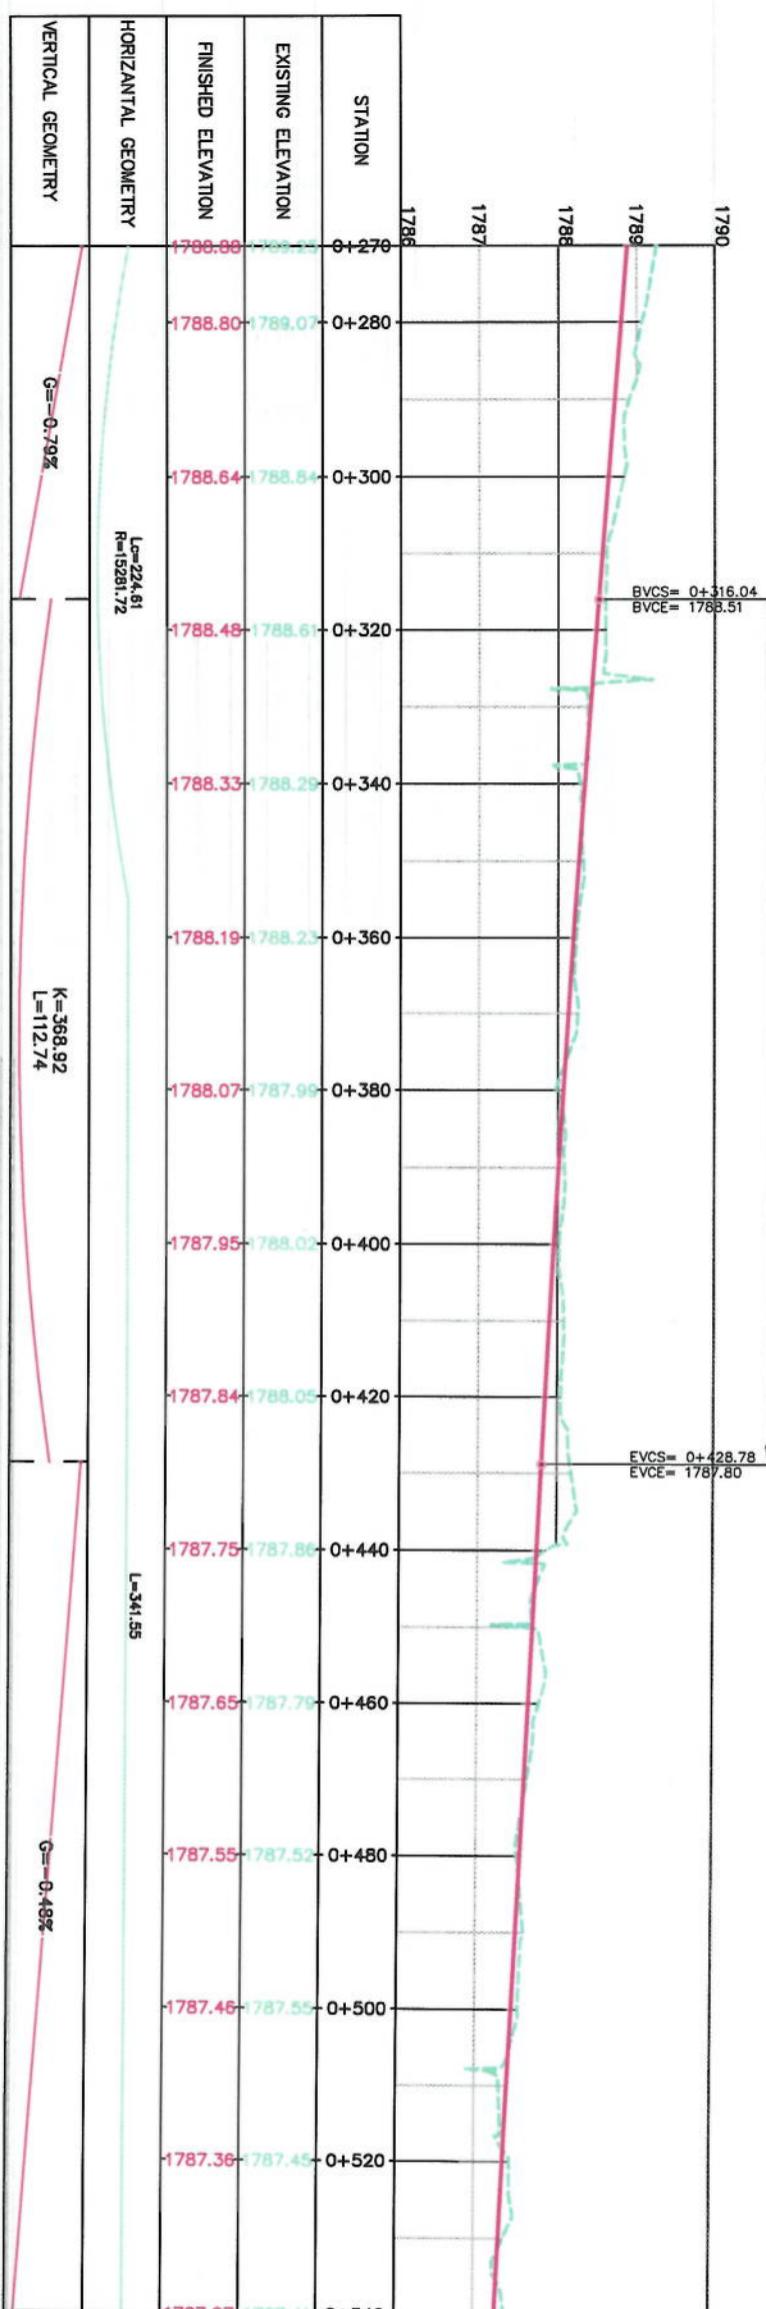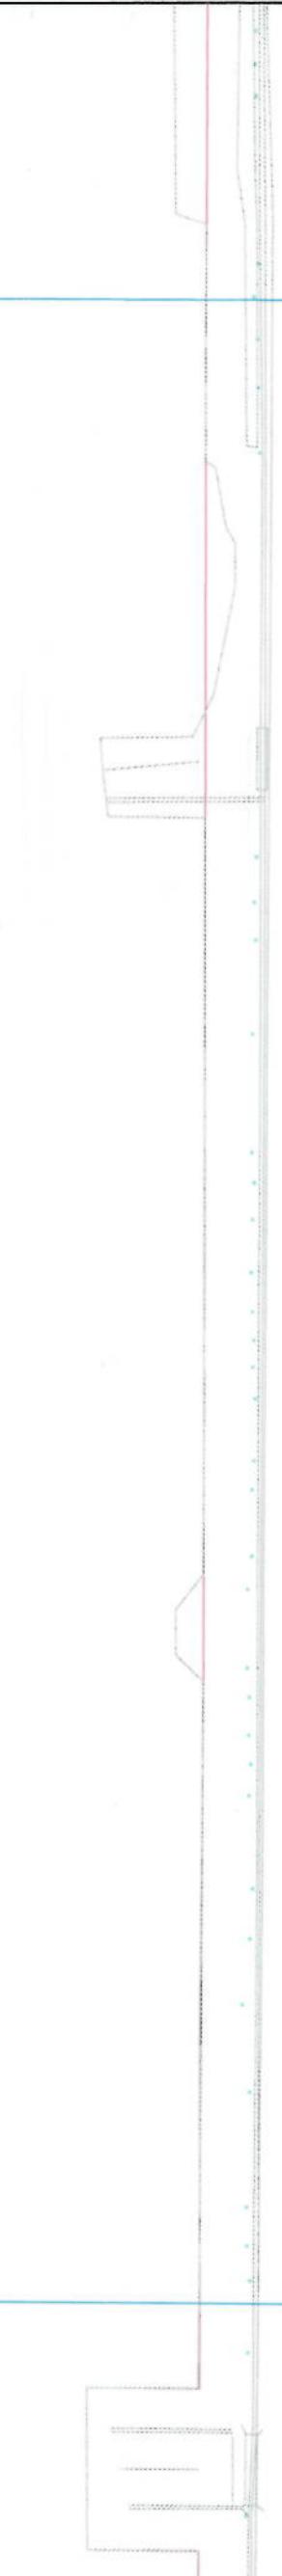
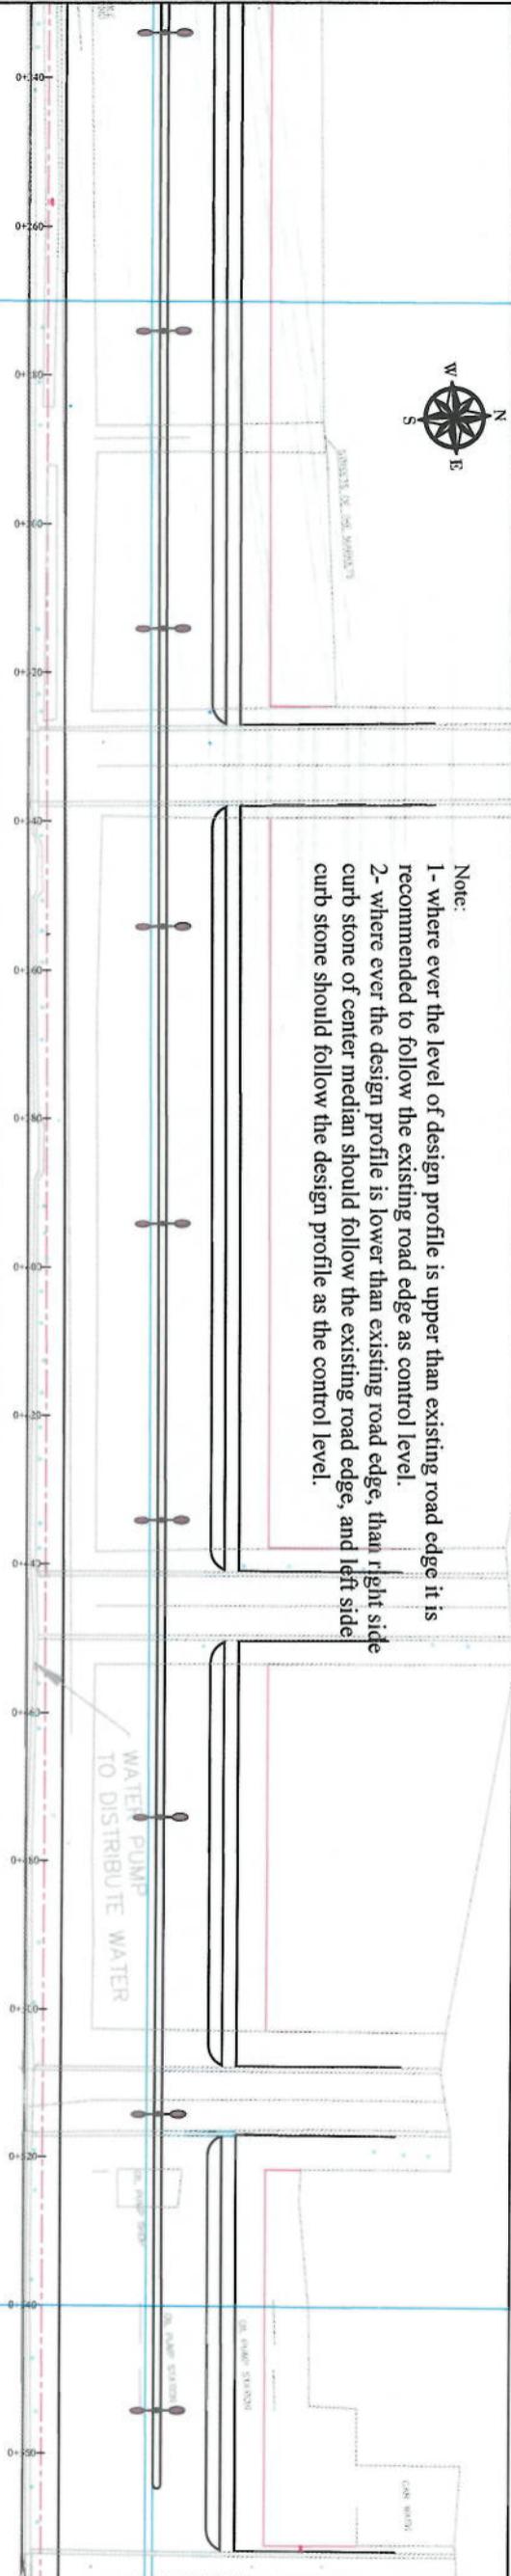


PLAN & PROFILE	
Designed by:	Signature
Mohammad Fisa Sial	Signature
Drawn by:	Signature
Mohammad Fisa Sial	Signature
Checked by:	Signature
Habibullah Sialzi	Signature
Date:	6/10/2023
Scale:	1:1000
Status:	FINAL DESIGN
Project Code:	
Drawing Number:	PP-2
Revision:	00

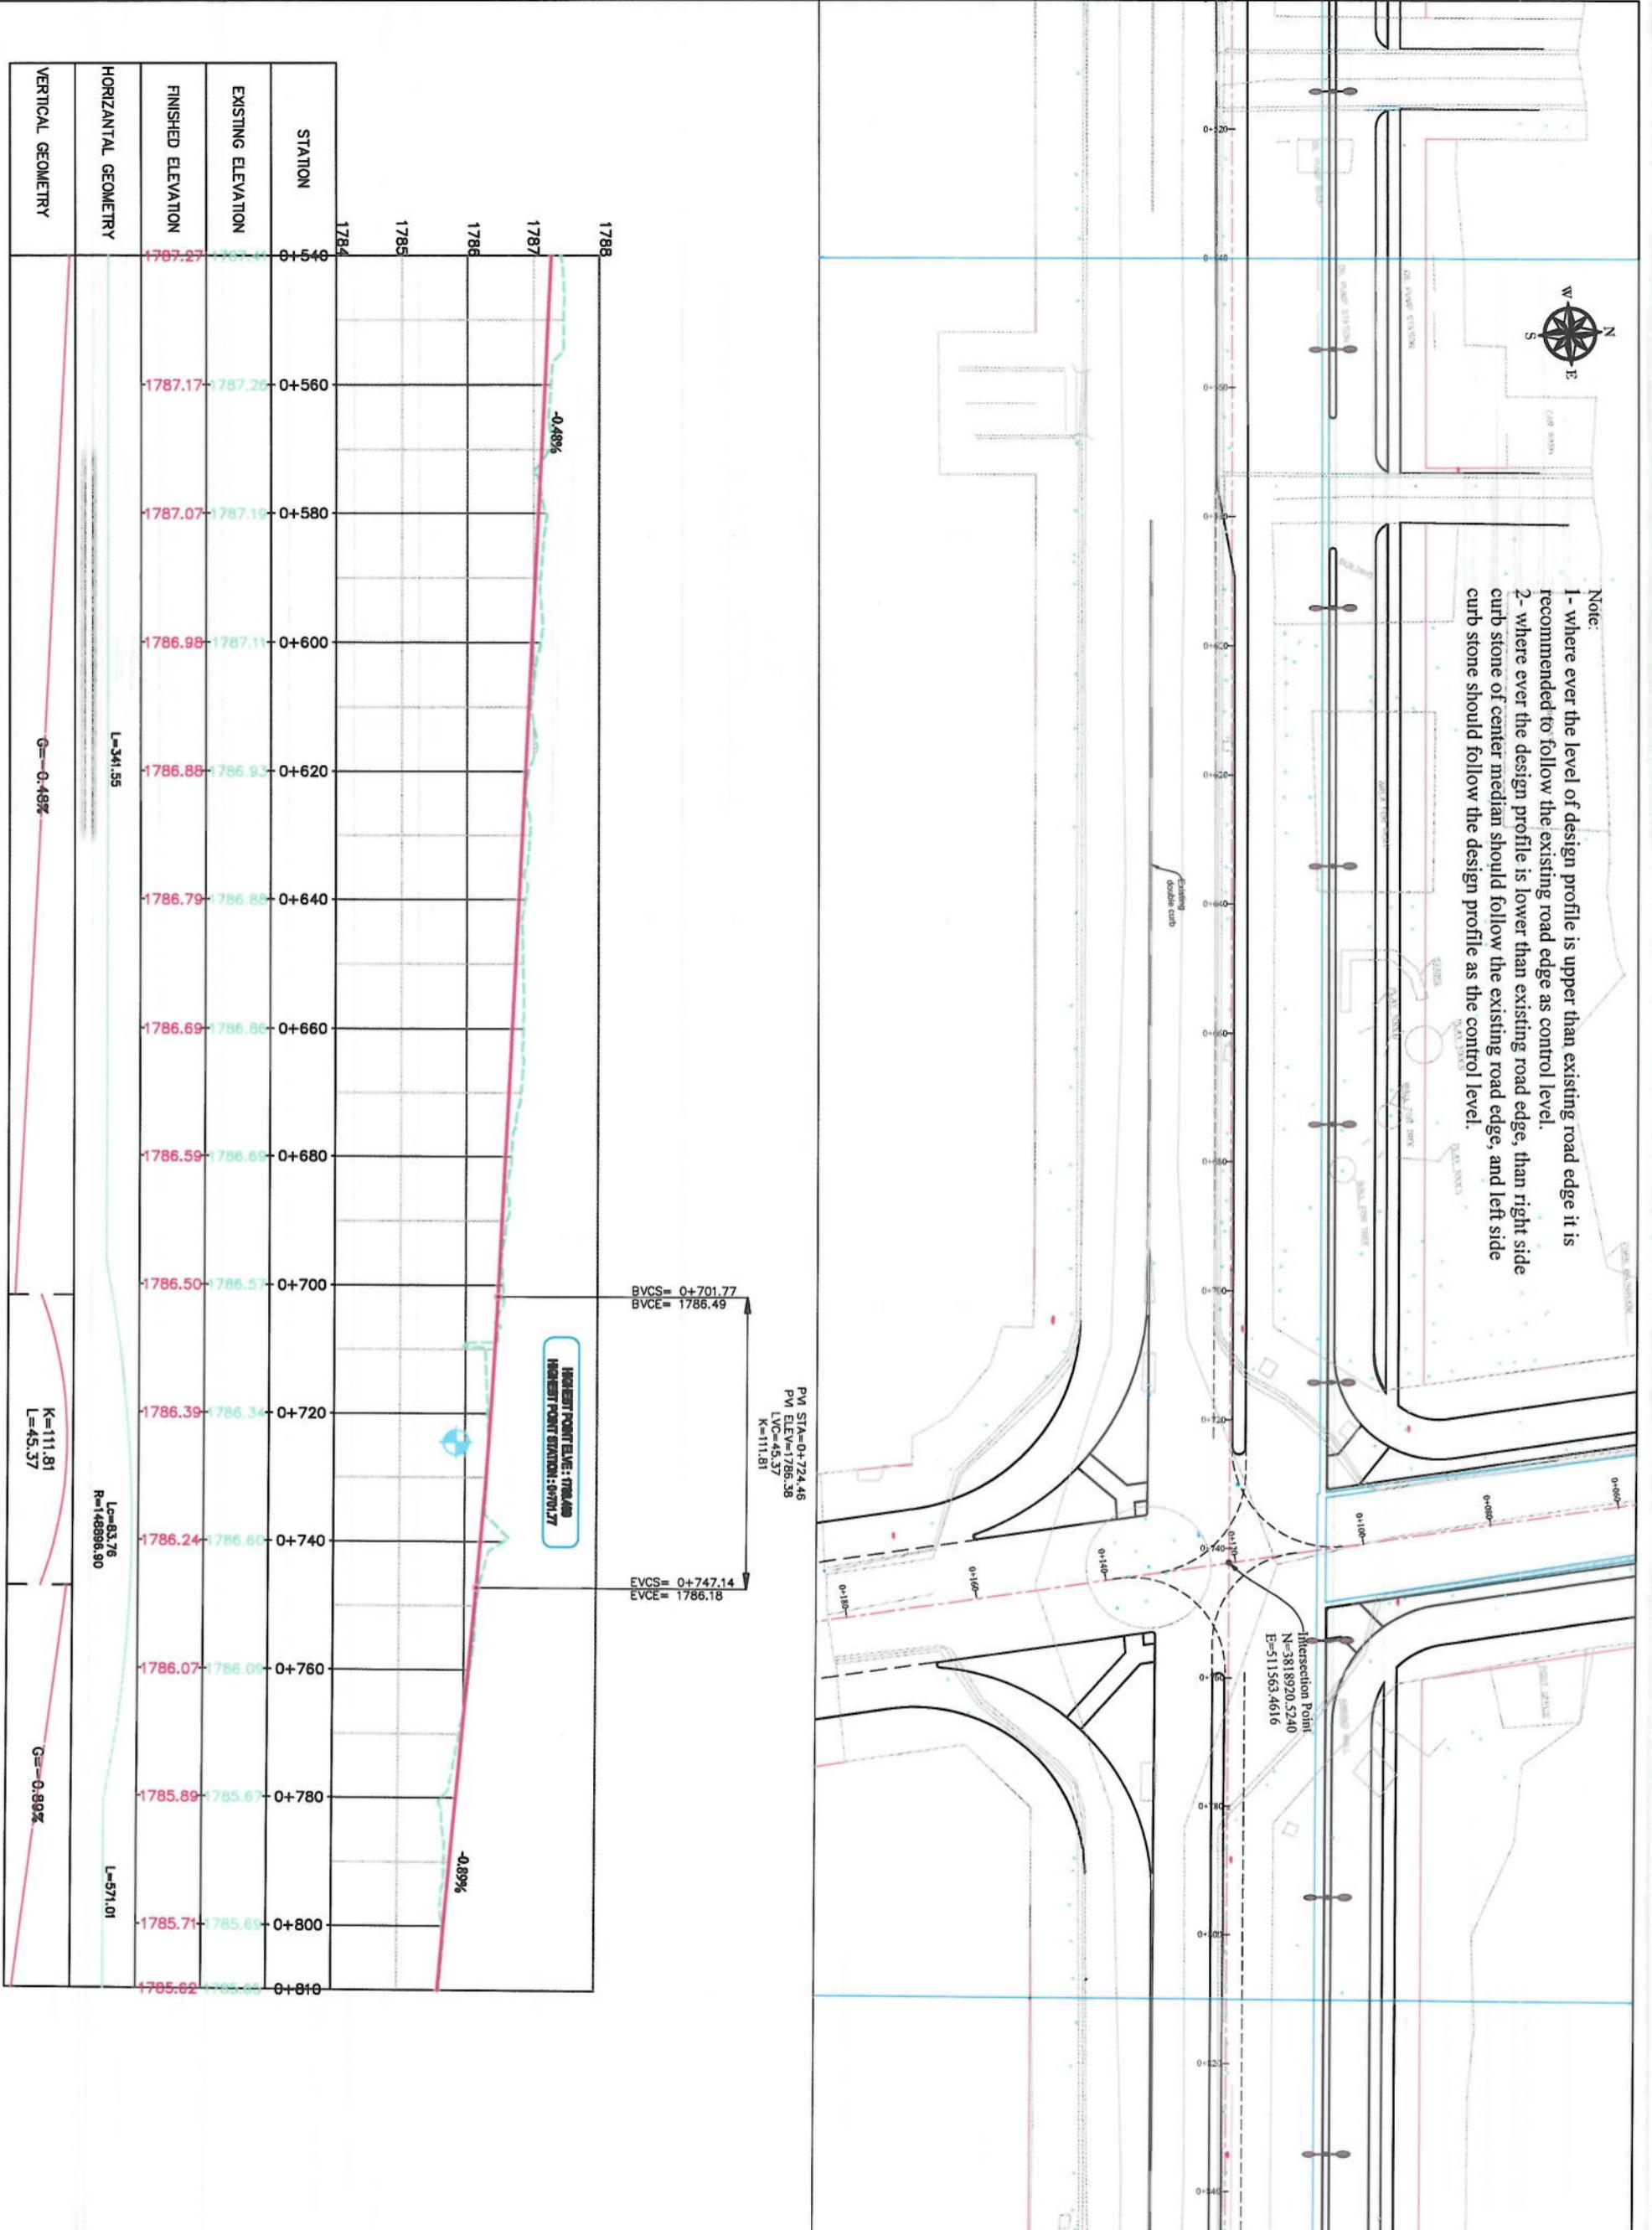

NOTE

- 1-The lengths of all new side ditches have shown on the plan.
  - 2-The finished level of new roads should be exhausted to the existing paved roads both in start and at its end property.
  - 3-In case of changing in typical cross section type all components should be adjusted properly.
  - 4-All Bed levels of new ditches should be adjusted to the existing others next levels to direct surface water property.
  - 5-Because of residential area on the site, the survey team was not allowed to enter the houses, therefore, the design has been based on the survey with less accuracy and it is necessary to re-survey the area after the demolition of houses.

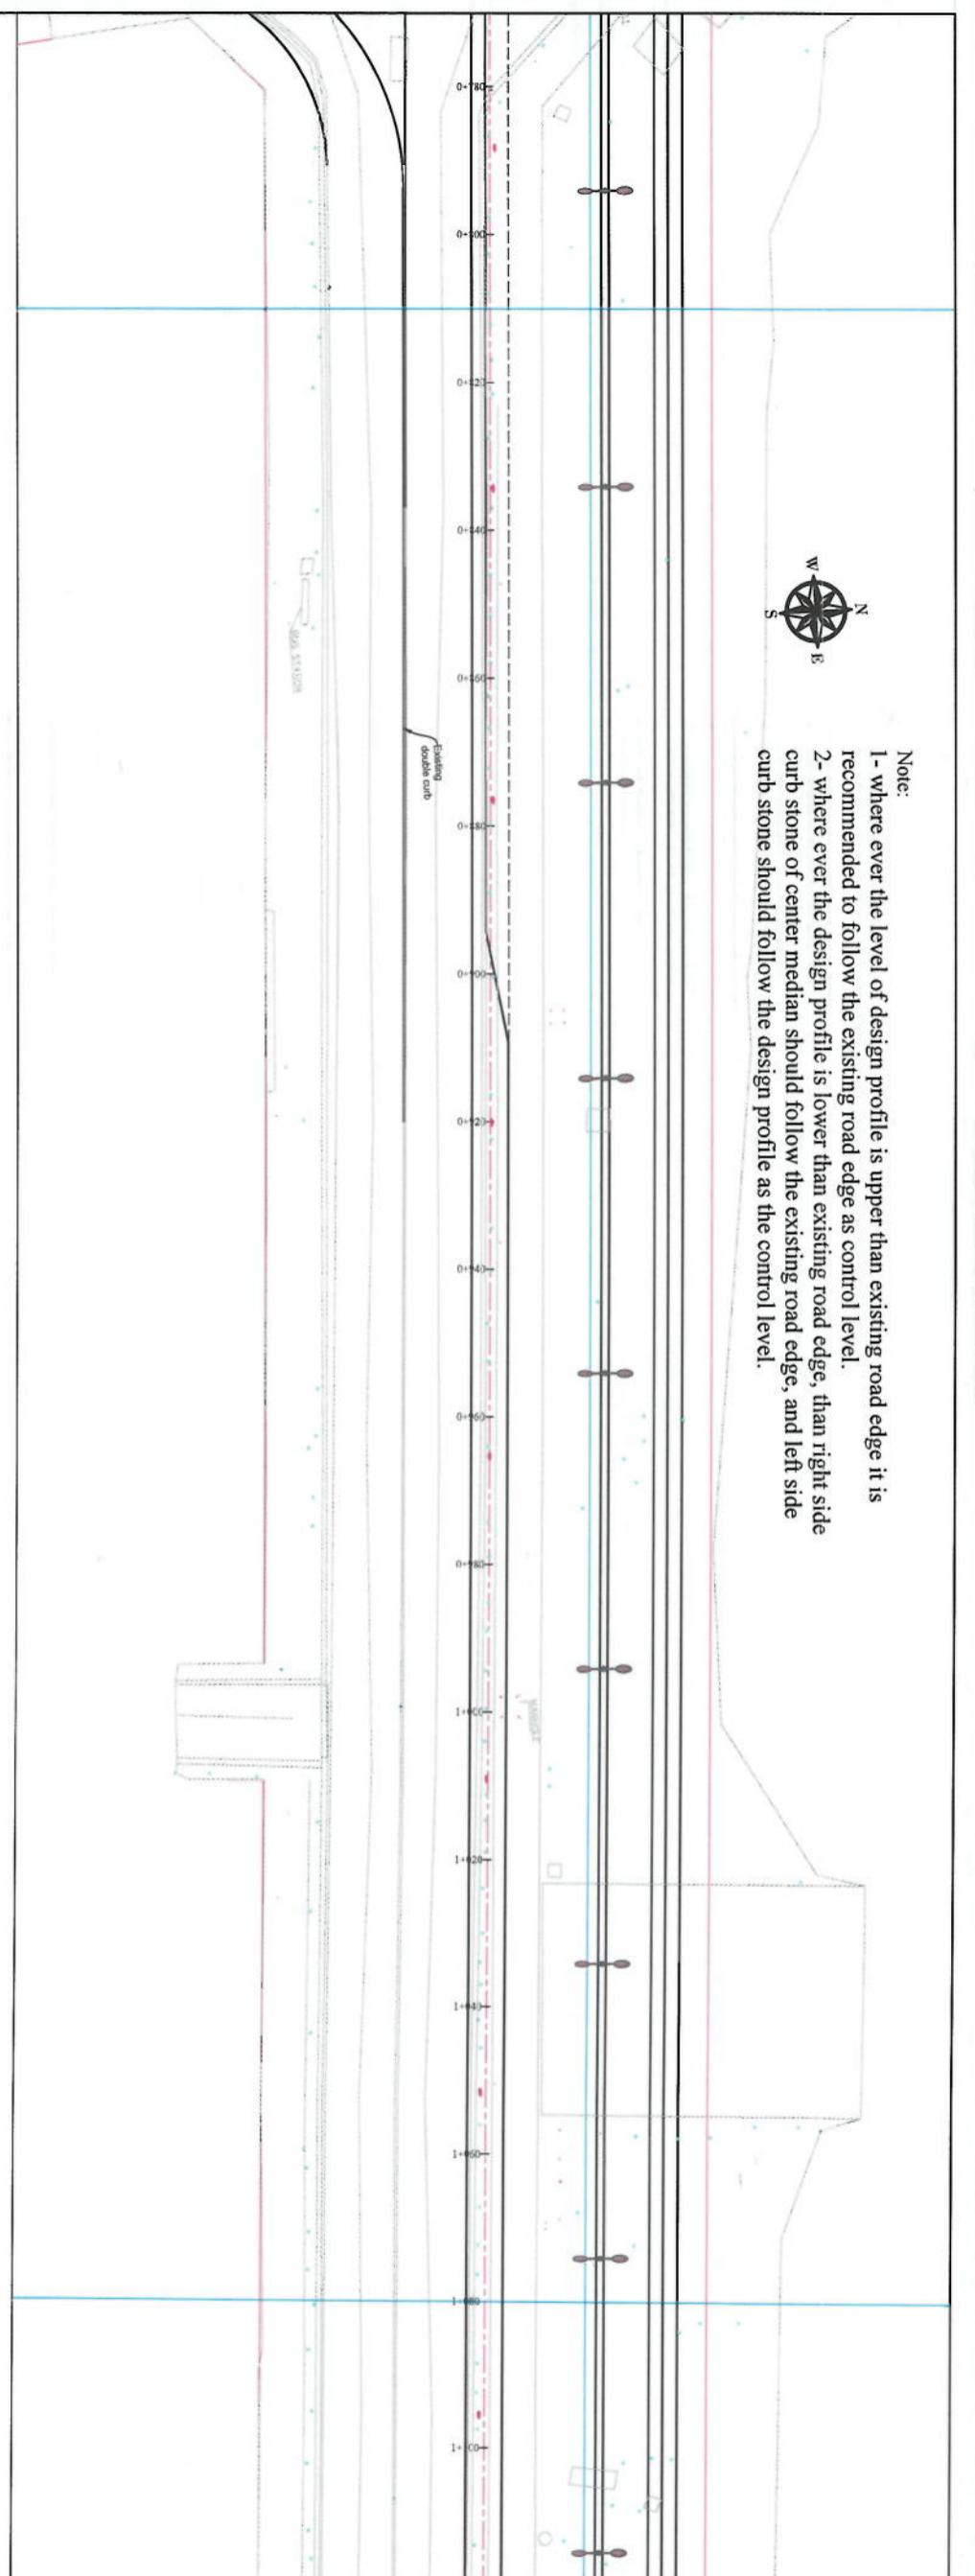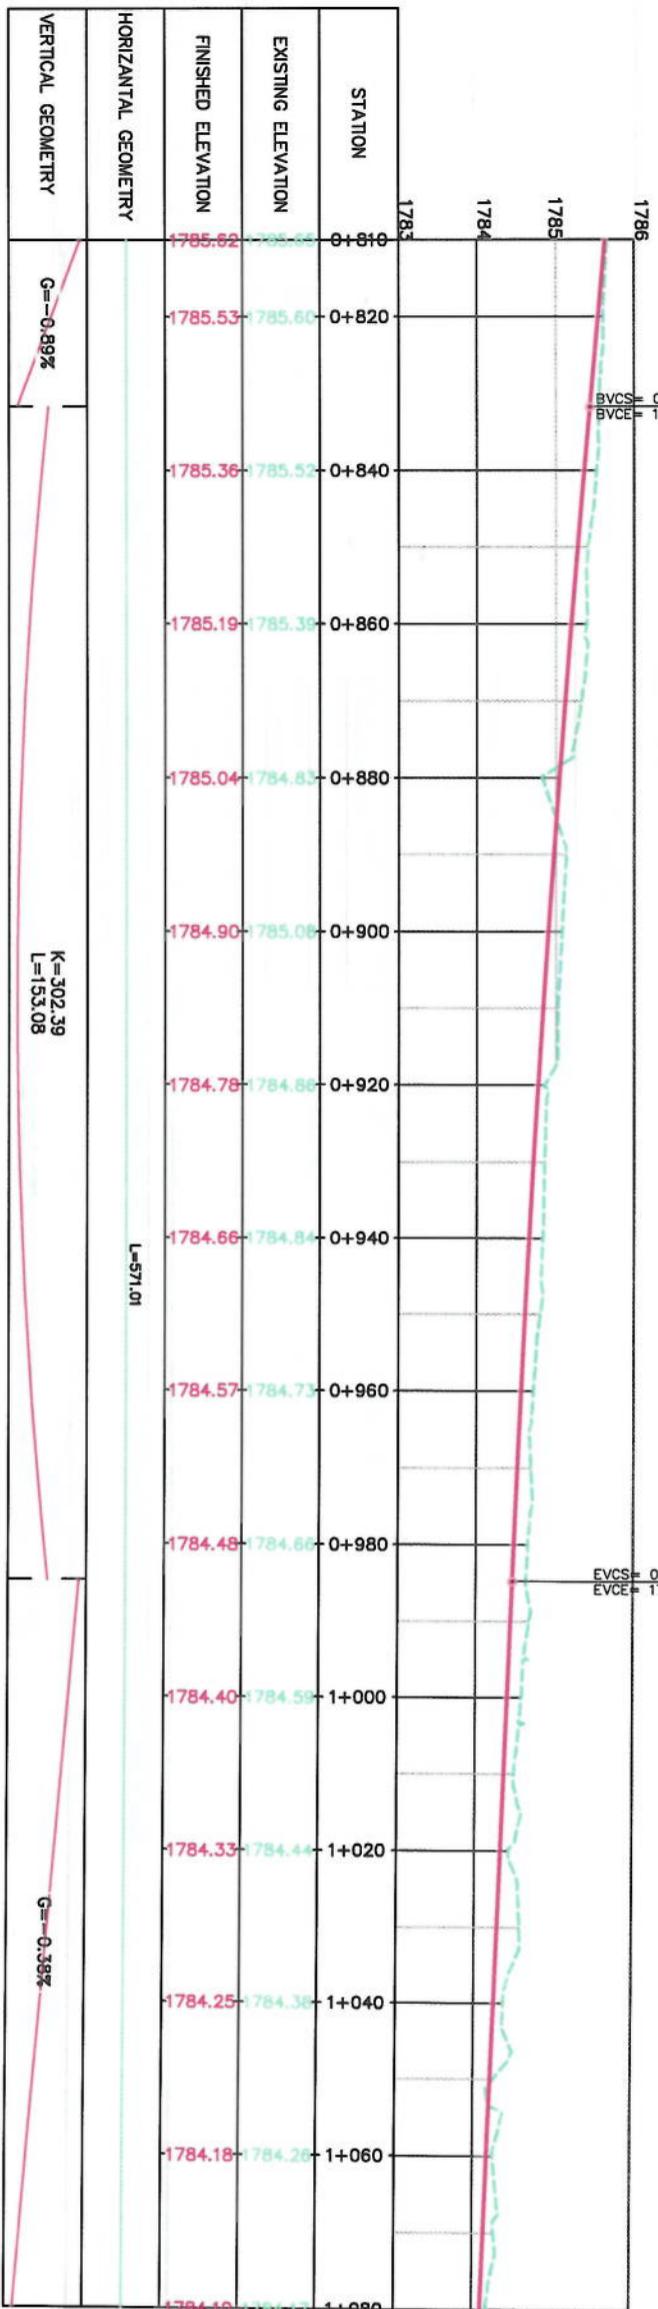

- Note:

  - 1- where ever the level of design profile is upper than existing road edge it is recommended to follow the existing road edge as control level.
  - 2- where ever the design profile is lower than existing road edge, than right side curb stone of center median should follow the existing road edge, and left side curb stone should follow the design profile as the control level.

NOTE


- 1-The lengths of all new side ditches have shown on file plan.
  - 2-The finished level of new roads should be adjusted to the existing paved roads both in start and at the end property.
  - 3-In case of changing in typical cross section type all components should be adjusted properly.
  - 4-All Bed levels of new ditches should be adjusted to the existing ditch bed levels to direct surface water properly.
  - 5-Because of residential area on the site, the survey team was not allowed to enter the houses, therefore, the design has been based on the survey with less accuracy and it is necessary to re-survey the area after the demolition of houses.



		KABUL MUNICIPALITY	
		Designed by:	KABUL MUNICIPALITY DESIGN TEAM
		Project Name:	Cot-e-Sang'i To Dehmanzang Road Project
		Drawing Title:	
<b>PLAN &amp; PROFILE</b>			
Designed by:	Signature:  Mohammad Eesa Sial		
Drawn by:	Signature:  Mohammad Eesa Sial		
Checked by:	Signature:  Hashbulah Shalizi		
Date:	Scale:		
6/10/2023	1:1000		
Status: FINAL DESIGN			
Drawing Number:		Revision:	PP-4
		00	



Note:  
 1- where ever the level of design profile is upper than existing road edge it is recommended to follow the existing road edge as control level.  
 2- where ever the design profile is lower than existing road edge, than right side curb stone of center median should follow the existing road edge, and left side curb stone should follow the design profile as the control level.

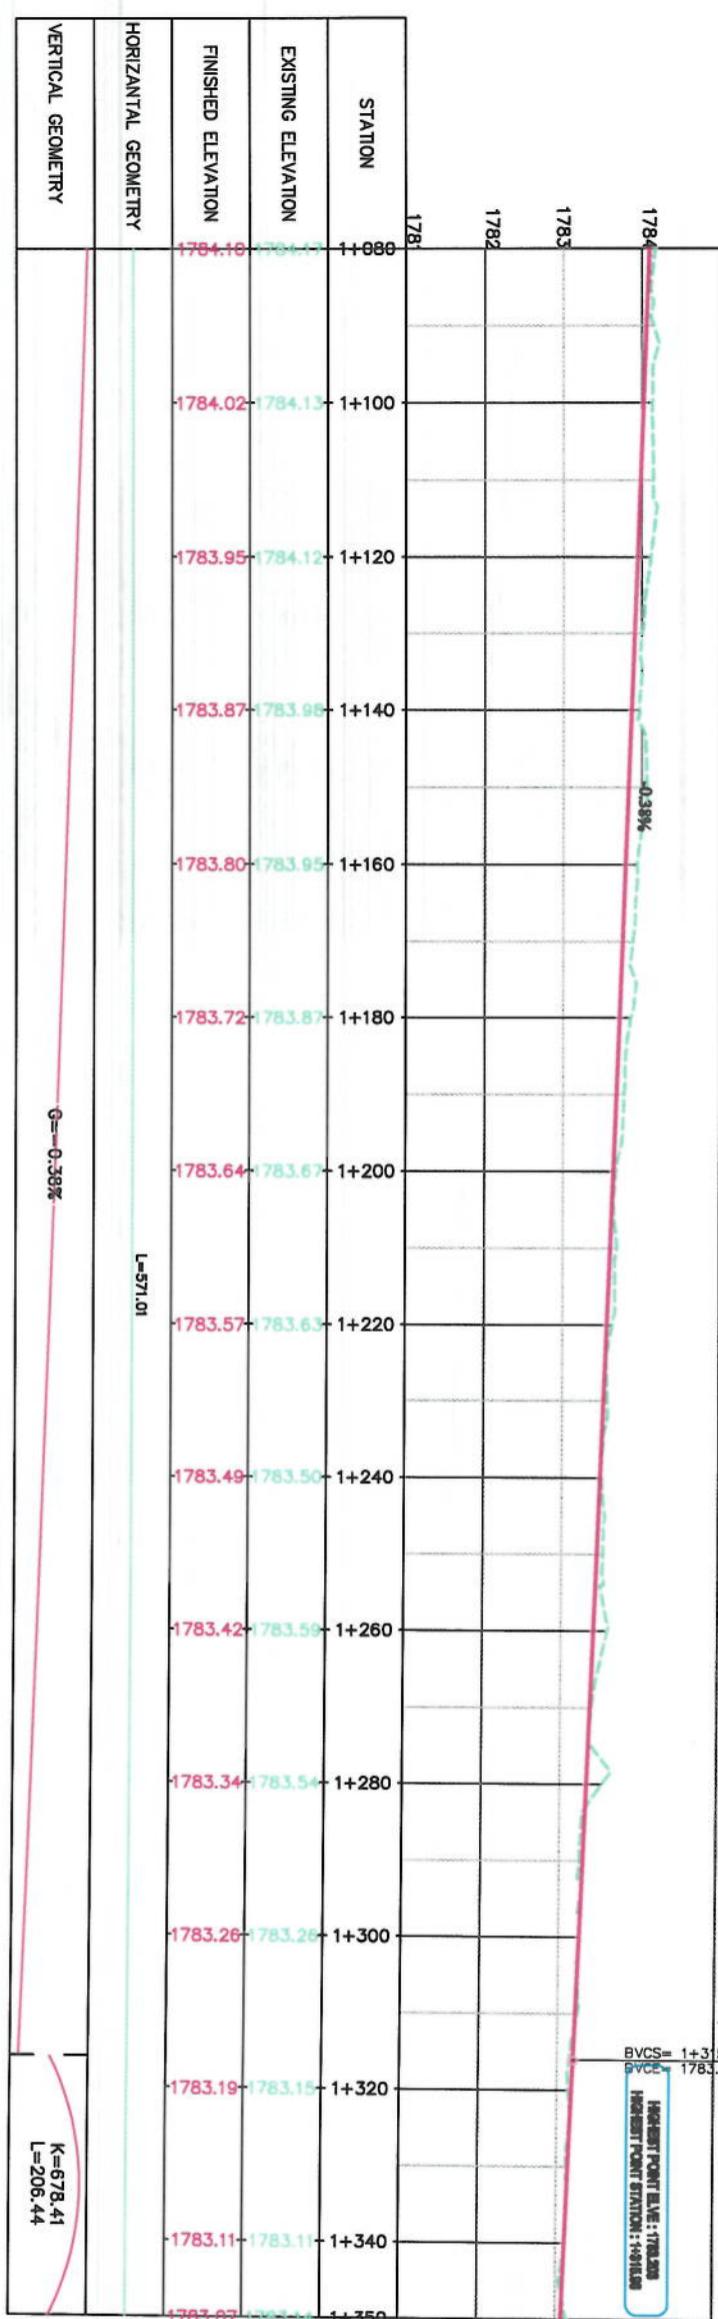



Note:

- 1- where ever the level of design profile is upper than existing road edge it is recommended to follow the existing road edge as control level.
- 2- where ever the design profile is lower than existing road edge, than right side curb stone of center median should follow the existing road edge, and left side curb stone should follow the design profile as the control level.


**NOTE:**

- 1- The lengths of all new side ditches have shown on the plan.
- 2- The finished level of new roads should be adjusted to the existing paved roads both at start and at the end of the property.
- 3- In case of changing in typical cross section type all components should be adjusted properly.
- 4- All Bed levels of new ditches should be adjusted to the existing ditches and levels to reflect surface with property.
- 5- Because of residential area on the site, the survey was not allowed to enter the houses; therefore, the design was done based on the survey with less accuracy and it is necessary to re-survey the area after the demolition of houses.




**LEGENDS**

- CENTER-LINE
- - - EXISTING SURFACE
- EXISTING SIDE DITCH

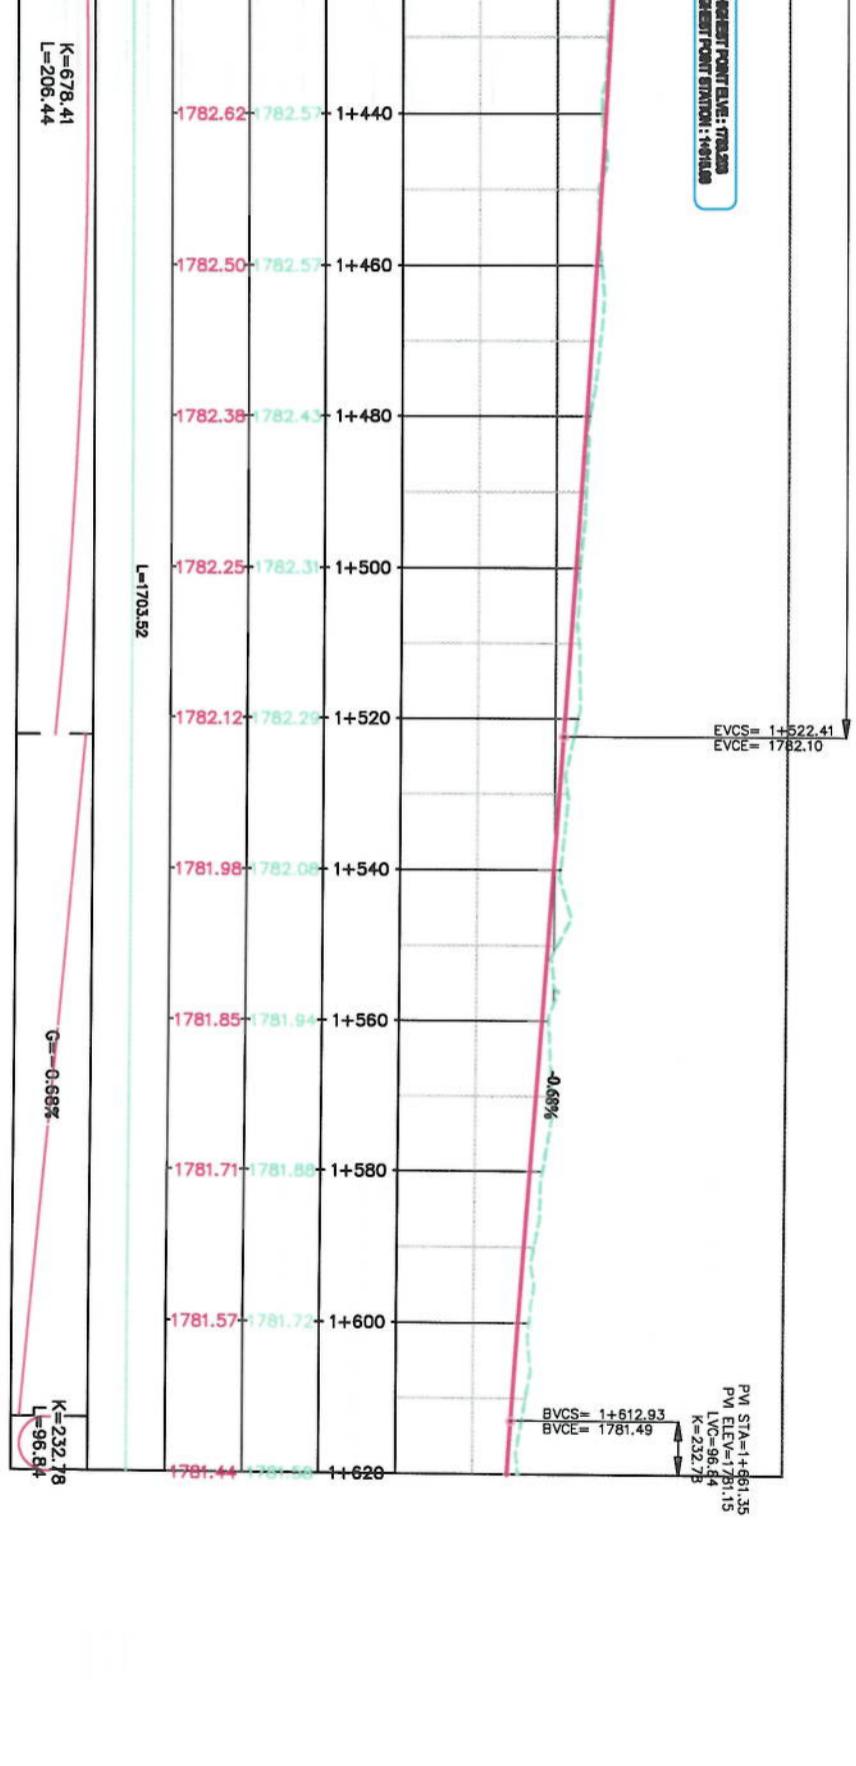


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K=678.41	L=206.44
G=-0.68%	

<b>VERTICAL GEOMETRY</b>	K=232.78 L=96.44
<b>PLAN &amp; PROFILE</b>	
Designed by: Mohammad Eesa Sini	Signature:
Drawn by: Mohammad Eesa Sini	Signature:
Checked by: Hasbullah Shultz	Signature:
Date: 6/10/2023	Scale: 1:1000
Status: FINAL DESIGN	
Project Code:	
Drawing Number: PP-6	Revision: 00

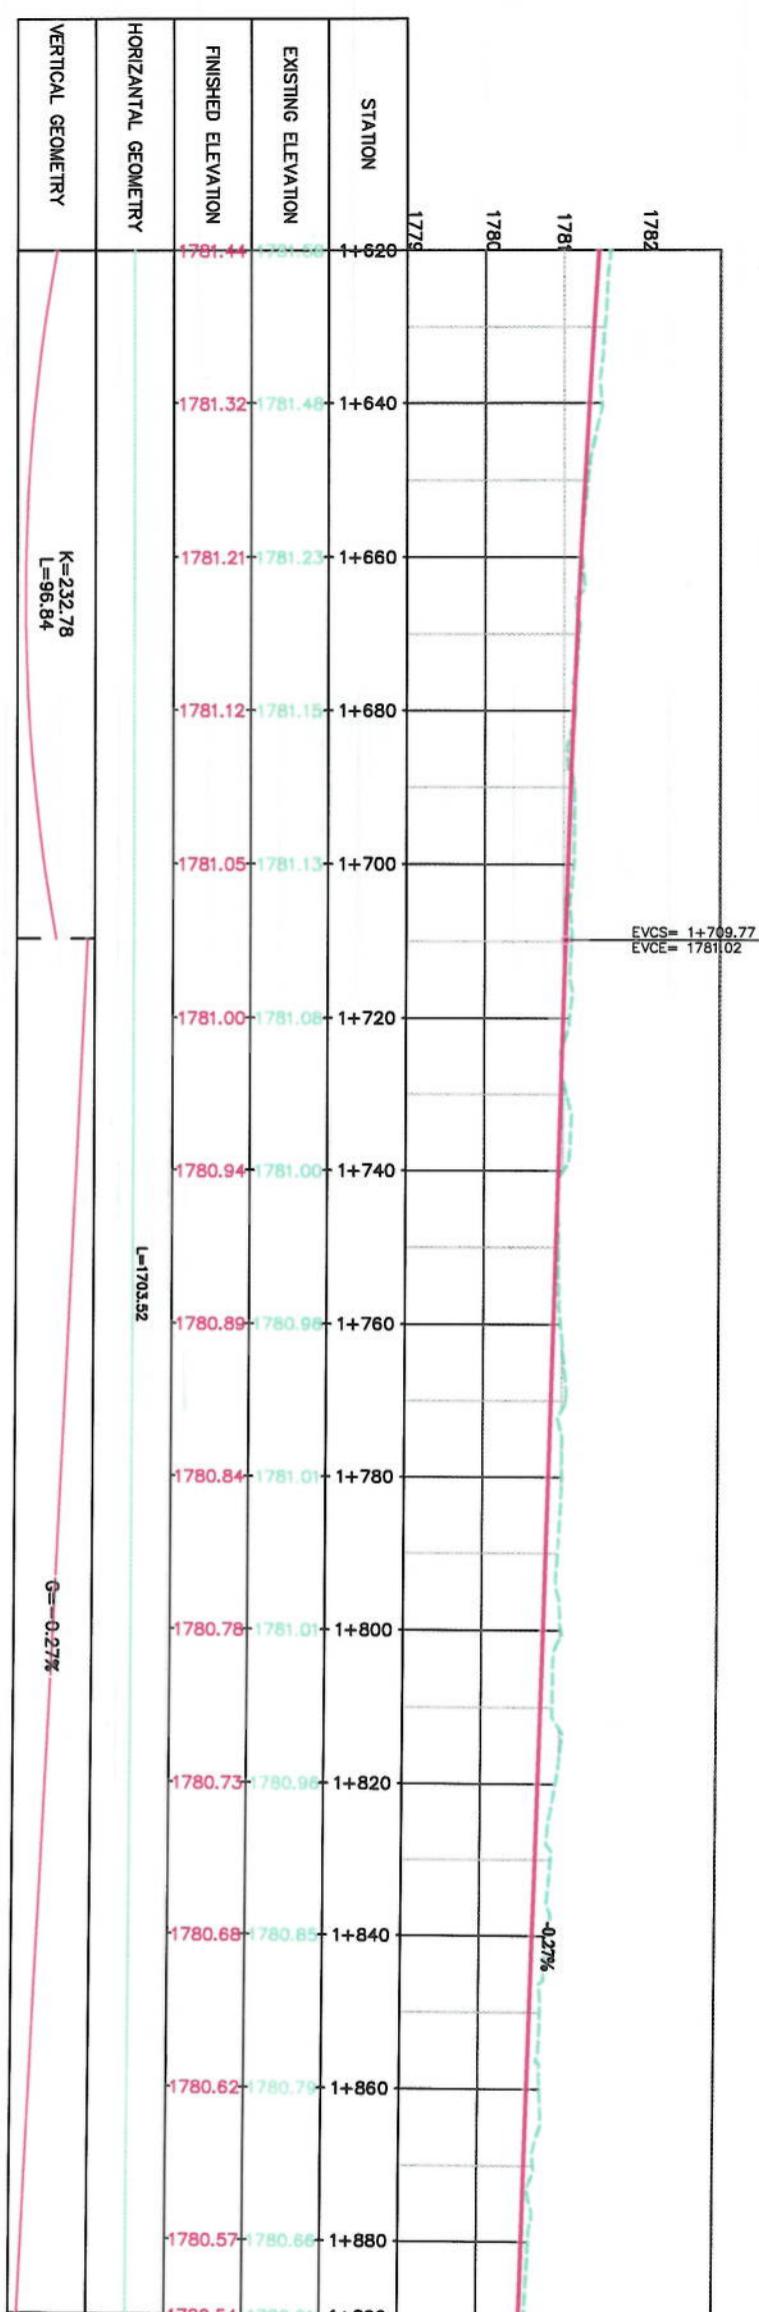



**Note:**

- 1- where ever the level of design profile is upper than existing road edge it is recommended to follow the existing road edge as control level.
- 2- where ever the design profile is lower than existing road edge, than right sidele curb stone of center median should follow the existing road edge, and left side curb stone should follow the design profile.

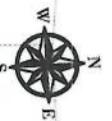

NOT LET TO SURVEY THIS AREA

NOT LET TO SURVEY THIS AREA

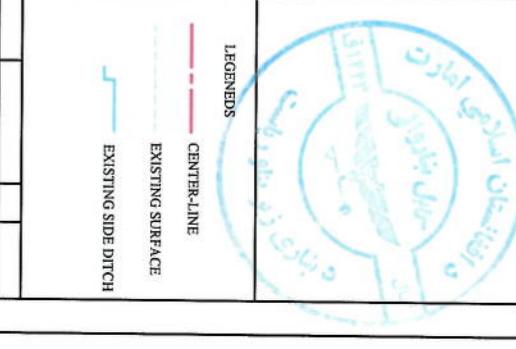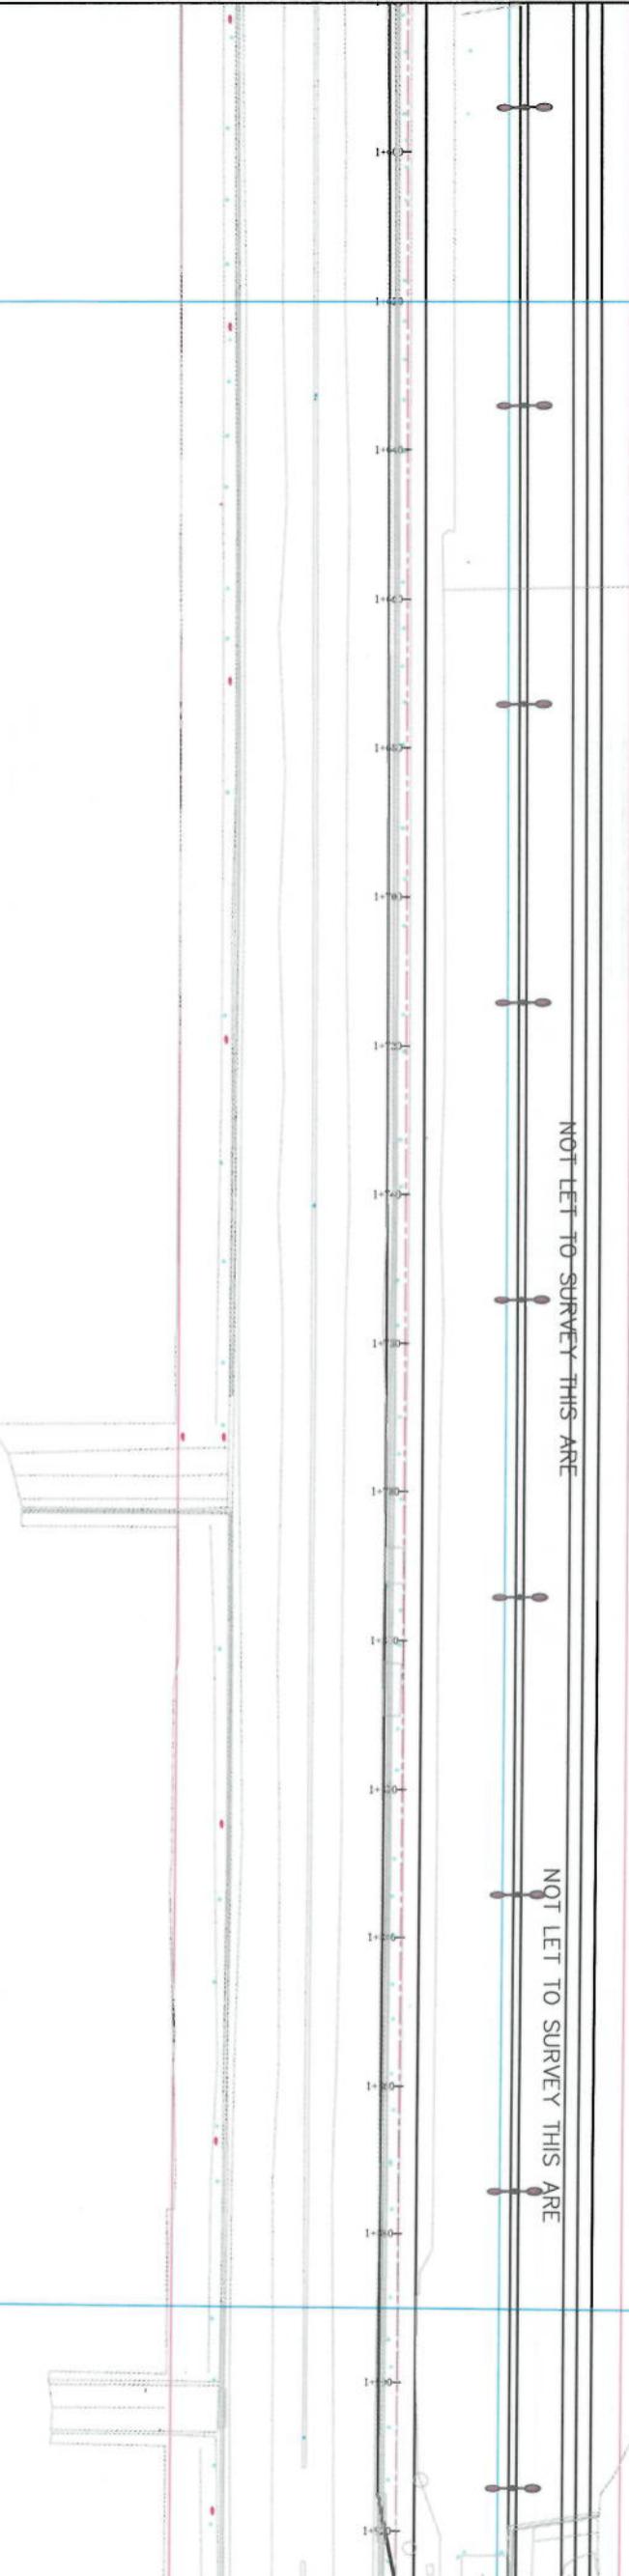

Date	Revision Details	Drawn

PLAN & PROFIL

AFGHANISTAN

KABUL MUNICIPALITY

11

KABUL MUNICIPAL  
DESIGN TEAM

1

Drawing 111c

104

Pl

104

Designed by  
*Mohammed Ew*

Drawn by:

Mohammad Es

Checked by:

www.oxfordjournals.org

1

1

Date:

6/10/2023

Status:


Project Code

2. The finished level of new roads should be adjusted to the existing paved roads both at start and at the end property.

3. In case of changing in typical cross section type all components should be adjusted properly.

4- All BfL levels of new ditches should be adjusted to the existing ditches bed levels to direct surface water properly.

5. Because of residential area on the site, the survey team was not allowed to enter the houses, therefore the design has been based on the survey with less accuracy and it is necessary to re-survey this area after the demolition of houses.

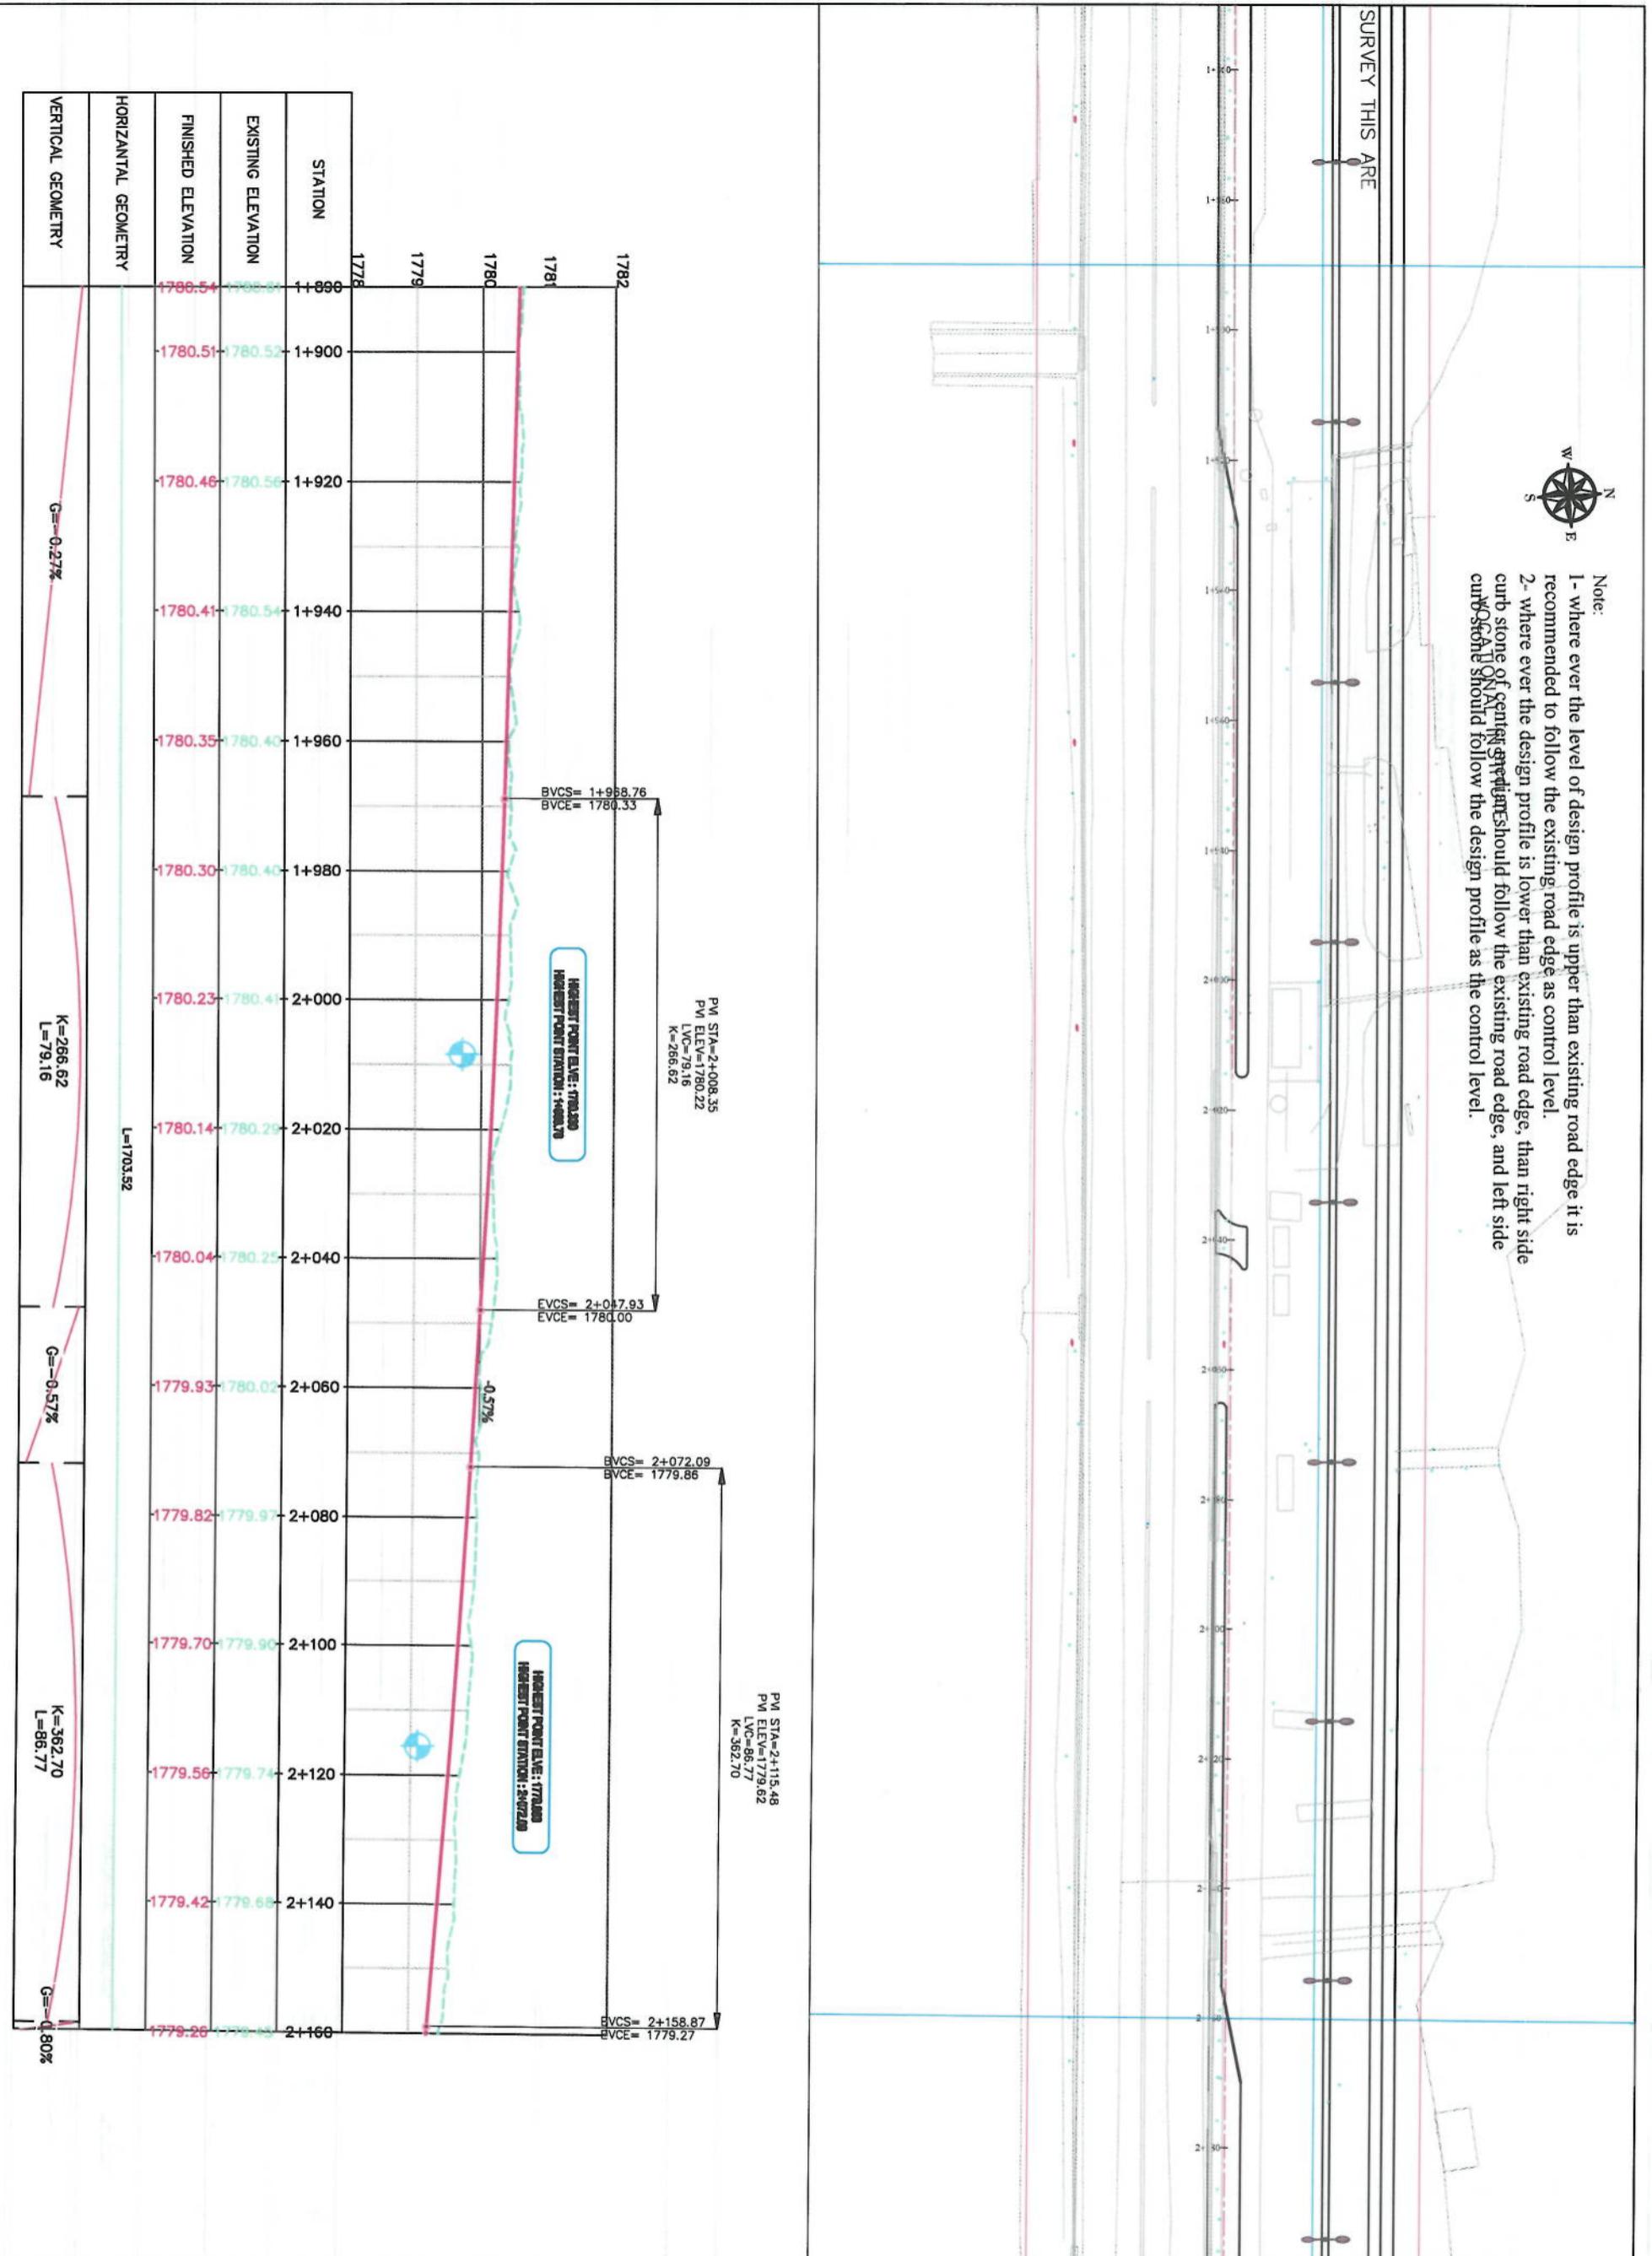

NOTE

- SURVEY THIS ARE**

Note:

  - 1- where ever the level of design profile is upper than existing road edge it is recommended to follow the existing road edge as control level.
  - 2- where ever the design profile is lower than existing road edge, than right side curb stone of central shoulder should follow the existing road edge, and left side curb stone should follow the design profile as the control level.

Note:  
1- where ever the level of design profile is upper than existing road edge it is recommended to follow the existing road edge as control level.  
2- where ever the design profile is lower than existing road edge, than right side curb stone of ~~central~~<sup>median</sup>should follow the existing road edge, and left side


**NOTE.**

- 1.-The lengths of all new side ditches have shown on the plan.

NOTE:	
<p>1- The lengths of all new side ditches have shown on the plan.</p> <p>2- The finished level of new roads should be adjusted to the existing paved roads both at start and at the end property.</p> <p>3- In case of changing in typical cross section type all components should be adjusted properly.</p> <p>4- All Bed levels of new ditches should be adjusted to the existing ditches bed levels to direct surface water properly.</p> <p>5- Because of residential areas on the site, the survey team was not allowed to enter the houses; therefore, the design has done based on the survey with less accuracy and is necessary to re-survey the area after the demolition of houses.</p>	
<b>LEGENDS</b>	
CENTER-LINE	
EXISTING SURFACE	
EXISTING SIDE DITCH	
Date	Revision Details
	Draught
<b>ISLAMIC EMIRATE OF AFGHANISTAN</b>	
<b>KABUL MUNICIPALITY</b>	
<b>KABUL MUNICIPALITY DESIGN TEAM</b>	
<b>Cot-e-Sangi To Detmangz Road Project</b>	
<b>Drawing Title:</b>	
<b>PLAN &amp; PROFILE</b>	
<b>Designed by:</b> Mohammad Eissa Sial Signature:	
<b>Drawn by:</b> Mohammad Eissa Sial Signature:	
<b>Checked by:</b> Hashbulah Shafizi Signature:	
Date:	Scale:
6/10/2023	1:1000
<b>Status:</b> <b>FINAL DESIGN</b>	
<b>Project Code:</b>	
Drawing Number	PP-8
Revision	00



Note:  
 1- where ever the level of design profile is upper than existing road edge it is recommended to follow the existing road edge as control level.  
 2- where ever the design profile is lower than existing road edge, than right side curb stone of center median should follow the existing road edge, and left side curb stone should follow the design profile as the control level.

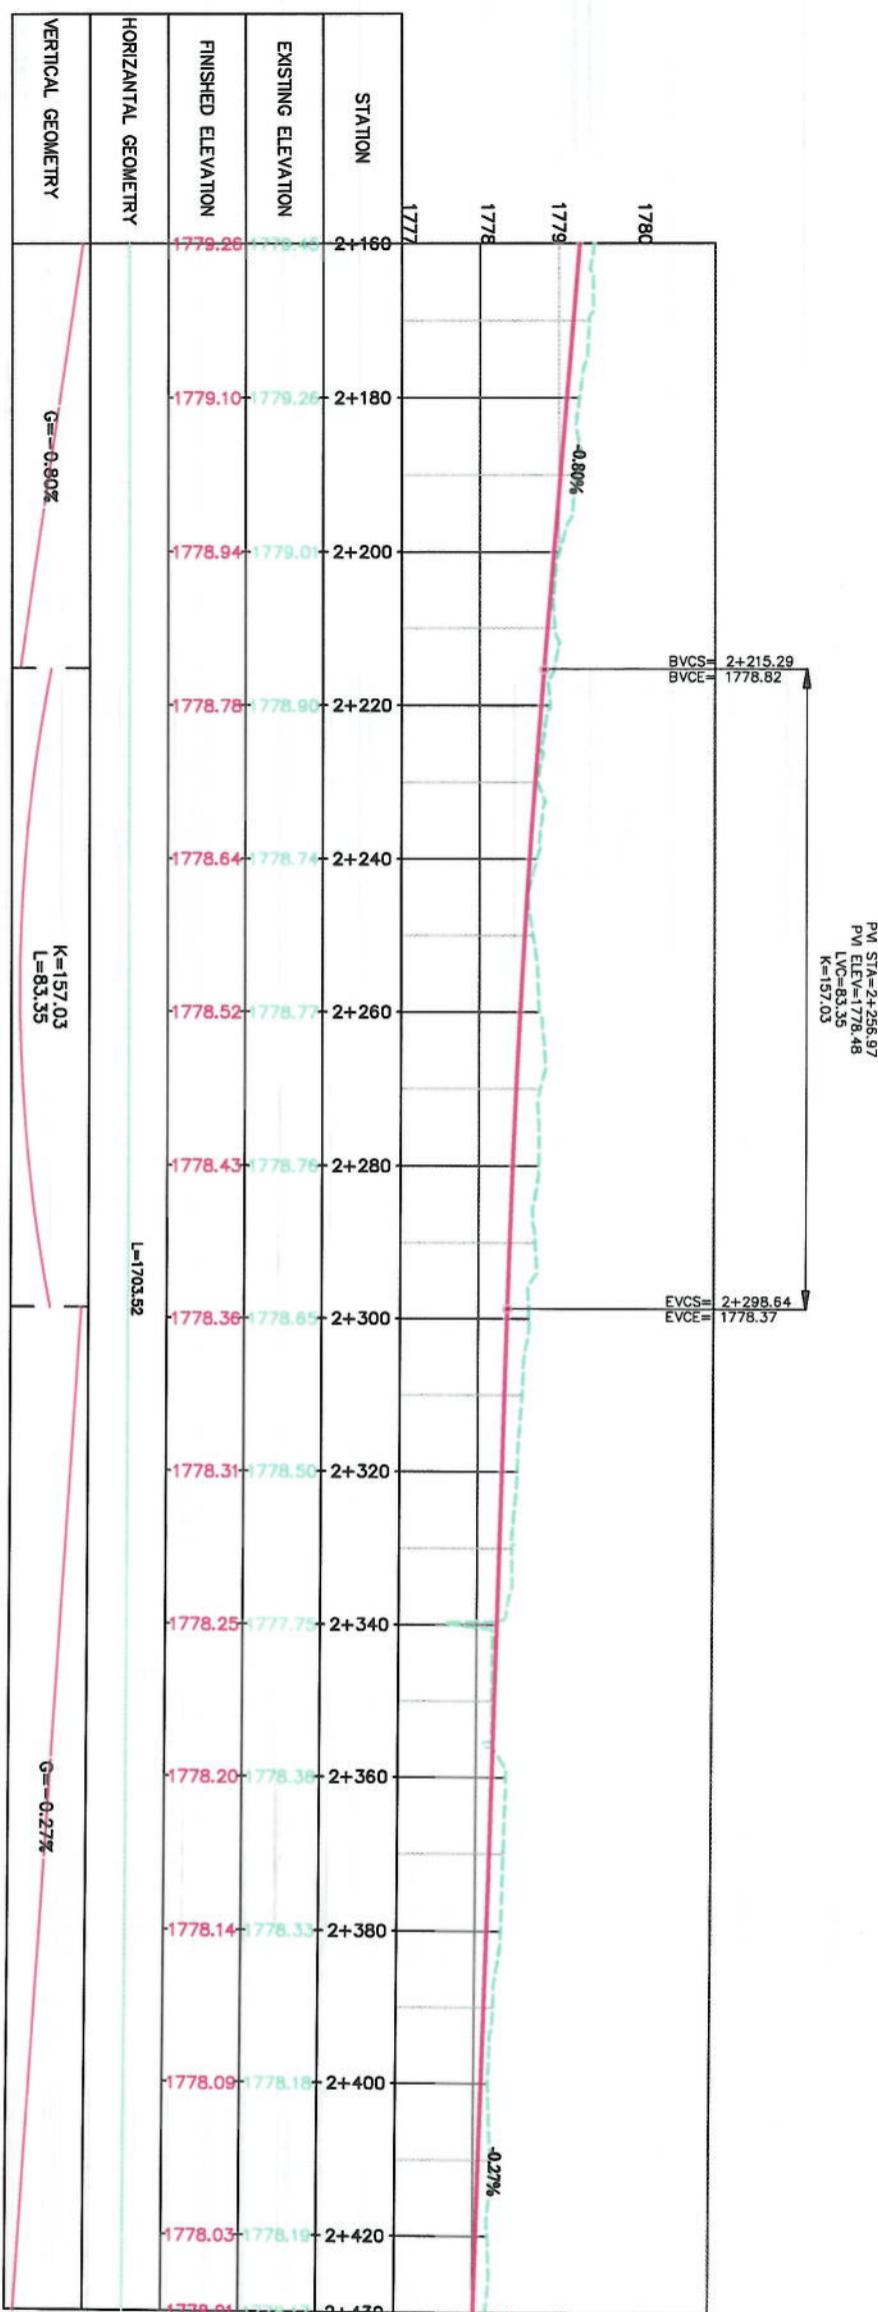



PLAN & PROFILE		
Designed by:	Signature:	
Mohammed Issa Sarai		
Drawn by:	Signature:	
Mohammed Issa Sarai		
Checked by:	Signature:	
Habibullah Shahzai		
Date:	Scale:	
6/10/2023	1:1000	
Status:	FINAL DESIGN	
Project Code:		
Drawing Number:	PP-9	Revision 00



NOTE:  
 1- The lengths of all new side ditches have shown on the plan.  
 2- The finished level of new roads should be adjusted to the existing paved roads both at start and at the end properly.  
 3- In case of changing in typical cross section type all components should be adjusted properly.  
 4- All Bed levels of new ditches should be adjusted to the existing ditches bed levels to direct surface water properly.  
 5- Because of residential areas on the site, the survey team was not allowed to enter the houses, therefore the design has done based on the survey with best accuracy and it is necessary to resurvey the area after the demolition of houses.



Note:  
 1- where ever the level of design profile is upper than existing road edge it is recommended to follow the existing road edge as control level.  
 2- where ever the design profile is lower than existing road edge, than right side curb stone of center median should follow the design profile as the control level.

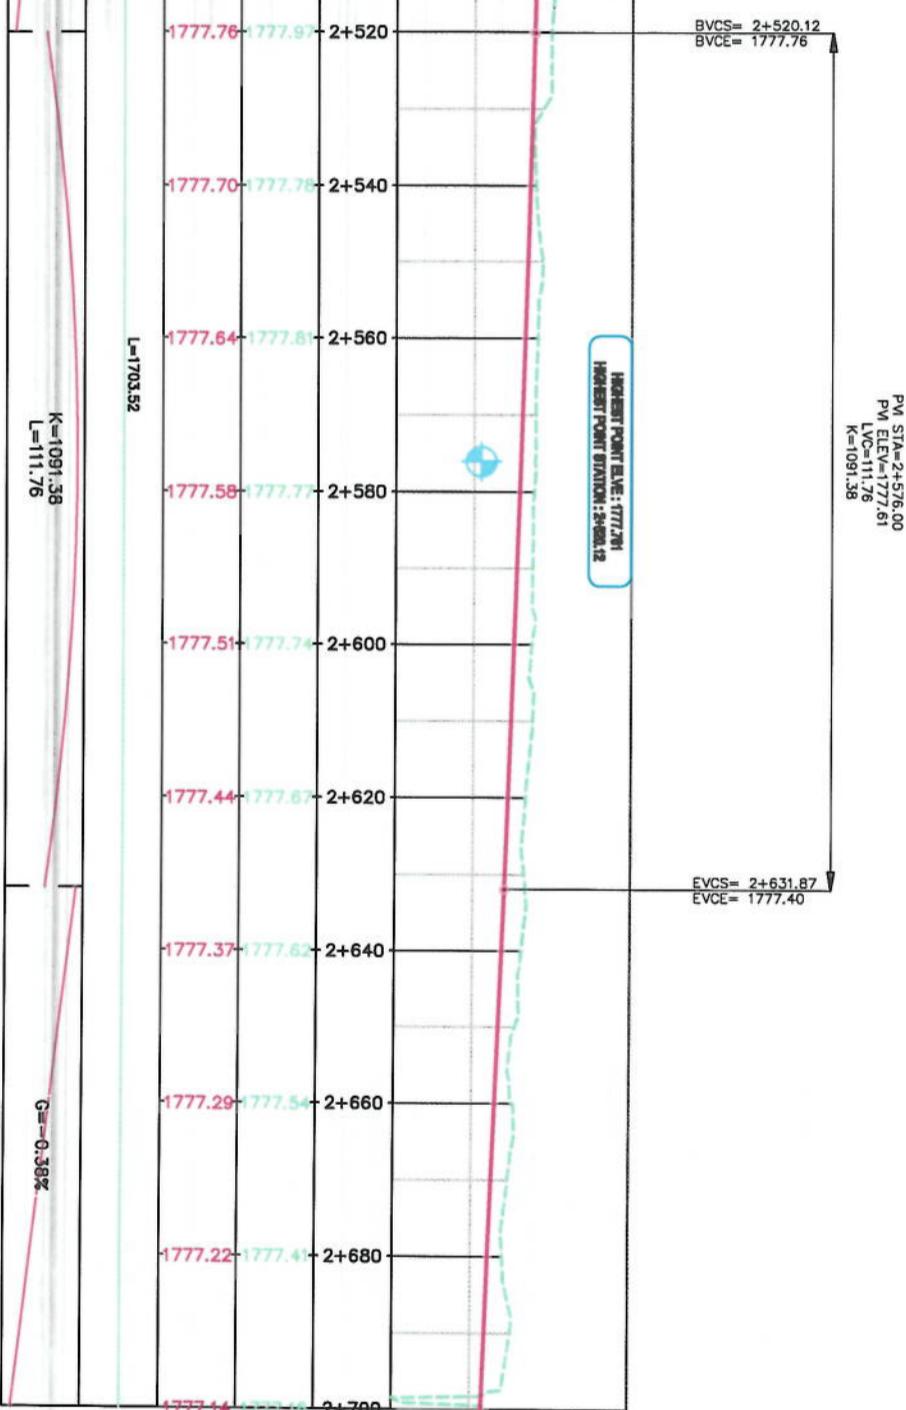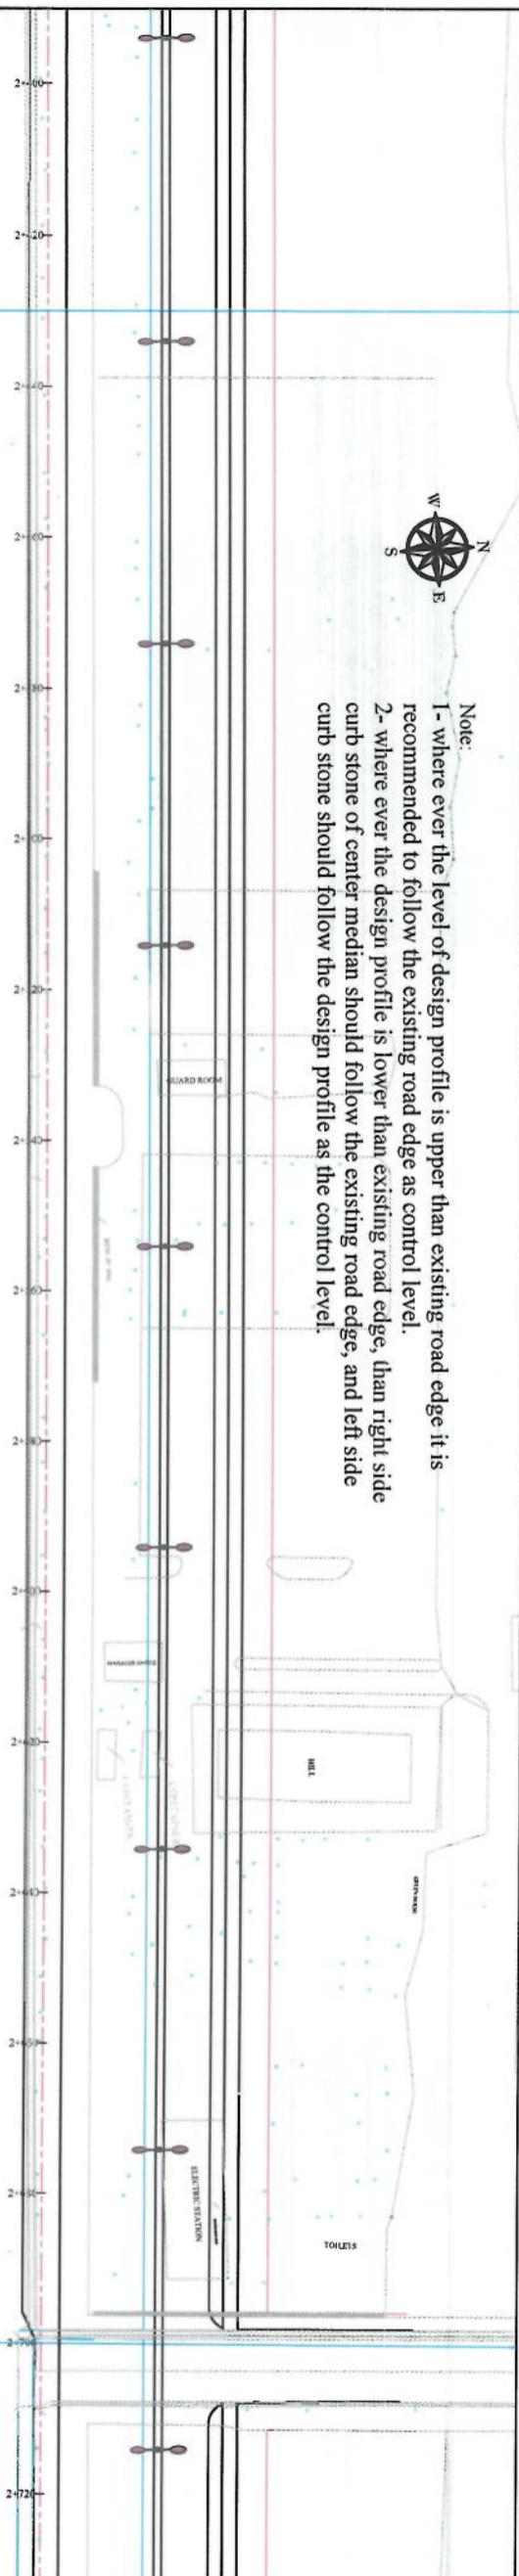

KABUL MUNICIPALITY  
DESIGN TEAM

ISLAMIC EMIRATE OF  
AFGHANISTAN

Client:

KABUL MUNICIPALITY

Designed by:

Mohammad Easa Sial

Drawn by:

Mohammad Easa Sial

Checked by:

Hassanullah Shahzai

Signature:




Signature



Note:

- where ever the level of design profile is upper than existing road edge it is recommended to follow the ~~existing road edge~~ as control level.
- where ever the design profile is lower than ~~existing road edge~~, the right side curb stone of center median should follow the existing road edge, and left side curb stone should follow the design profile as the control level.

NOTE:  
 1. The lengths of all new side ditches have shown on the plan.  
 2. The finished level of new roads should be adjusted to the existing paved roads both at start and at the end property.  
 3. In case of changing in typical cross section types all components should be adjusted properly.  
 4. All Bed levels of new ditches should be adjusted to the existing ditches bed levels to detect surface water property.  
 5. Because of residential area on the site, the survey team was not allowed to enter the houses; therefore, the design has done based on the survey with less accuracy and it is necessary to re-survey this area after the demolition of houses.

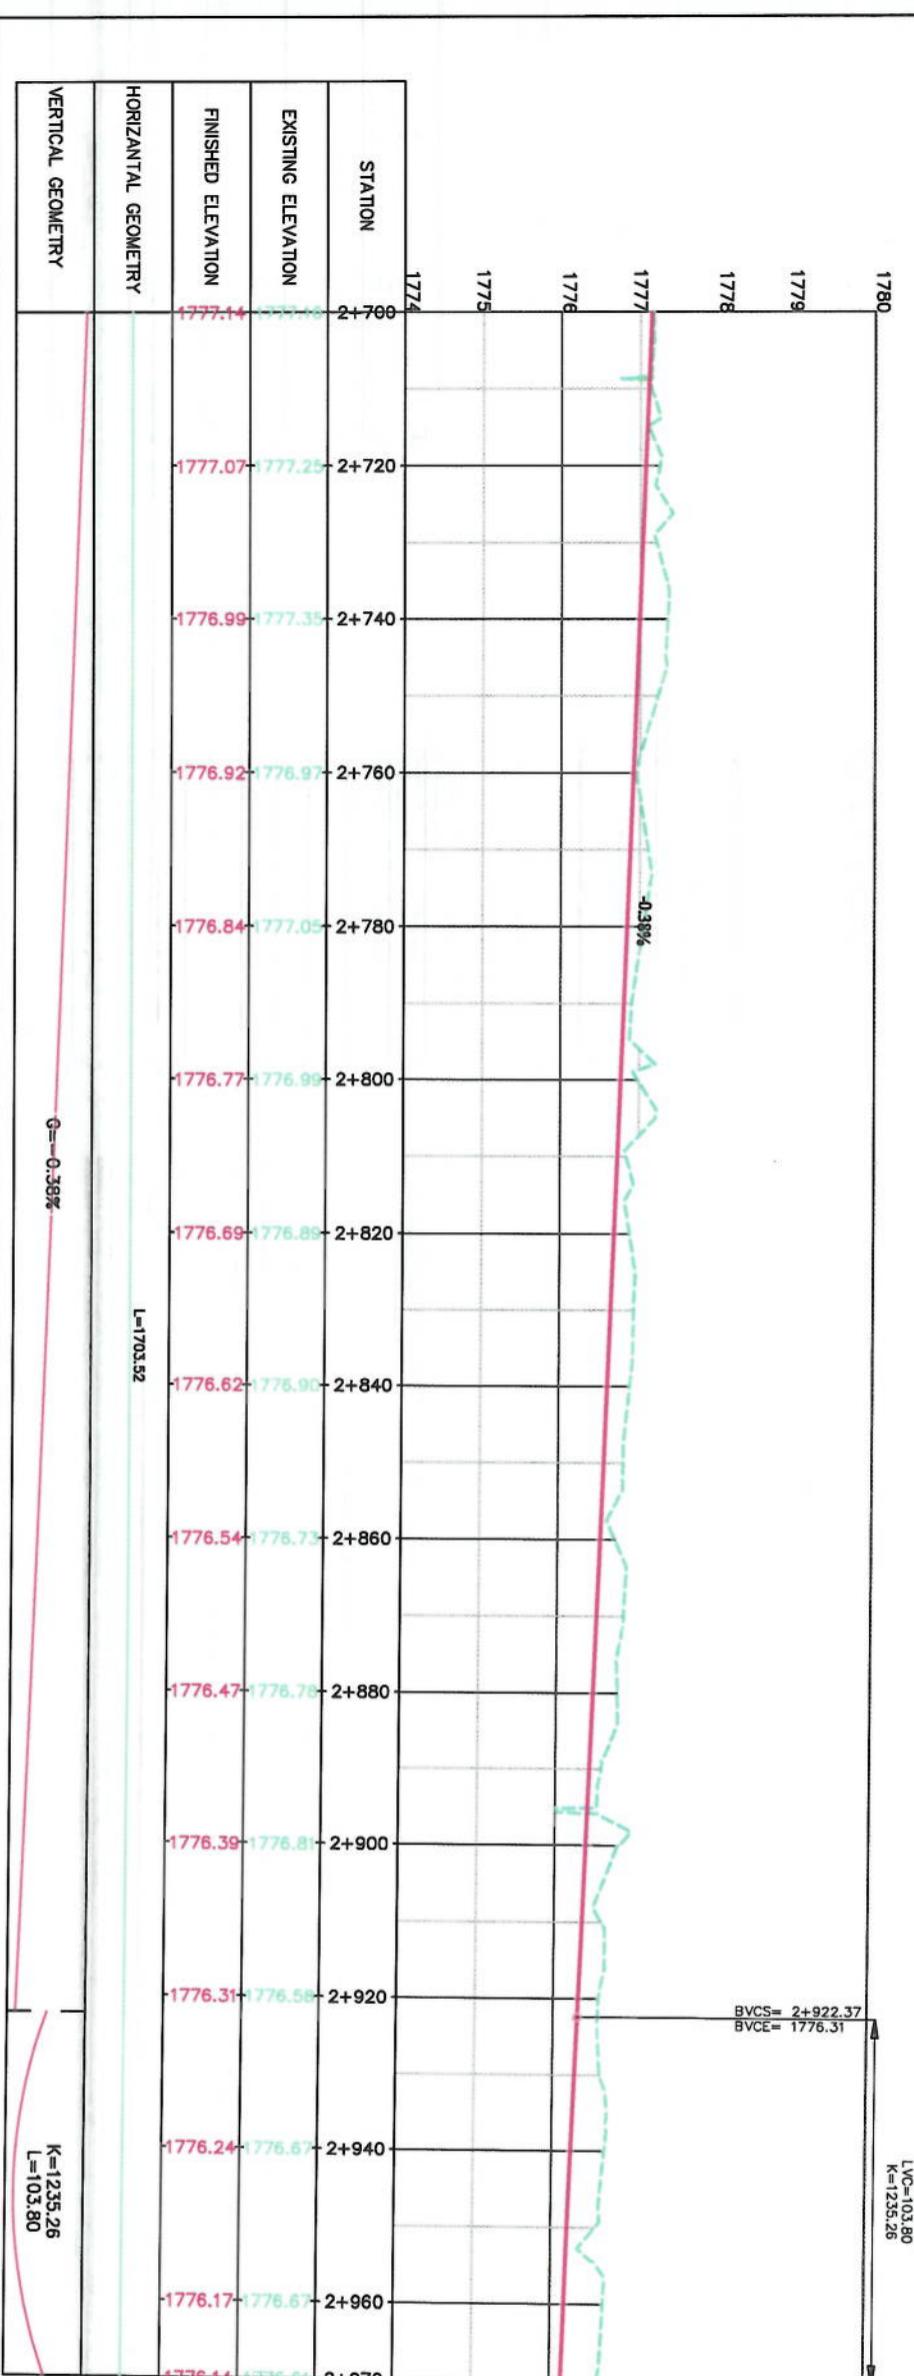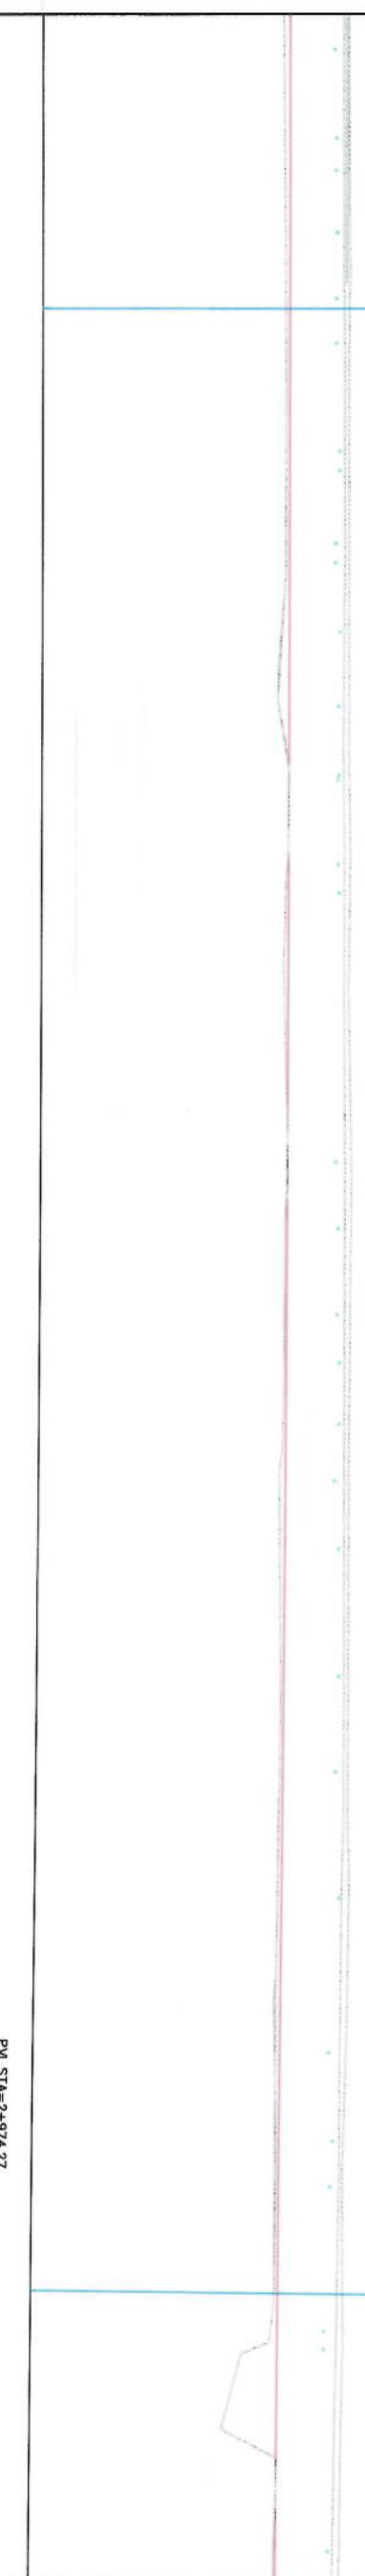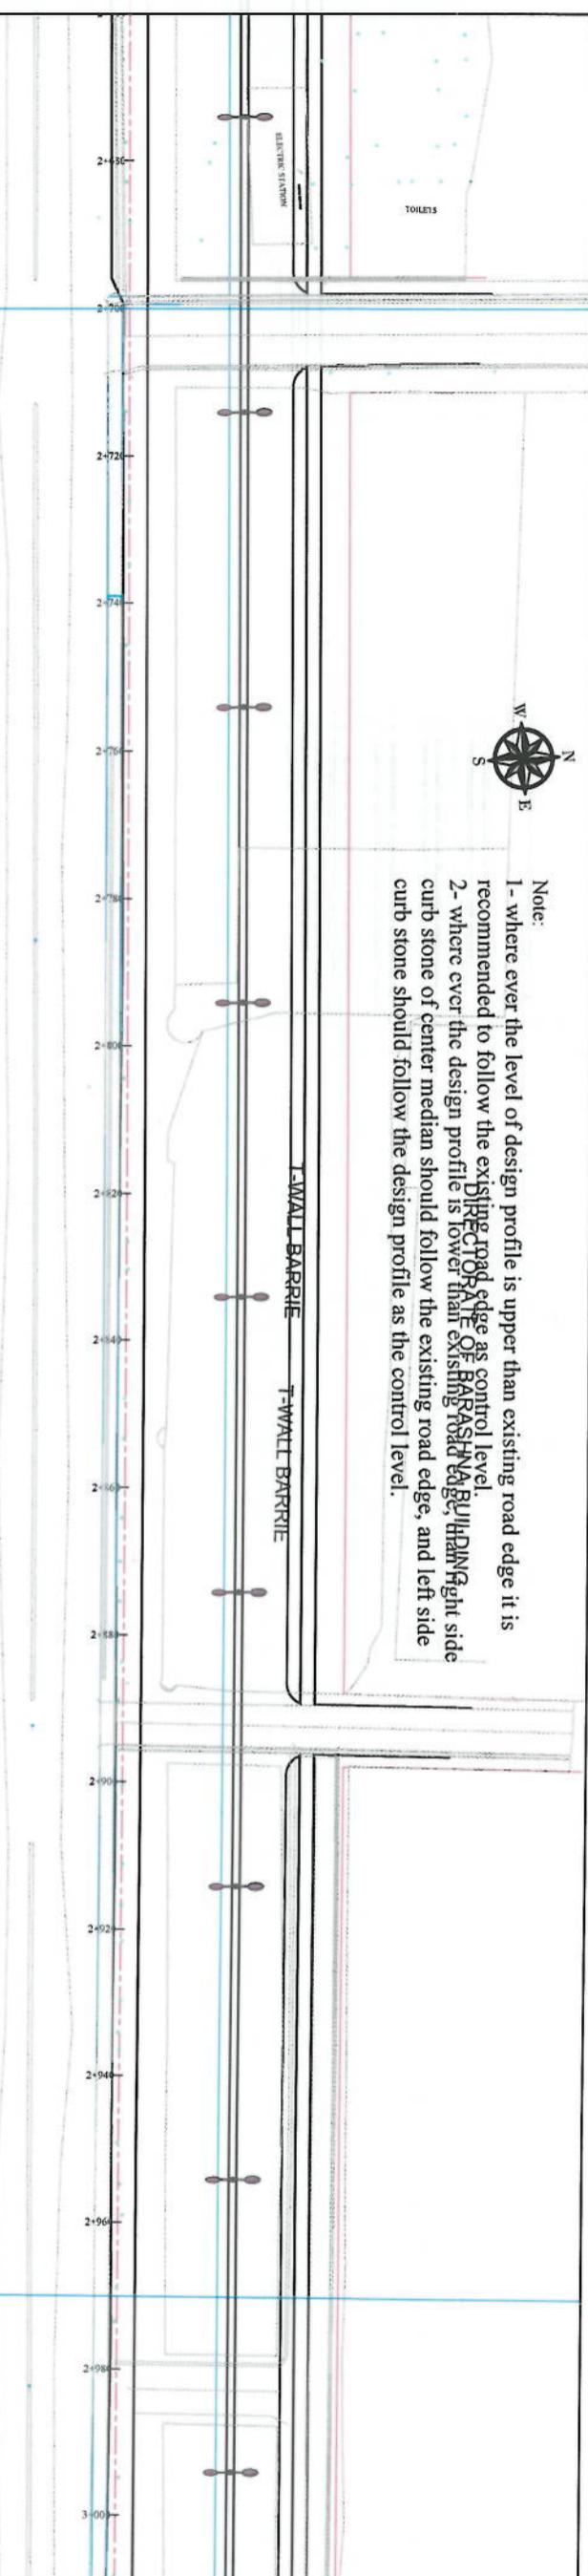


PLANE & PROFILE
Designed by: Mohammad Fisa Sial <i>[Signature]</i>
Drawn by: Mohammad Fisa Sial <i>[Signature]</i>
Checked by: Hashullah Shahzai <i>[Signature]</i>
Project Name: Cole-Sangi To Delamang Road Project
Drawing Title:
FINAL DESIGN
Date: 6/10/2023 Scale: 1:1000
Status: FINAL DESIGN
Project Code:
Drawing Number: PP-11 Revision: 00




Note:  
 1- where ever the level of design profile is upper than existing road edge it is recommended to follow the existing road edge as control level.  
 2- where ever the design profile is lower than existing road edge, than right side curb stone of center median should follow the existing road edge, and left side curb stone should follow the design profile as the control level.

### DIRECTORATE OF TRAFFIC

NOTE:  
 1- The lengths of all new side ditches have shown on the plan.  
 2- The finished level of new roads should be adjusted to the existing paved roads both at start and at the end property.  
 3- In case of changing in typical cross section type all components should be adjusted properly.  
 4- All Bed levels of new ditches should be adjusted to the existing ditches bed level to direct surface water properly.  
 5- Because of residential area on the site, the survey team was not allowed to enter the houses. Therefore, the design has done based on the survey with less accuracy and it is necessary to re-survey the area after the demolition of houses.

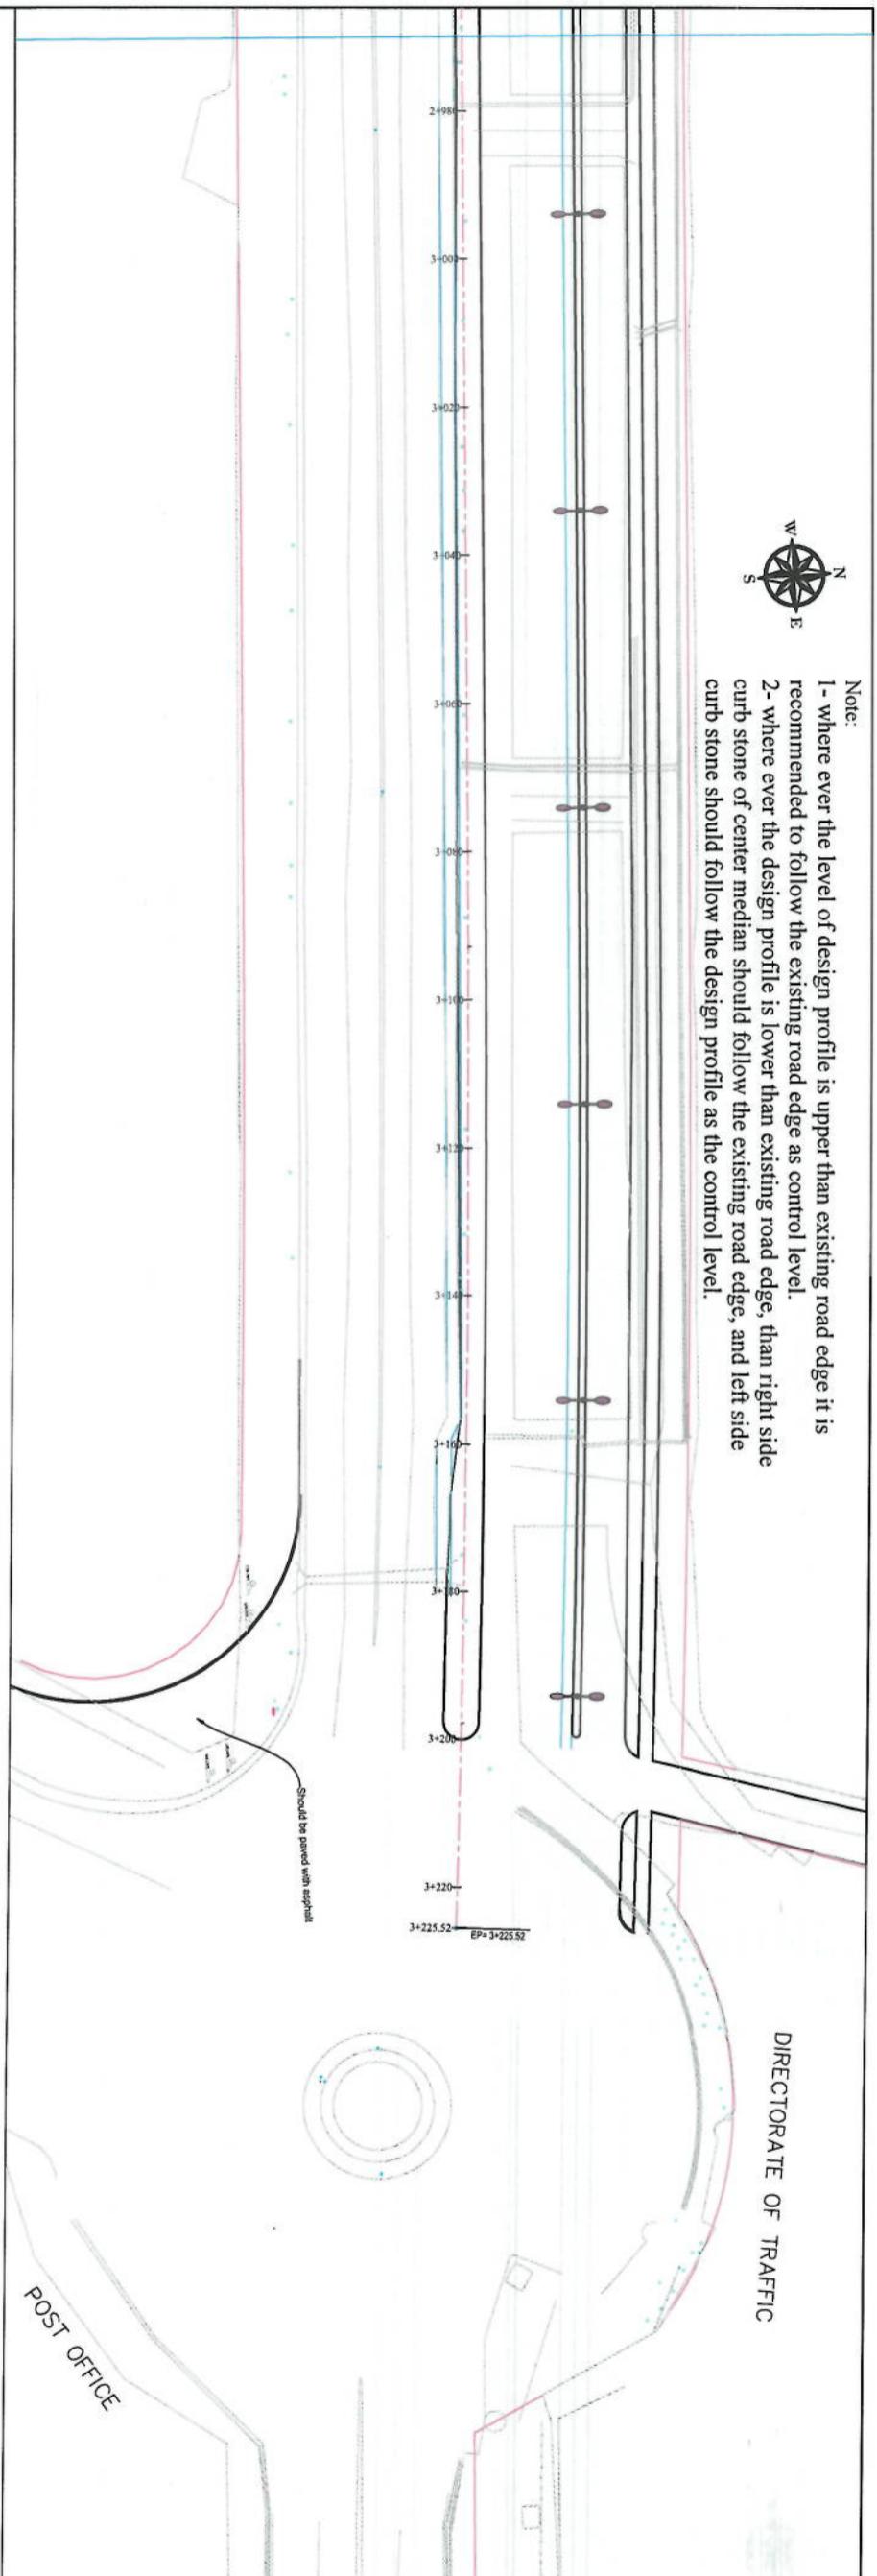


LEGENDS	
EXISTING SURFACE	EXISTING SIDE DITCH

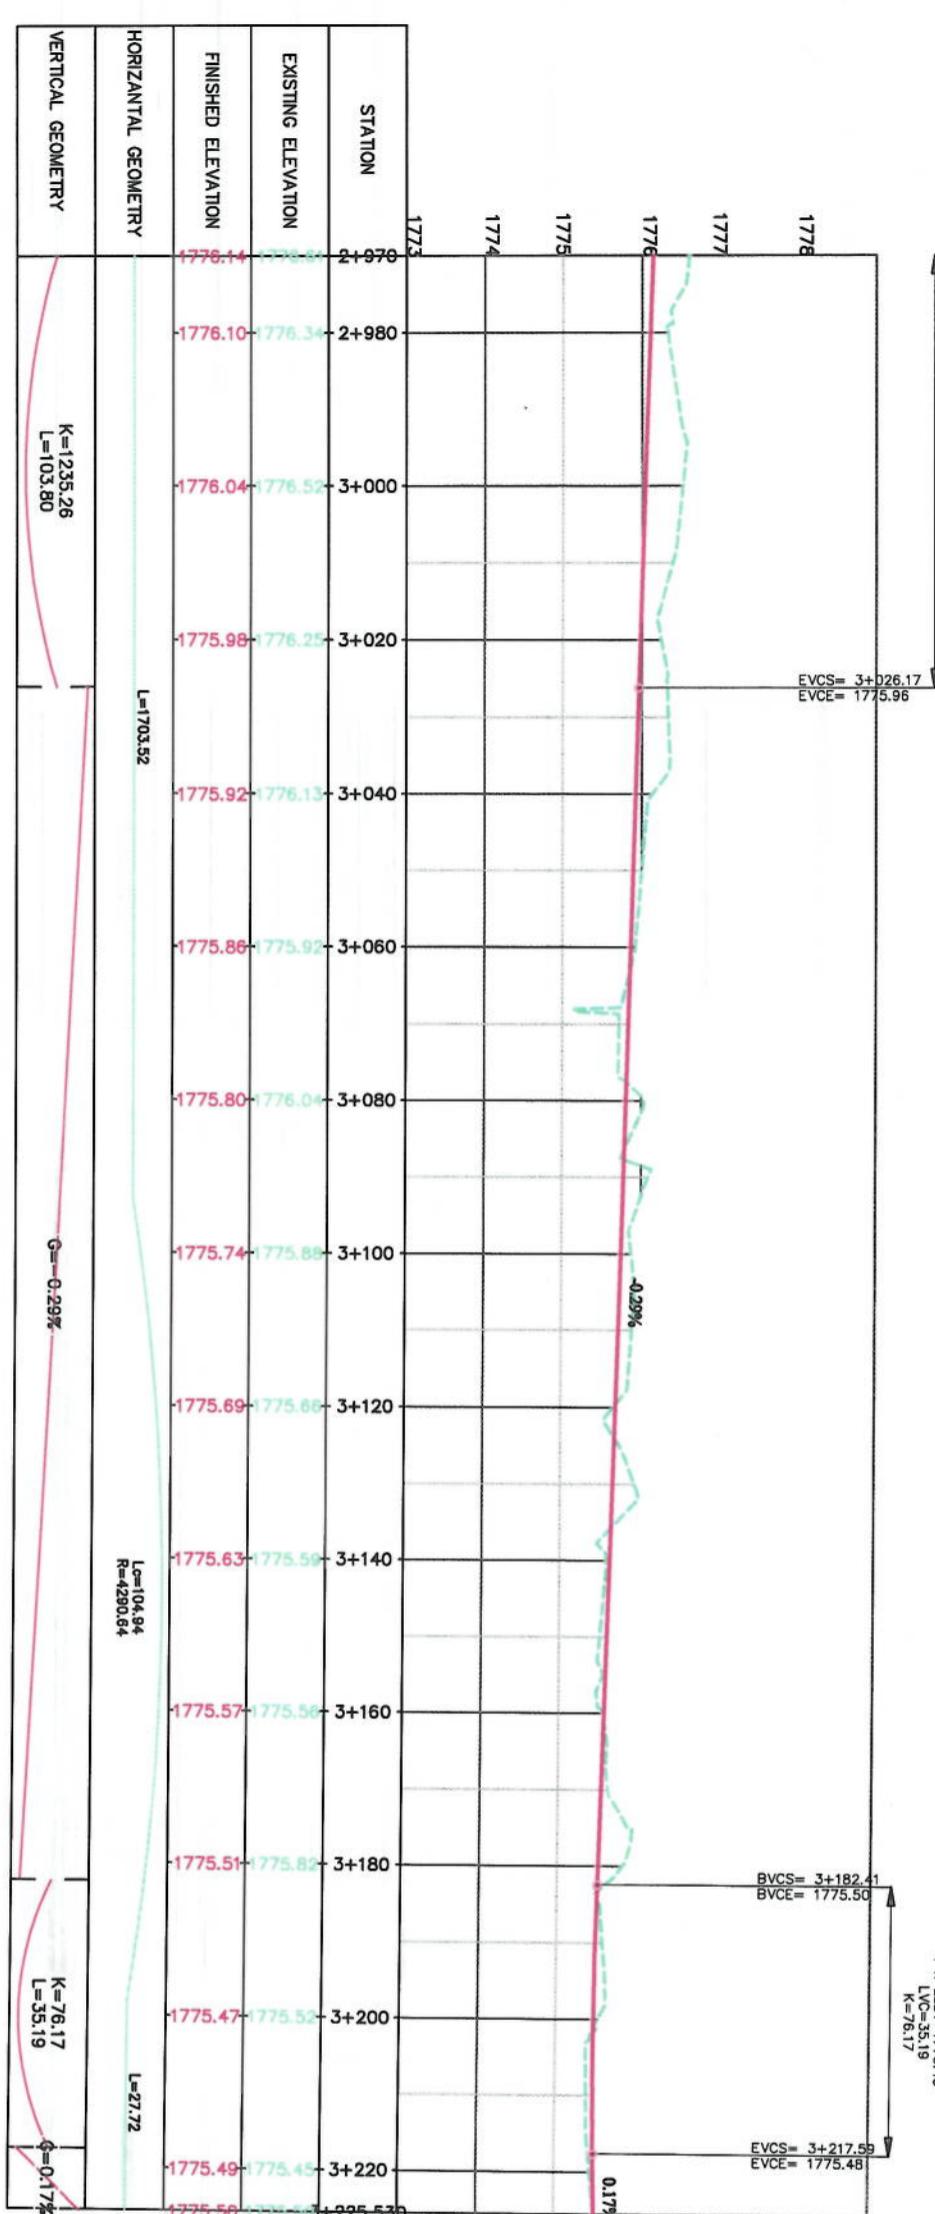

### PLAN & PROFILE

Designed by:	Signature:
Mohammad Ehsa Sial	
Drawn by:	Signature:
Mohammad Ehsa Sial	
Checked by:	Signature:
Hassanullah Sialzi	
Project Name:	
Co-Op-Sang-e to Dehmanzang Road Project	
Drawing Title:	
Date:	Scale:
6/10/2023	1:1000
Status:	
FINAL DESIGN	
Project Code:	
Drawing Number:	PP-12
Revision:	00

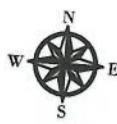

NOTE:

1. The lengths of all new side ditches have shown on the plan.
2. The finished level of new roads should be adjusted to the existing paved roads both at start and at the end property.
3. In case of changing in original cross section types all components should be adjusted properly.
4. All Bed levels of new ditches should be adjusted to the existing ditches bed levels to direct surface water properly.
5. Because of residential area on the site, the survey team was not allowed to enter the houses; therefore, the design has done based on the survey with less accuracy and it is necessary to re-survey this area after the demolition of houses.



LEGENDS	
	CENTER-LINE
	EXISTING SURFACE
	EXISTING SIDE DITCH

#### ISLAMIC EMIRATE OF AFGHANISTAN

Client:

Designed by:  
**KABUL MUNICIPALITY  
DESIGN TEAM**

Project Name: **Co-Sang To Dehnavazan  
Road Project**

Drawing Title:

#### PLAN & PROFILE

Designed by:  
**Mohammad Esmat Srat**

Signature:

Drawn by:  
**Mohammad Esmat Srat**

Signature:

Checked by:  
**Habibullah Shalizi**


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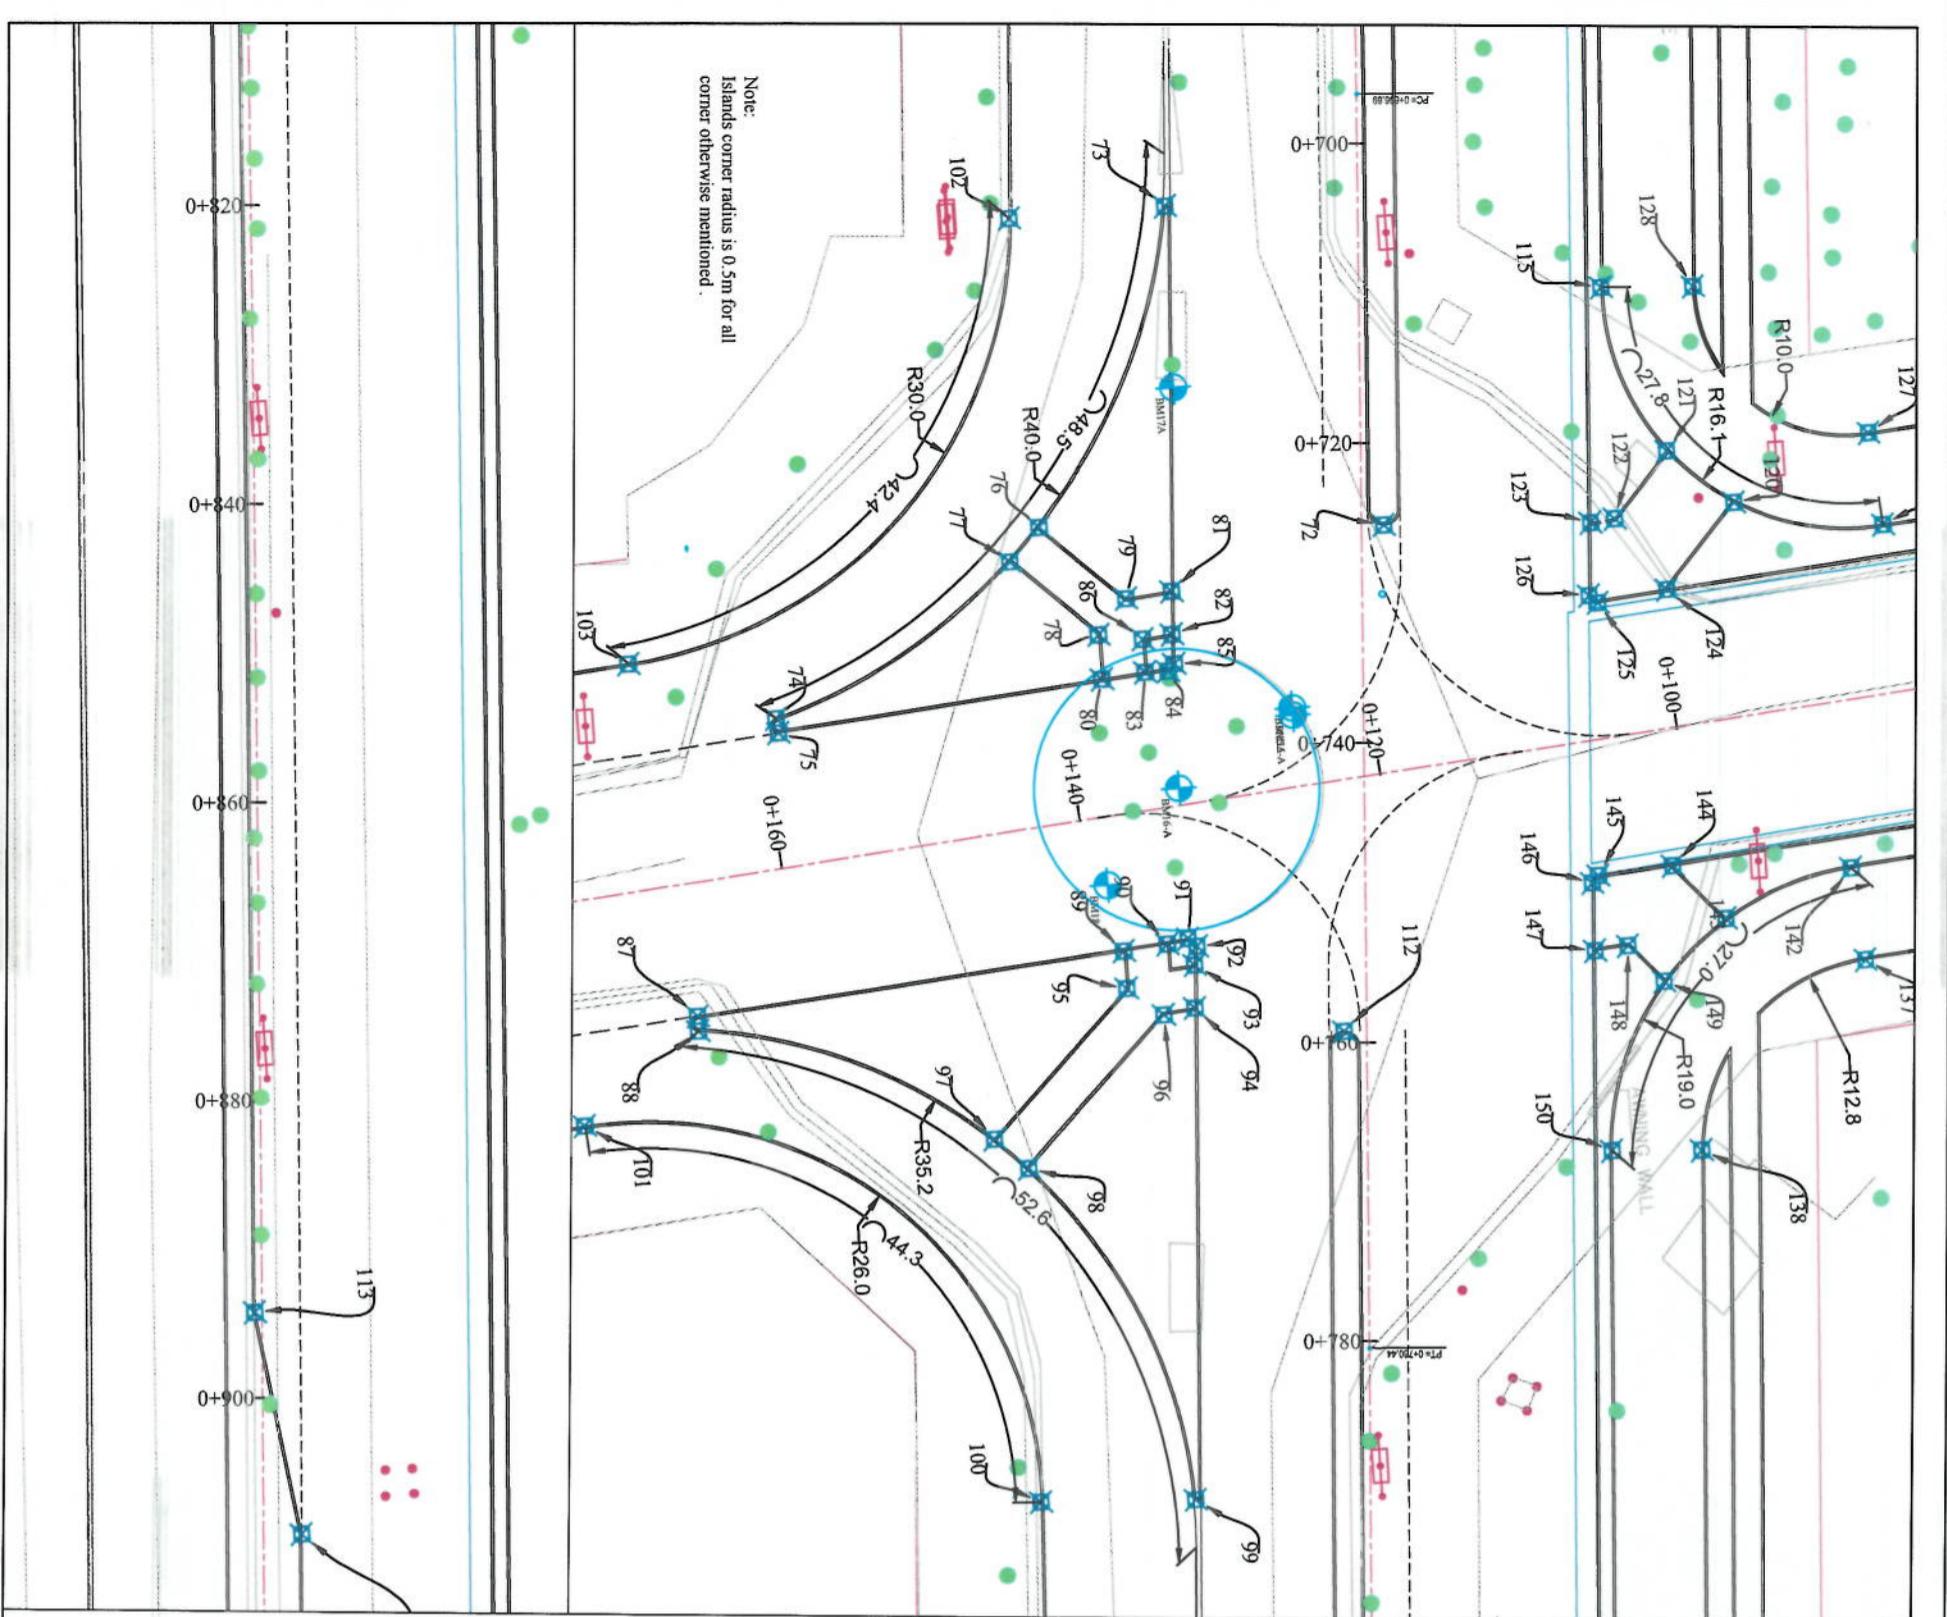
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6/10/2023	1:1000


Status:  
**FINAL DESIGN**

Project Code:

Drawing Number	PP.13
Revision	00



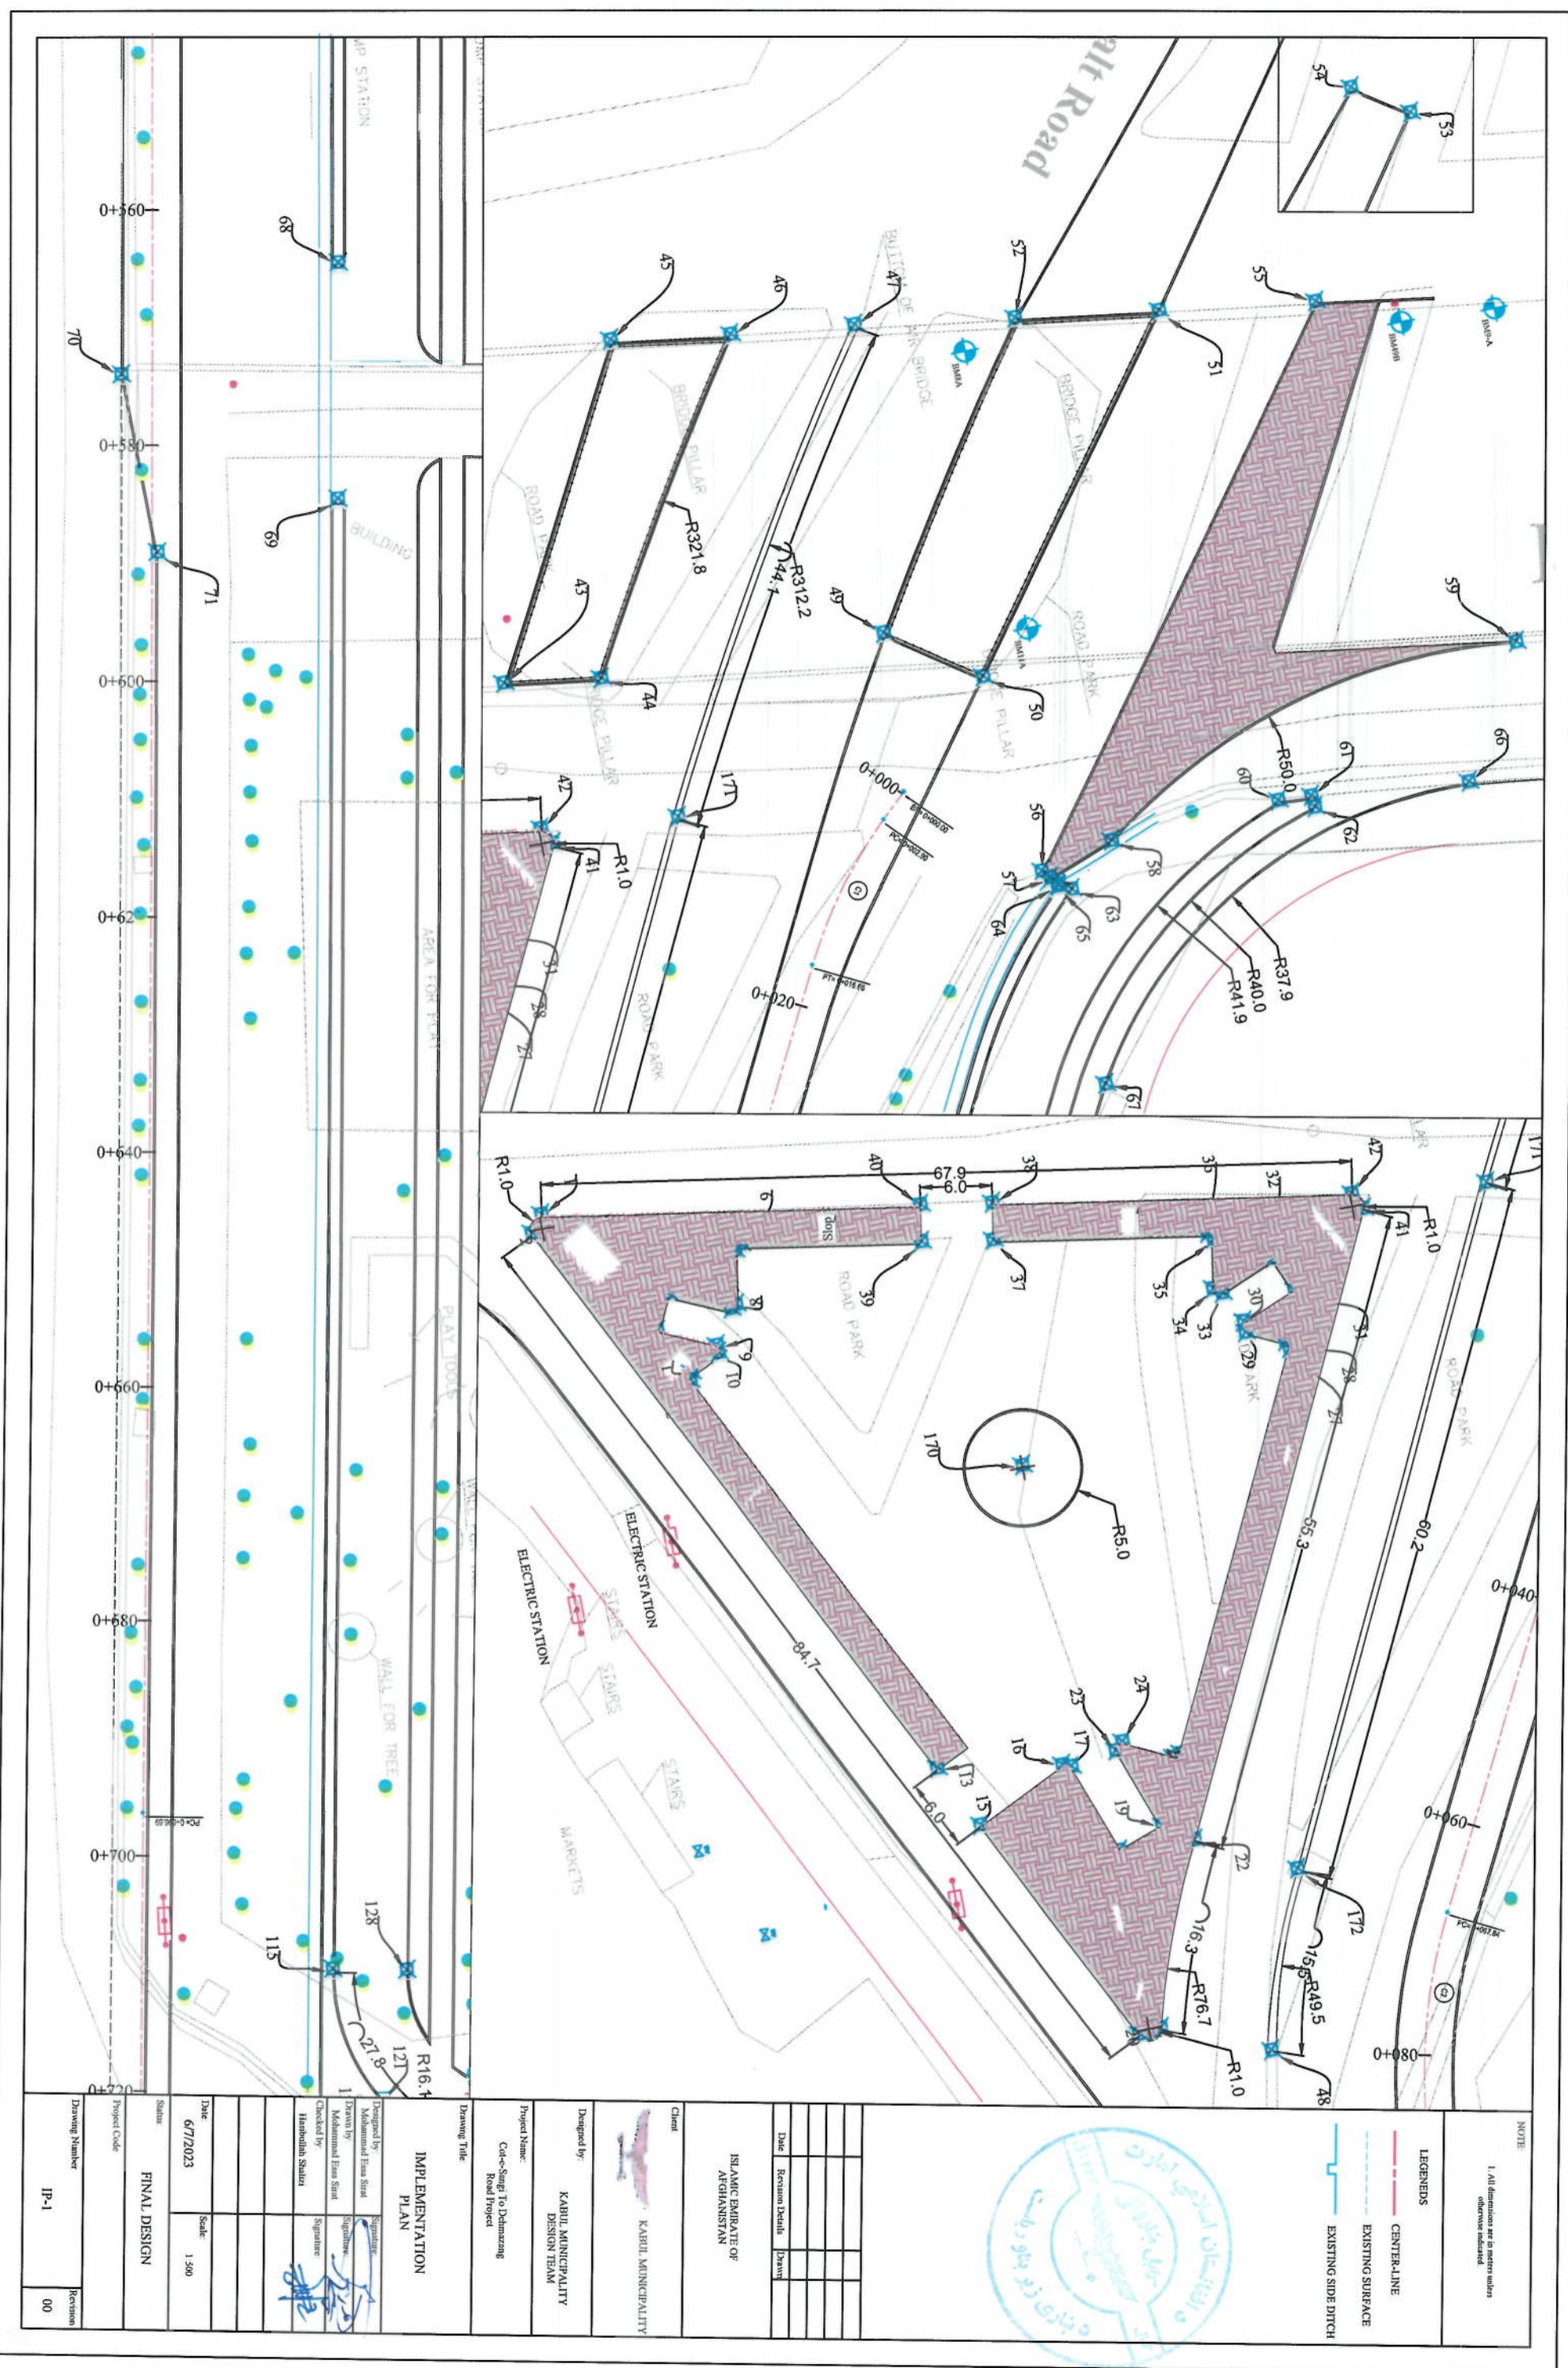

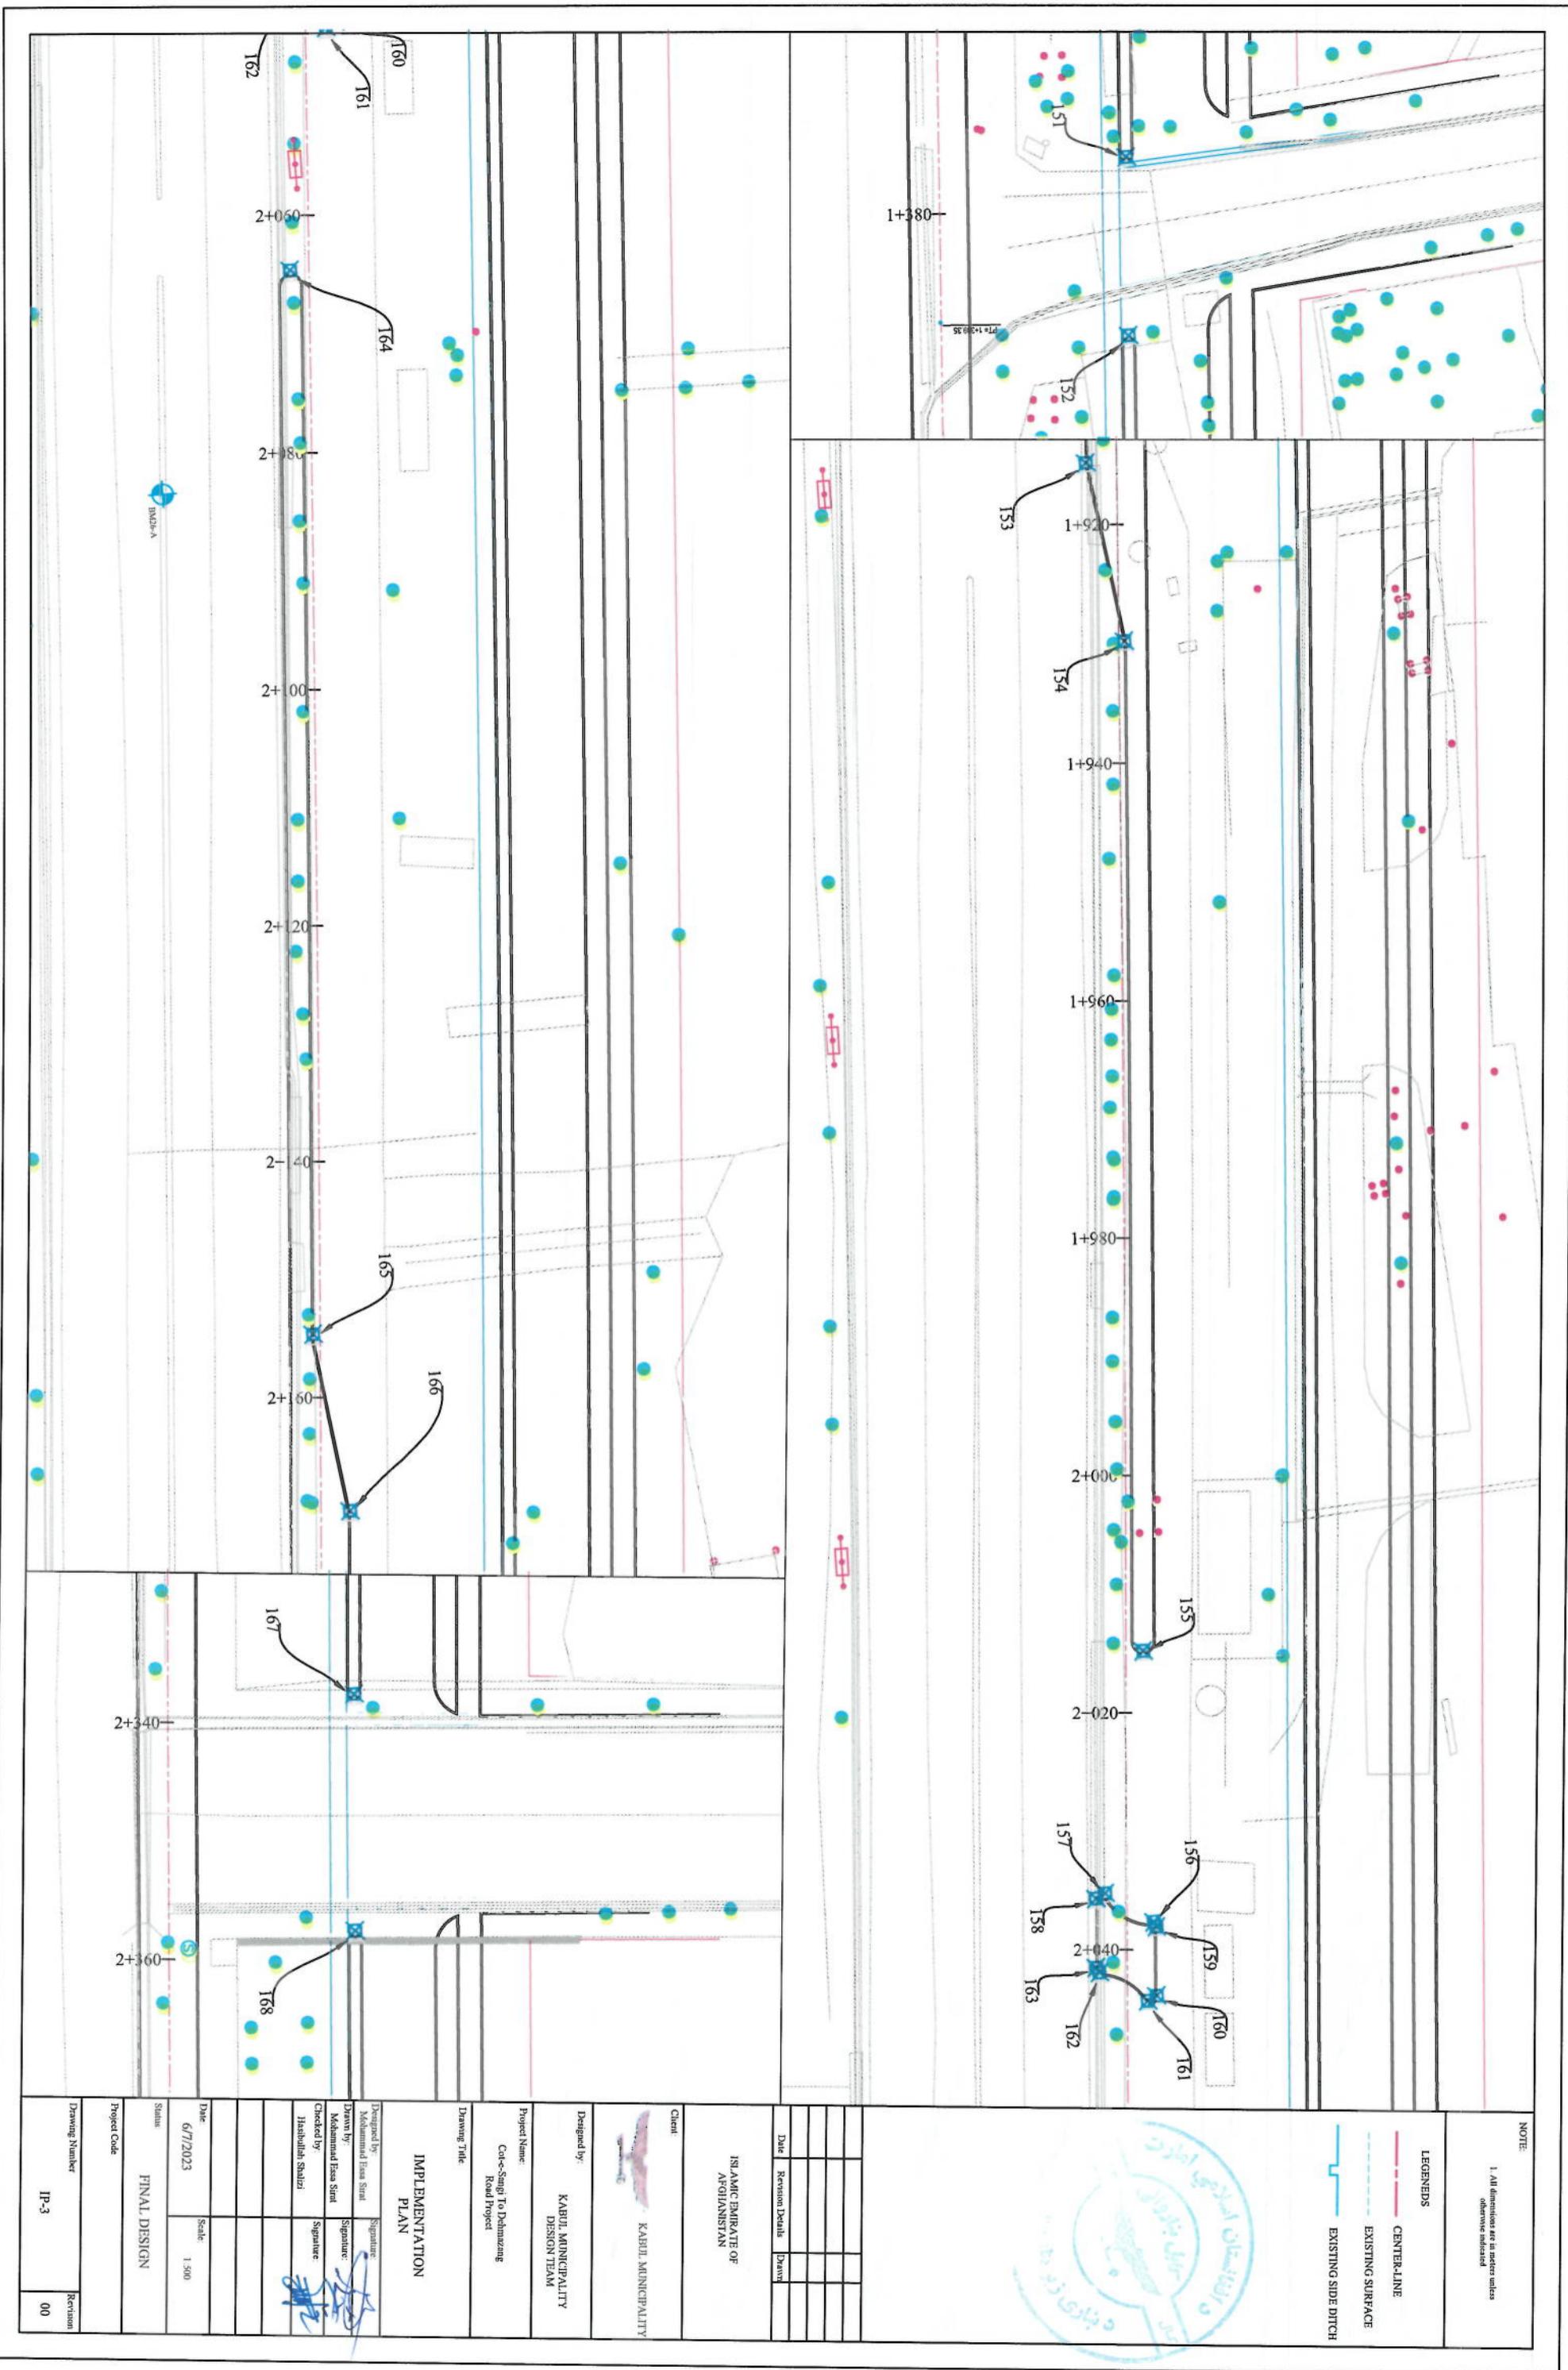

NOTE:

1. All dimensions are in meter unless otherwise indicated

LEGENDS	
	CENTER-LINE
	EXISTING SURFACE
	EXISTING SIDE DITCH



Point Table		
Point #	Northing	Eastng
1	3818901.81	510819.53
2	3818900.76	510820.95
3	3818910.83	510828.05
4	3818909.46	510831.05
5	3818917.05	510825.53
6	3818917.63	510825.12
7	3818915.83	510830.34
8	3818916.32	510830.07
9	3818914.09	510833.17
10	3818914.10	510833.80
11	3818911.57	510835.04
12	3818911.34	510835.71
13	3818925.70	510871.78
15	3818928.34	510877.16
16	3818936.05	510873.38
17	3818936.74	510873.66
18	3818939.32	510881.37
19	3818943.25	510879.97
20	3818938.09	510897.03
21	3818939.96	510898.84

Point Table		
Point #	Northing	Eastng
22	3818945.67	510881.62
23	3818940.61	510872.98
24	3818941.30	510872.36
25	3818945.24	510874.41
26	3818945.91	510874.17
27	3818961.18	510842.22
28	3818960.95	510841.56
29	3818957.76	510840.20
30	3818957.79	510839.29
31	3818962.49	510837.51
32	3818961.23	510834.46
33	3818956.43	510836.60
34	3818955.75	510836.06
35	3818956.57	510831.92
36	3818956.16	510831.34
37	3818938.49	510828.64
38	3818938.99	510825.53
39	3818932.56	510827.68
40	3818933.07	510824.53
41	3818969.51	510831.76
50	3819007.44	510824.71
51	3819027.73	510797.19
52	3819015.81	510795.53
53	3819059.01	510753.44
54	3819054.48	510750.41
55	3819040.81	510798.94
56	3819009.16	510841.74
57	3819009.76	510842.48
58	3819015.33	510840.30
59	3819052.06	510830.26
60	3819029.73	510839.59
61	3819032.54	510839.75


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143	3818943.84	511574.95
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145	3818935.54	511571.55
164	3818841.75	512884.34
165	3818837.44	512974.19
166	3818839.58	512989.34
167	3818842.81	513157.79
168	3818841.52	513177.75
169	3818790.79	514018.14
170	3818937.37	510847.88
171	3818890.16	510831.52
172	3818953.75	510885.58


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163	3818842.13	512861.04
164	3818840.75	512884.34
165	3818837.44	512974.19
166	3818839.58	512989.34
167	3818842.81	513157.79
168	3818841.52	513177.75
169	3818790.79	514018.14
170	3818937.37	510847.88
171	3818890.16	510831.52


BM Point Table			
Description	Elevation	Northing	Eastng
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BM8A	1800.02	3819011.15	510797.57
BM10A	1799.66	3818943.37	510812.19
BM49B	1799.79	3818047.57	510802.07
BM13A	1789.96	3818938.70	51039.05
BM12-A	1790.32	3818943.01	510970.65
BM13-A	1789.96	3818938.70	51039.05
BM15-A	1786.97	3818916.09	511559.49
BM15A	1786.97	3818916.09	511559.00
BM16-A	1787.40	3818908.23	511563.91
BM17A	1786.52	3818908.68	511537.21
BM18	1787.06	3818903.13	511570.06
BM20A	1784.46	3818925.46	511266.81
BM16-A	1787.40	3818908.23	511563.91
BM19A	1784.99	3818893.97	511819.84
BM21A	1783.43	3818873.51	512168.46
BM22-A	1783.18	3818868.63	512248.86
BM23-A	1782.01	3818856.51	512452.11
BM27-A	1778.76	3818815.91	513141.55
BM28-A	1778.57	3818812.54	513190.90
BM25-A	1777.38	3818788.47	51303.12
BM26-A	1776.85	3818782.53	513709.73
BM24-A	1781.39	3818850.24	512560.79
BM25-A	1780.96	3818840.42	512726.51
BM26-A	1780.28	3818829.76	512902.45
BM29-A	1775.75	3818766.61	513979.86
BM30-A	1775.94	3818761.68	514058.54
BM45-A	1794.36	3819244.24	510494.53
BM6-A	1793.36	3819193.18	510583.92
BM31-A	1776.00	3818761.17	514075.48
BM32-A	1775.98	3818753.86	514061.99
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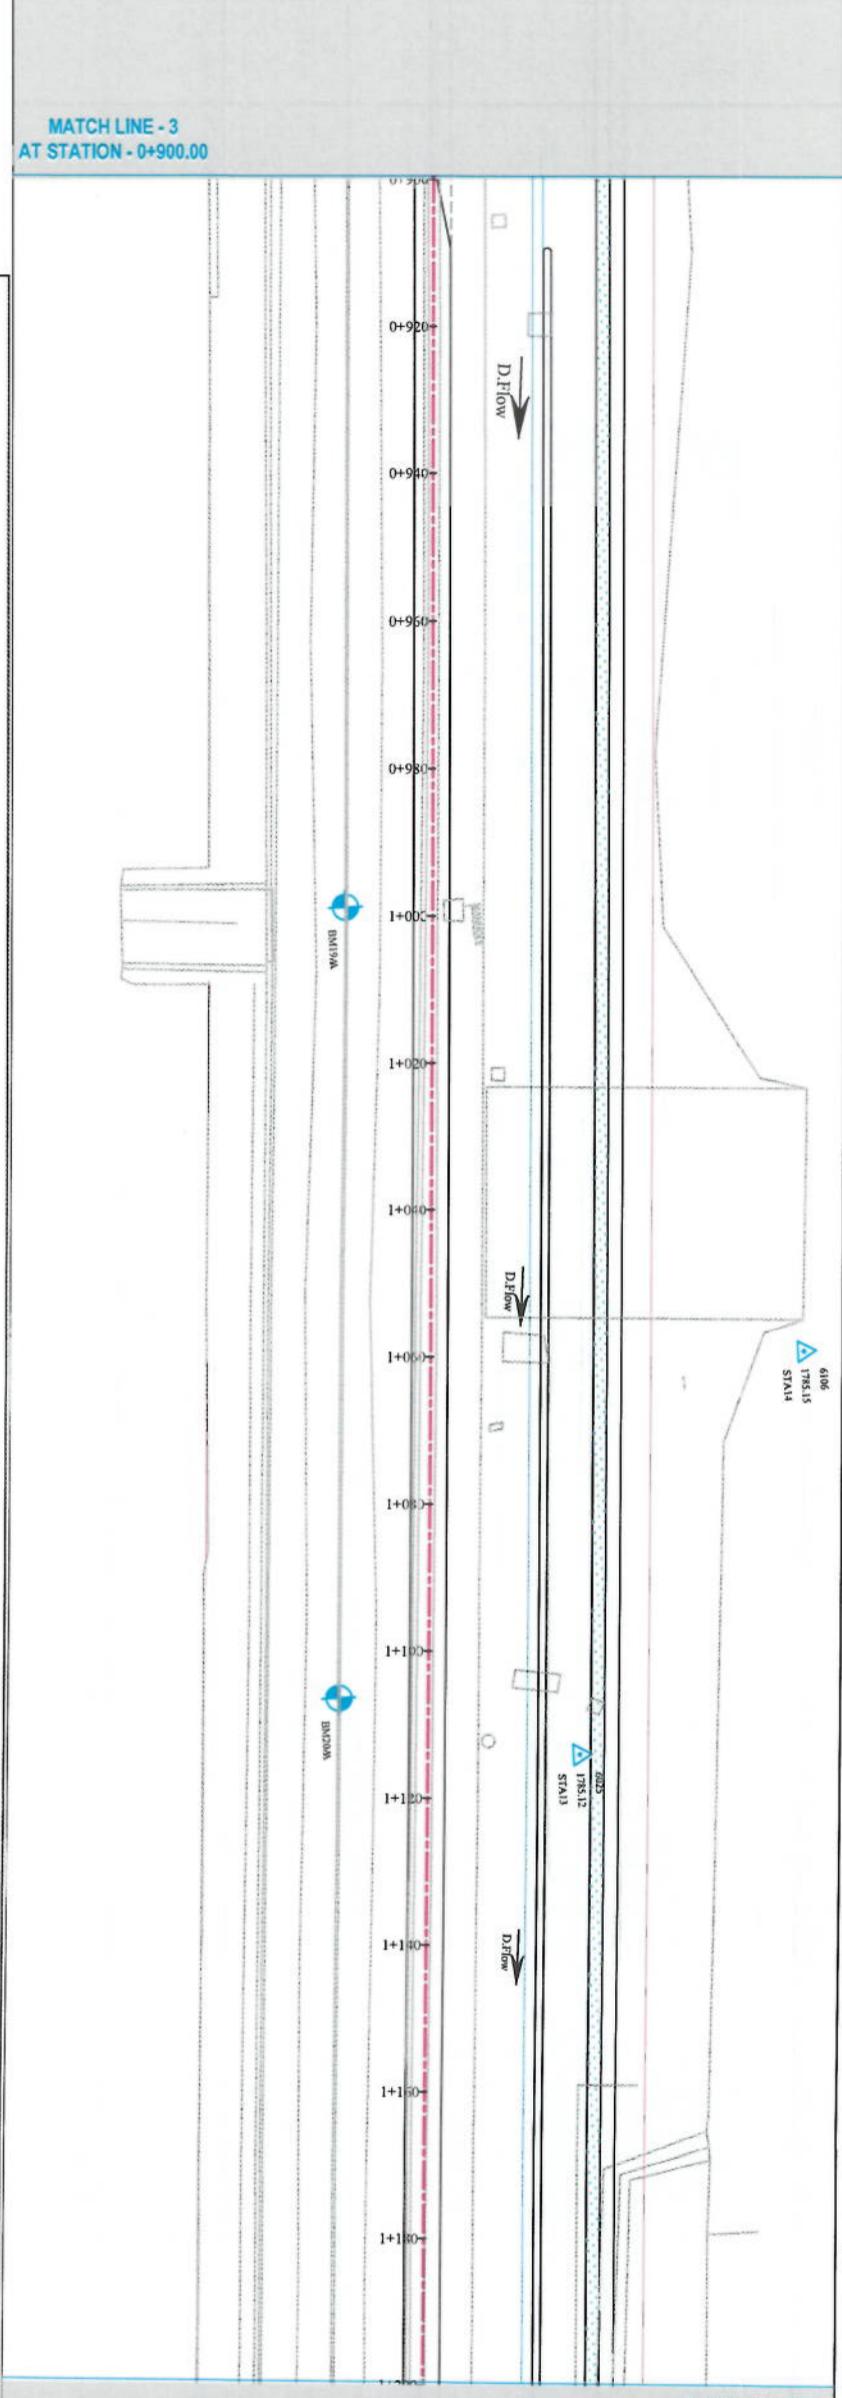
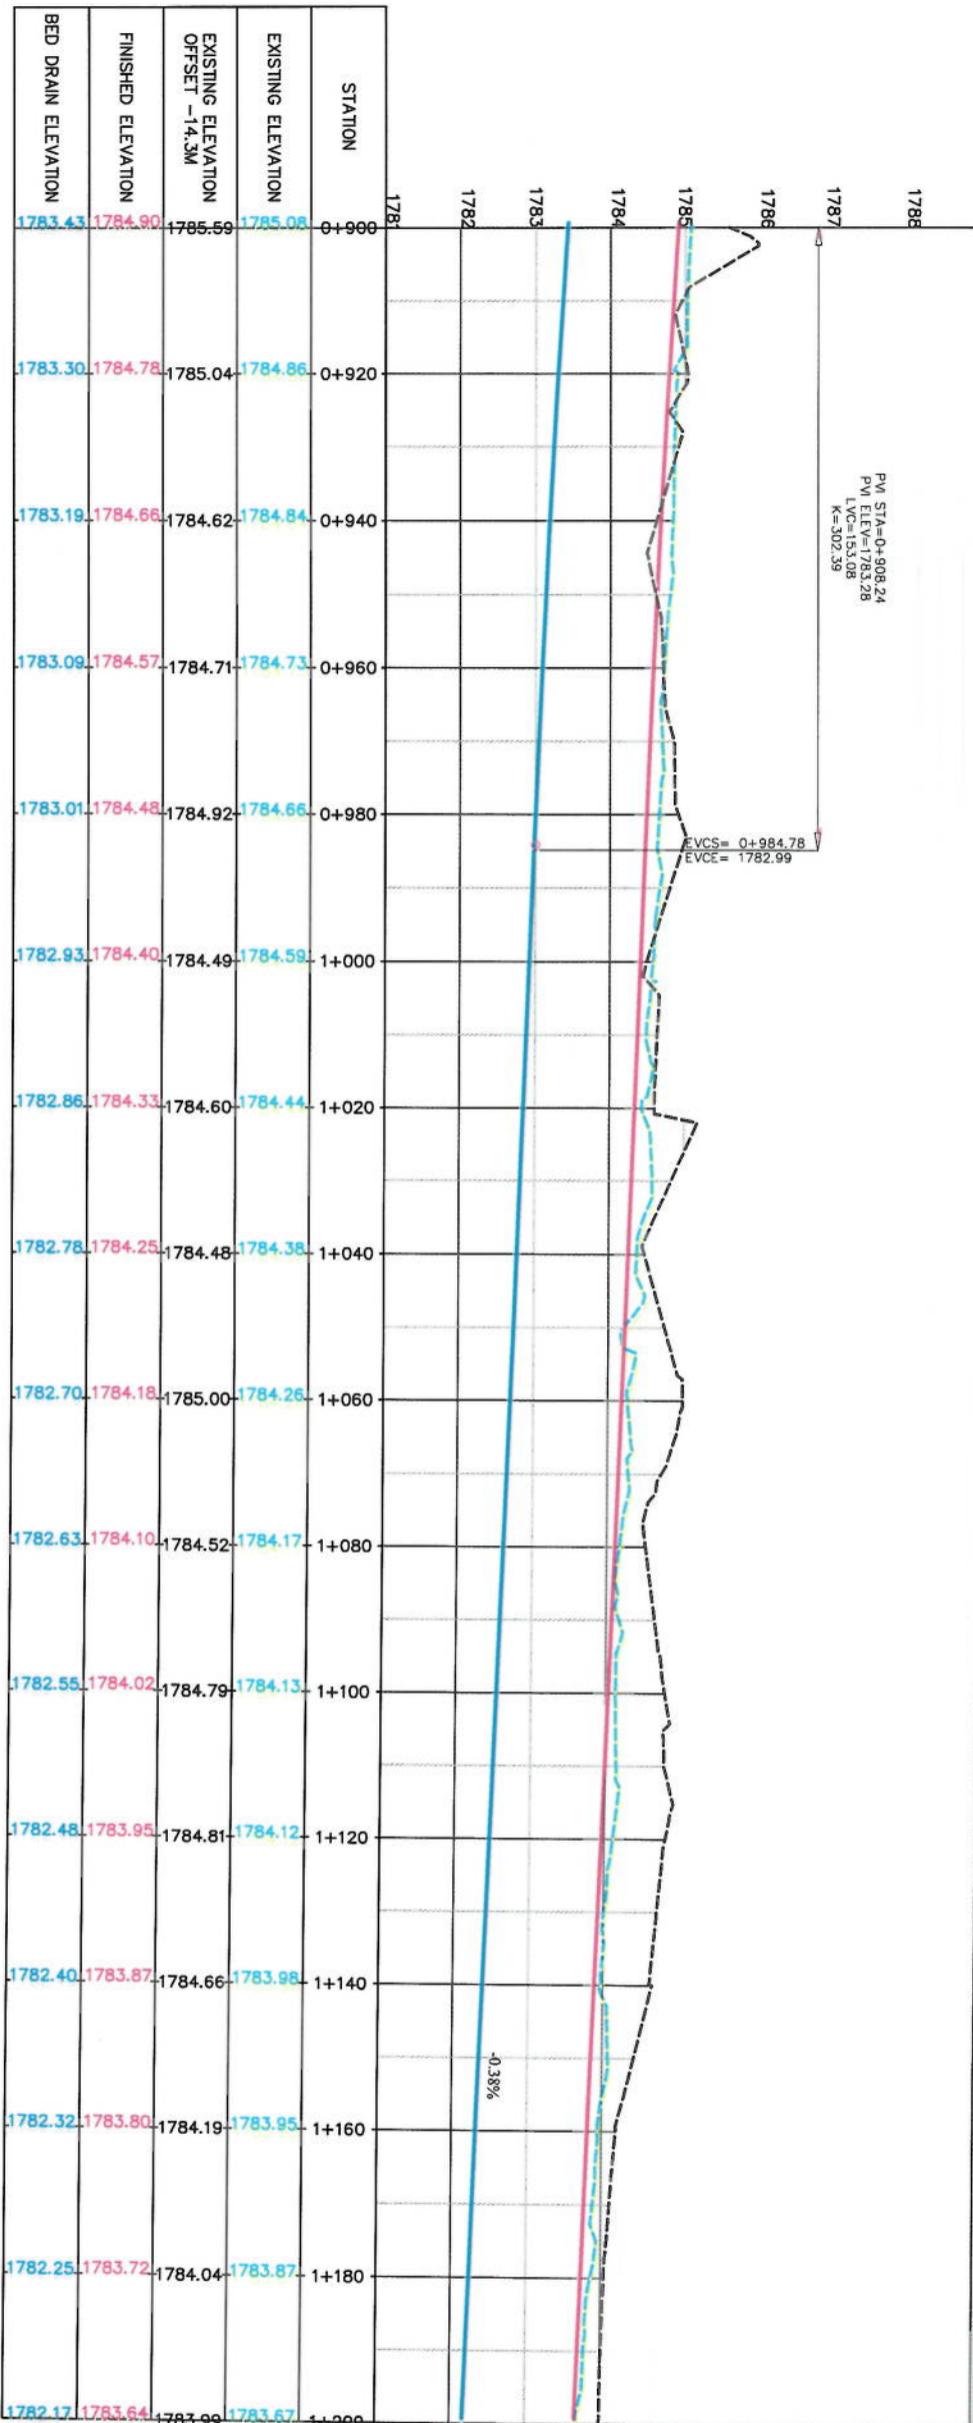
IMPLEMENTATION PLAN		
Designed by:	Signature:	Date:
Mohammad Esa Sial		6/7/2023
Mohammed Ihsan Sial		Sale: 1-500
Checkered by:	Signature:	
Ibrahim Shatila		
Drawn by:	Signature:	
Reviewed by:	Signature:	
Approved by:	Signature:	
Final Design:	Signature:	


Drawing Number	Revision
IP-4	0





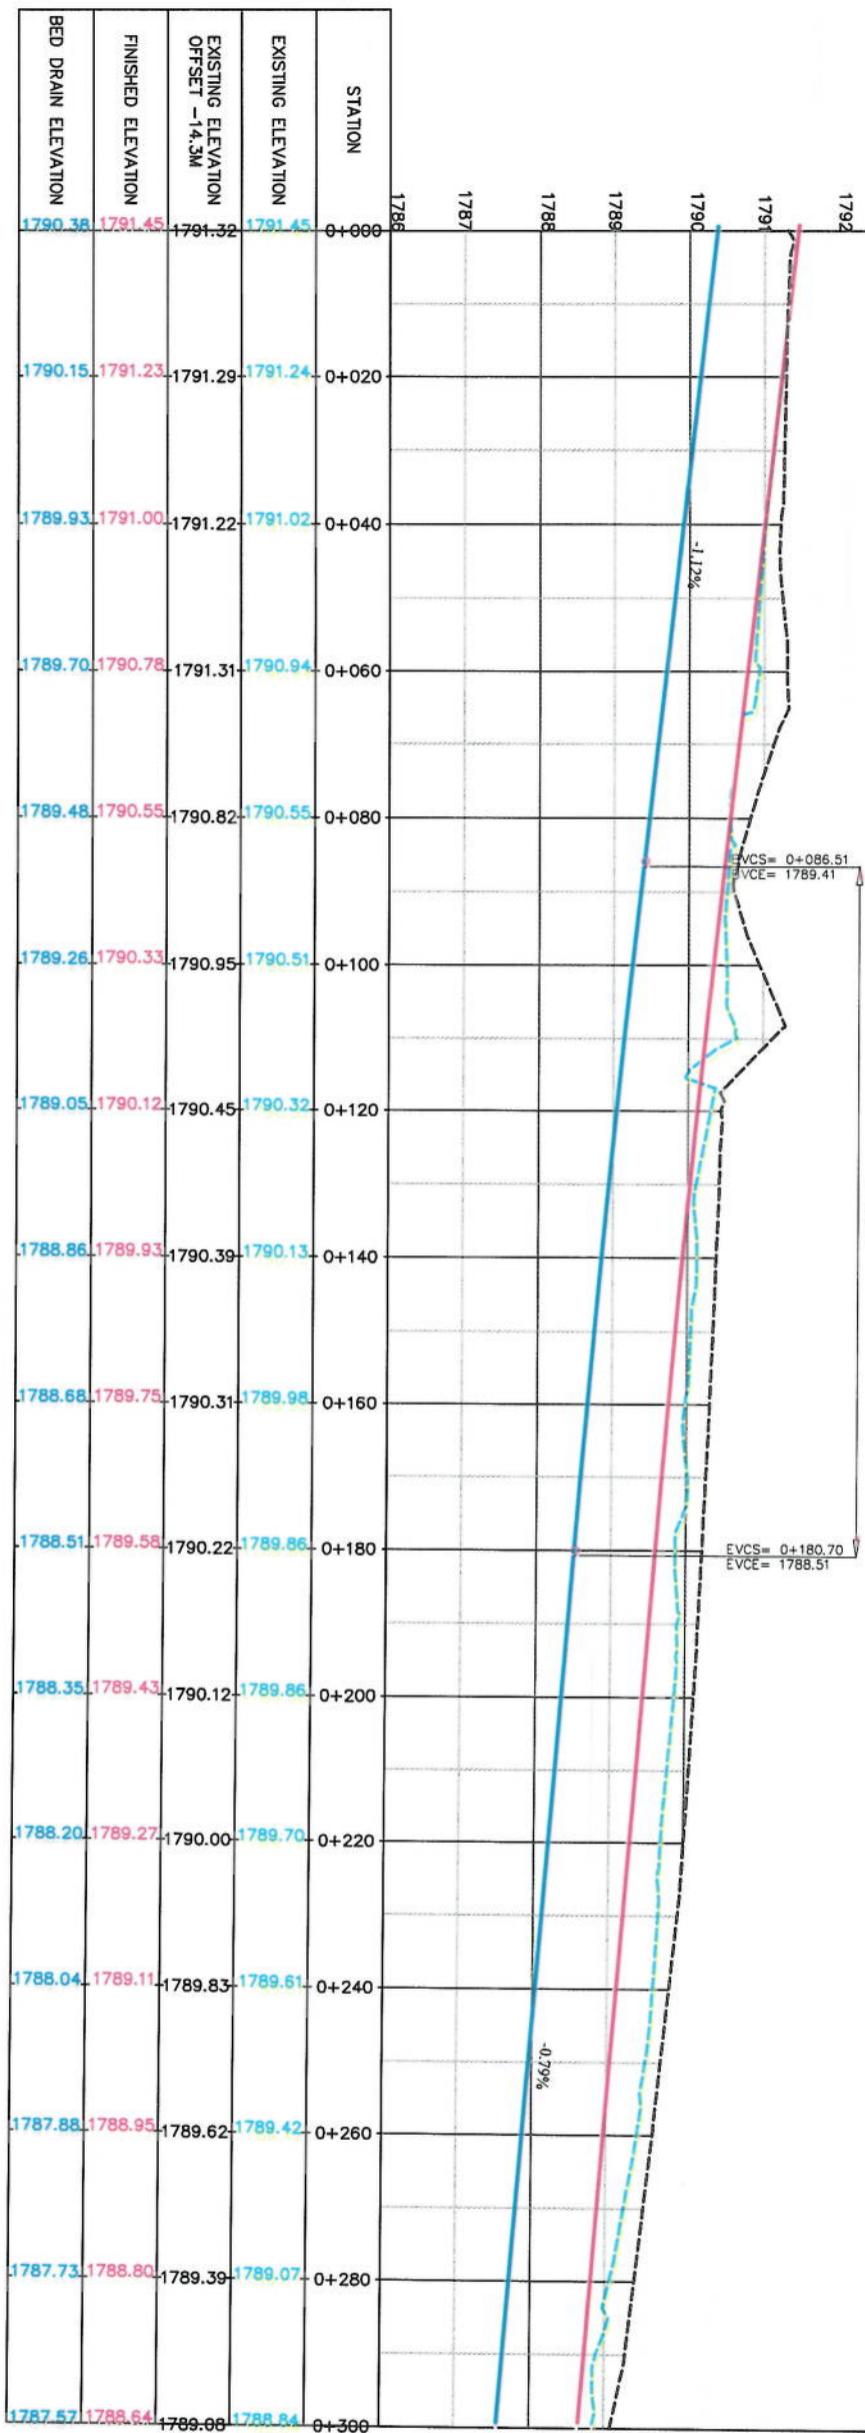

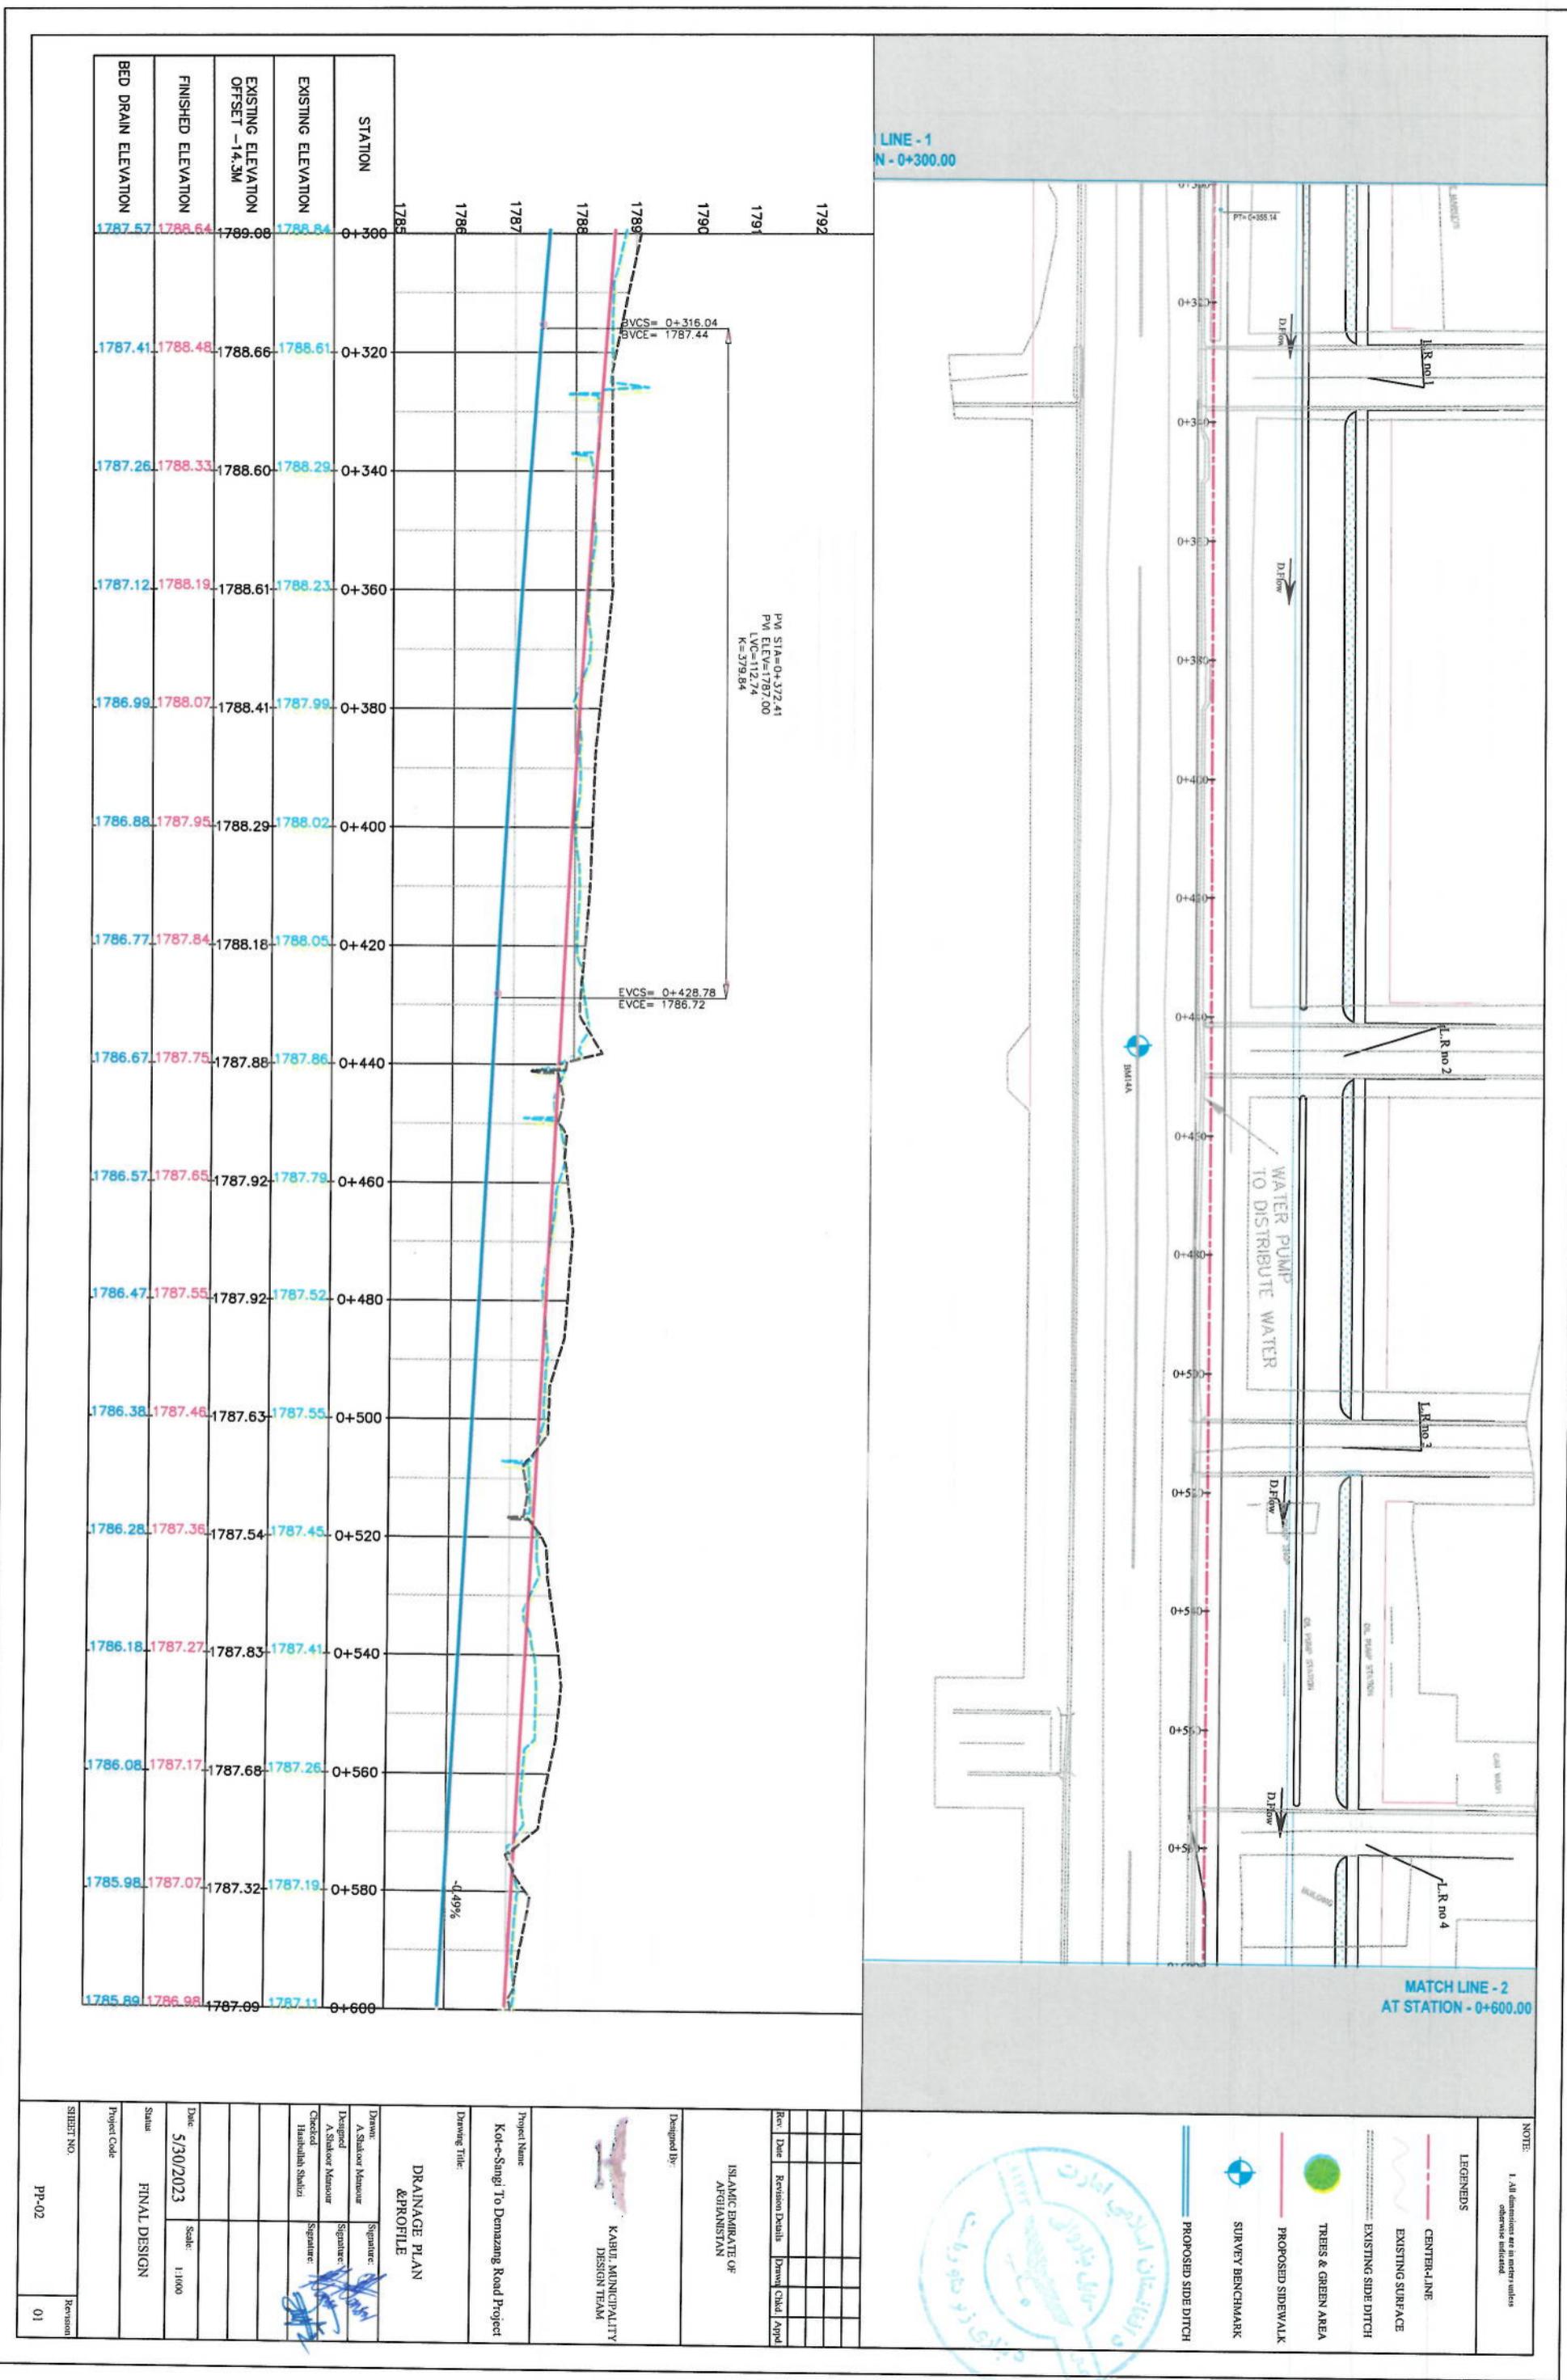

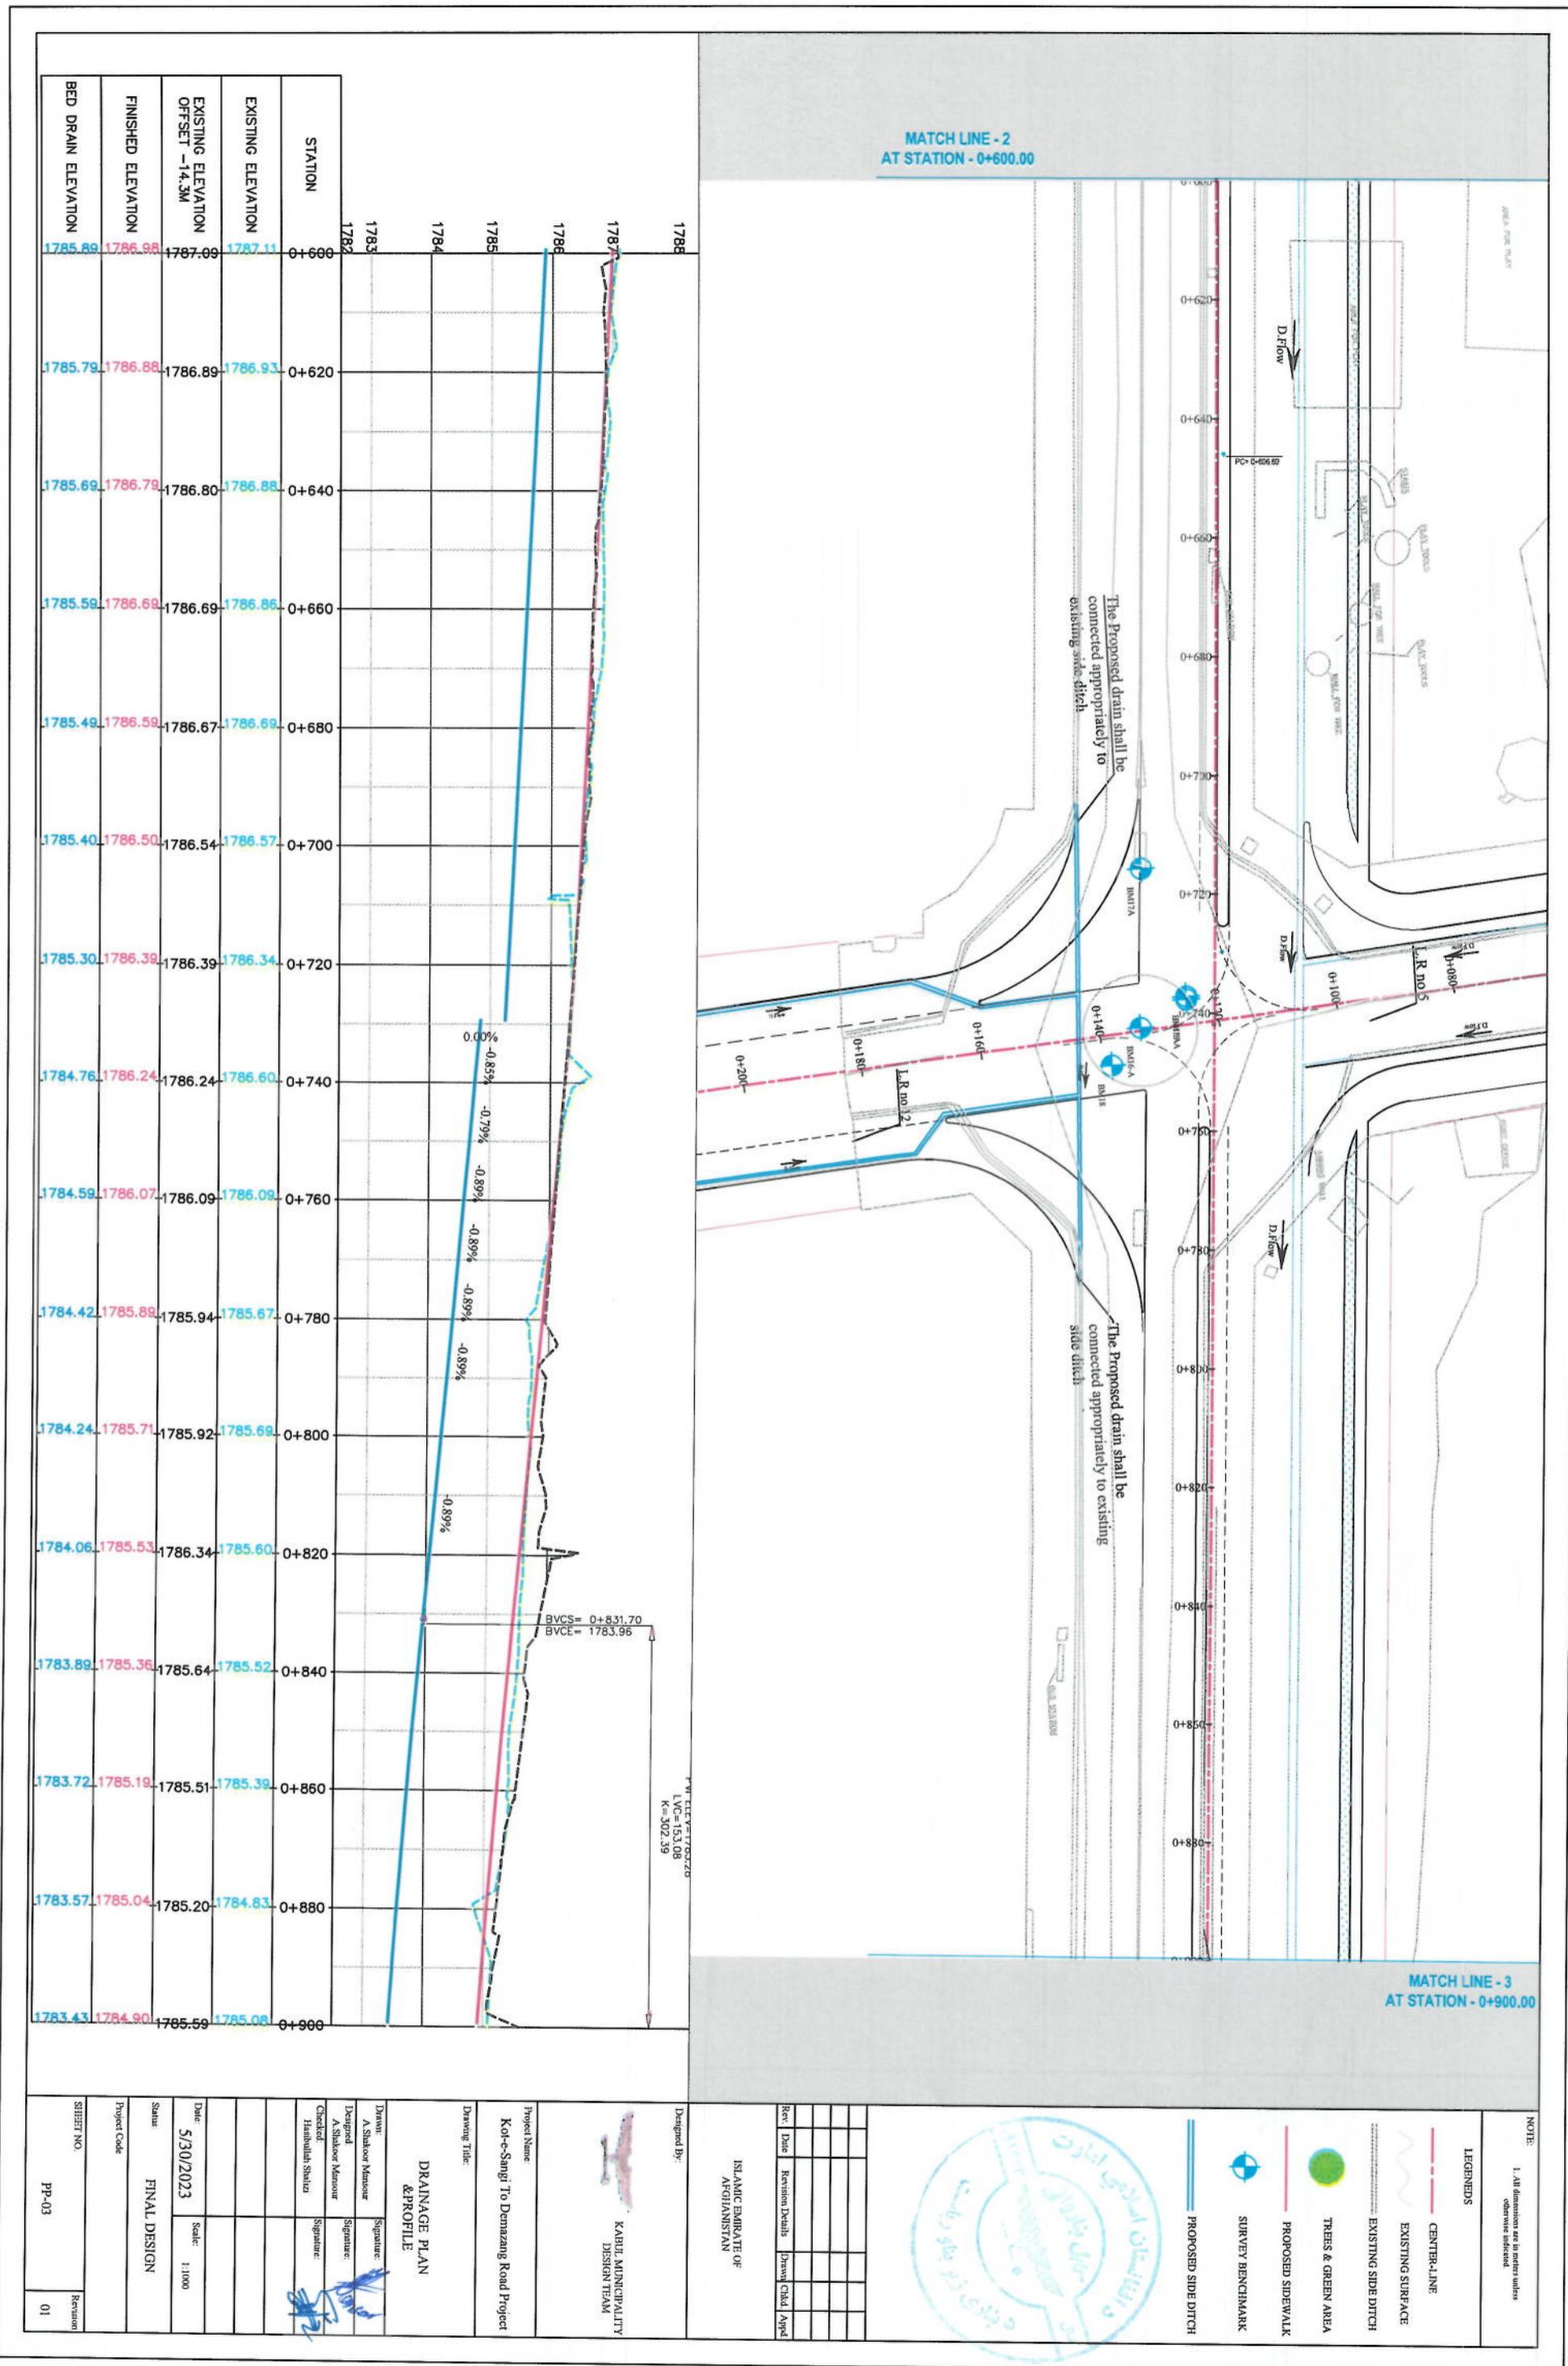

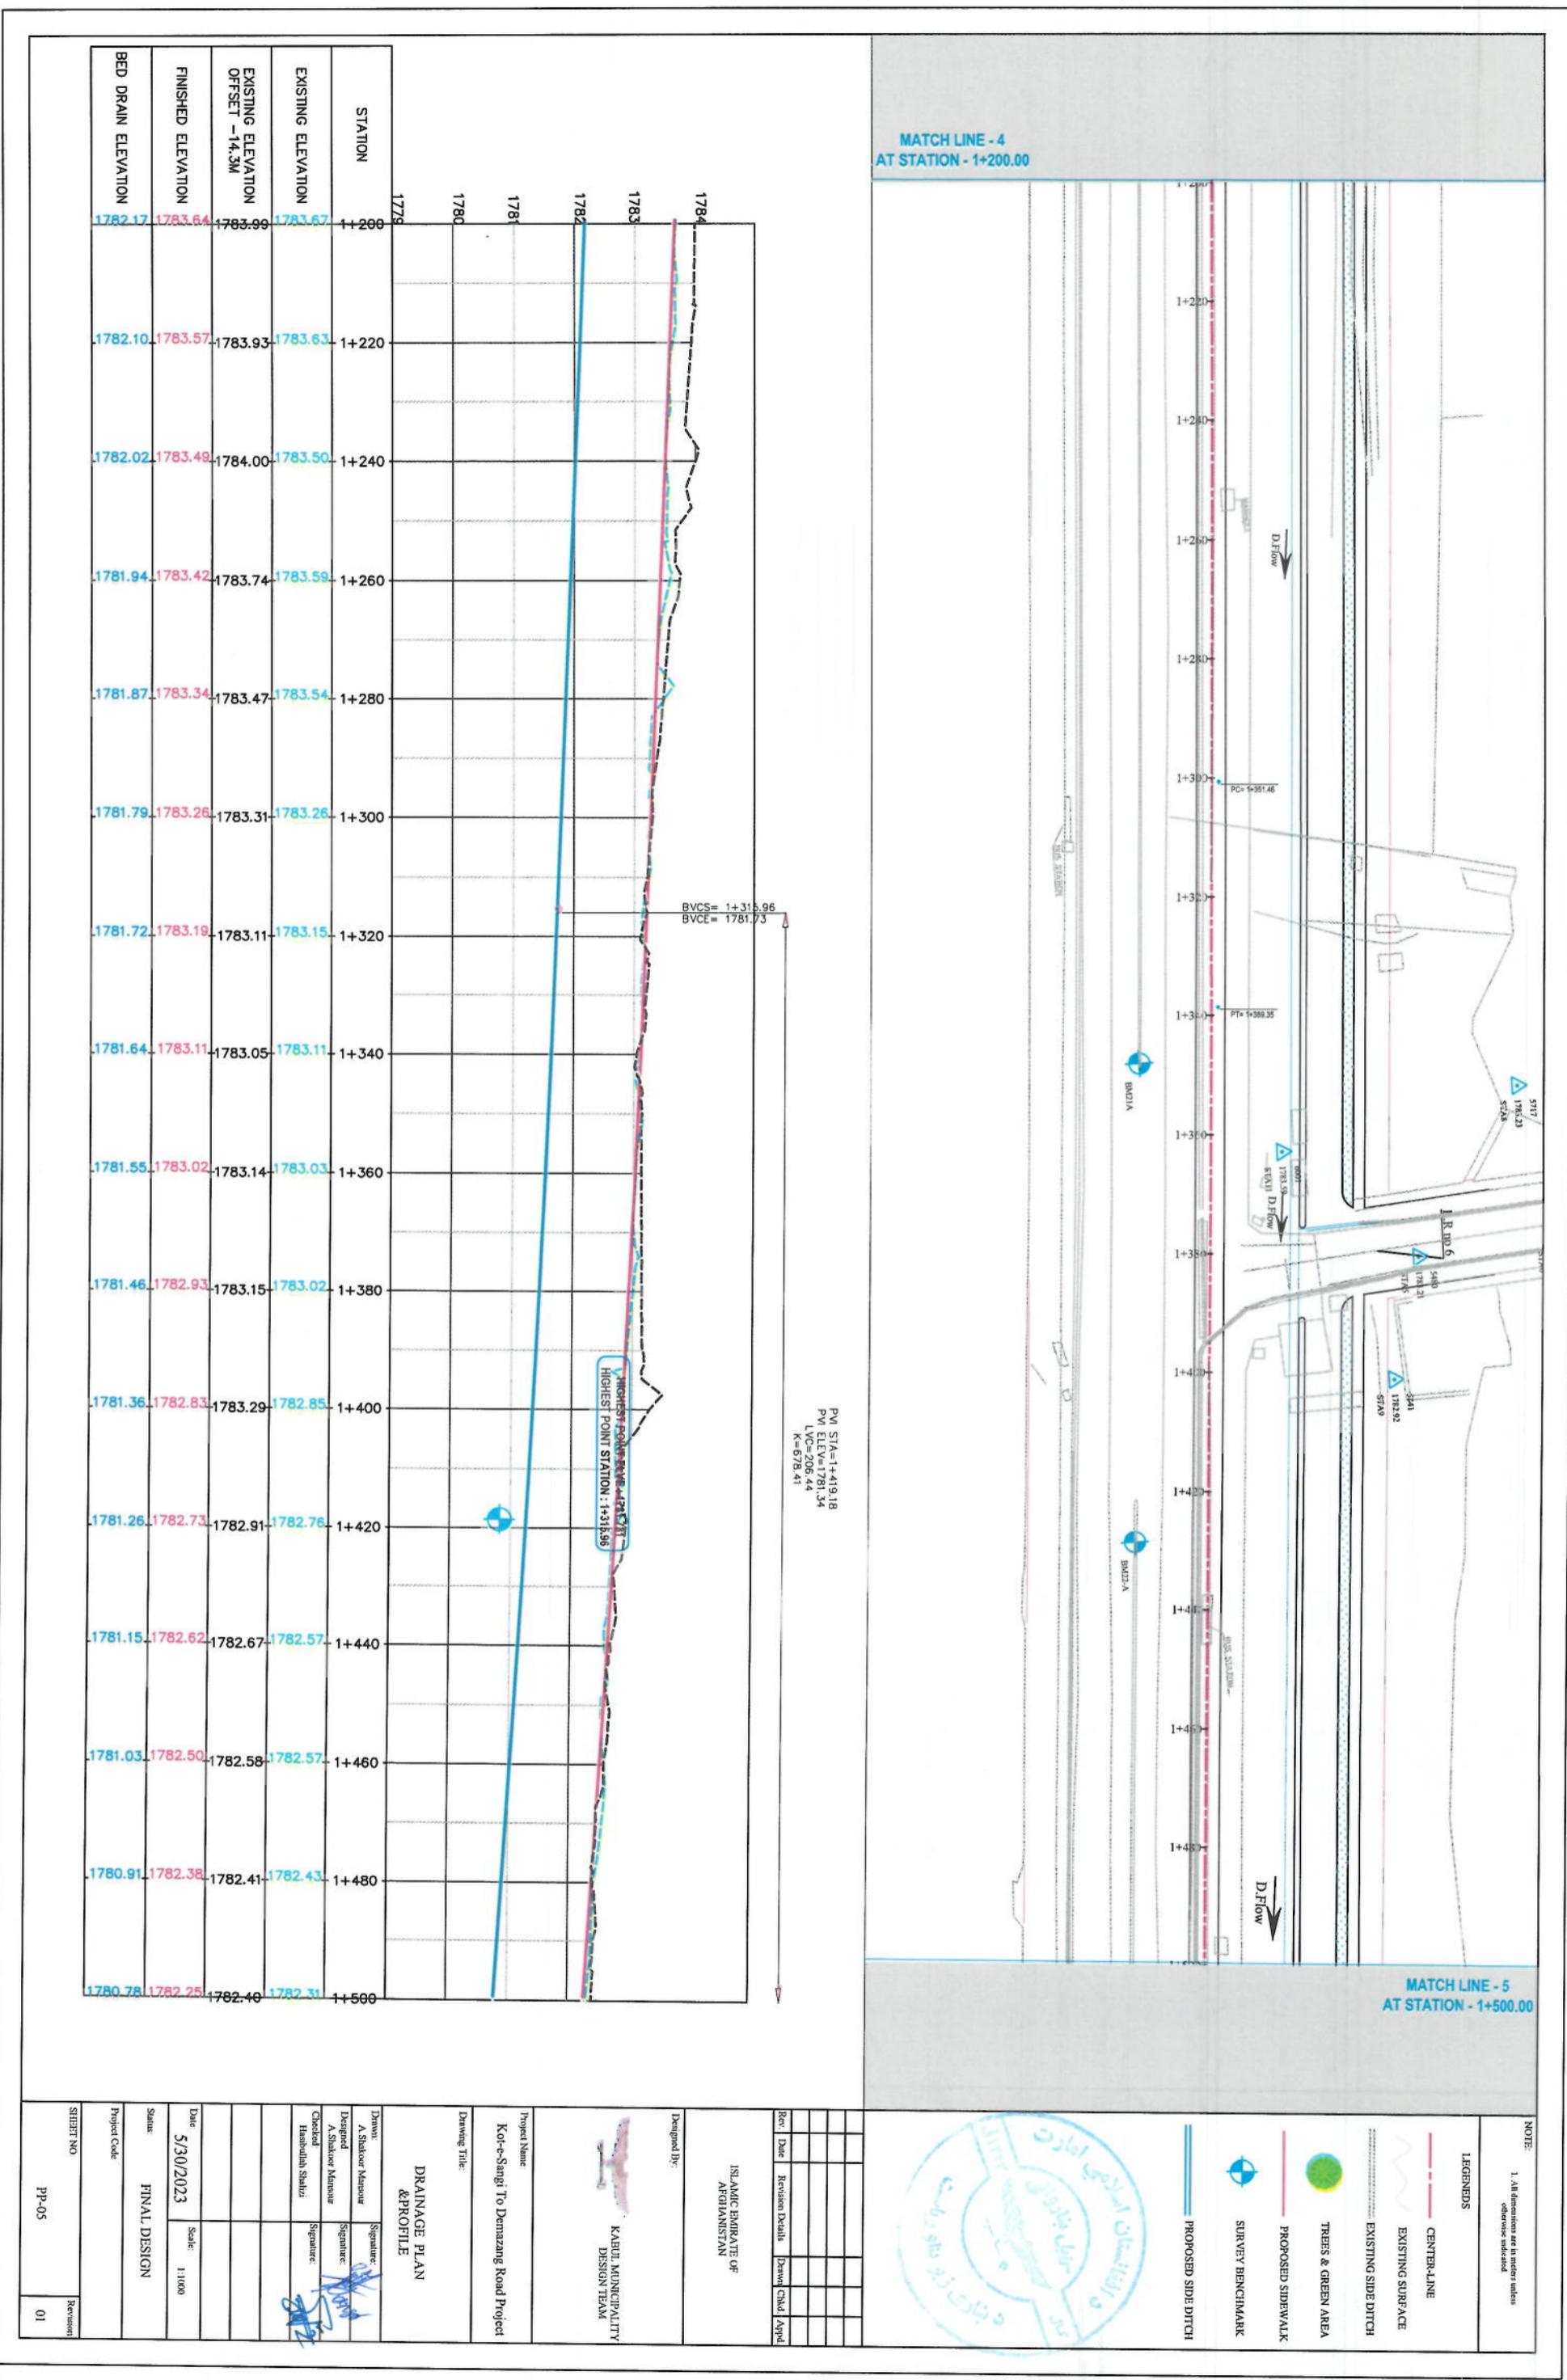

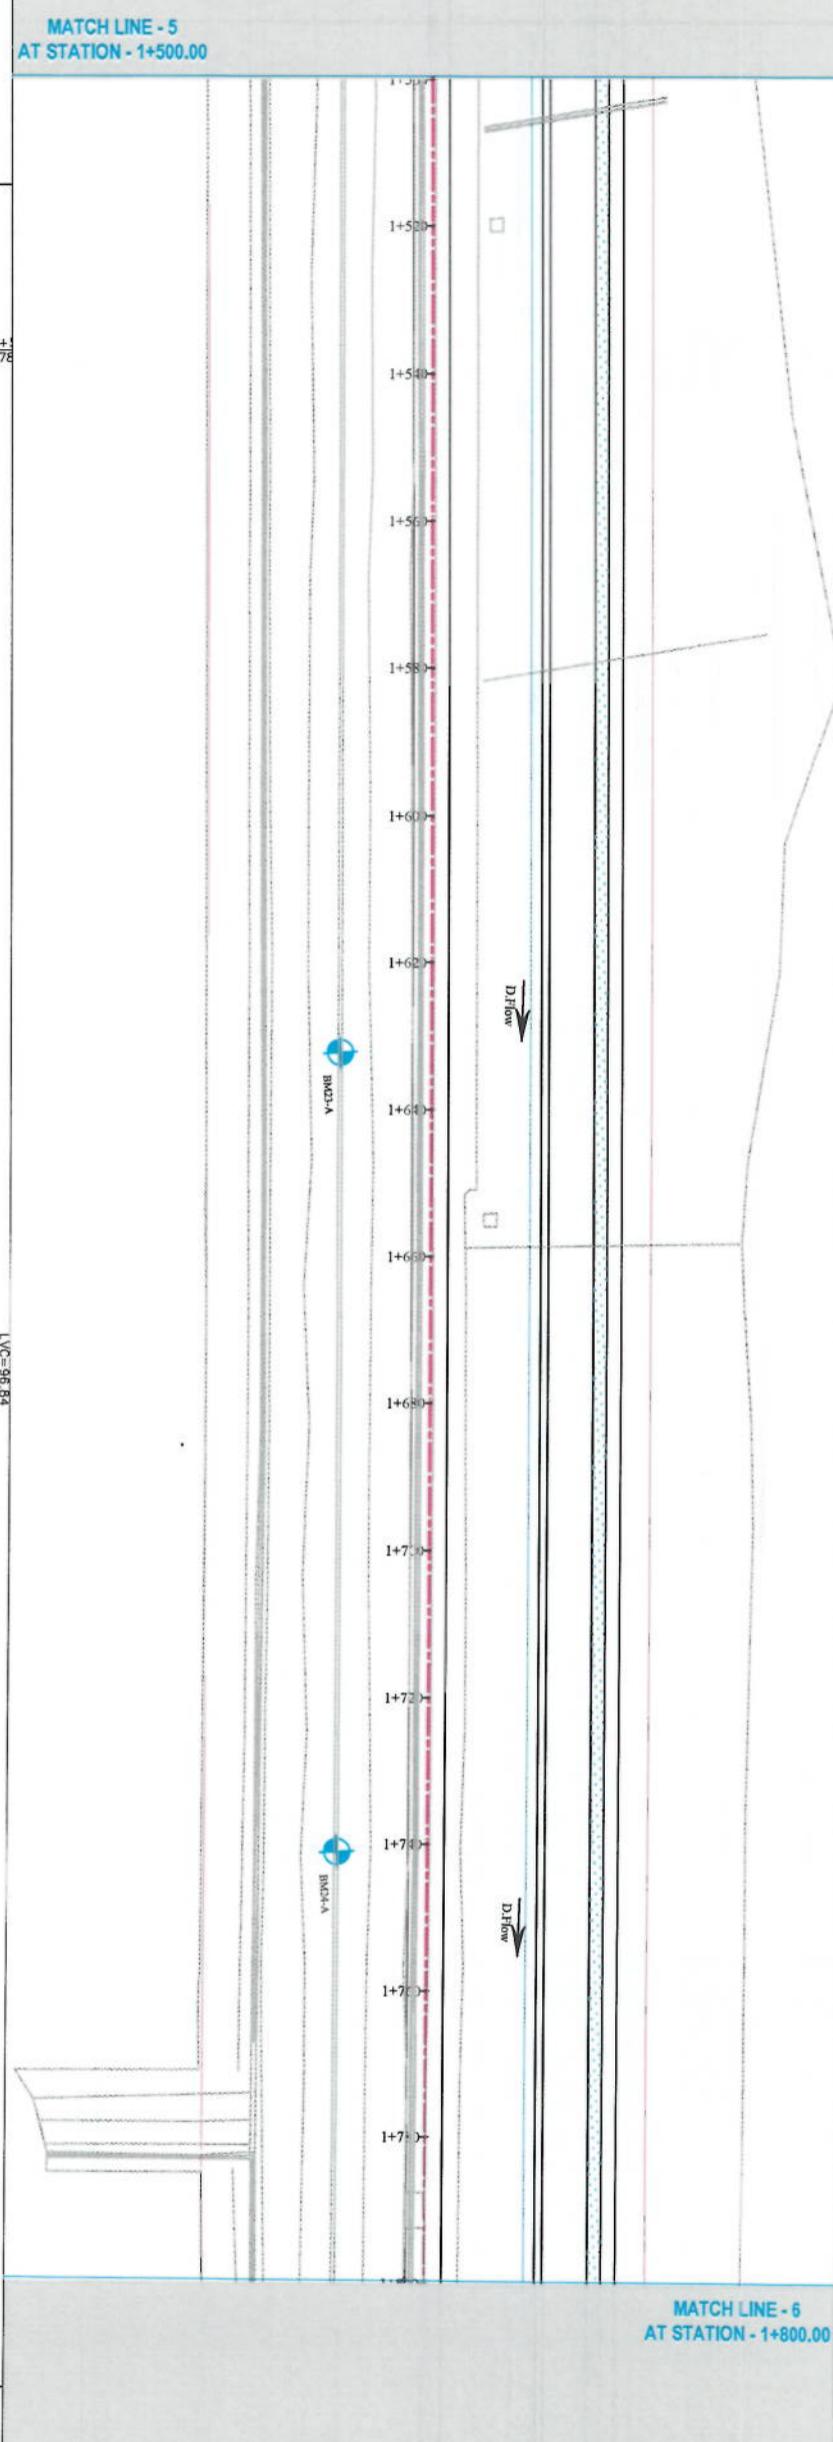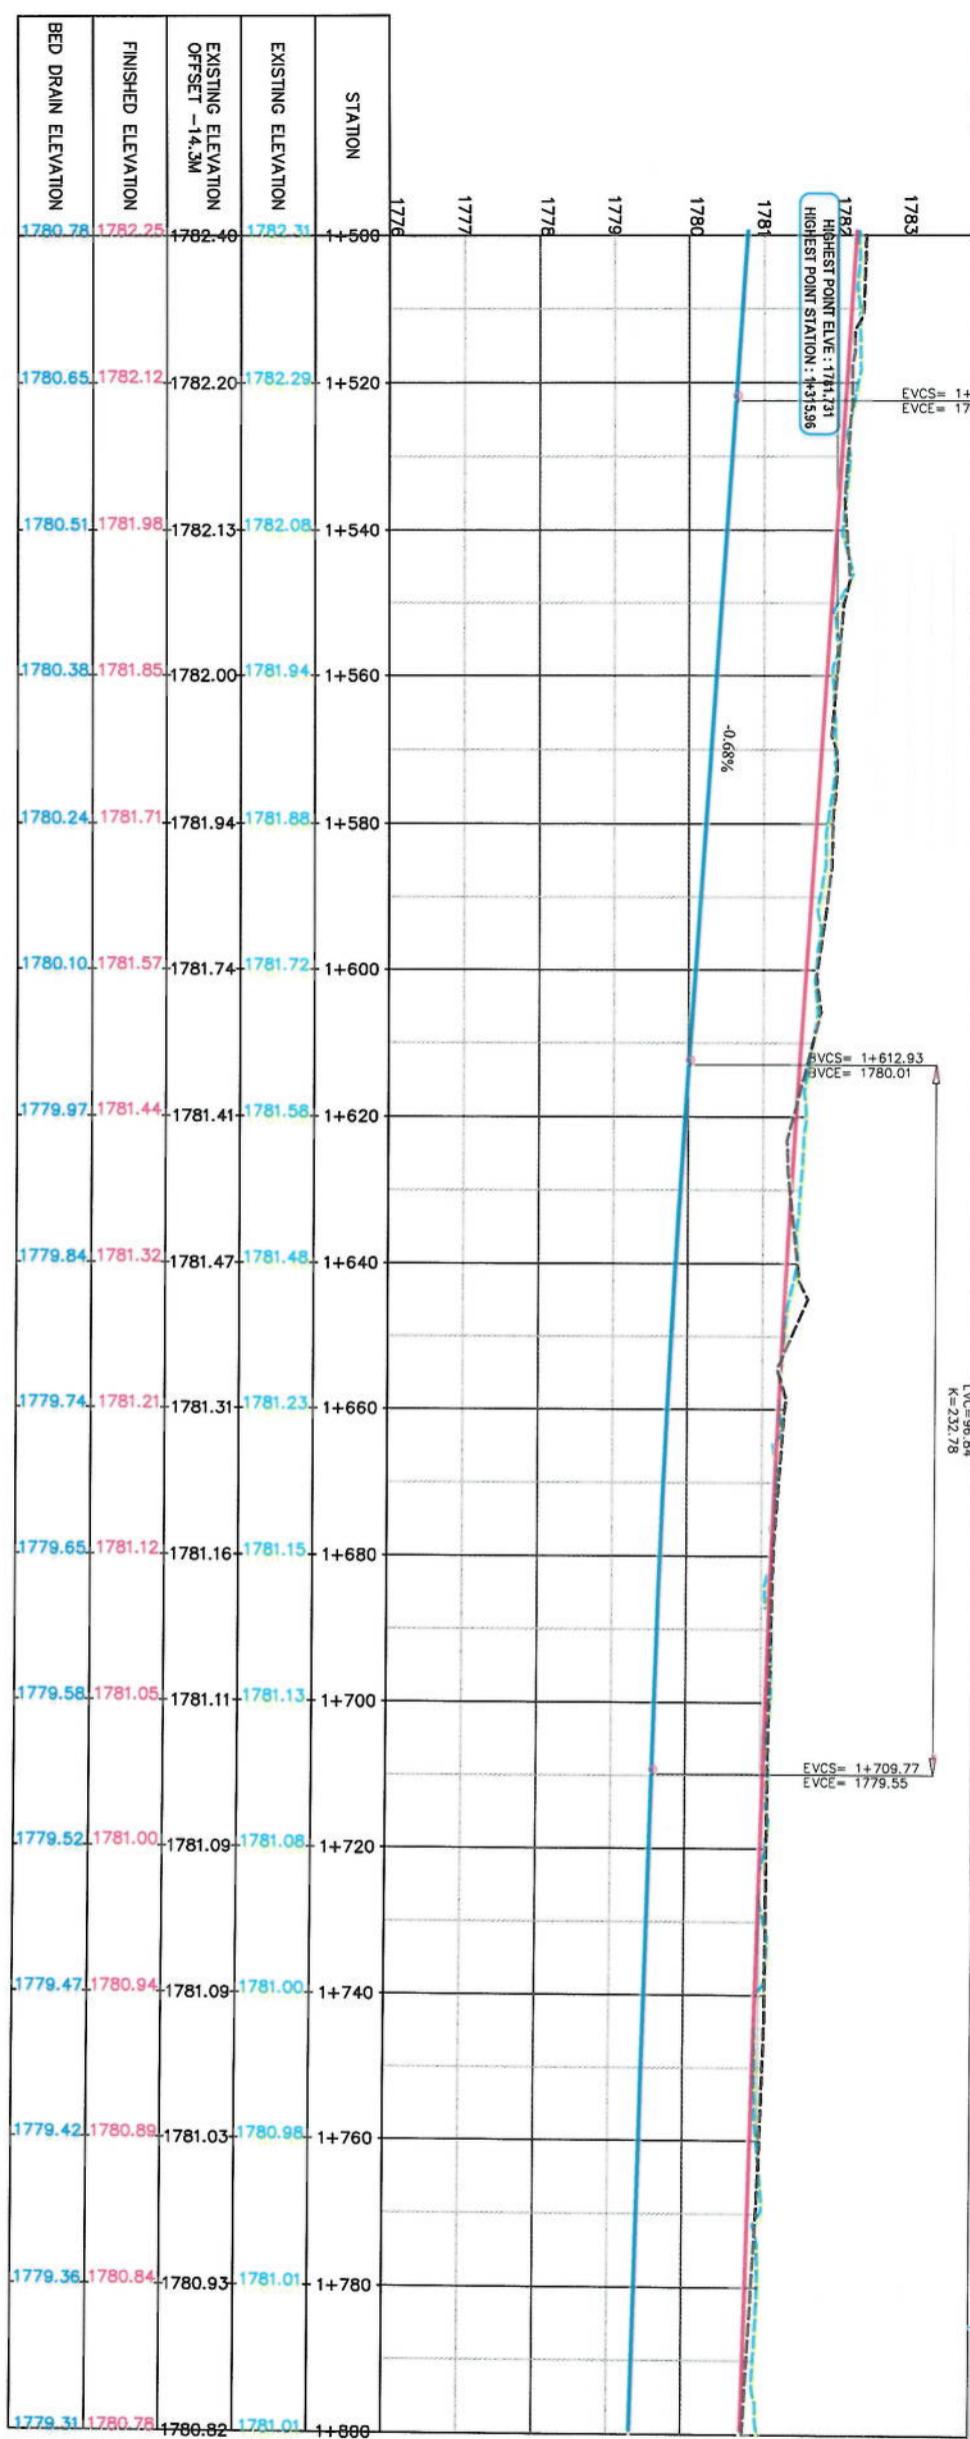

NOTE:  
1. All dimensions are in meters unless otherwise indicated.

LEGENDS

CENTER-LINE

EXISTING SURFACE

PROPOSED SIDE DITCH

SURVEY BENCHMARK

TREES & GREEN AREA

PROPOSED SIDEWALK




**MATCH LINE - 6  
AT STATION - 1+600.00**



SHEET NO. PP-06 Revision 01

Date: 5/30/2023 Saleh: 11000

Status: FINAL DESIGN

Project Code:

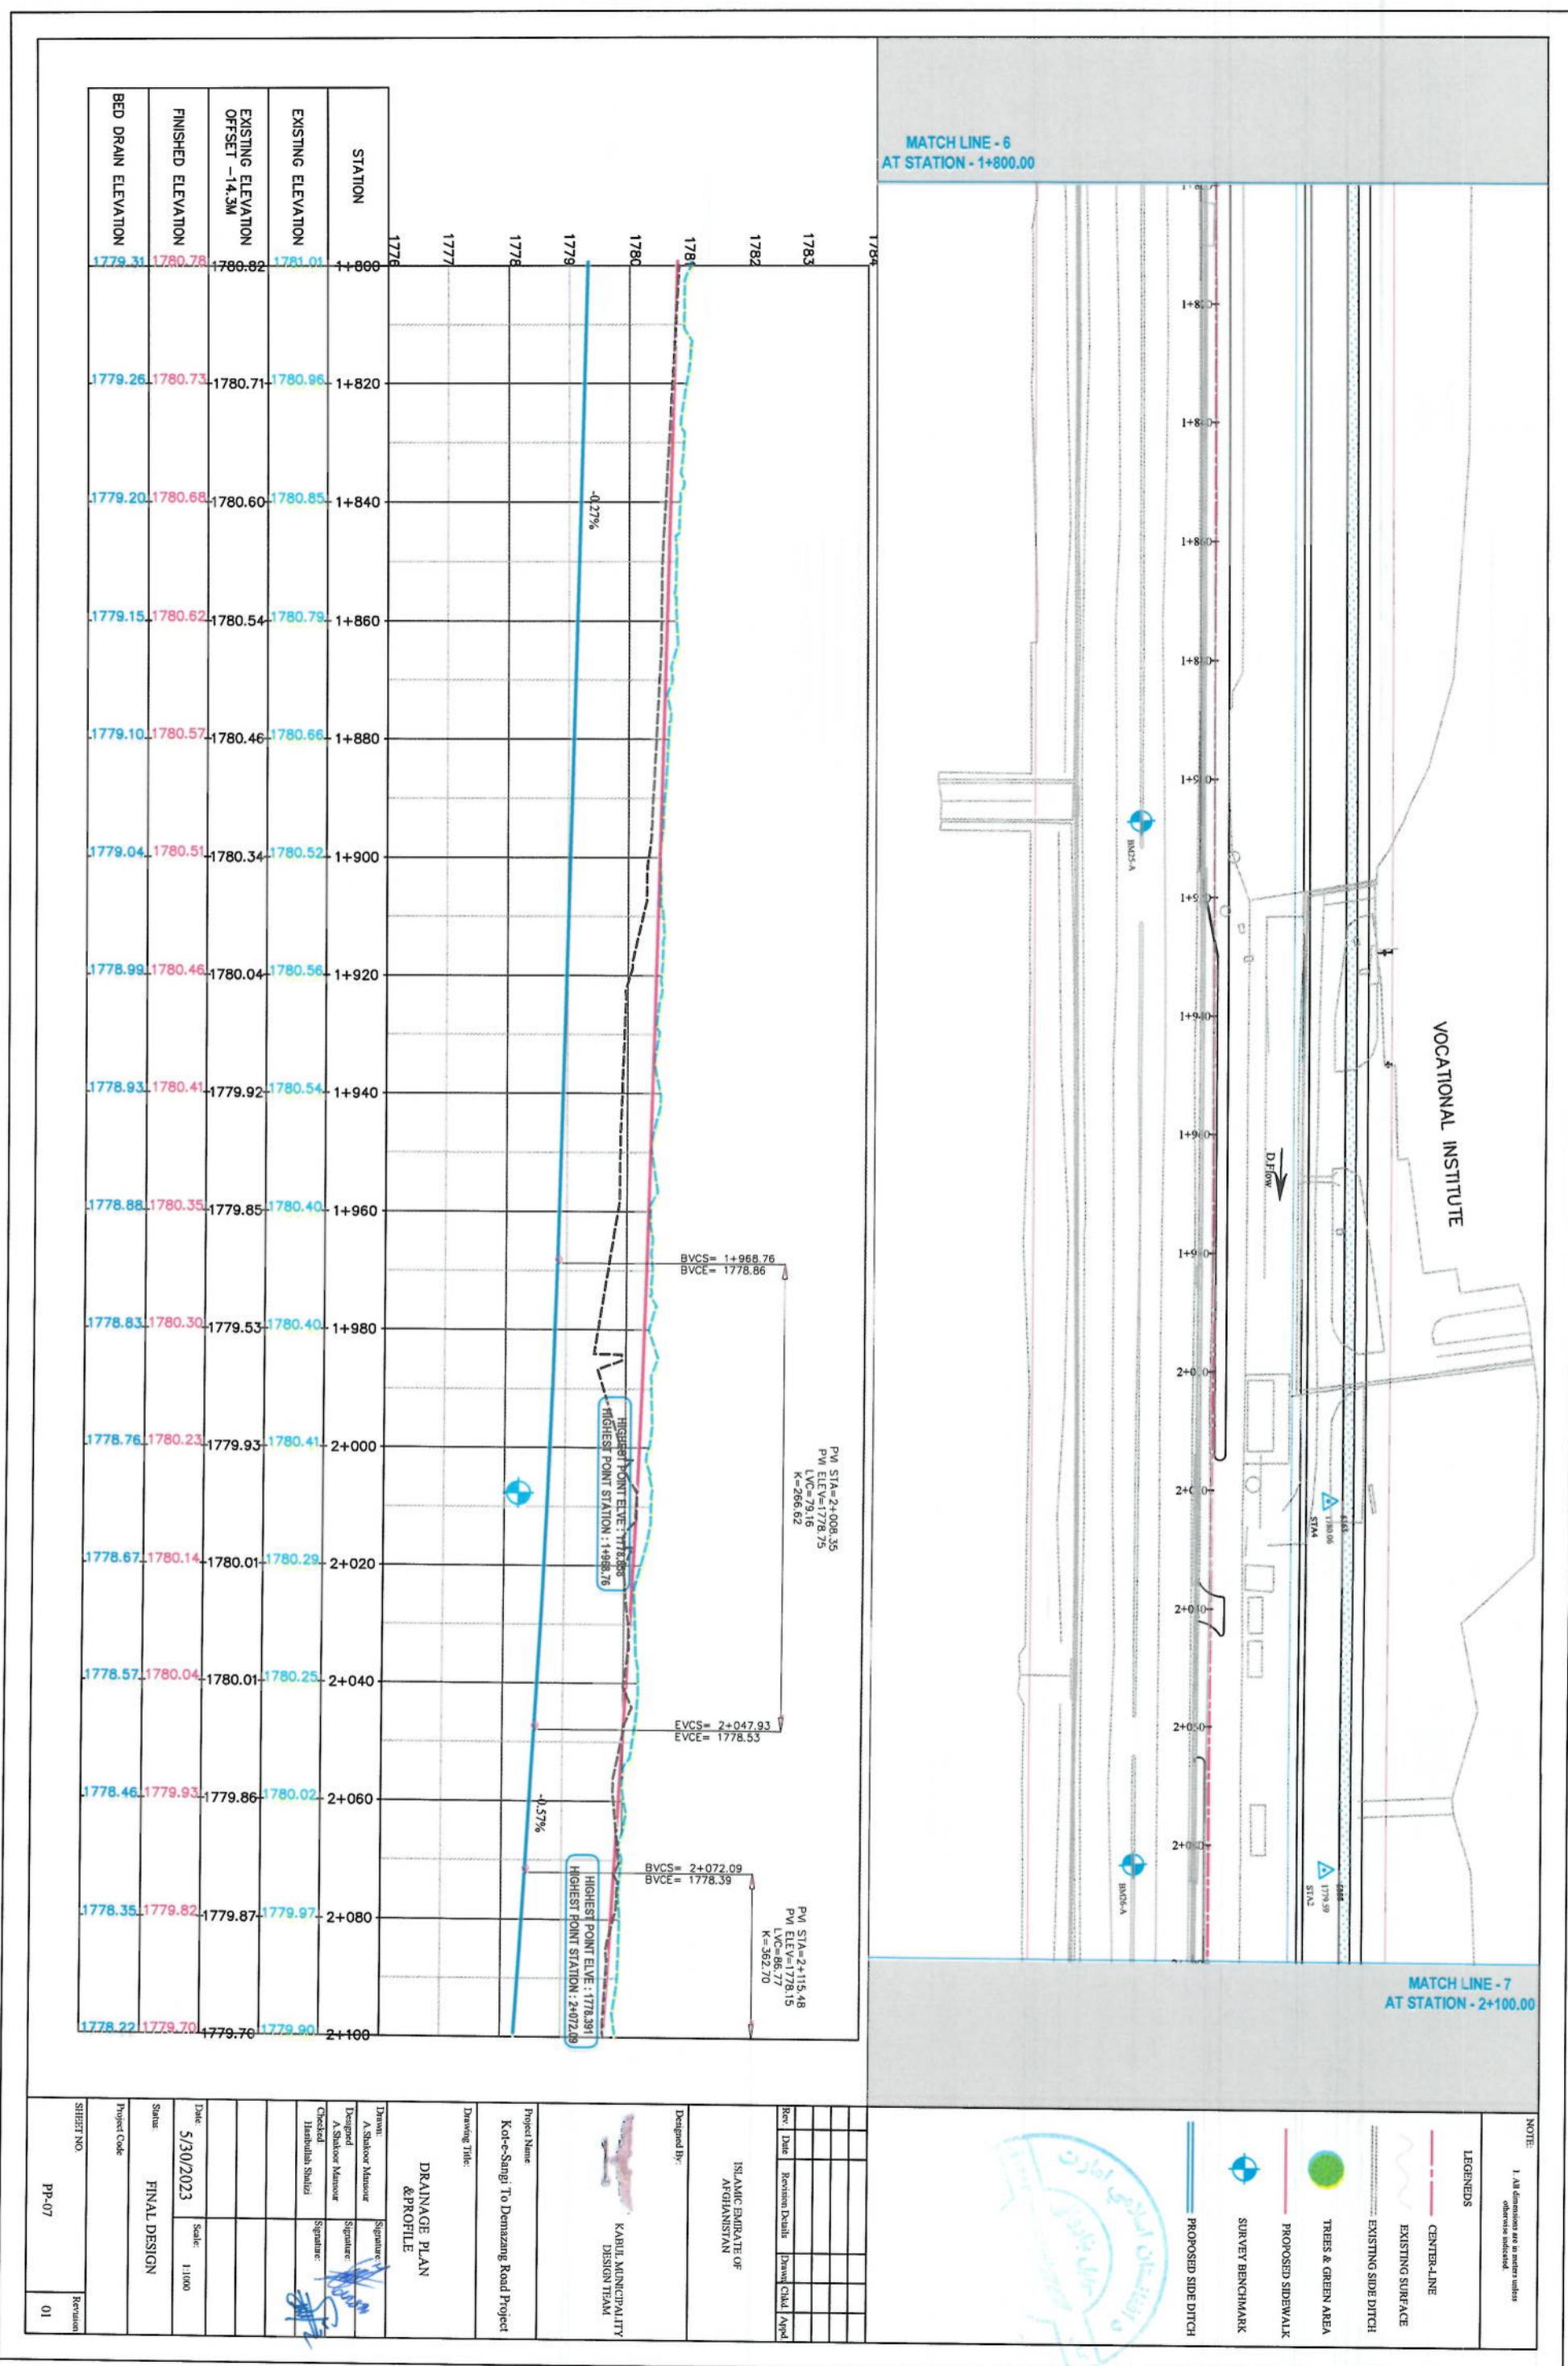


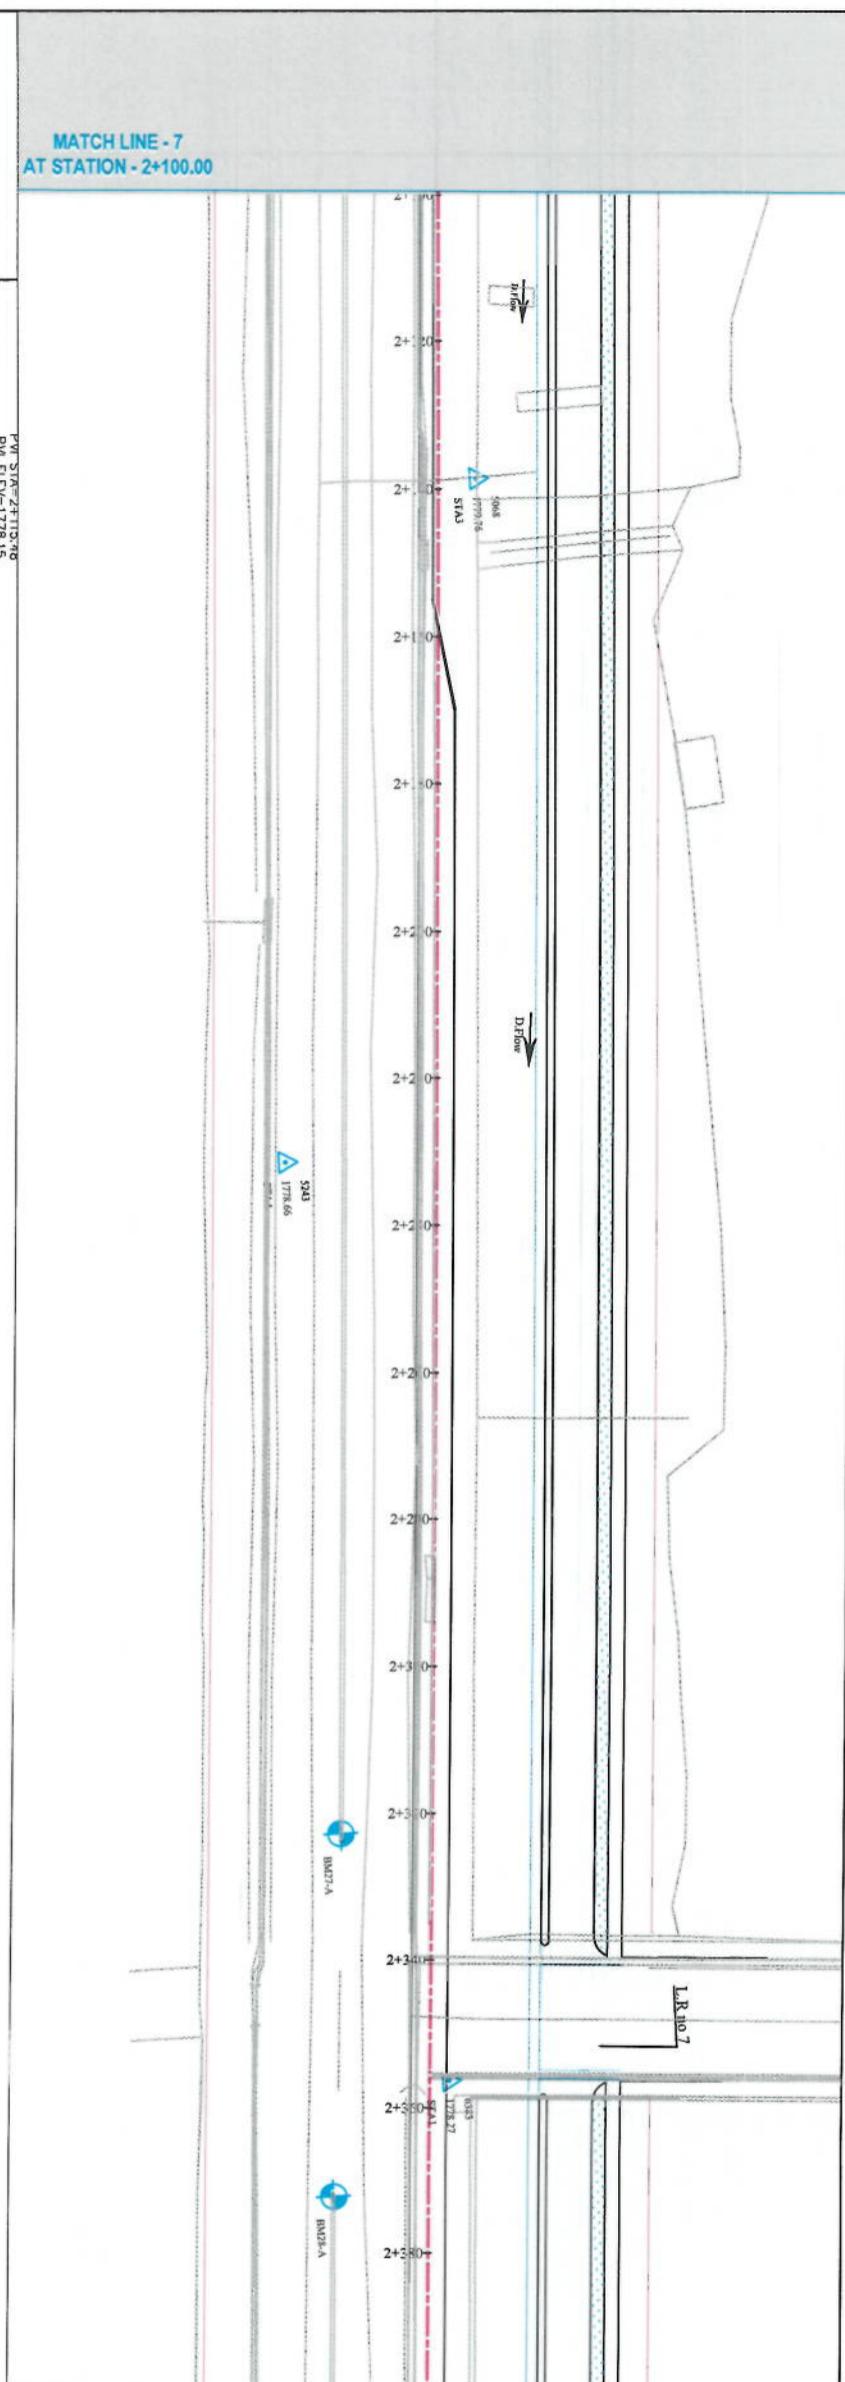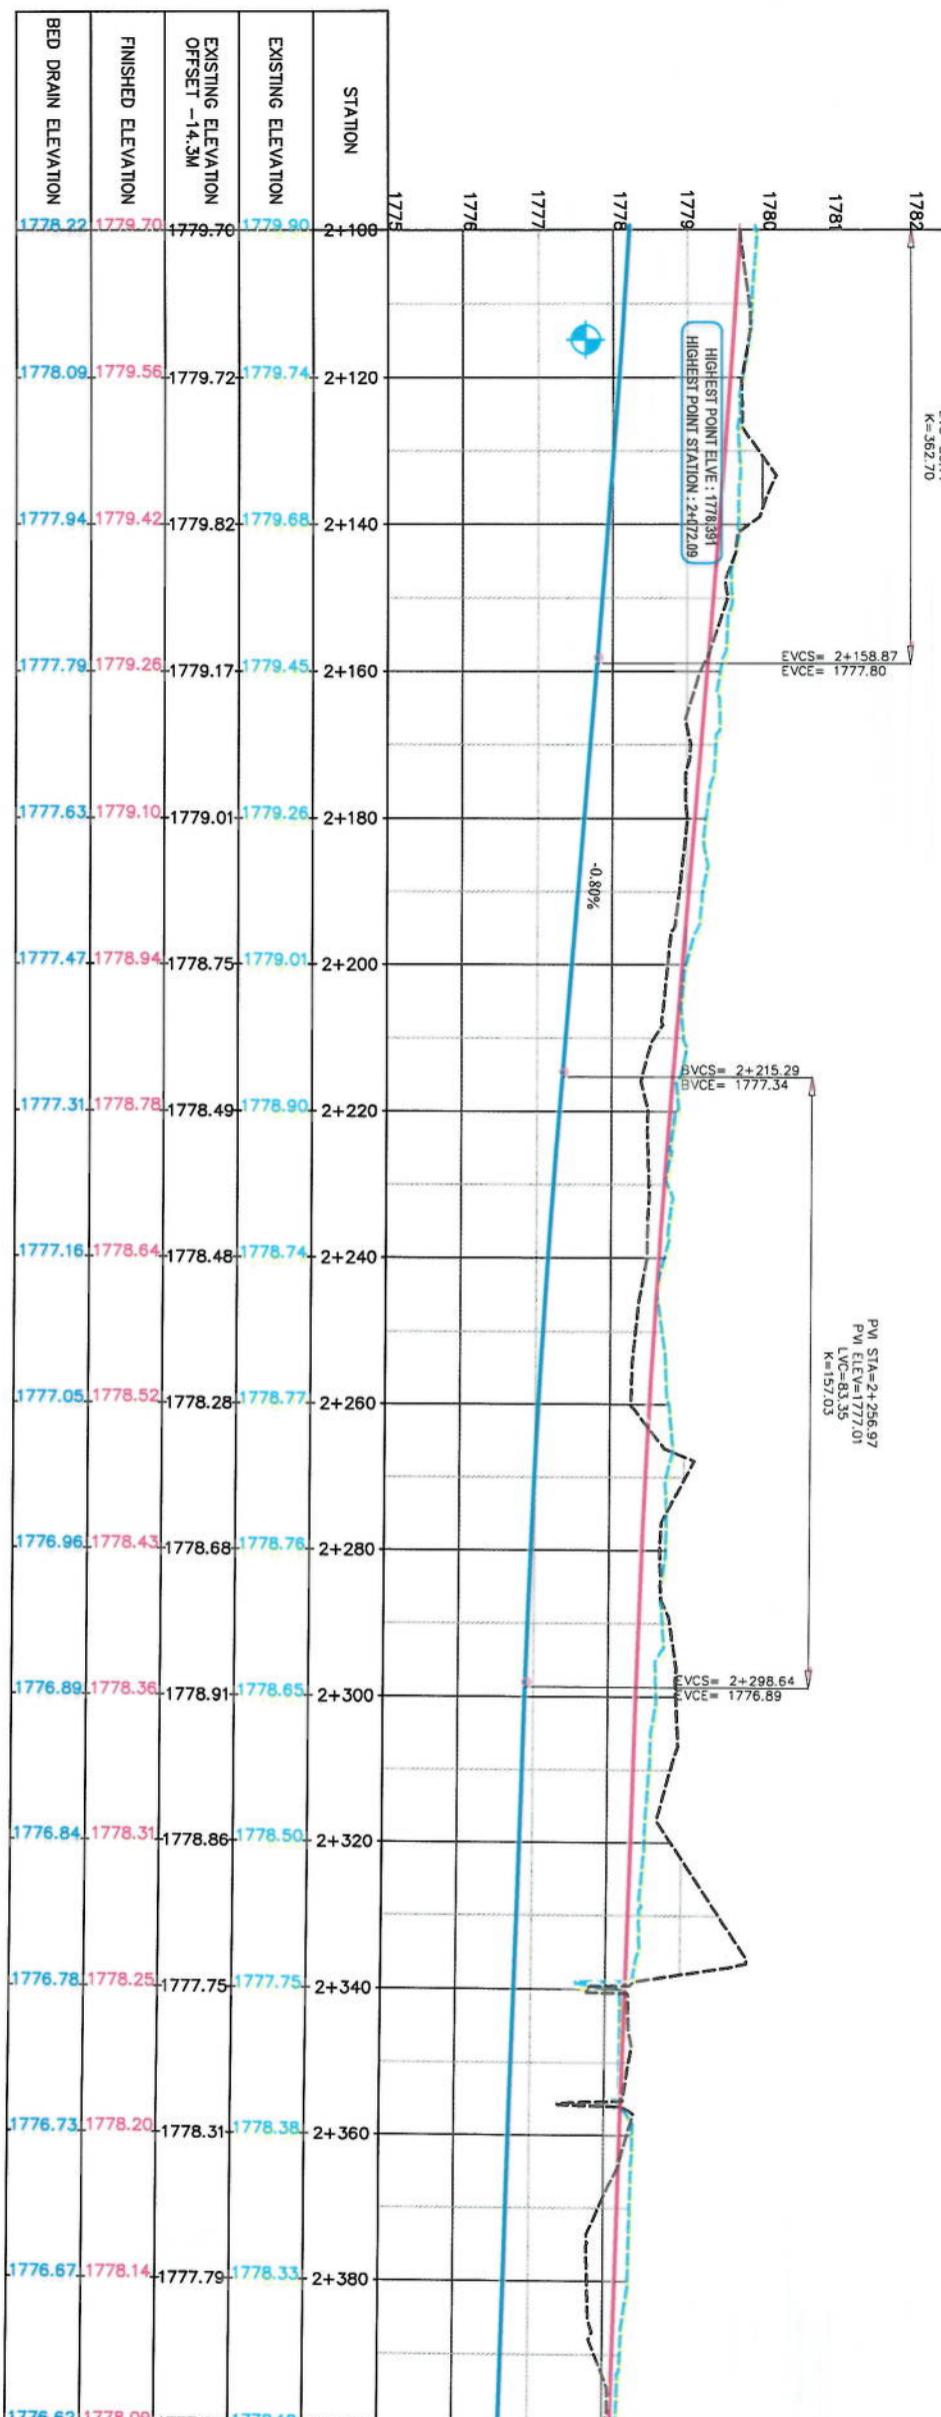


NOTE:  
1. All dimensions are in meters unless otherwise indicated.

LEGENDS					
SURVEY BENCHMARK	PROPOSED SIDE DITCH	EXISTING SURFACE	EXISTING SIDE DITCH	PROPOSED SIDEWALK	TREES & GREEN AREA
BM27-A	BM28-A	BM29-A	BM30-A	BM31-A	L.R.10.7
BM27-A	BM28-A	BM29-A	BM30-A	BM31-A	BM32-A
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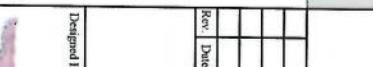
Drawn By:	Signature:
A. Shaboor Mansour	Signature:
Designed By:	Signature:
A. Shaboor Mansour	Signature:
Checked By:	Signature:
Hishamullah Shafiqzai	Signature:
Date:	Scale:
5/30/2023	1:1000
Status:	FINAL DESIGN
Project Code:	
SHEET NO.	PP-08
Revision:	01



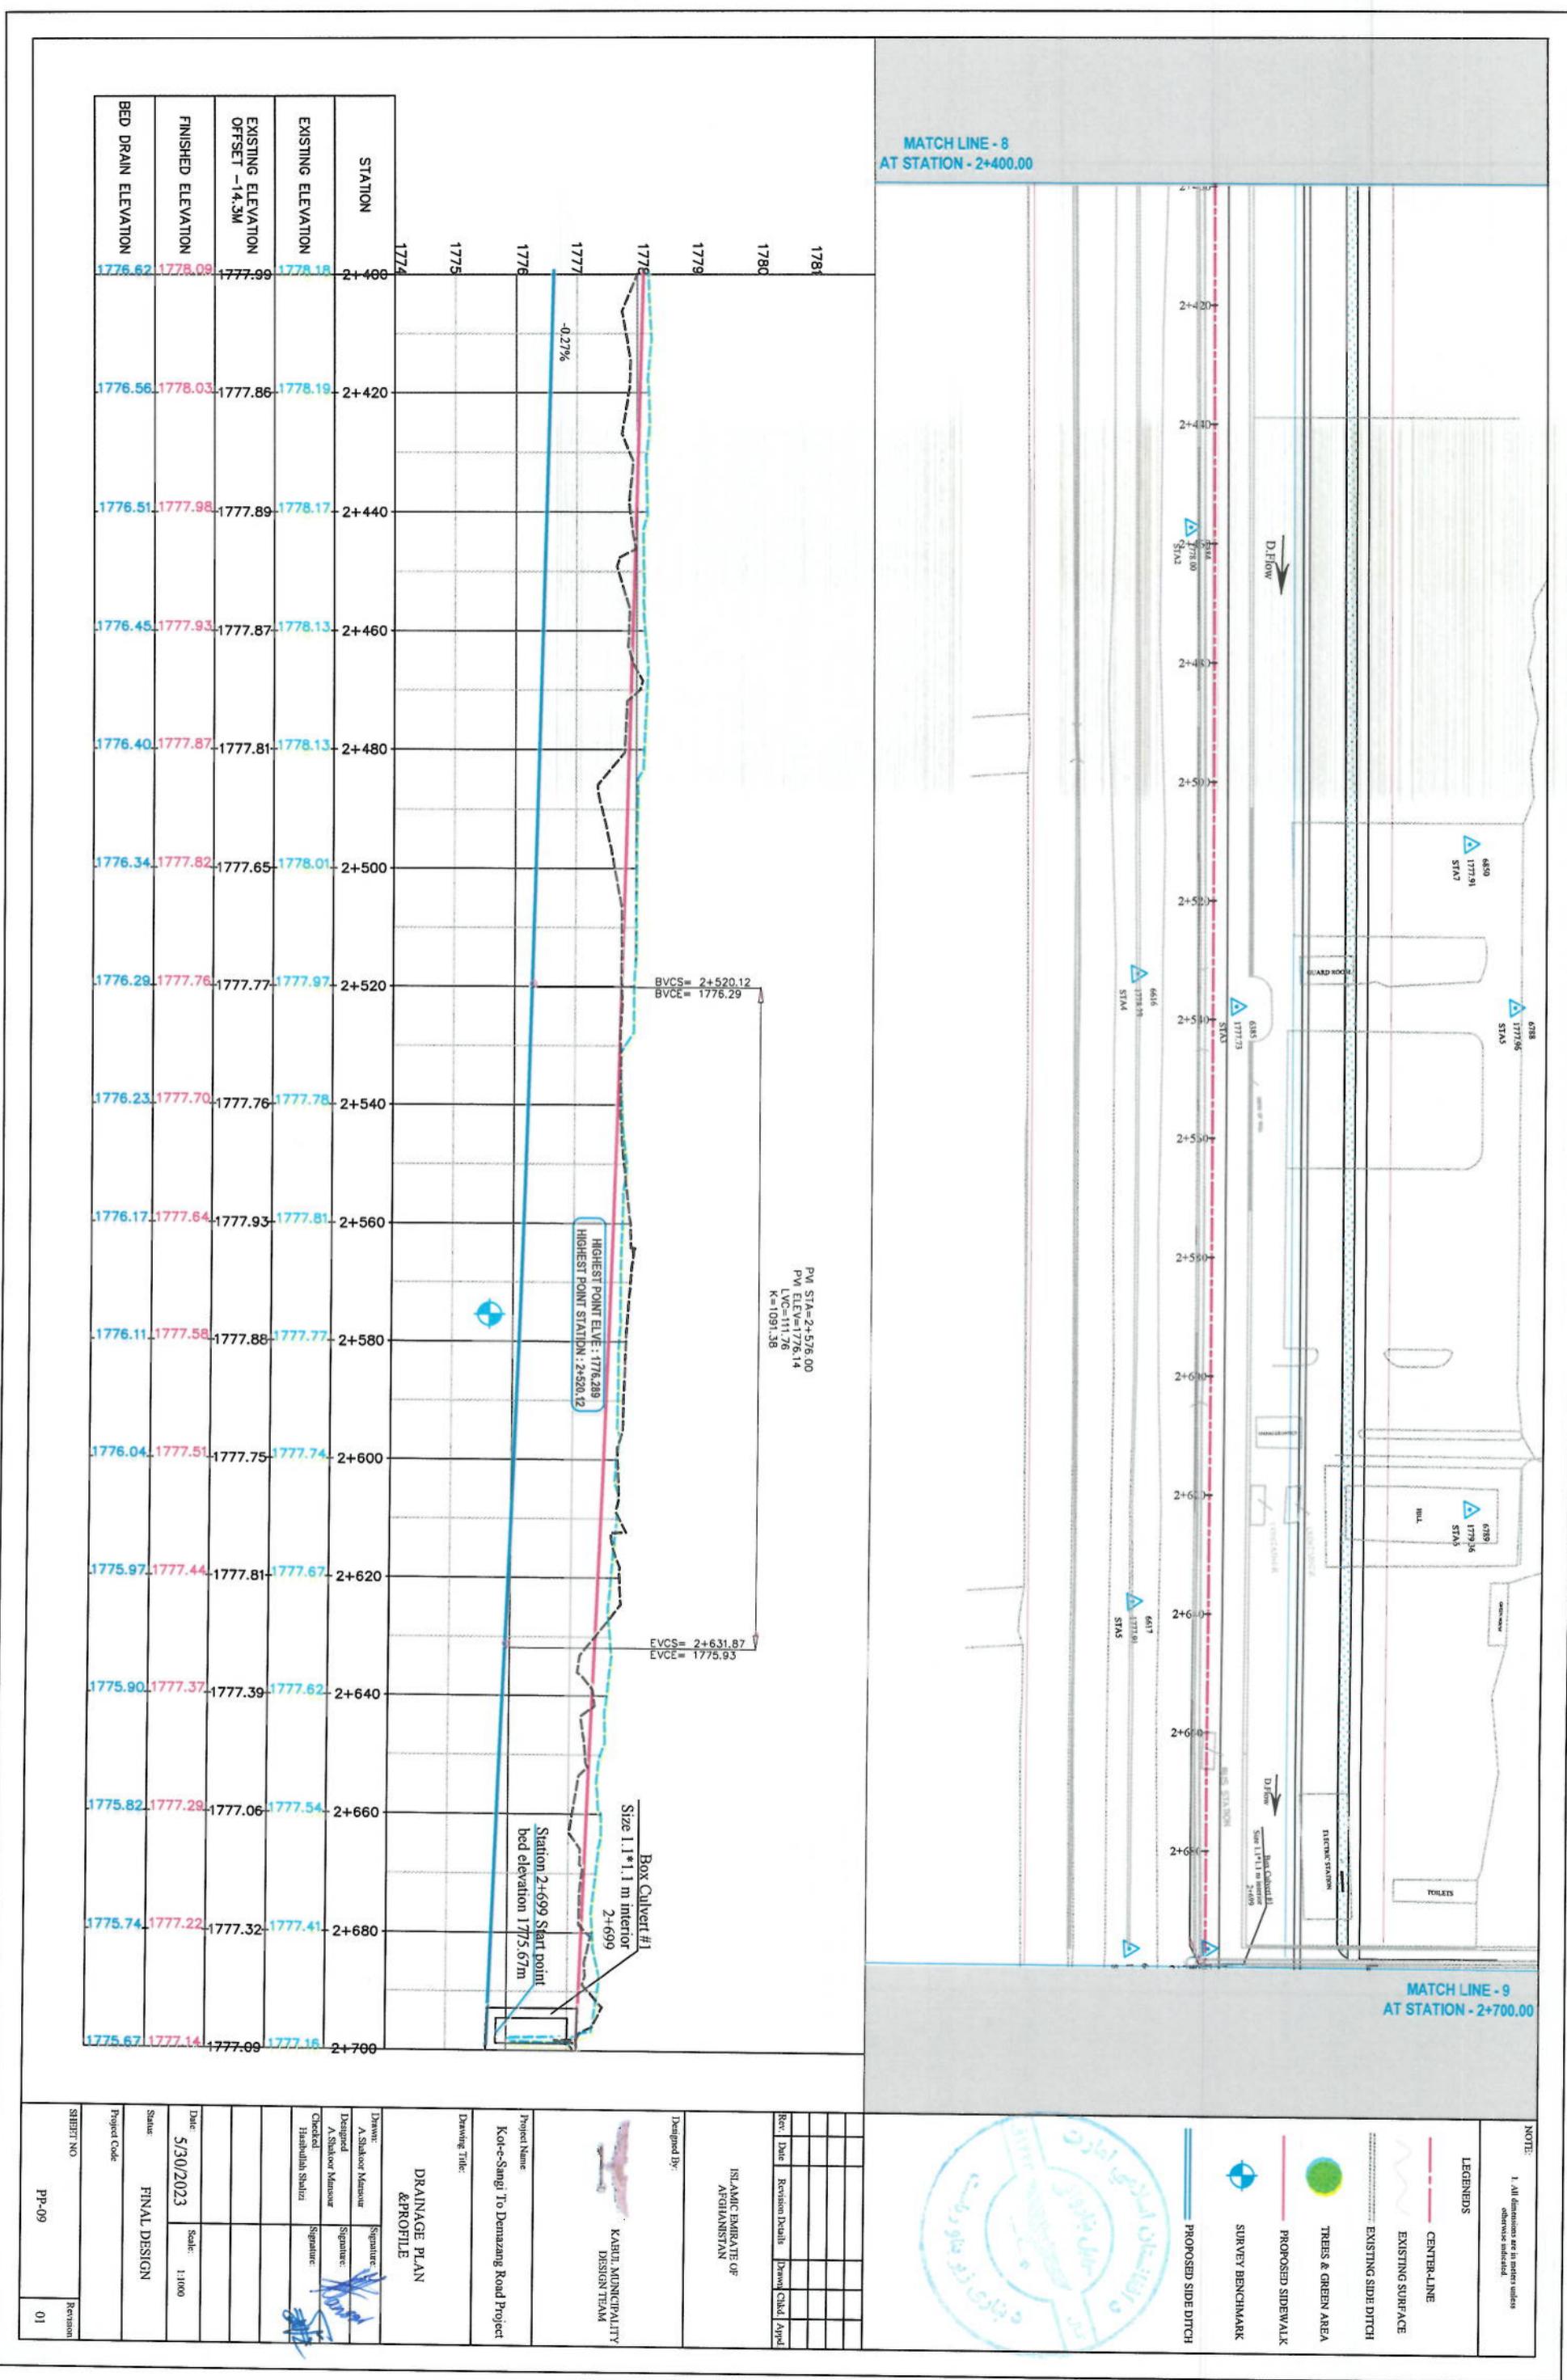

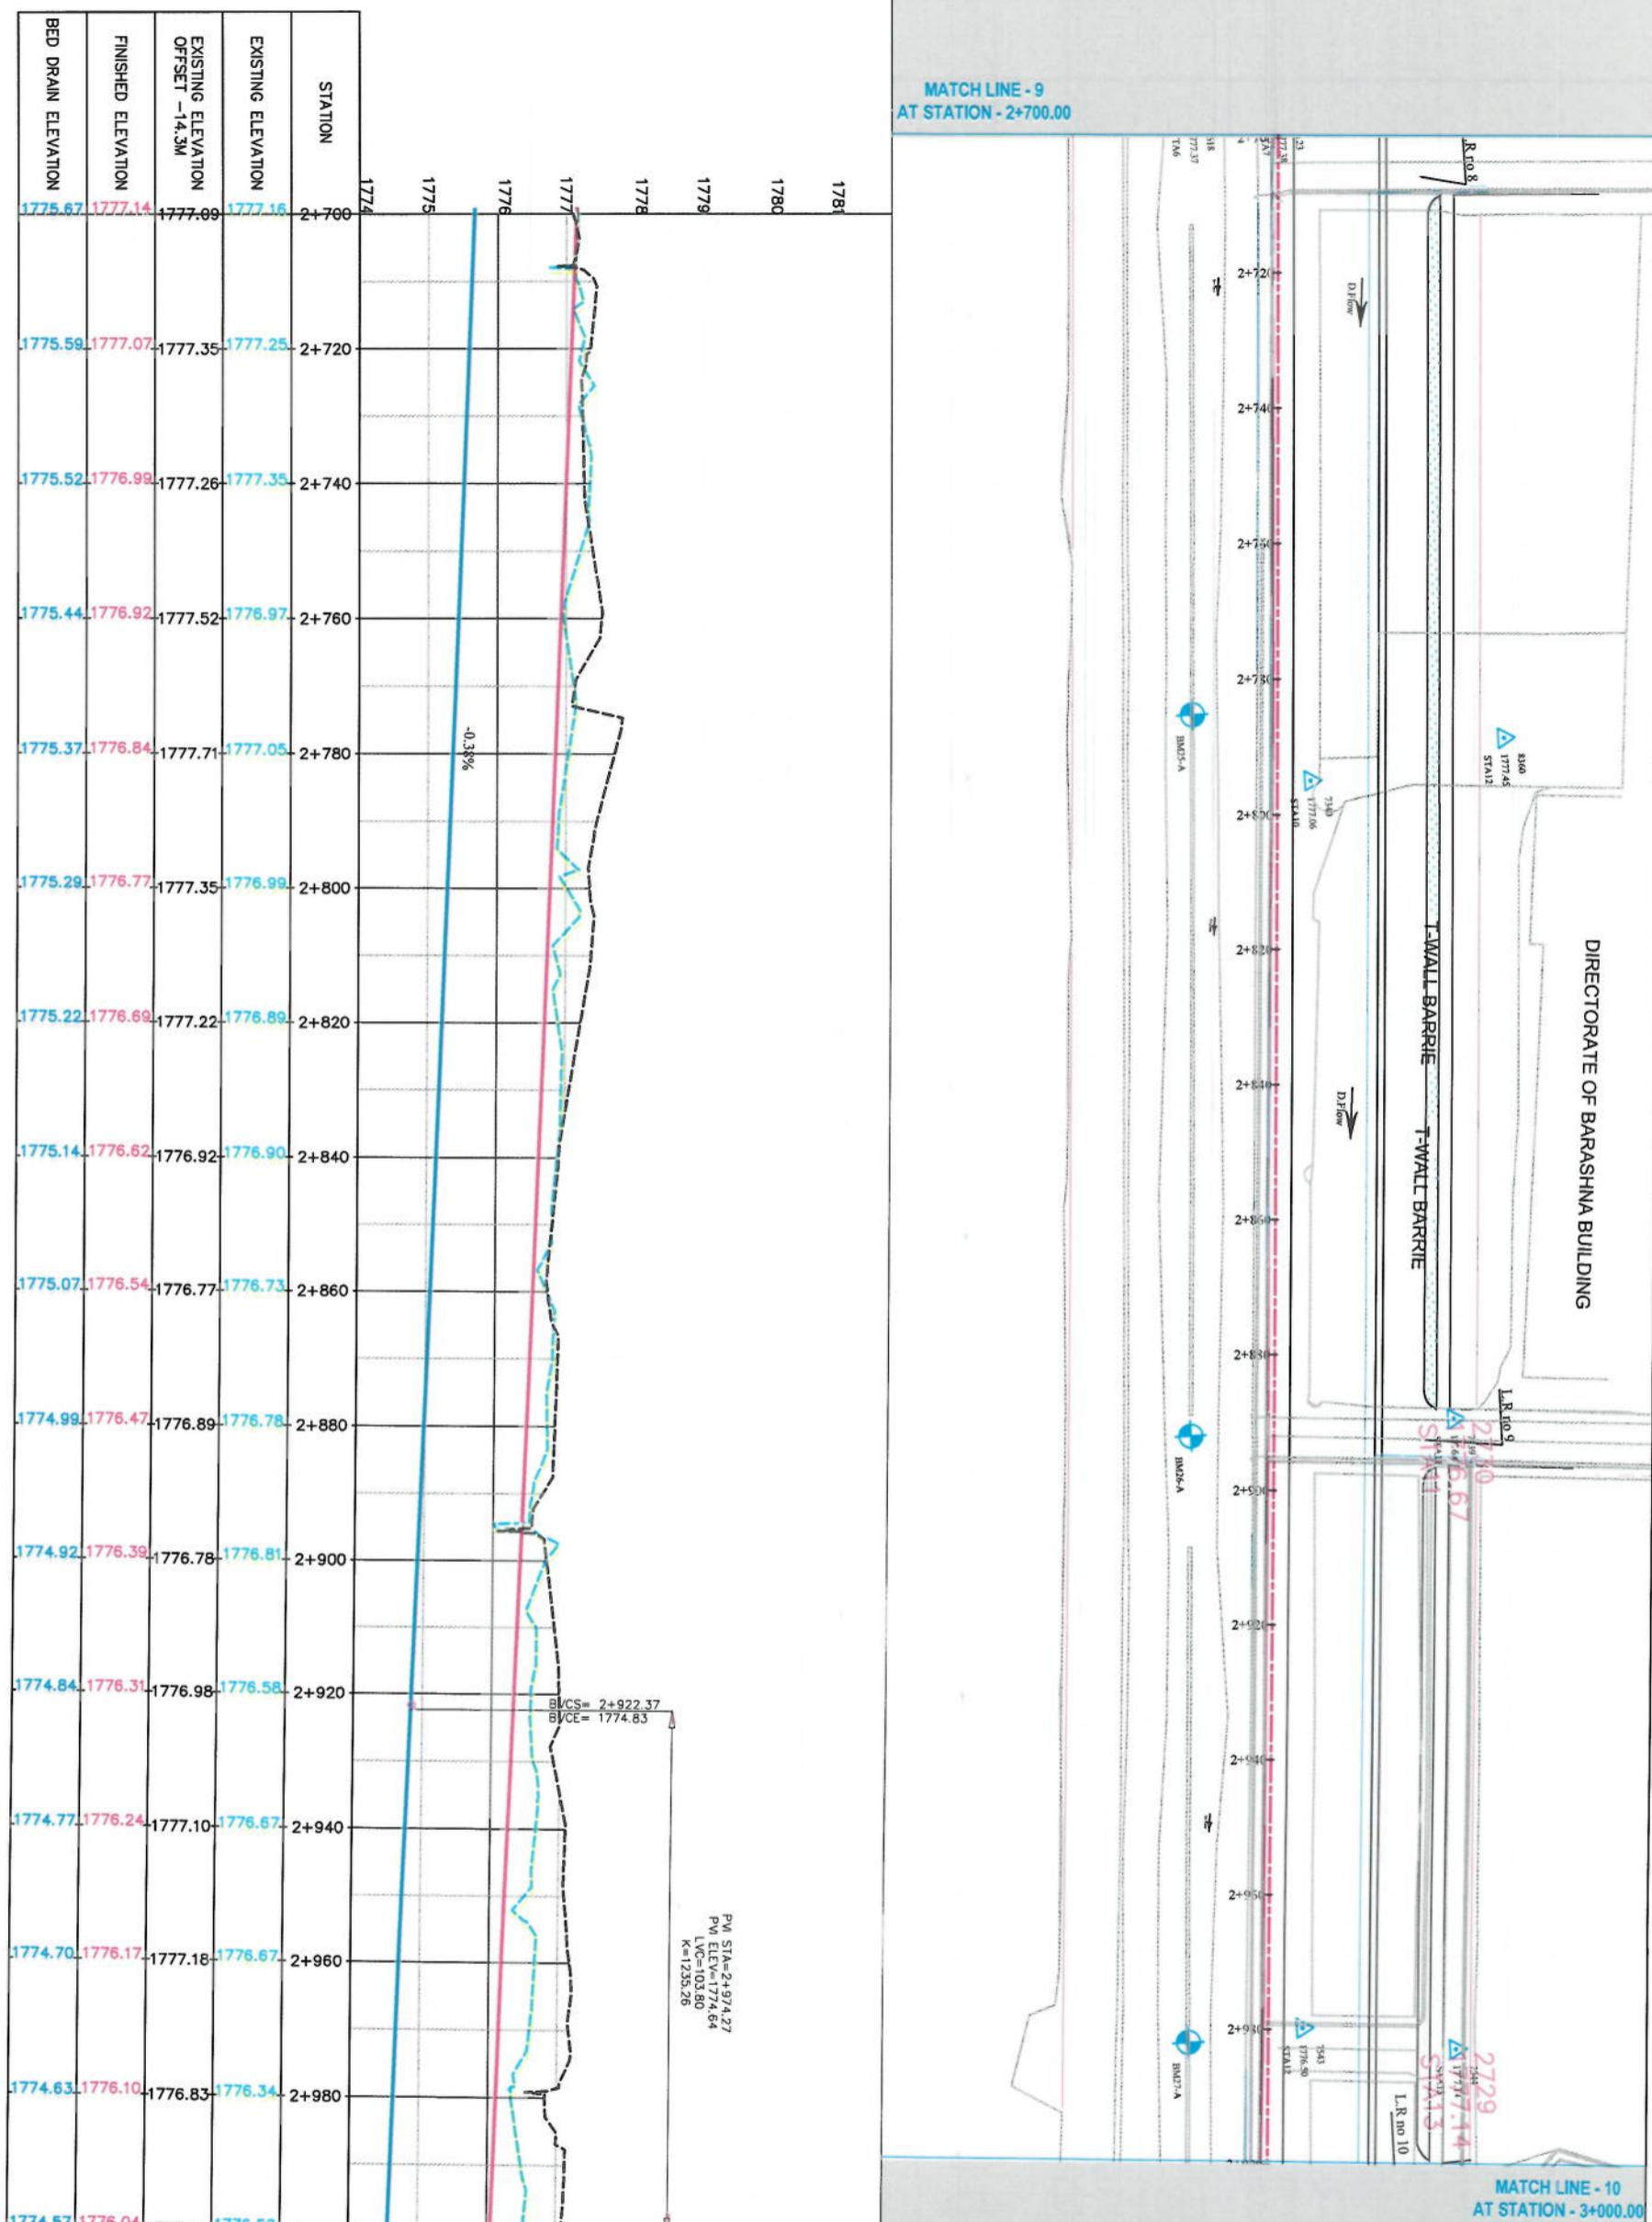NOTE

ALL DIMENSIONS ARE IN MILLIMETERS



LEGENDS				
	CENTER-LINE			
	EXISTING SURFACE			
	PROPOSED SIDE DITCH			
	TREES & GREEN AREA			
	SURVEY BENCHMARK			
<b>PROPOSED SIDE DITCH</b>				
Rev.	Revision Details	Drawn	Chkd.	Ayed
<p align="center"><b>ISLAMIC EMIRATE OF AFGHANISTAN</b></p>  <p align="center">KABUL MUNICIPALITY DESIGN TEAM</p>				
<p>Designed By:</p> <p><b>Kot-e-Sang'i To Demazang Road Project</b></p> <p>Drawing Title:</p> <p align="center"><b>DRAINAGE PLAN &amp; PROFILE</b></p>				
Drawn:	A. Shakoor Mansour	Signature:		
Designed	A. Shakoor Mansour	Signature:		
Checked	Habibullah Shabizi	Signature:		
Date:	5/30/2023	Scale:	1:1000	
Status:	FINAL DESIGN			
Project Code:				
SHEET NO.	PP-10		Revision 01	

## DIRECTORATE OF TRAFFIC

NOTE:  
1. All dimensions are in meters unless otherwise indicated.

## LEGENDS

- CENTER-LINE
- EXISTING SURFACE
- PROPOSED SIDEWALK
- SURVEY BENCHMARK

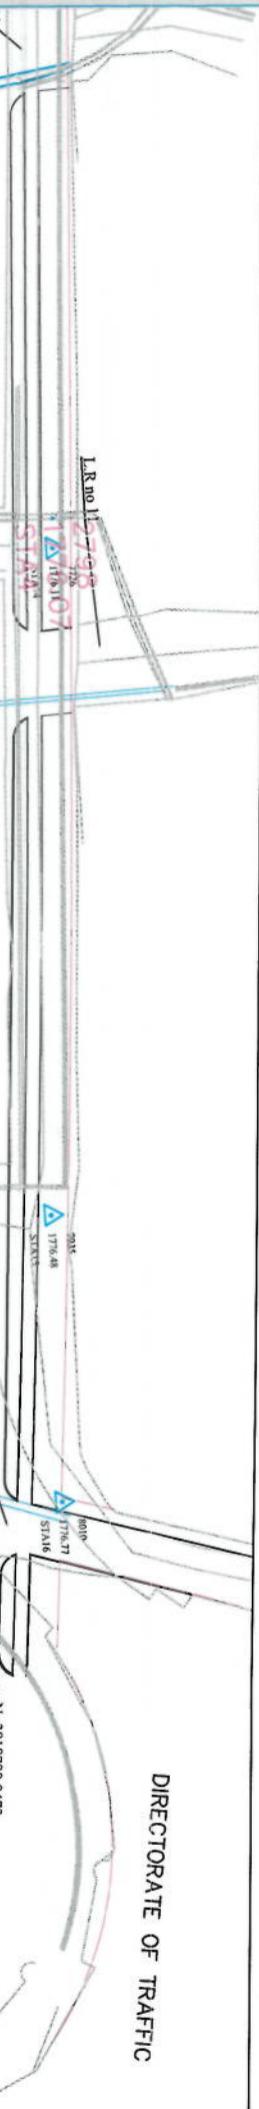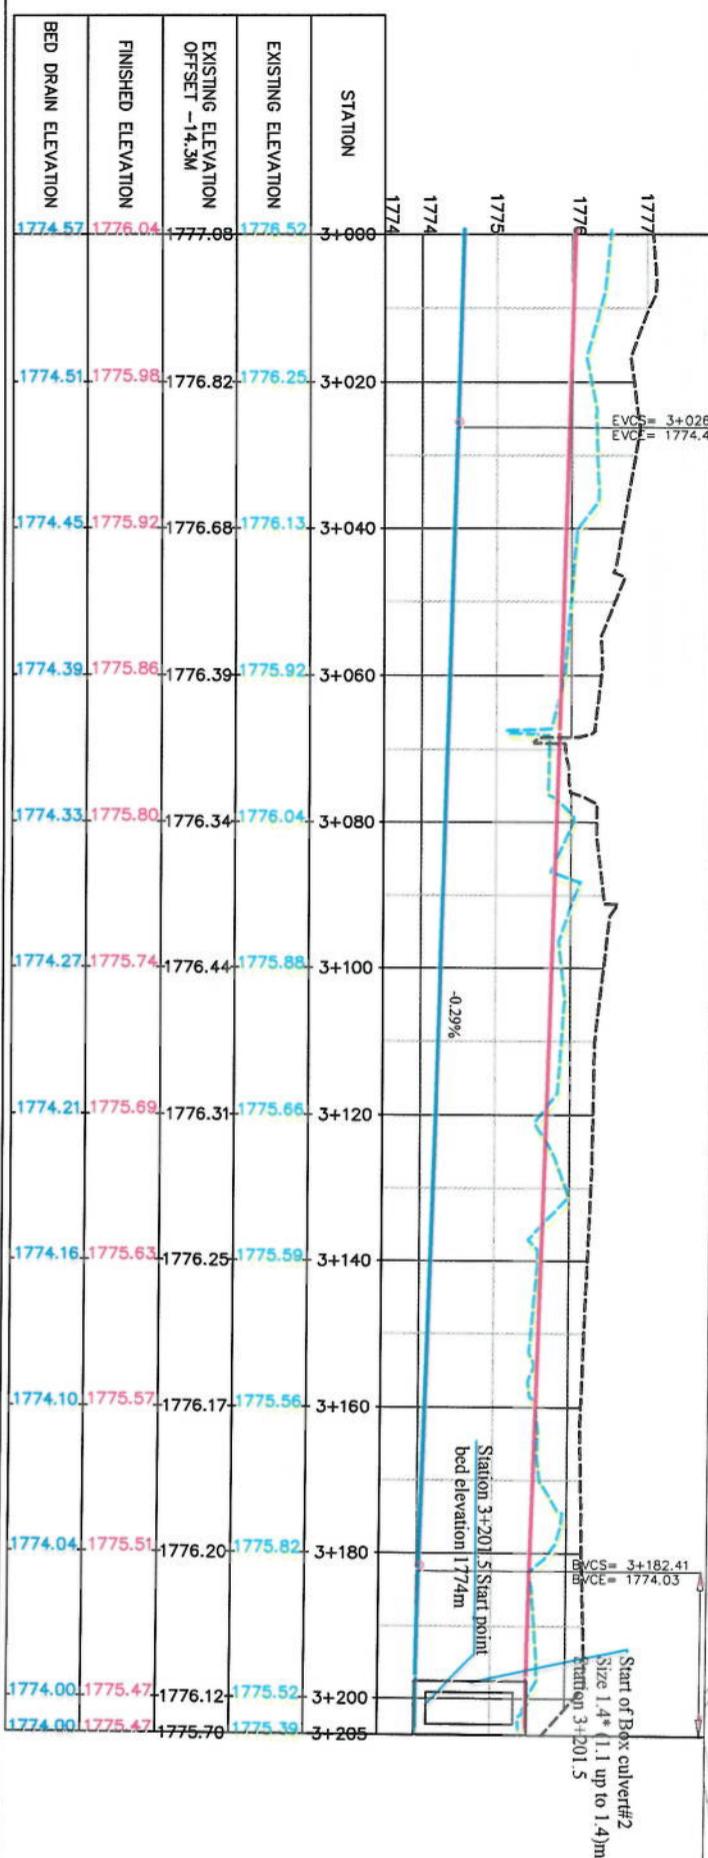MATCH LINE - 10  
AT STATION - 3+000.00

KABUL MUNICIPALITY DESIGN TEAM

Project Name:  
Koh-e-Sangi To Demazang Road Project

Drawing Title:

DRAINAGE PLAN  
& PROFILEDrawn: A. Shaboor Mansour  
Designed: A. Shaboor Mansour  
Checked: Hasibullah Shahizi

Rev. Date Revision Details Drawn Chkd Appd

ISLAMIC EMIRATE OF  
AFGHANISTANDesigned By:  

BED DRAIN ELEVATION

FINISHED ELEVATION

EXISTING ELEVATION OFFSET -14.3M

BED DRAIN ELEVATION

1774.57 1776.04

1774.45 1775.92

1774.39 1775.86

1774.33 1775.80

1774.27 1775.74

1774.21 1775.69

1774.16 1775.63

1774.10 1775.57

1774.04 1775.51

1774.00 1775.47

1774.00 1775.47

1774.51 1775.98

1774.45 1775.92

1774.39 1775.86

1774.33 1775.80

1774.27 1775.74

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1774.16 1775.63

1774.10 1775.57

1774.04 1775.51

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1774.57 1776.04

1774.45 1775.92

1774.39 1775.86

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1774.04 1775.51

1774.00 1775.47

1774.51 1775.98

1774.45 1775.92

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1774.57 1776.04

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1774.04 1775.51

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1774.45 1775.92

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1774.04 1775.51

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1774.57 1776.04

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1774.04 1775.51

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1774.21 1775.69

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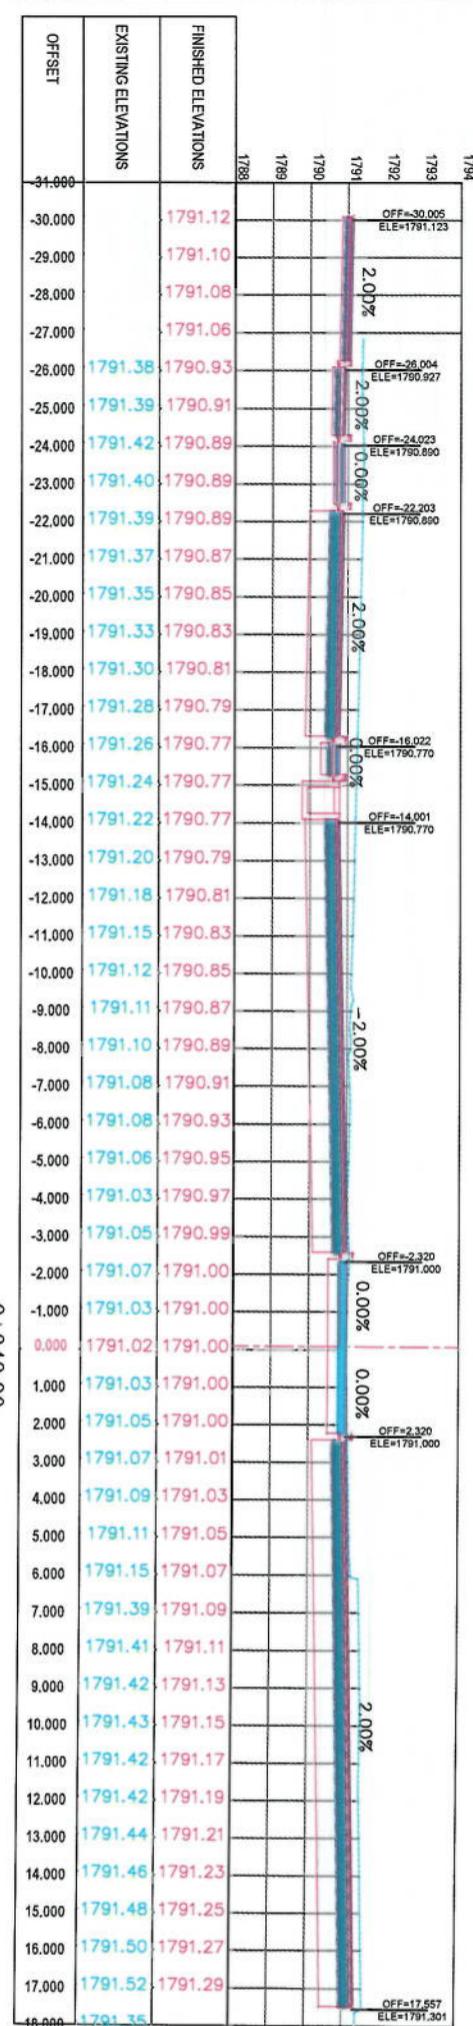
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1774.33 1775.


## NOTE:

1. All dimensions are in meters unless otherwise marked

LEGENDS	
	CENTER-LINE
	EXISTING SURFACE
	EXISTING SIDE DITCH



0+040.00

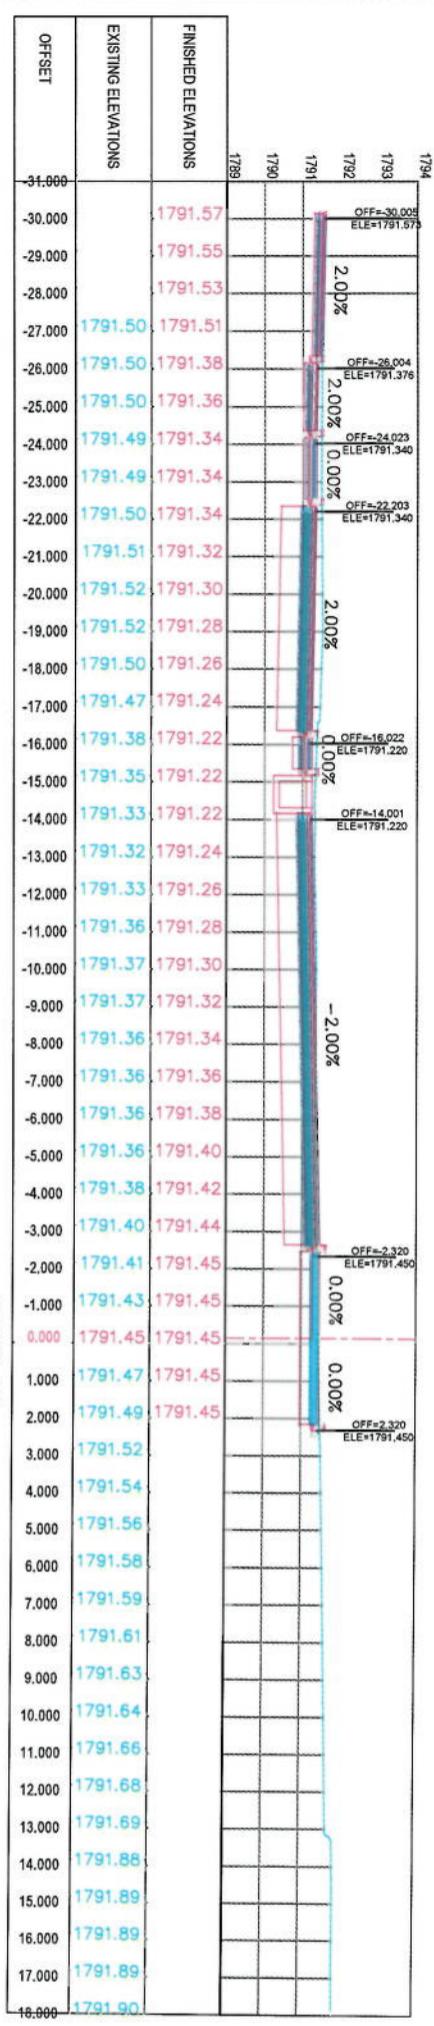

0+020.00

## CROSS SECTIONS

Designed by:  
Colo-Sang To Demzang  
Road Project

Project Name:  
KABUL MUNICIPALITY  
Client:  
ISLAMIC EMIRATE OF AFGHANISTAN  
KABUL MUNICIPALITY  
Designed by:  
KABUL MUNICIPALITY DESIGN TEAM  
Checked by:  
Hannanullah Sardar  
Signature:



Drawing Title:  
FINAL DESIGN




Drawing Number: CS-1 Revision: 00  
Date: 6/7/2023 Scale: 1:200  
Status: FINAL DESIGN  
Project Code:

## NOTE:

1. All dimensions are in meters unless otherwise indicated


## LEGENDS

 CENTER-LINE  
 EXISTING SURFACE  
 EXISTING SIDE DITCH

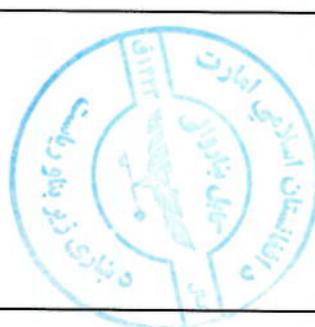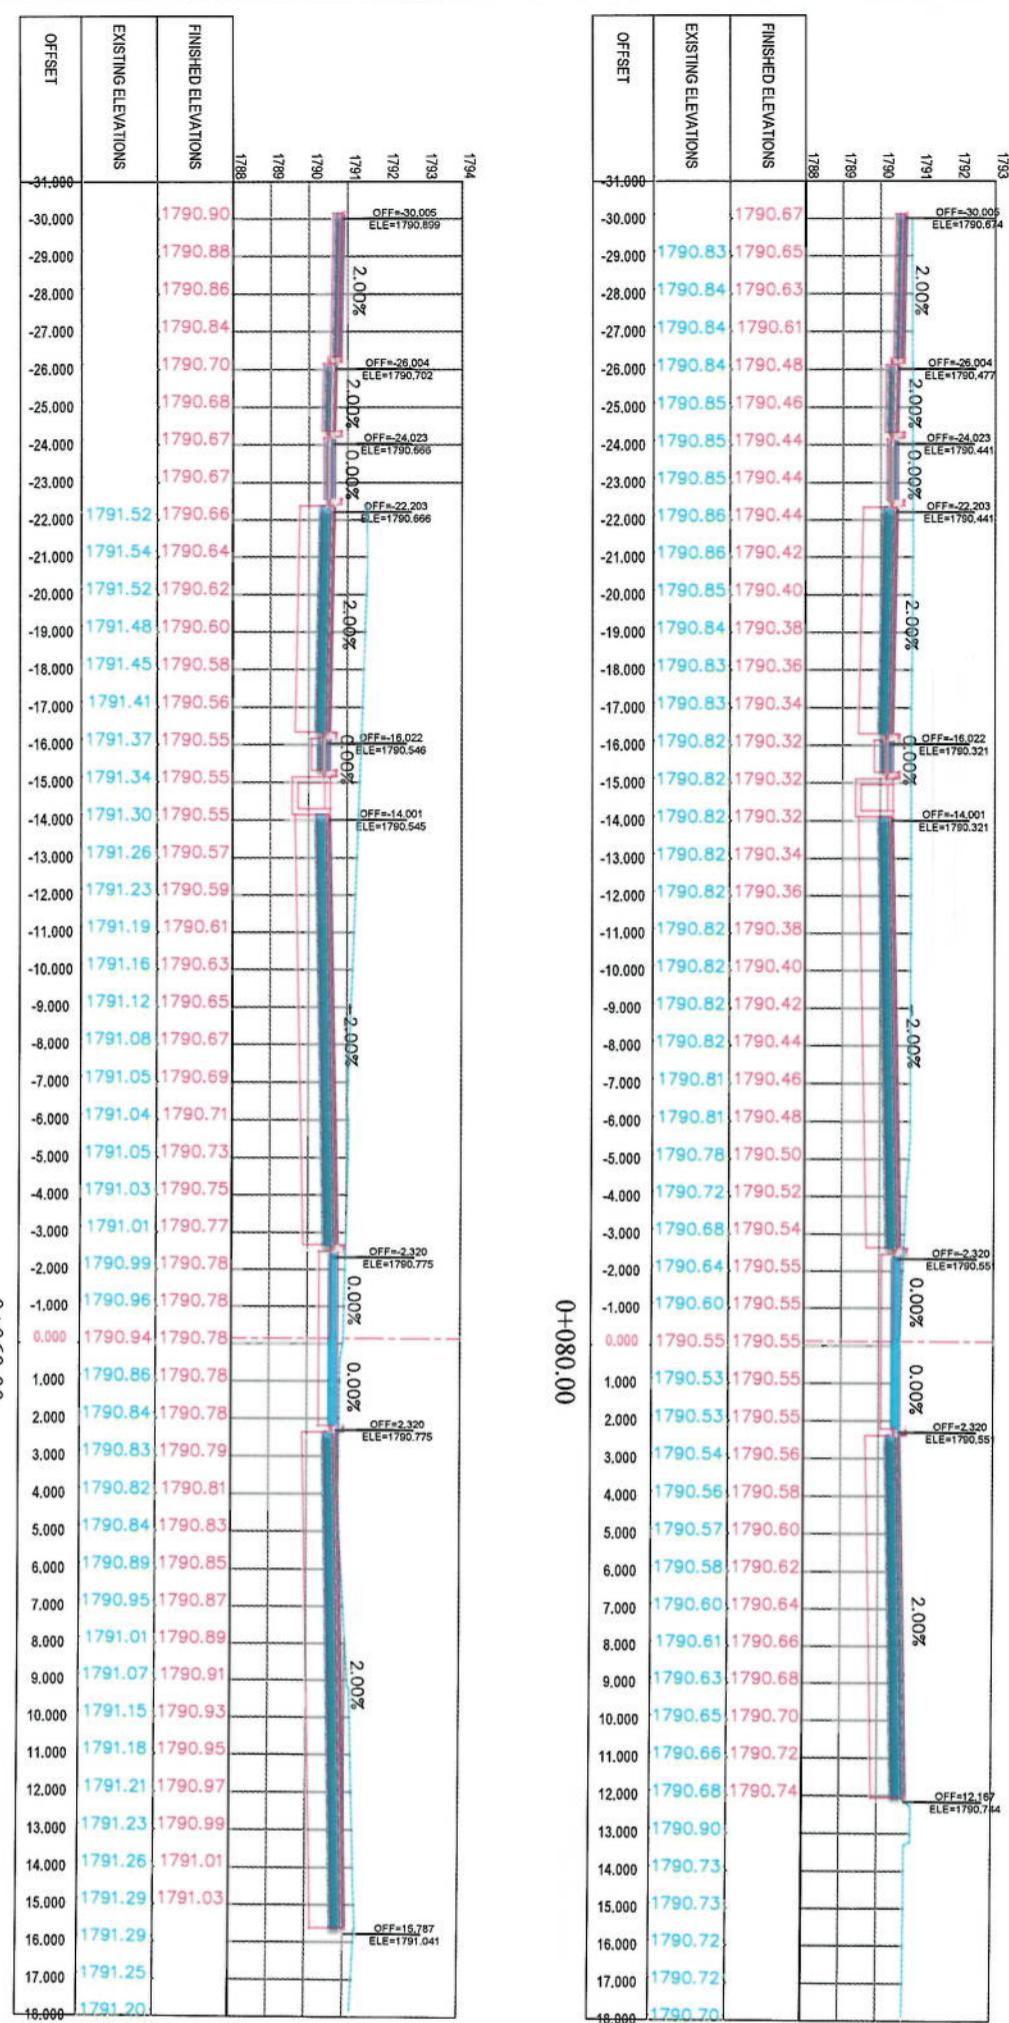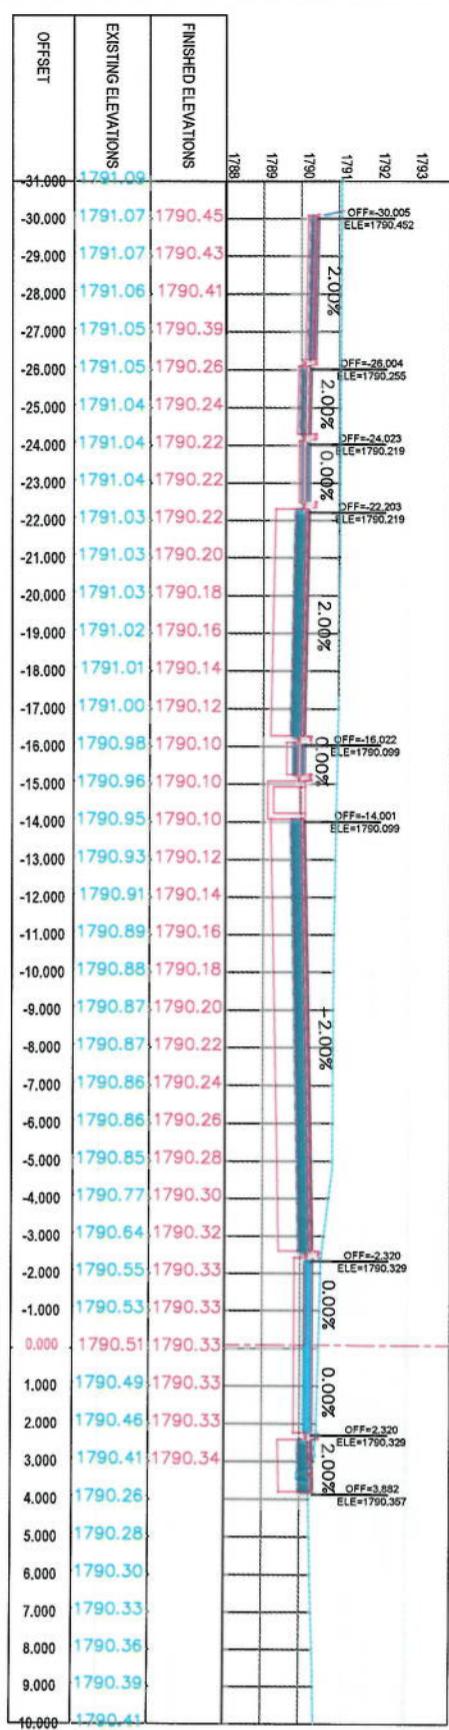


Drawing Title:	CROSS SECTIONS		
Designed by:	Signature:		
Mohammad Eesa Sint			
Drawn by:	Signature:		
Mohammad Eesa Sint			
Checked by:	Signature:		
Hanbulah Soltz			
Date: 6/7/2023	Scale: 1:200		
Status: FINAL DESIGN			
Project Code:			
Drawing Number: CS-2	Revision: 00		


0+120.00

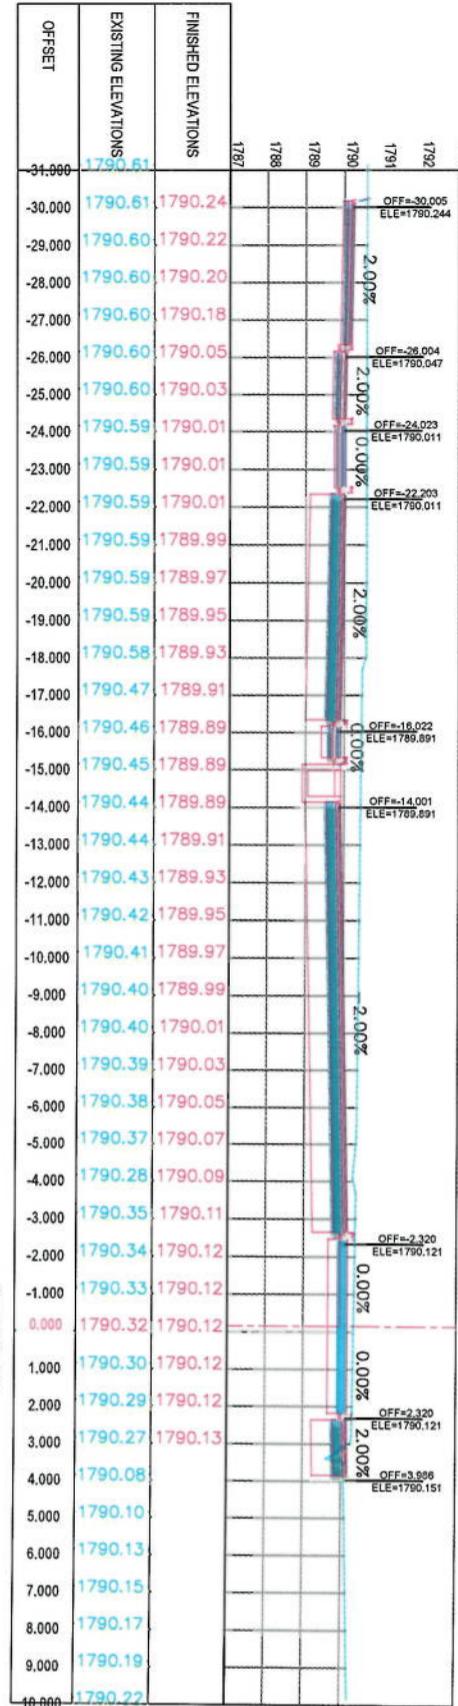

0+140.00

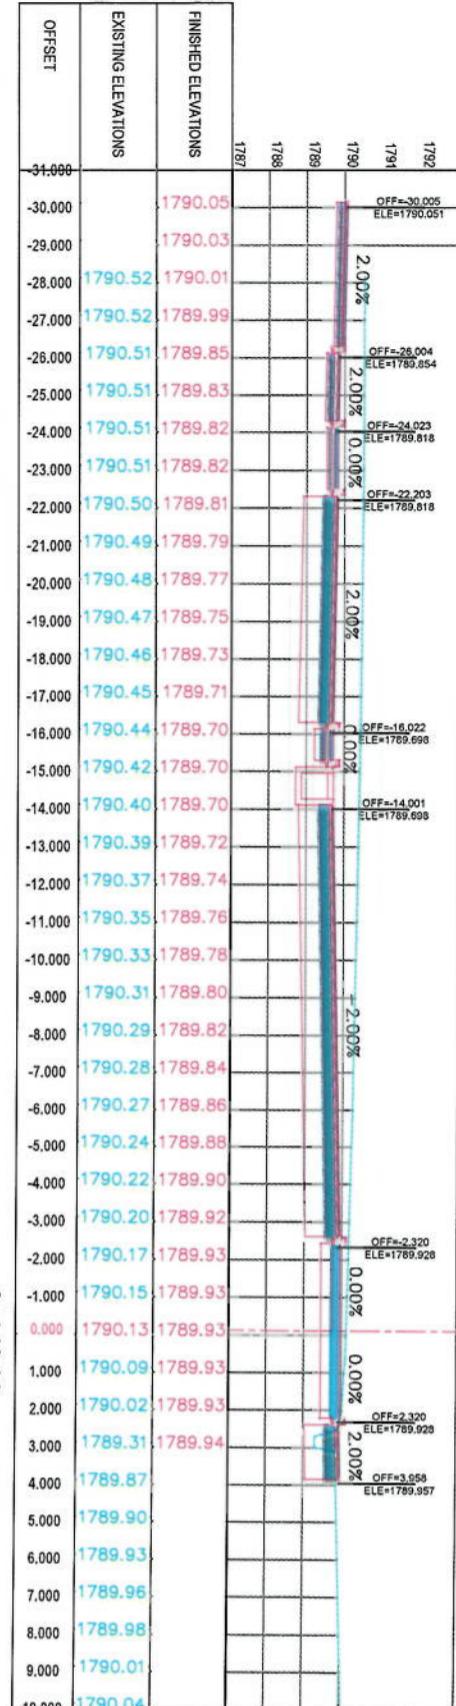


0+160.00

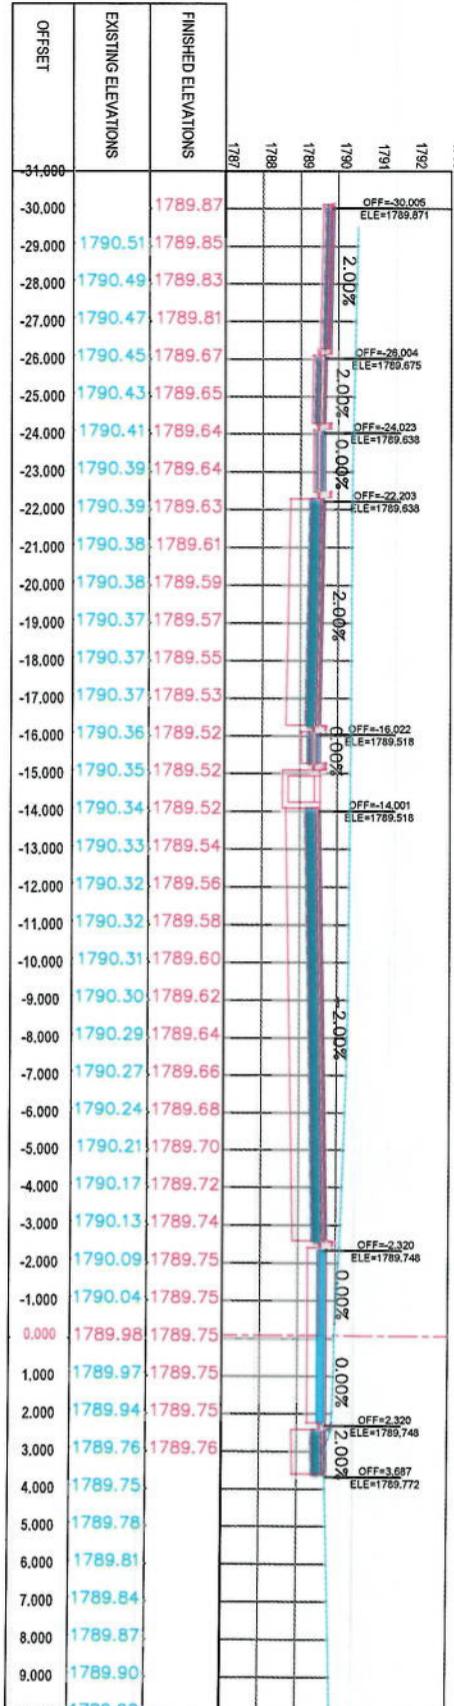


NOTE:


- All dimensions are in metres unless otherwise indicated.

LEGENDS
CENTER-LINE
EXISTING SURFACE
EXISTING SIDE DITCH

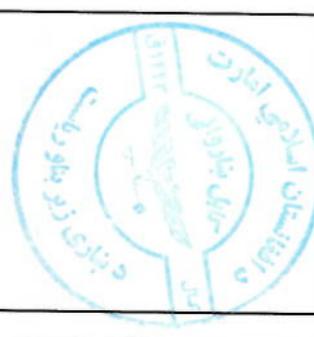

Project Name:	KABUL MUNICIPALITY DESIGN TEAM
Design Title:	Cone-Single To Demazang Road Project
Checked by:	Hannanullah Shamsi
Date:	6/7/2023
Scale:	1:200
Status:	FINAL DESIGN
Project Code:	CS-3
Revision:	00

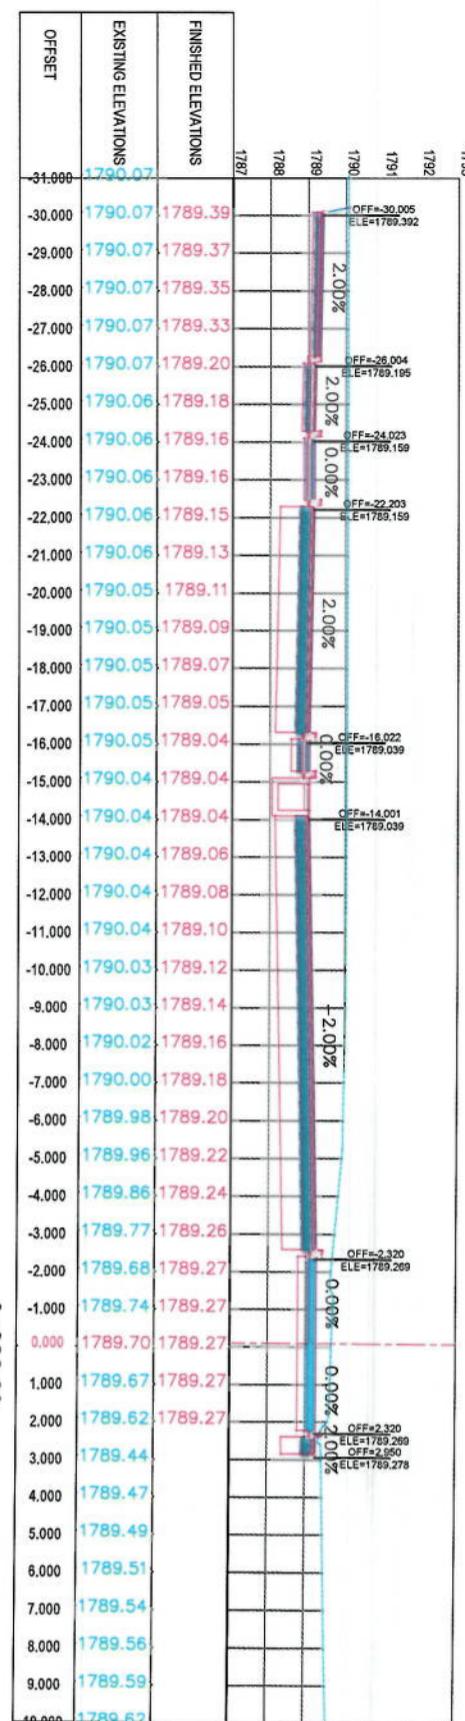


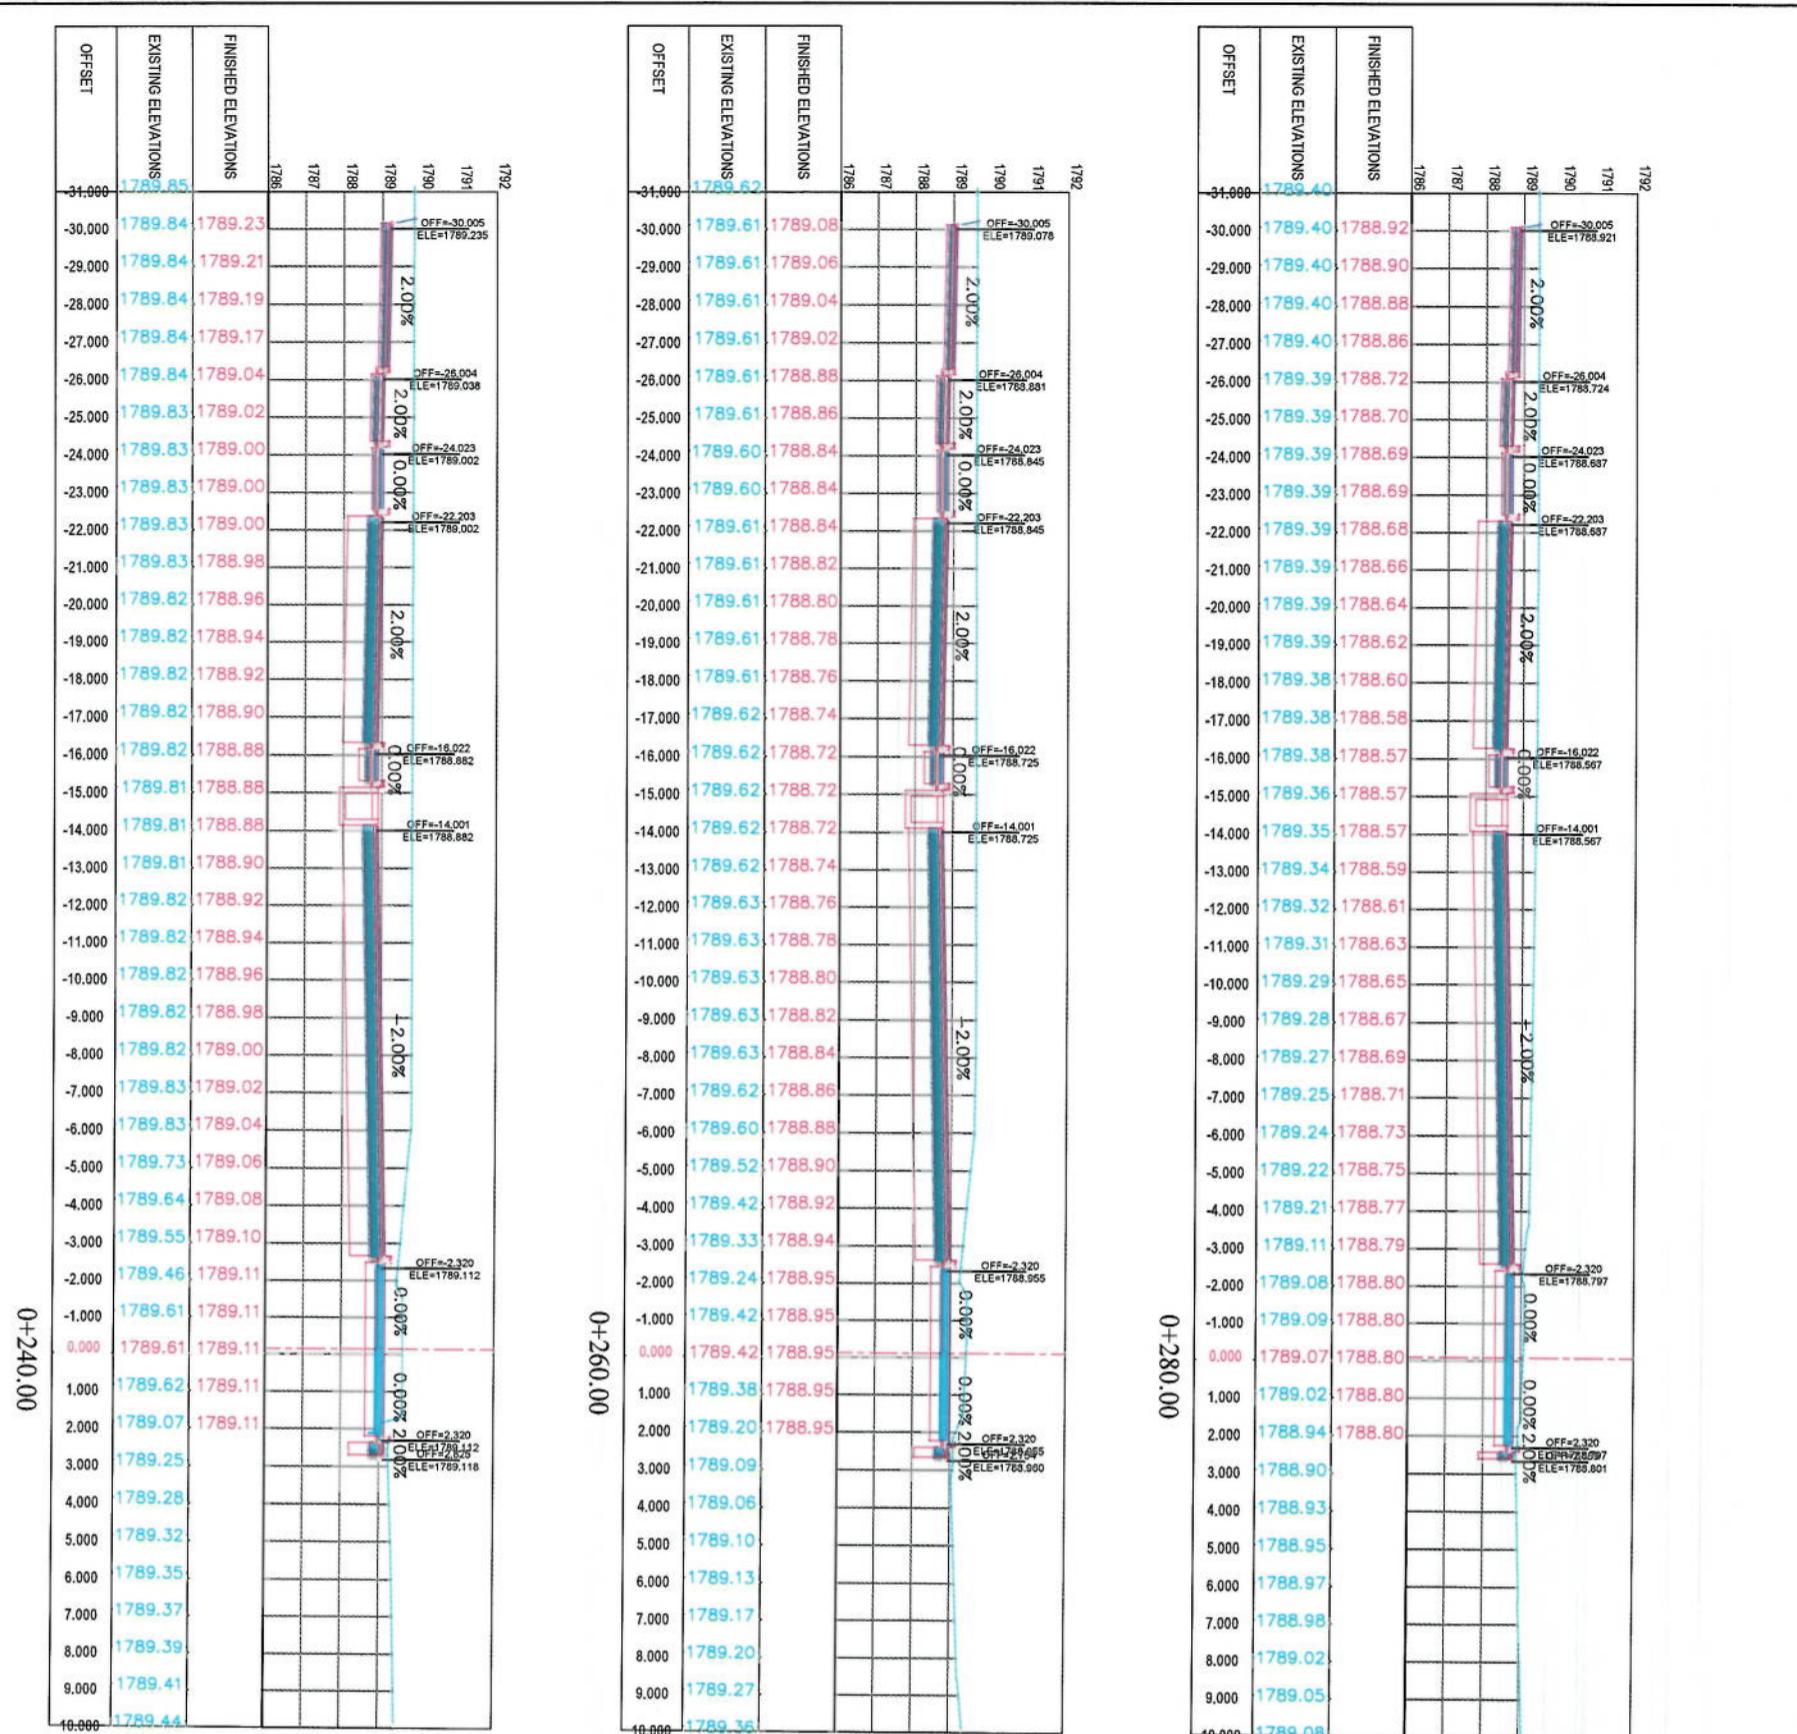


NOTE:  
1. All dimensions are in meters unless otherwise indicated.



Designed by:	KABUL MUNICIPALITY DESIGN TEAM
Project Name:	Islamabad-Kabul Road Project
Drawing Title:	CROSS SECTIONS
Code-Sign To Demazang	Road Project
Drawn by:	Mohammad Eesa Sait
Checked by:	Habibullah Saitz
Date:	6/7/2023
Scale:	1:200
Status:	FINAL DESIGN
Project Code:	CS-5
Revision:	00

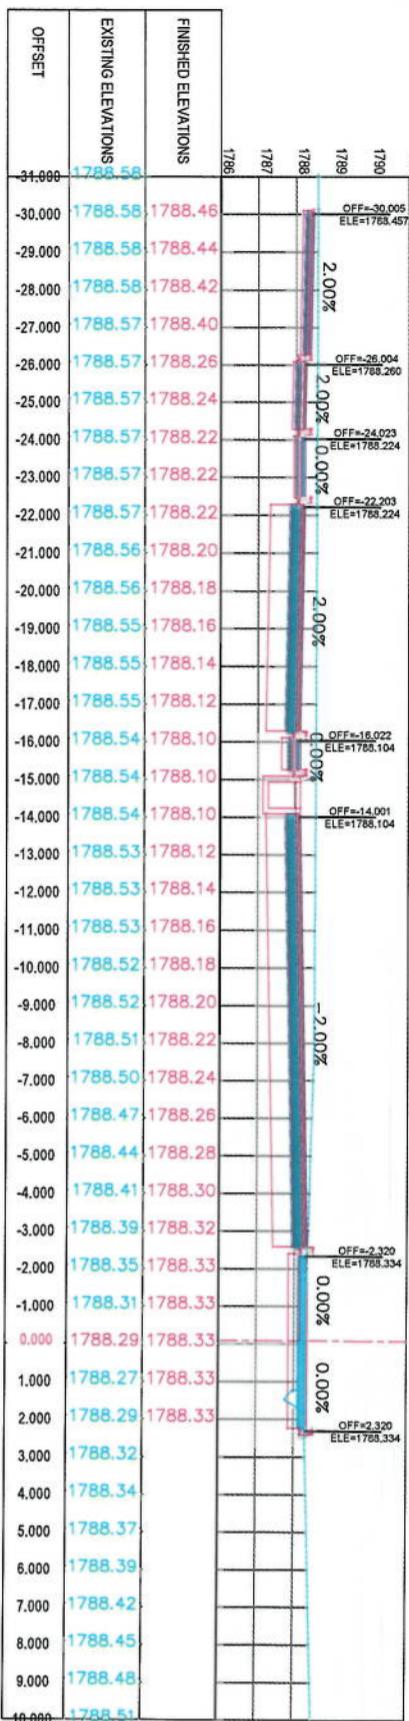


0+340.00



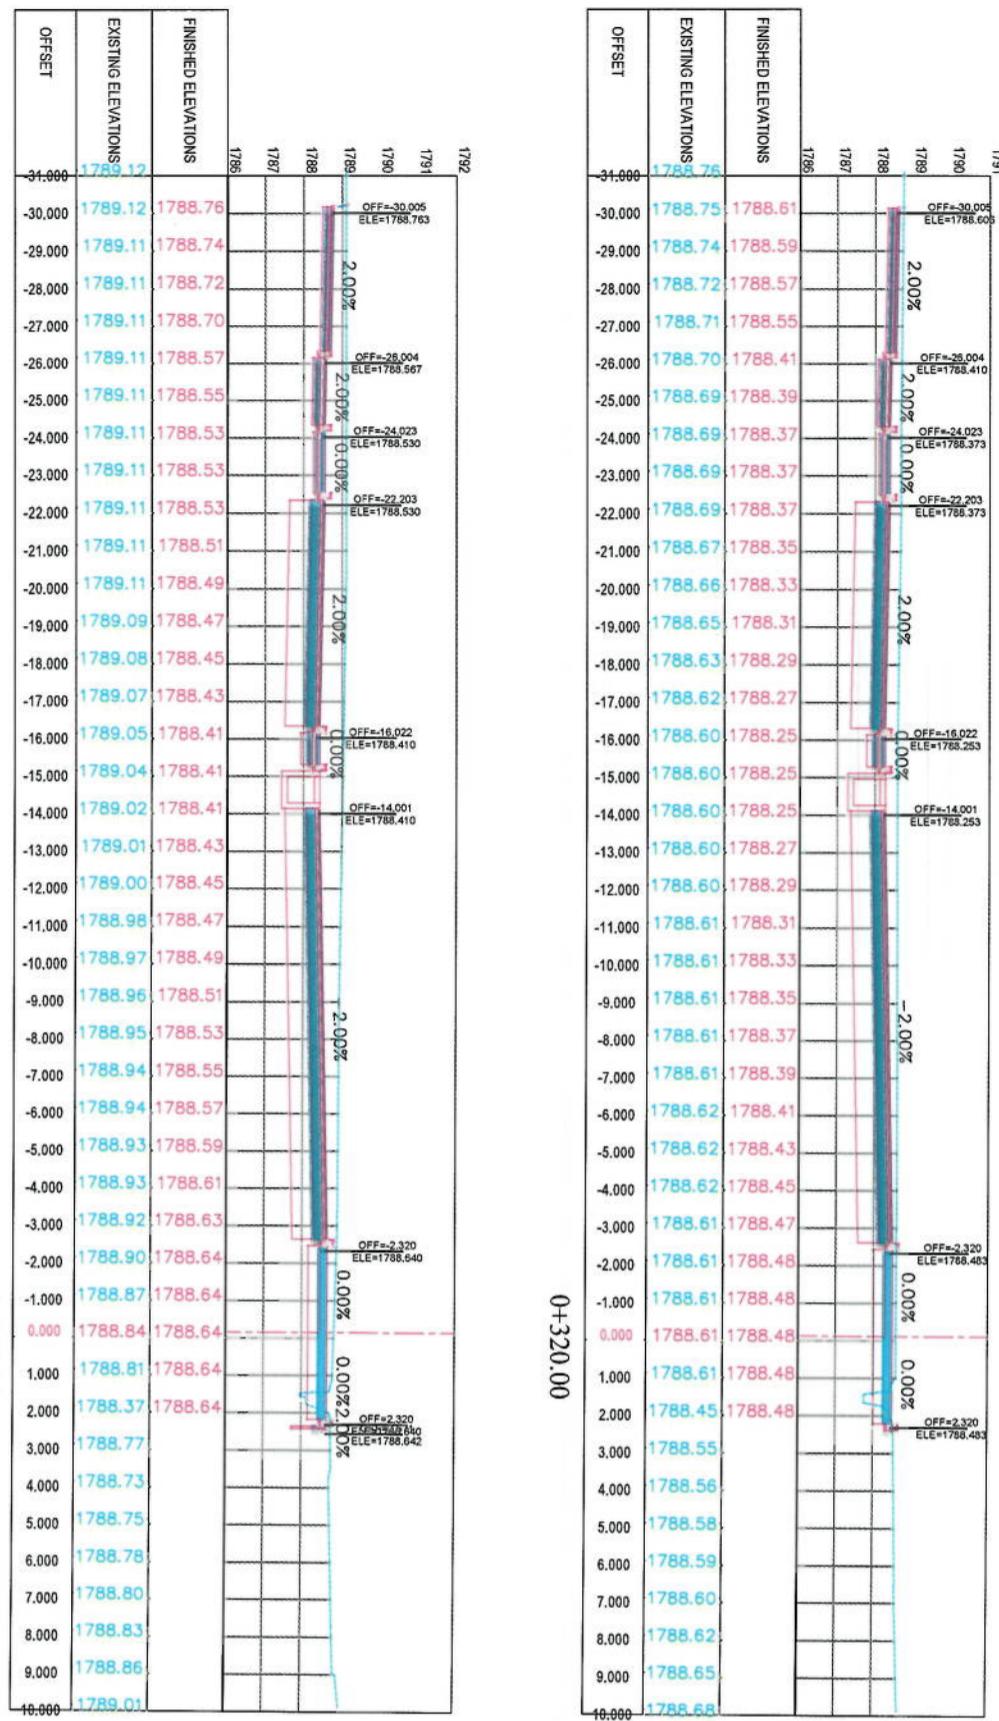


0+320.00

0+300.00

NOTES	
1. All dimensions are in meters unless otherwise indicated.	
LEGENDES	
— CENTER-LINE	
— EXISTING SURFACE	
— EXISTING SIDE DITCH	
Project Name:	KABUL MUNICIPALITY DESIGN TEAM
Designed by:	KABUL MUNICIPALITY
Draughting Title:	Coor-Song To Demazang Road project
CROSS SECTIONS	
Drawn by:	Mohammad Esa Sint
Checked by:	Habibullah Shafiq
Date:	6/7/2023
Scale:	1:200
Project Code:	FINAL DESIGN
Drawing Number:	CS-6
Revision:	00

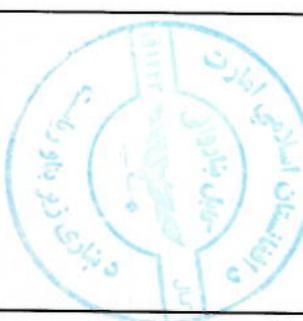

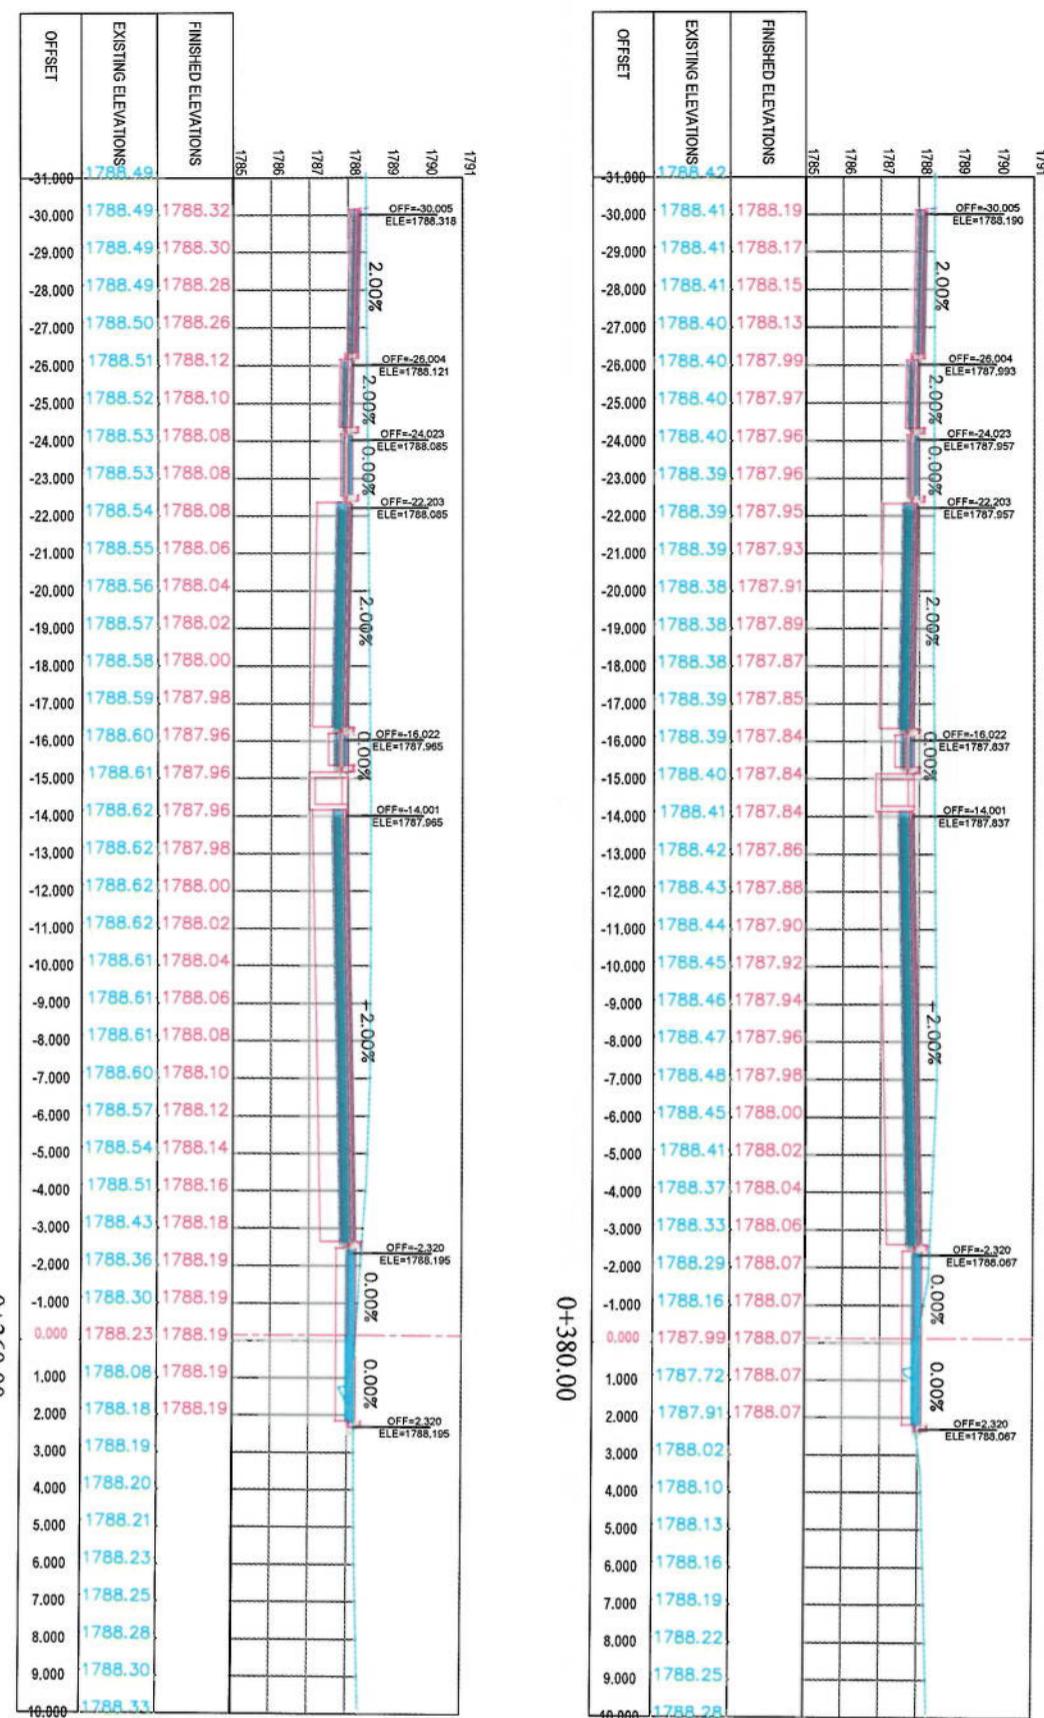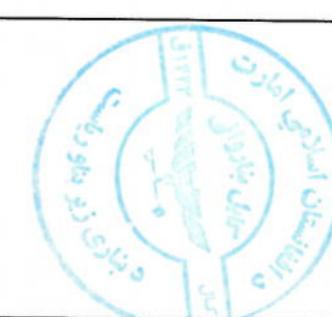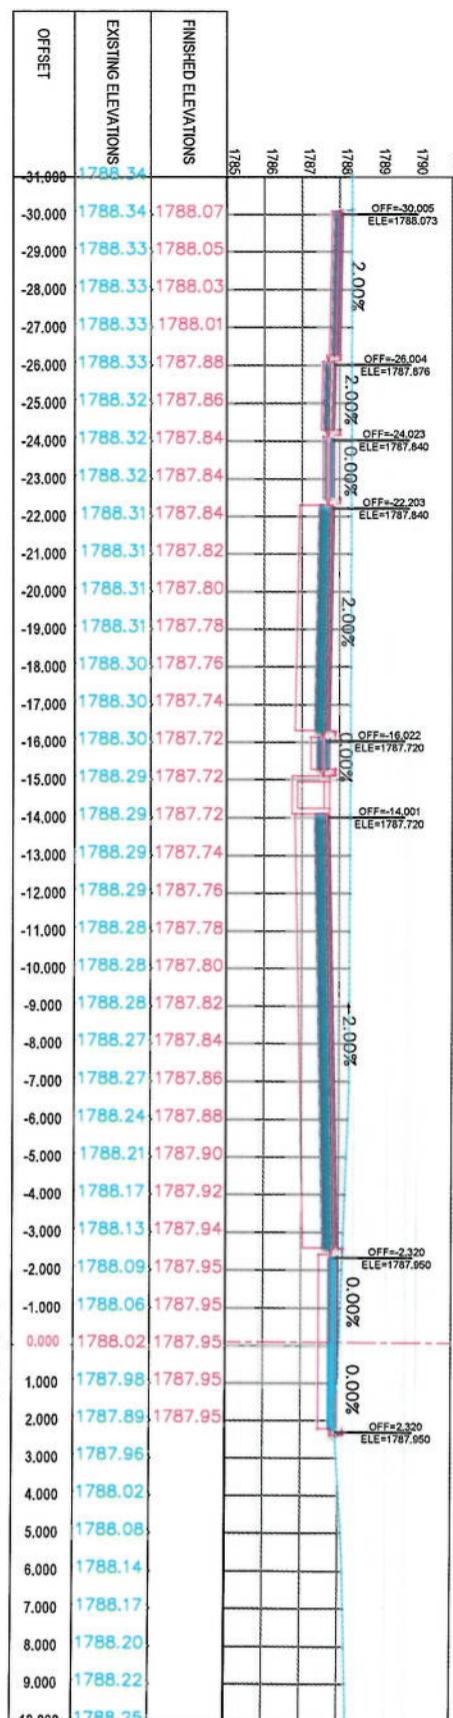

NOTE:


- All dimensions are in meters unless otherwise indicated.

LEGENDS


- CENTER-LINE
- EXISTING SURFACE
- EXISTING SIDE DITCH

Project Name:	ISLAMIC EMIRATE OF AFGHANISTAN		
Client	 KABUL MUNICIPALITY		
Designed by:	KABUL MUNICIPALITY DESIGN TEAM		
Project Code:	CS-7	Revision	00
Drawing Number:			
Date:	6/7/2023	Scale:	1:200
Status:	FINAL DESIGN		



0+420.00

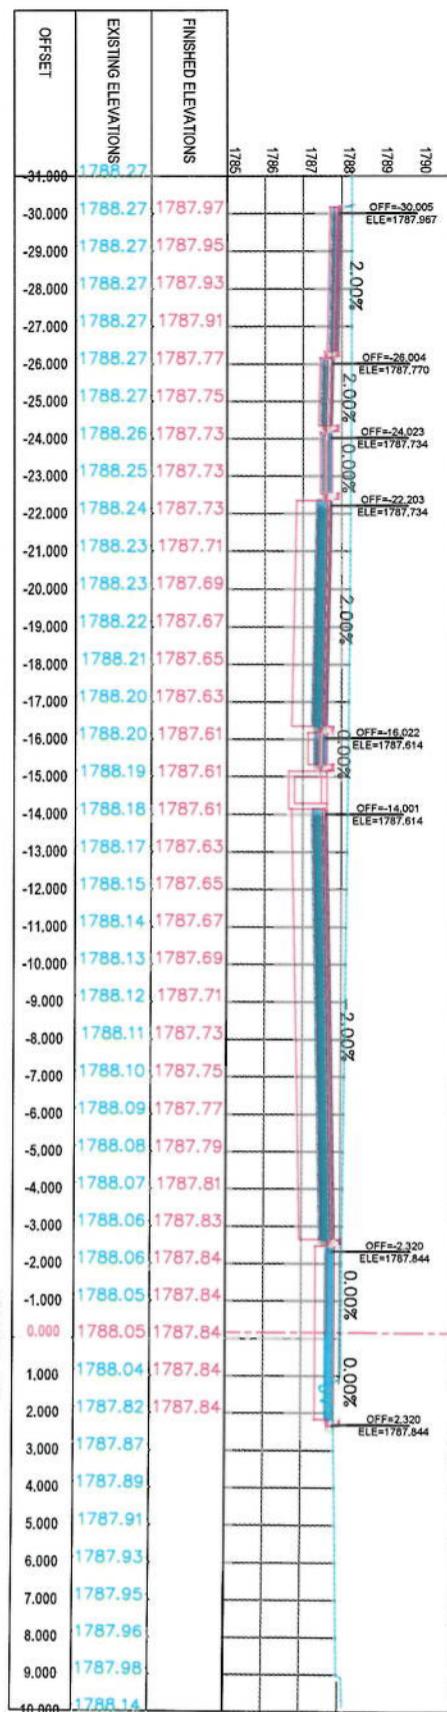


0+440.00

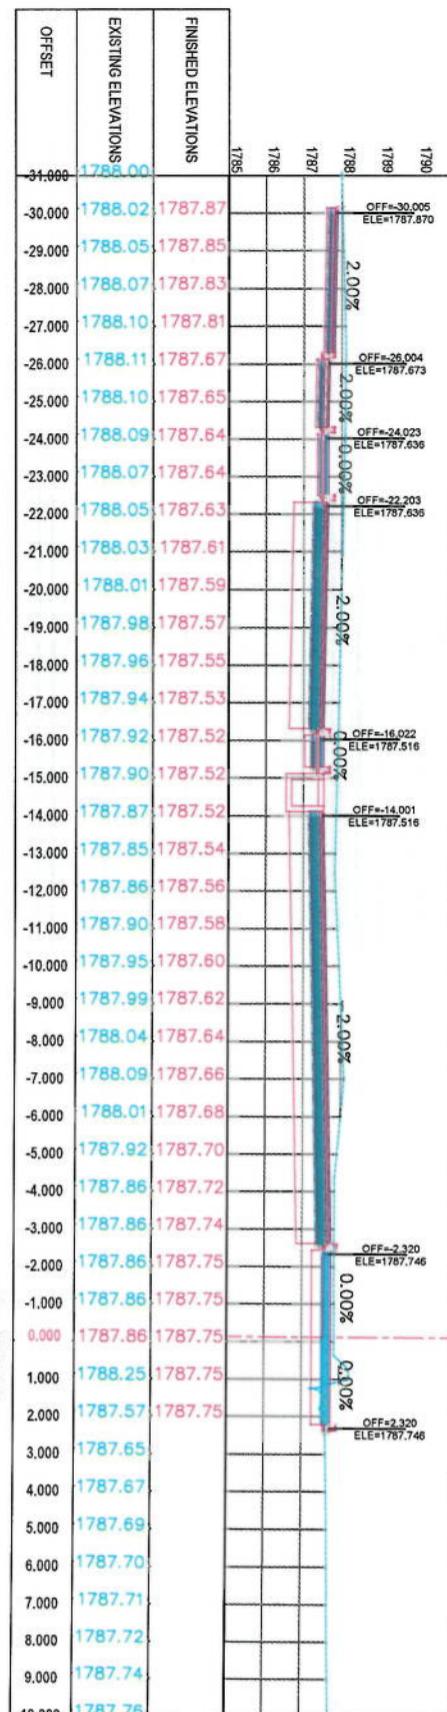


0+460.00

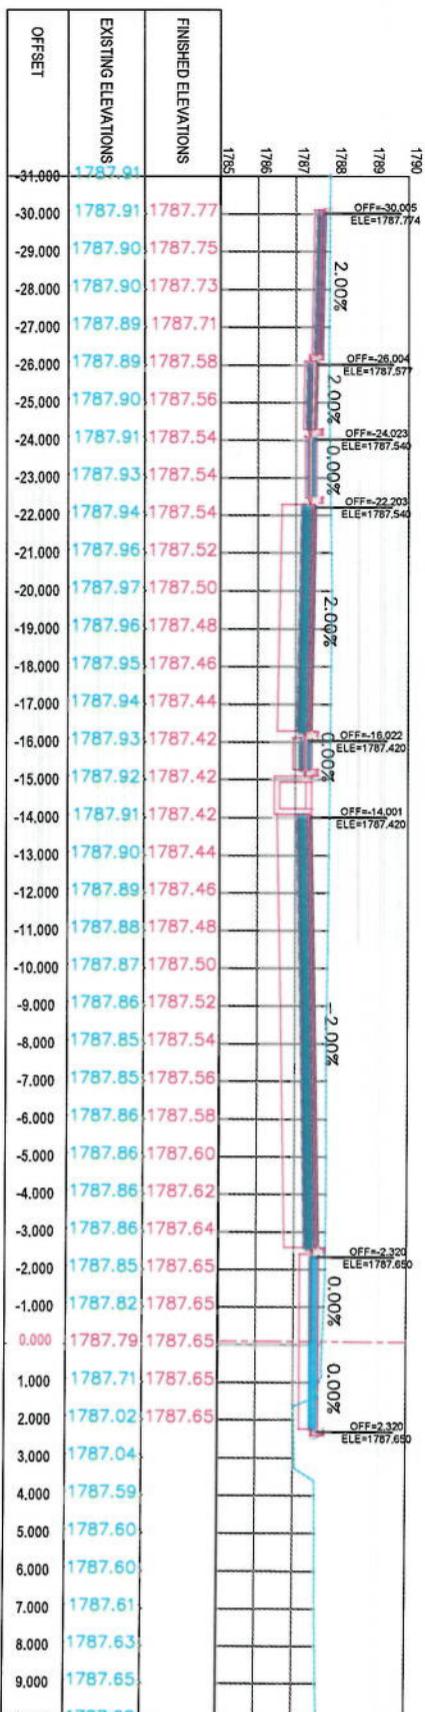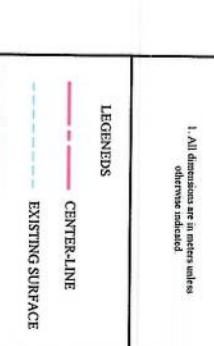NOTE:  
1. All dimensions are in meters unless otherwise indicated.


Project Name:	Kabul-Sangin To Demazang Road Project
Drawing Title:	CROSS SECTIONS
Designed by:	Mohammad Eesa Slati
Drawn by:	Mohammad Eesa Slati
Checked by:	Hassanullah Slati
Date:	6/7/2023
Scale:	1:200
Status:	FINAL DESIGN
Project Code:	CS-8
Revision:	00

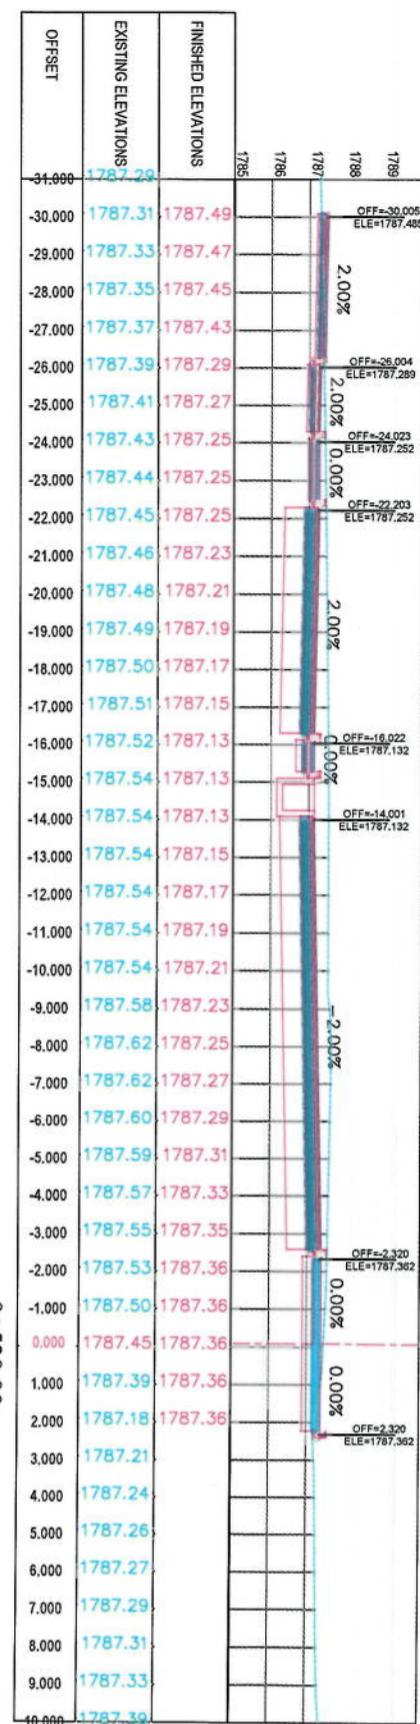

0+520.00

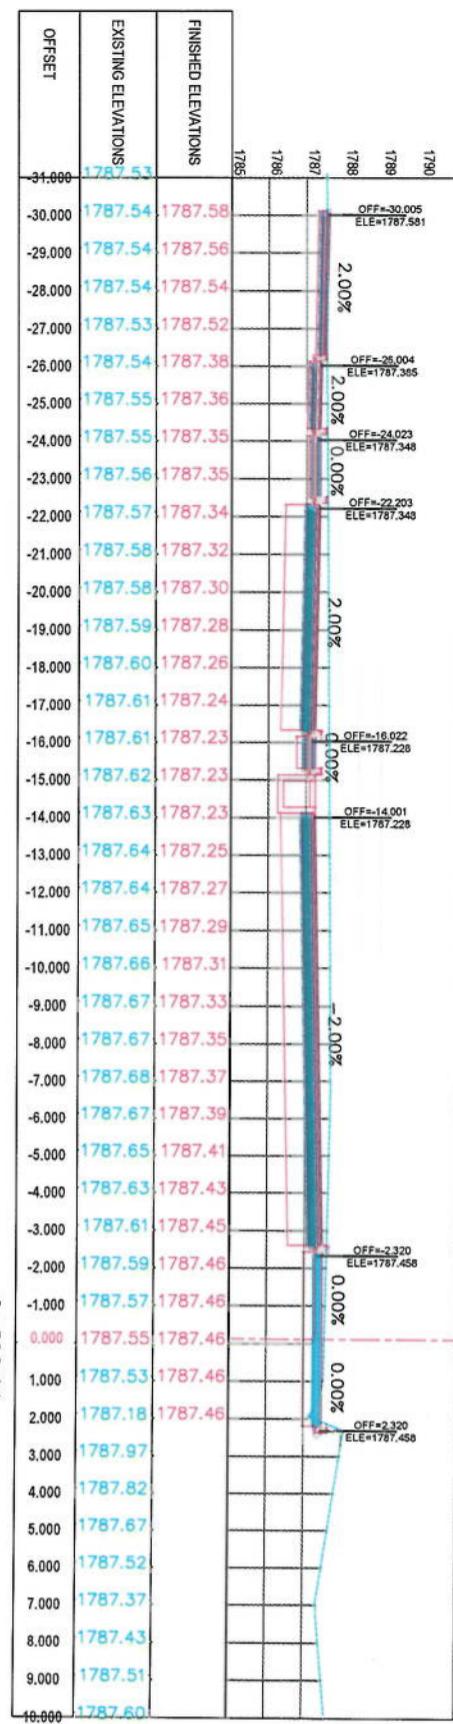

0+500.00

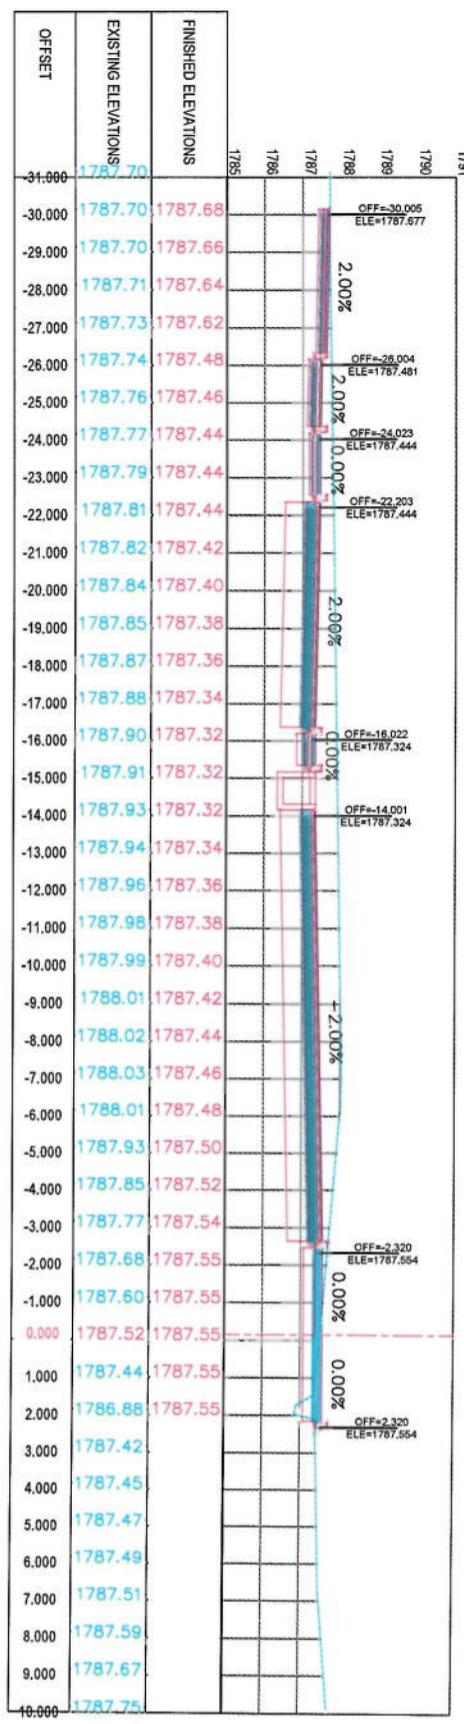

0+480.00


NOTE:  
1. All dimensions are in meters unless otherwise indicated.

**LEGENDS**

- CENTER-LINE
- EXISTING SURFACE
- EXISTING SIDE DITCH



Project Name:	KABUL MUNICIPALITY DESIGN TEAM
Code-Sign To Demazang	Rod Project
Designed by:	Mohammad Eesa Sial
Signed:	[Signature]
Drawn by:	Mohammad Eesa Sial
Signed:	[Signature]
Checked by:	Hassanullah Shabani
Signed:	[Signature]
Status:	FINAL DESIGN
Project Code:	CS-9
Drawing Number:	00
Revision:	

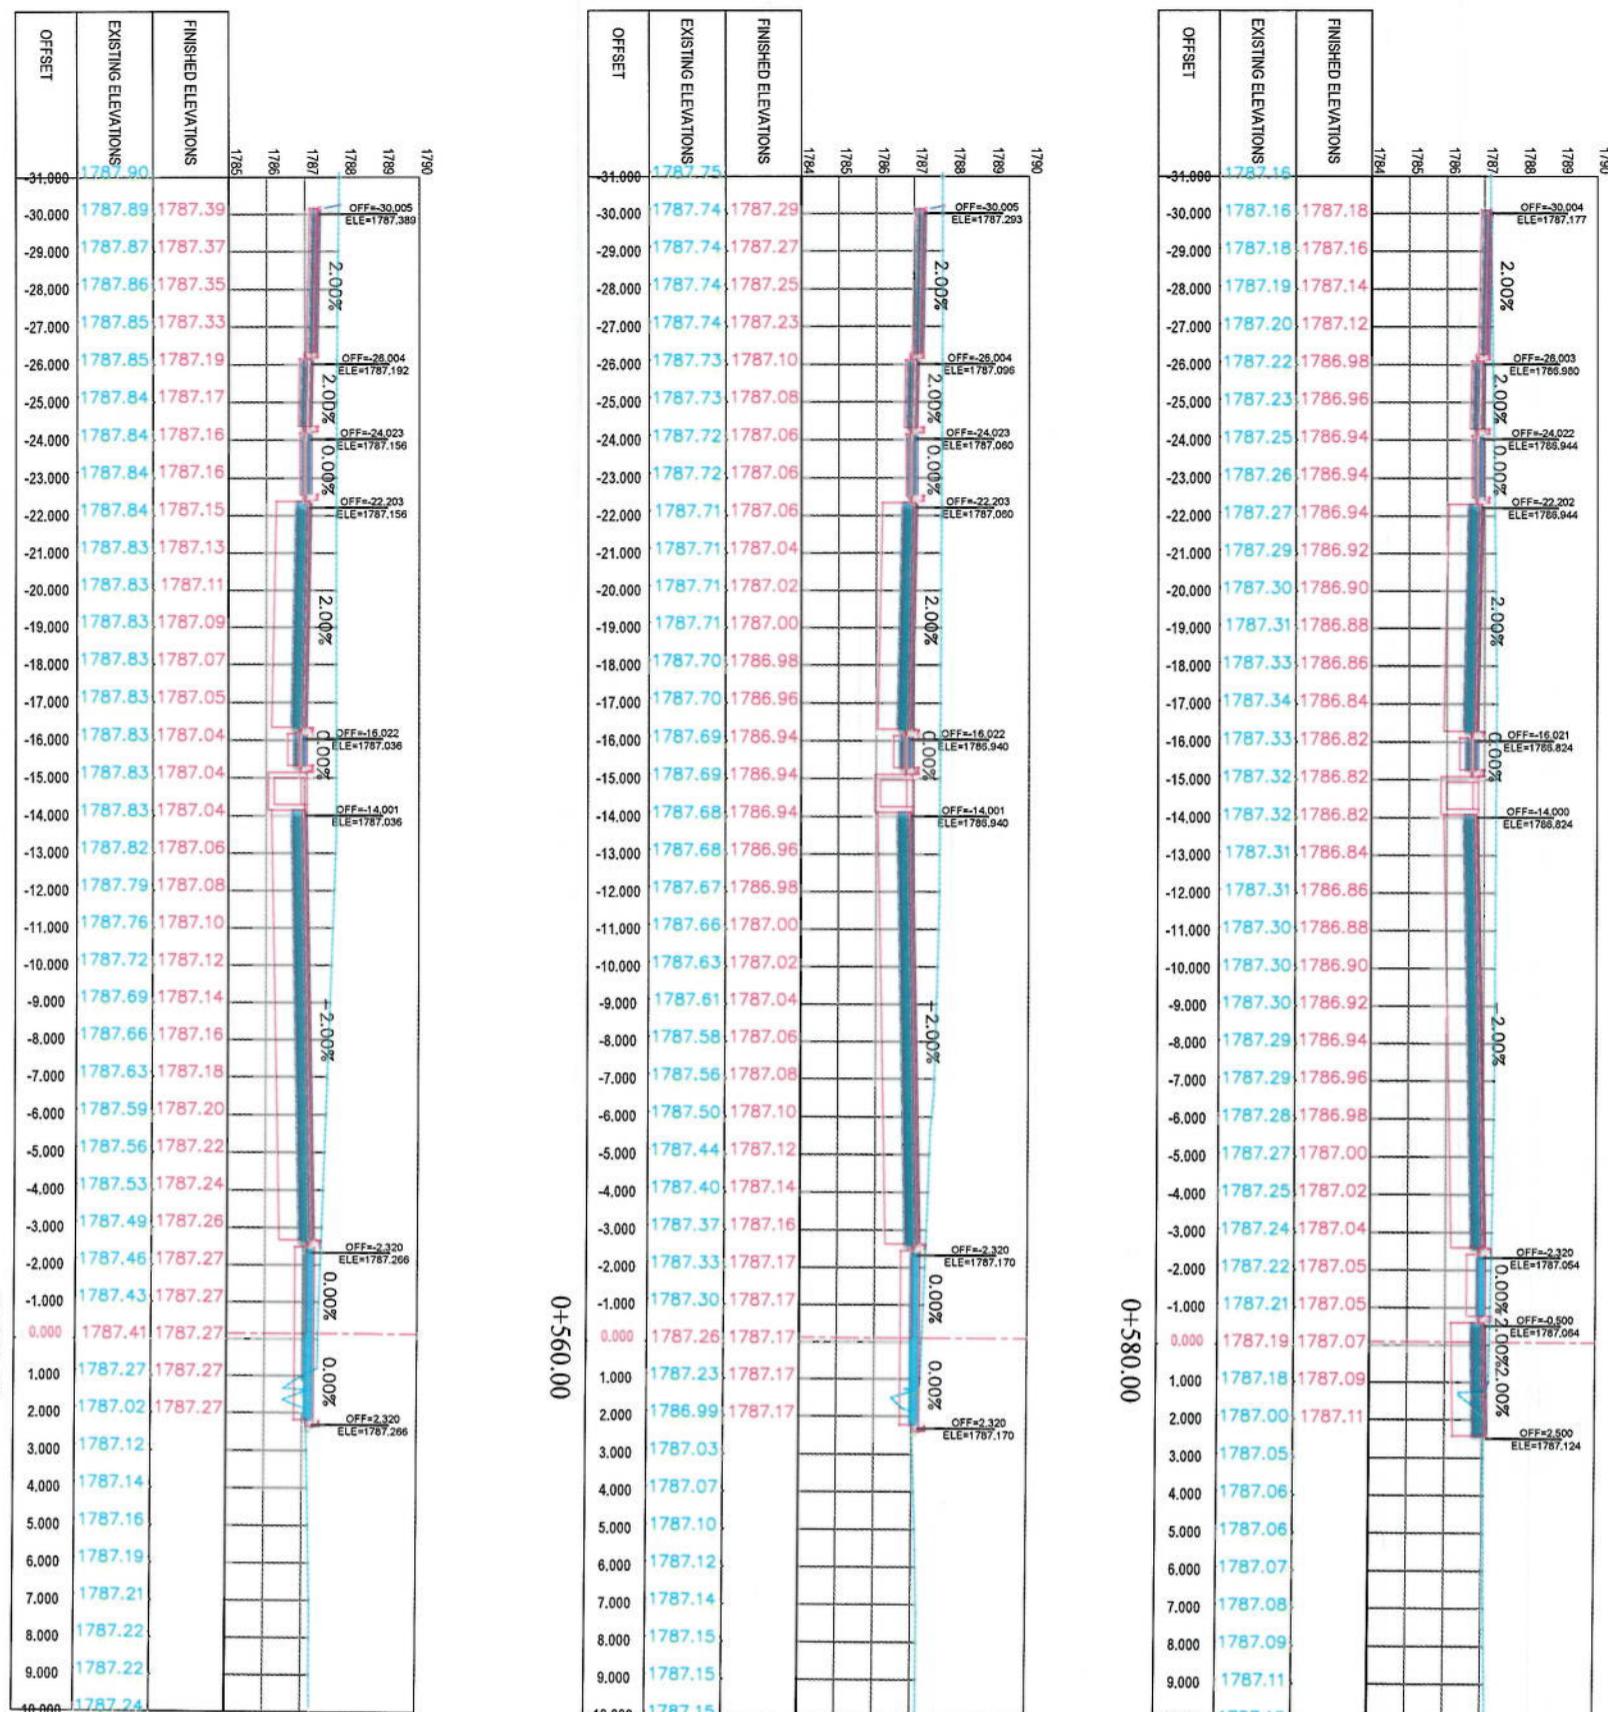

NOT

1. All dimensions are in meters unless otherwise indicated

## LEGEND

1. All dimensions are in meters unless otherwise indicated


CENTENARIAN

一

#### — EXISTING SU



CS-10  
00

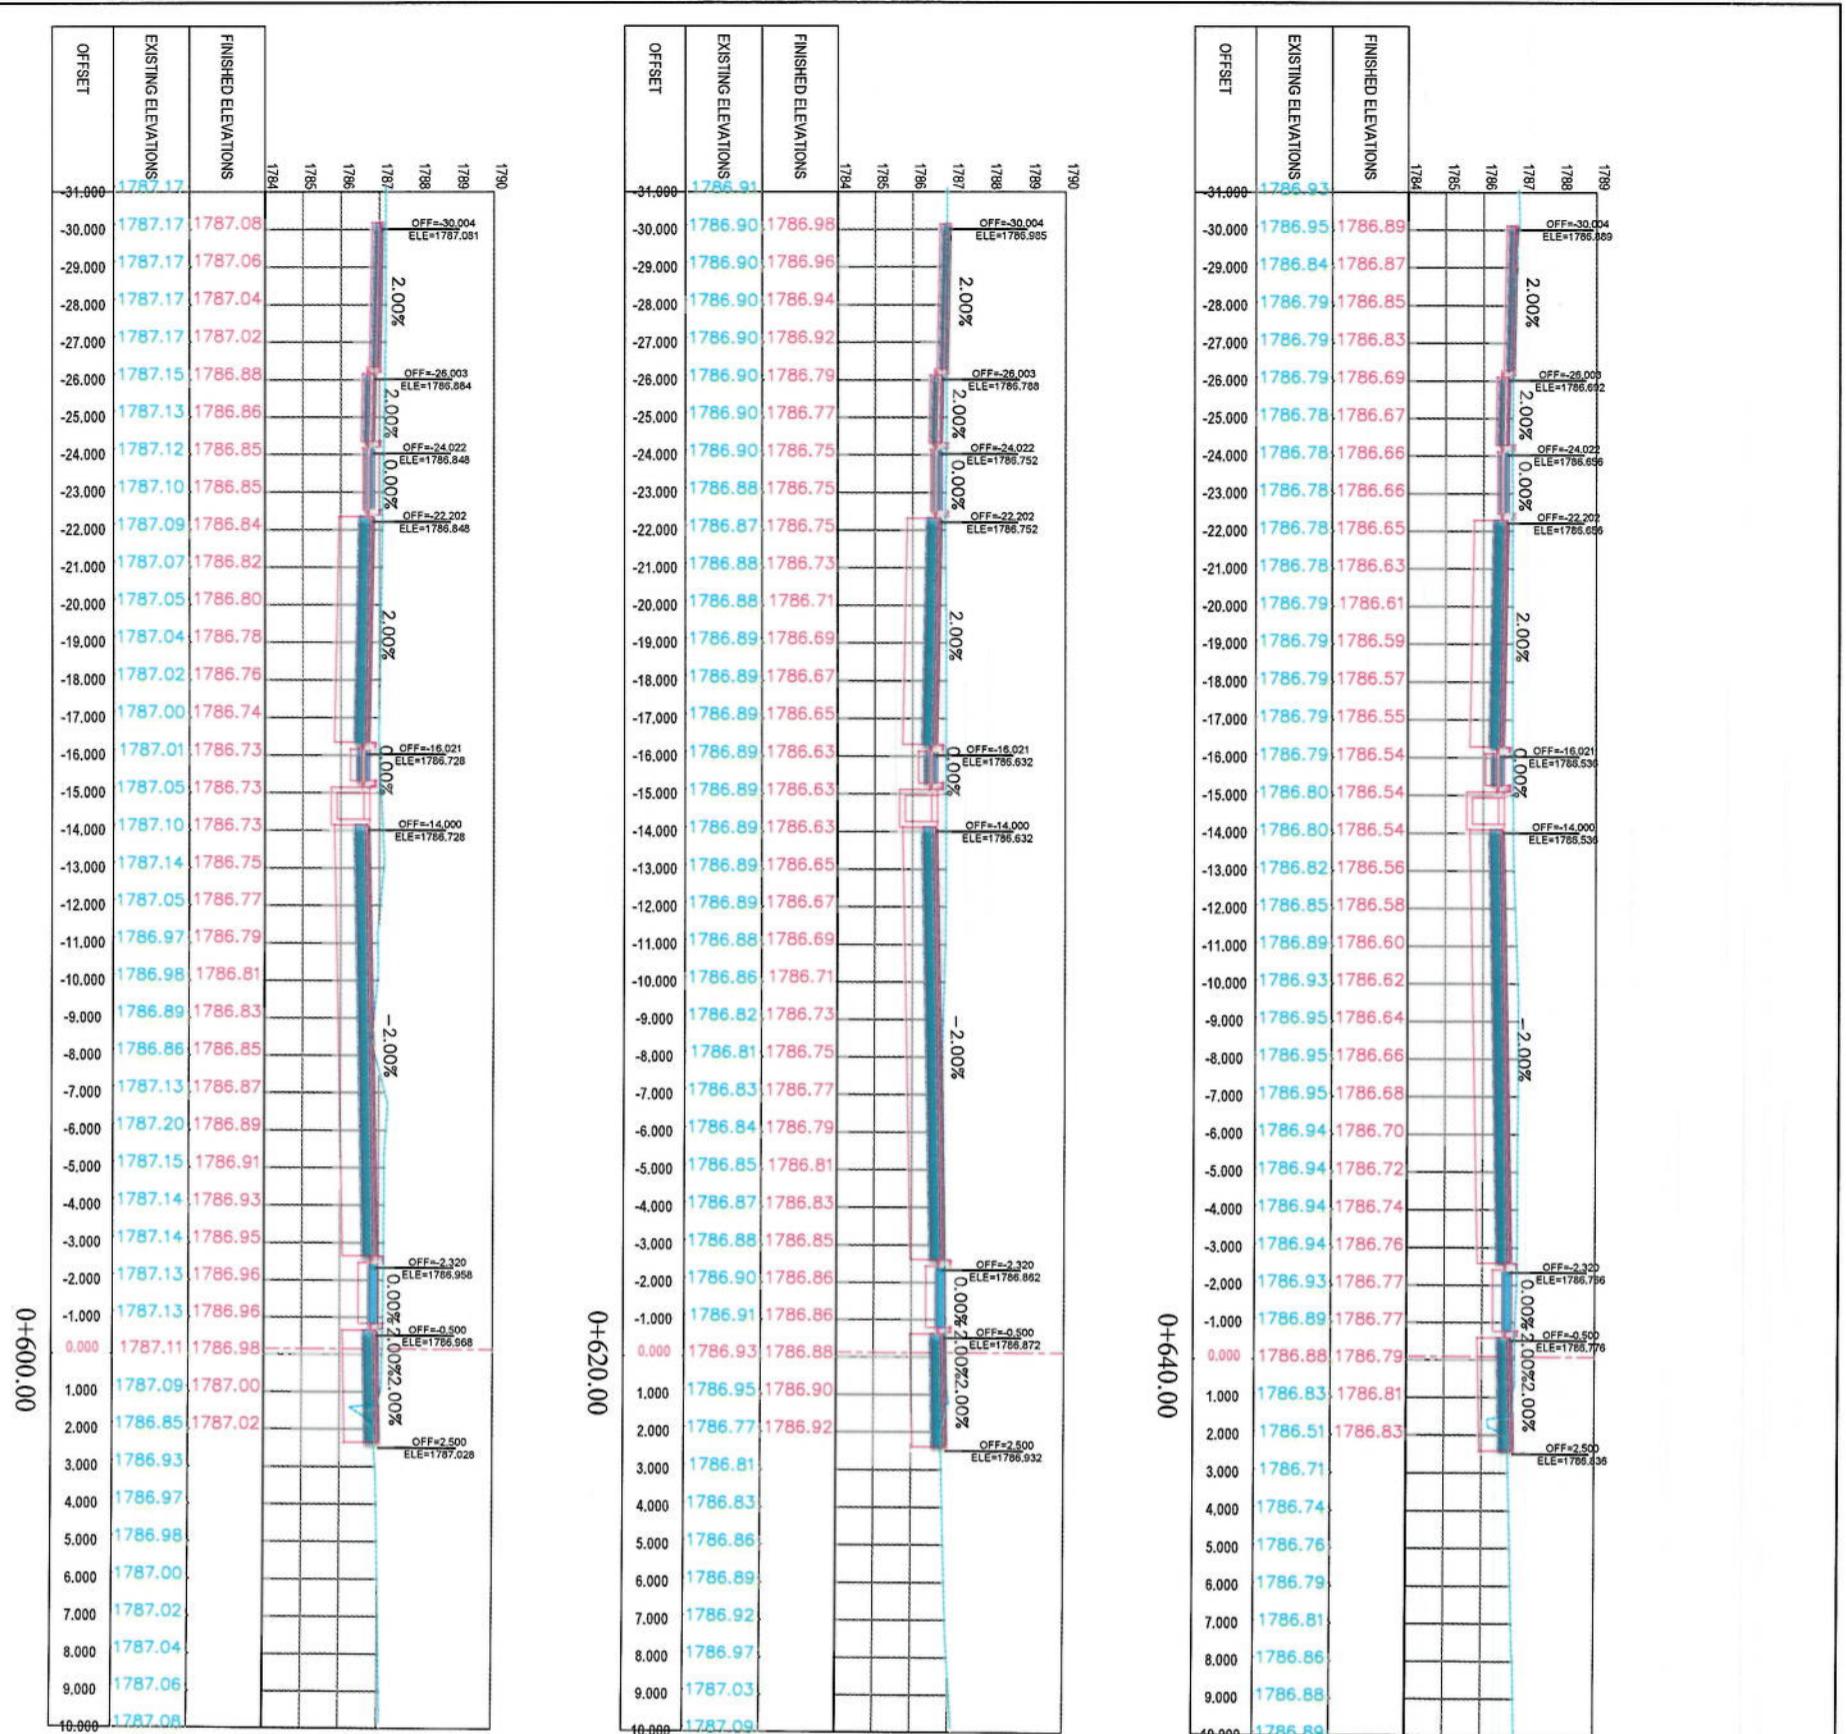

NOTE:


1. All dimensions are in meters unless otherwise indicated

**LEGENDS**


- CENTER-LINE
- - - EXISTING SURFACE
- EXISTING SIDE DITCH



CROSS SECTIONS		
Drawing Title:		
Designed by:	KABUL MUNICIPALITY	Drawn by:
Project Name:	KABUL MUNICIPALITY DESIGN TEAM	
Conc-Sang To Demazang	Road Project	
Date:	6/7/2023	Scale:
Status:	FINAL DESIGN	
Project Code:	CS-11	Revision: 00

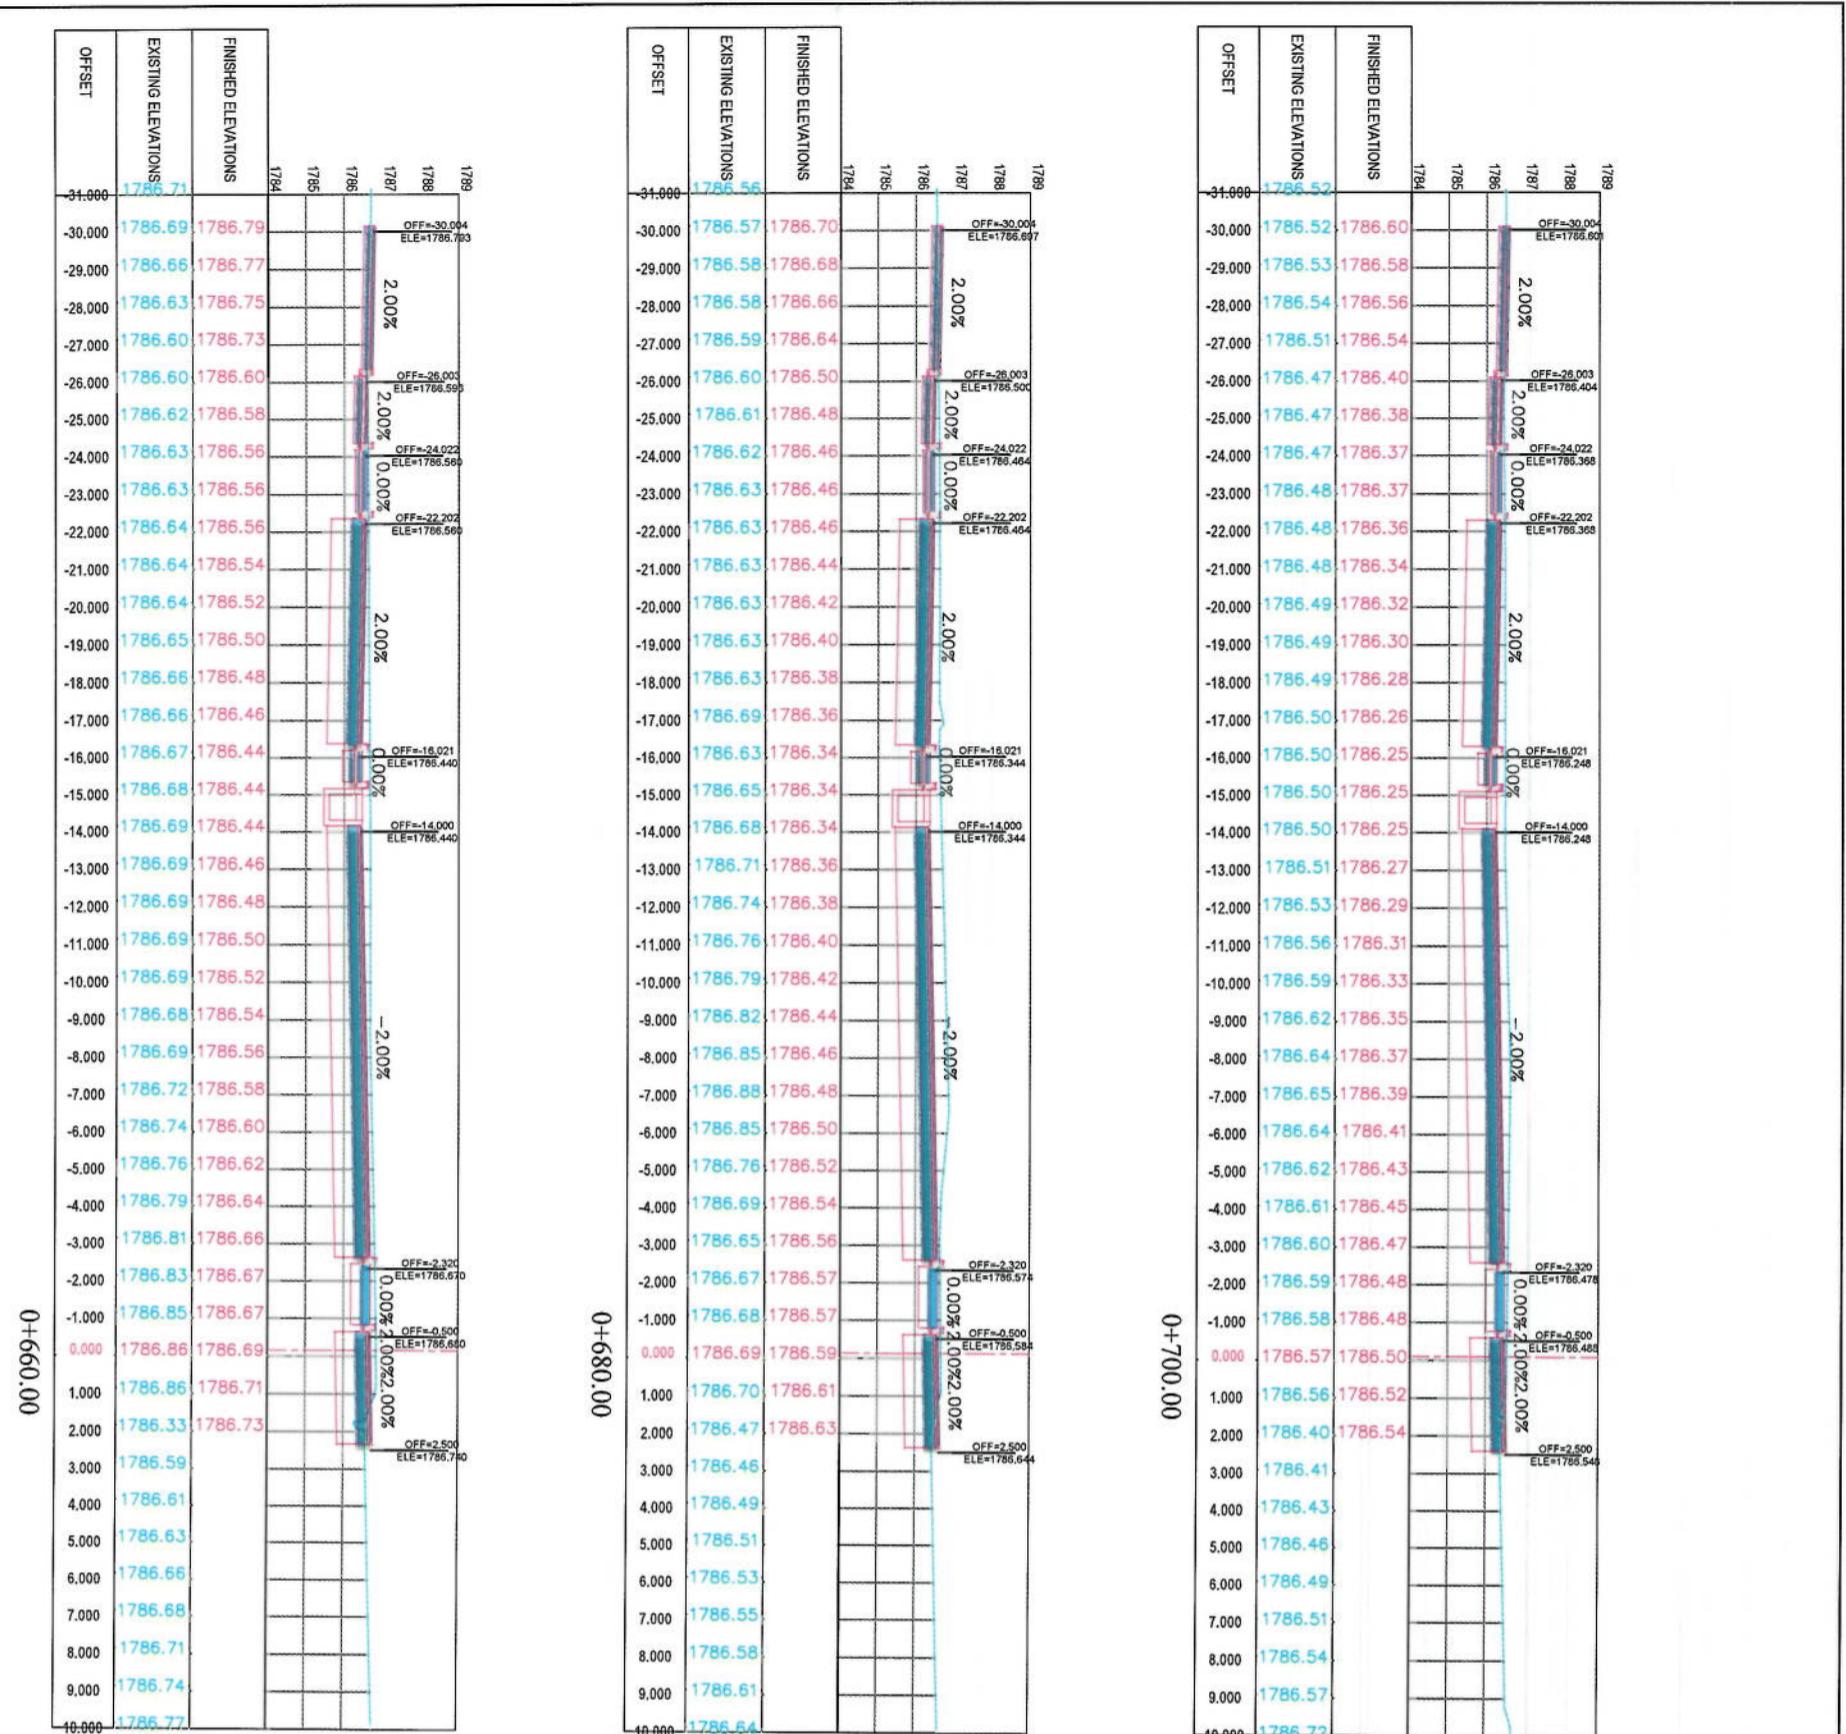

0+680.00

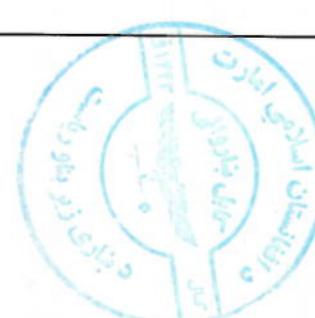

NOTE:

1. All dimensions are in metres unless otherwise indicated.

**LEGENDS**


CENTER-LINE

EXISTING SURFACE



EXISTING SIDE DITCH

FINISHED ELEVATIONS	EXISTING ELEVATIONS	EXISTING SIDE DITCH
1786.71	1786.70	OFF=30.004 ELE=1786.607
1786.69	1786.68	OFF=26.003 ELE=1786.600
1786.66	1786.65	OFF=24.022 ELE=1786.568
1786.63	1786.62	OFF=22.202 ELE=1786.564
1786.60	1786.59	OFF=22.202 ELE=1786.560
1786.57	1786.56	
1786.54	1786.53	
1786.51	1786.50	
1786.48	1786.47	
1786.45	1786.44	
1786.42	1786.41	
1786.39	1786.38	
1786.36	1786.35	
1786.34	1786.33	
1786.31	1786.30	
1786.28	1786.27	
1784.03	1784.02	
1784.00	1784.00	
1783.97	1783.96	
1783.94	1783.93	
1783.91	1783.90	
1781.45	1781.44	
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1781.39	1781.38	
1781.36	1781.35	
1781.33	1781.32	
1781.30	1781.29	
1781.27	1781.26	
1781.24	1781.23	
1781.21	1781.20	
1781.18	1781.17	
1781.15	1781.14	
1781.12	1781.11	
1781.09	1781.08	
1781.06	1781.05	
1781.03	1781.02	
1780.99	1780.98	
1780.96	1780.95	
1780.93	1780.92	
1780.90	1780.89	
1780.87	1780.86	
1780.84	1780.83	
1780.81	1780.80	
1780.78	1780.77	
1780.75	1780.74	
1780.72	1780.71	
1780.69	1780.68	

0+720.00

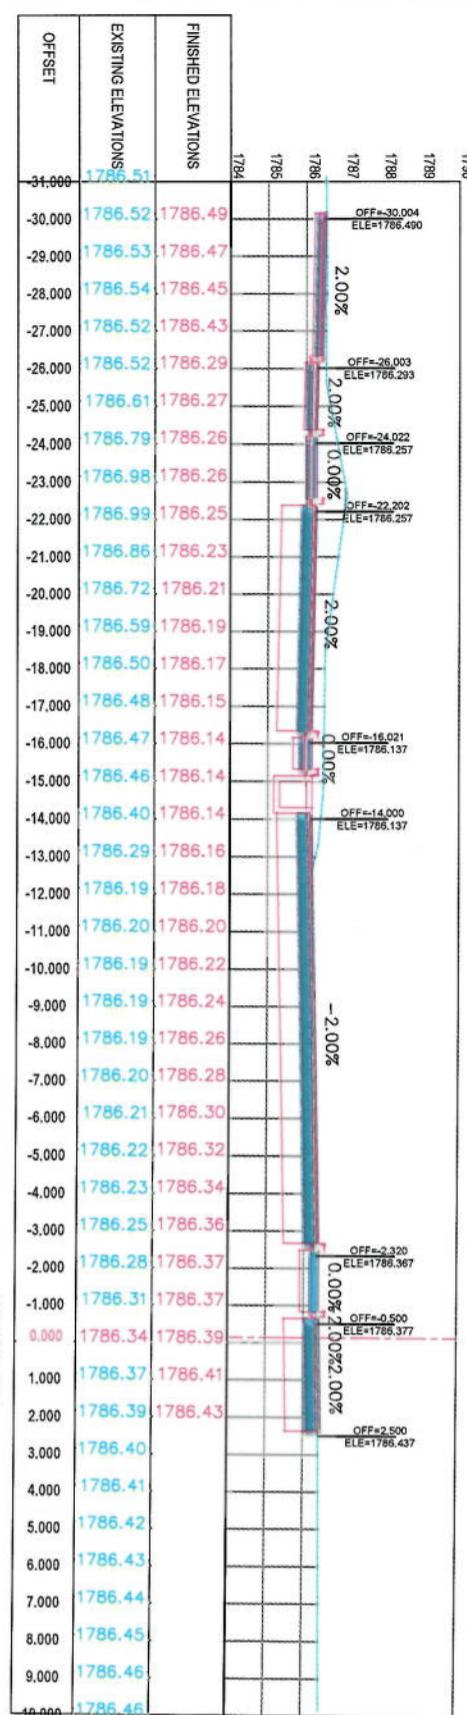


0+740.00

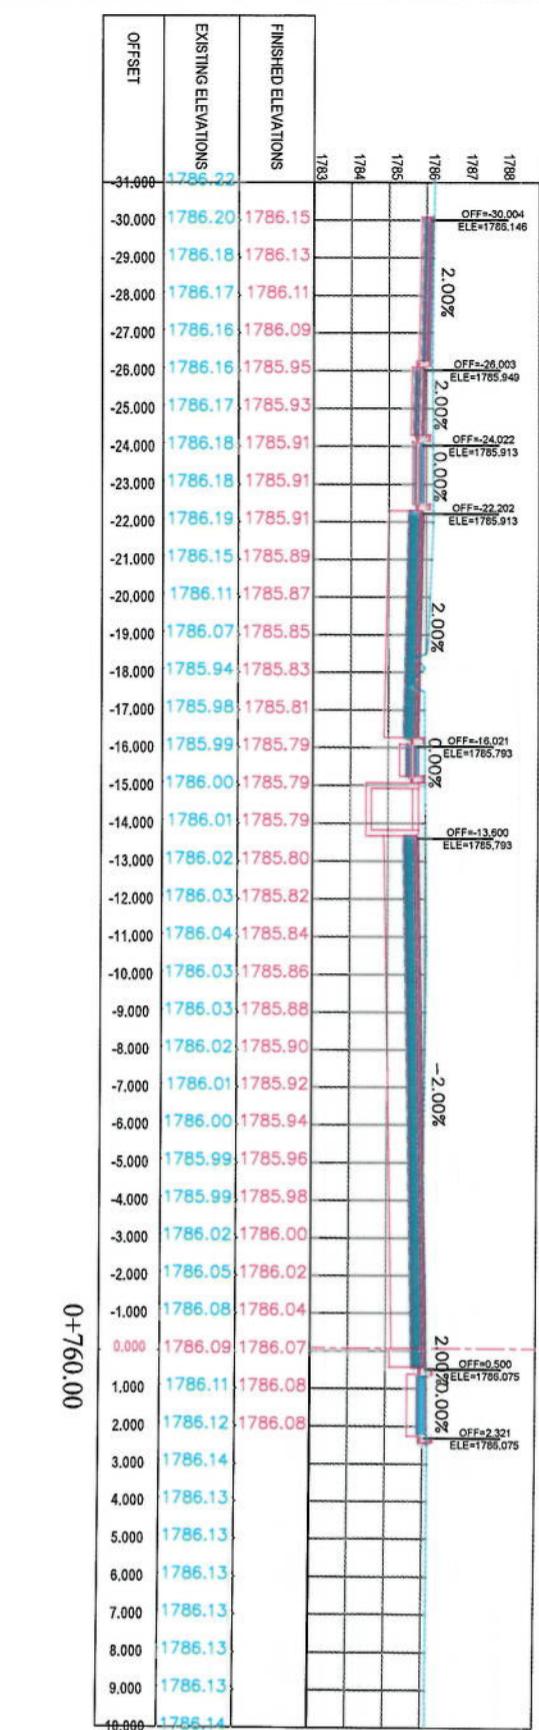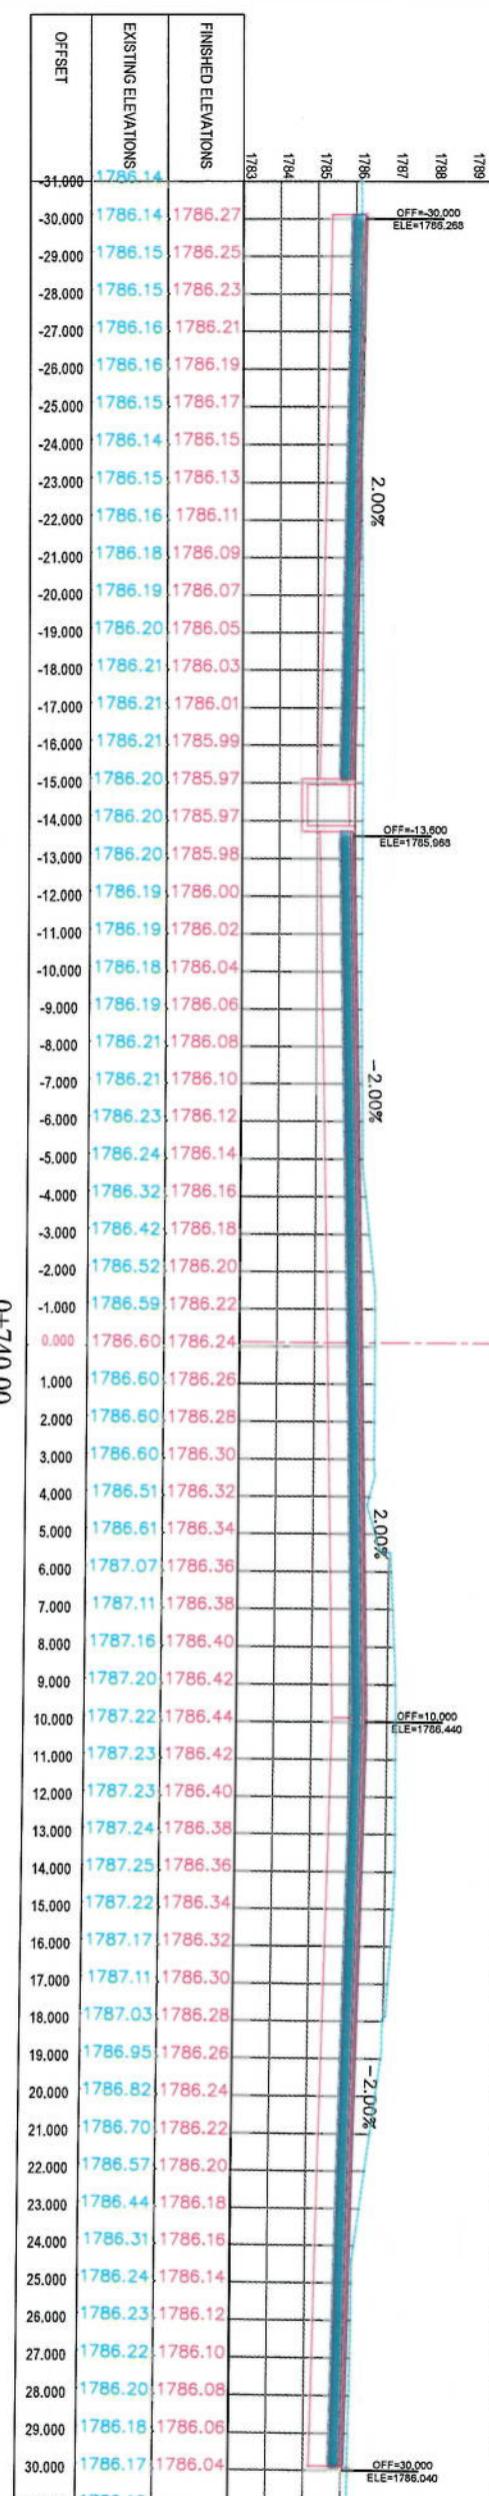


NOTE:

1. All dimensions are in meters unless otherwise indicated.

LEGENDS	
CENTER-LINE	—
EXISTING SURFACE	---
EXISTING SIDE DITCH	U

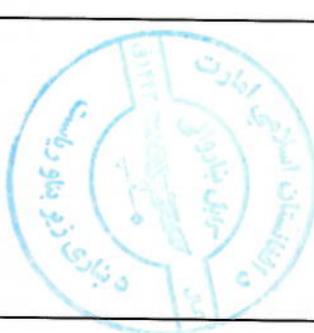

Project Name:	KABUL MUNICIPALITY
Code-Sangji To Demizing	Road Project
Drawing Title:	CROSS SECTIONS
Designed by:	Hannanullah Shahid
Drawn by:	Mohammad Ehsan Sait
Checked by:	Mohammad Ehsan Sait
Date:	6/7/2023
Scale:	1:200
Status:	FINAL DESIGN
Project Code:	CS-13
Revision:	00

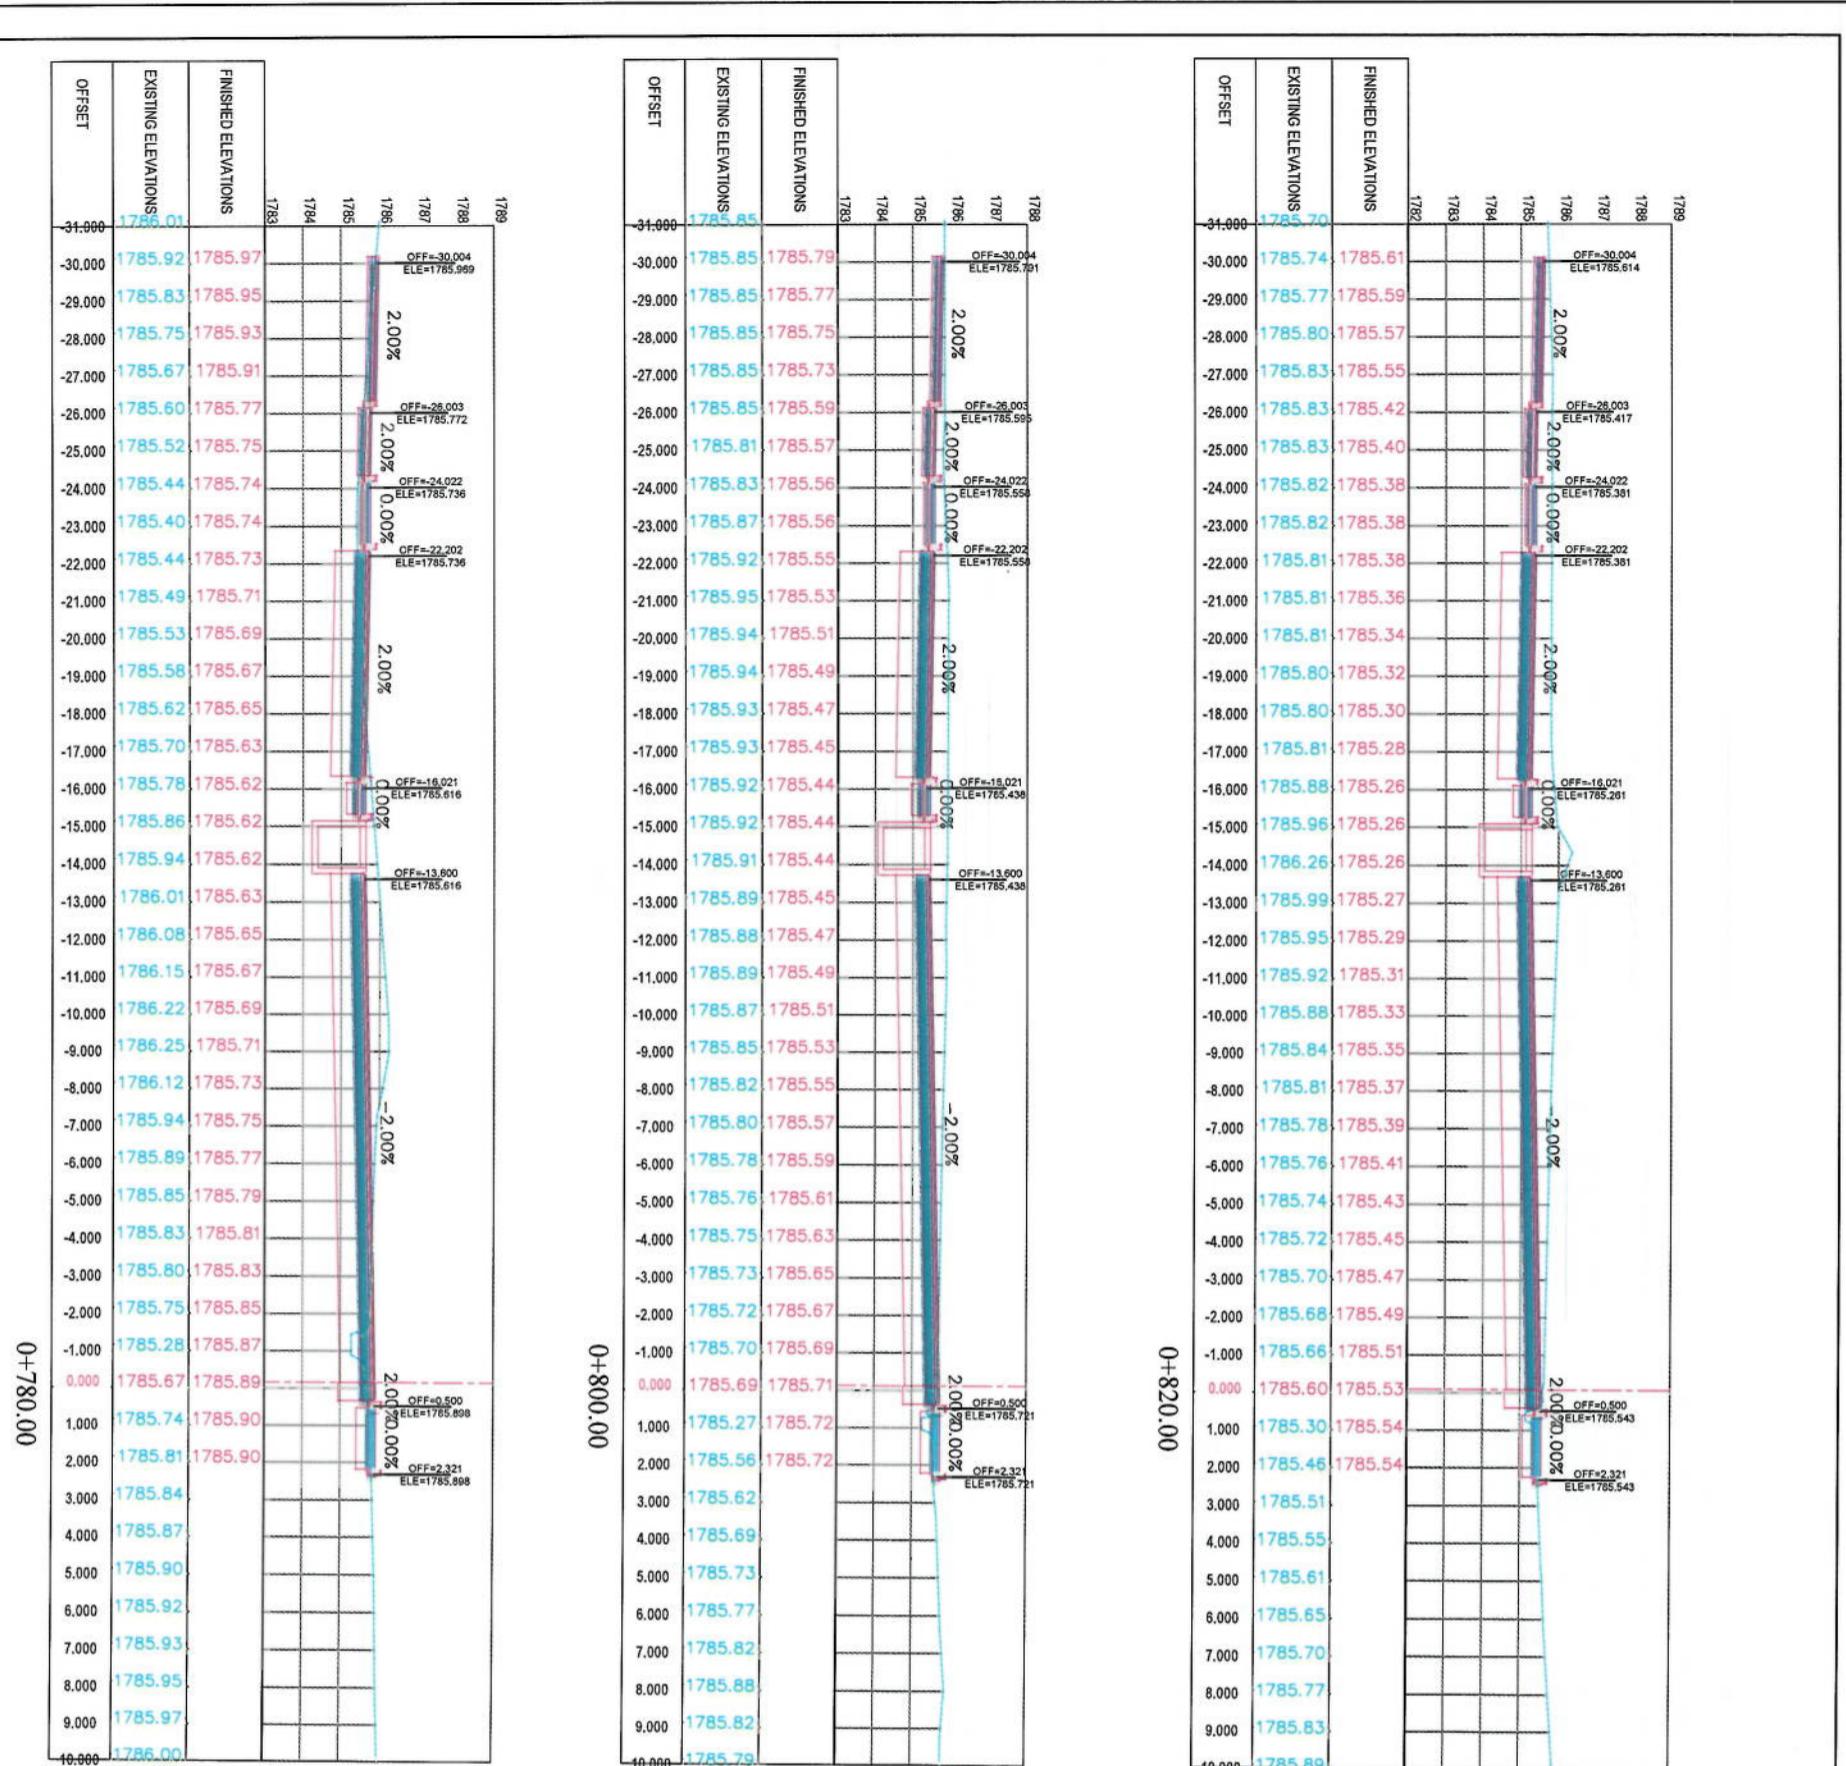

**0+780.00**

**0+800.00**

**ISLAMIC EMIRATE OF  
AFGHANISTAN**

**KABUL MUNICIPALITY**

**Client**

**ISLAMIC EMIRATE OF  
AFGHANISTAN**

**KABUL MUNICIPALITY**

Designed by:  
KABUL MUNICIPALITY  
DESIGN TEAM

Project Name:  
Cave-Sang To Demazang  
Road Project

Drawing Title:  
CROSS SECTIONS

Designed by:  
Mohammad Eisa Sait  
Signature:

Drawn by:  
Mohammad Eisa Sait  
Signature:

Checked by:  
Hasibullah Saitra  
Signature:

Date: 6/7/2023 Scale: 1:200

Status: FINAL DESIGN

Project Code: CS-14 Revision: 00

**NOTE:**


- All dimensions are in meters unless otherwise indicated.

**LEGENDS**

- CENTER-LINE**: Solid red line.
- EXISTING SURFACE**: Dashed blue line.
- EXISTING SIDE DITCH**: Blue line with a small square symbol.

**ISLAMIC EMIRATE OF  
AFGHANISTAN**

**KABUL MUNICIPALITY**

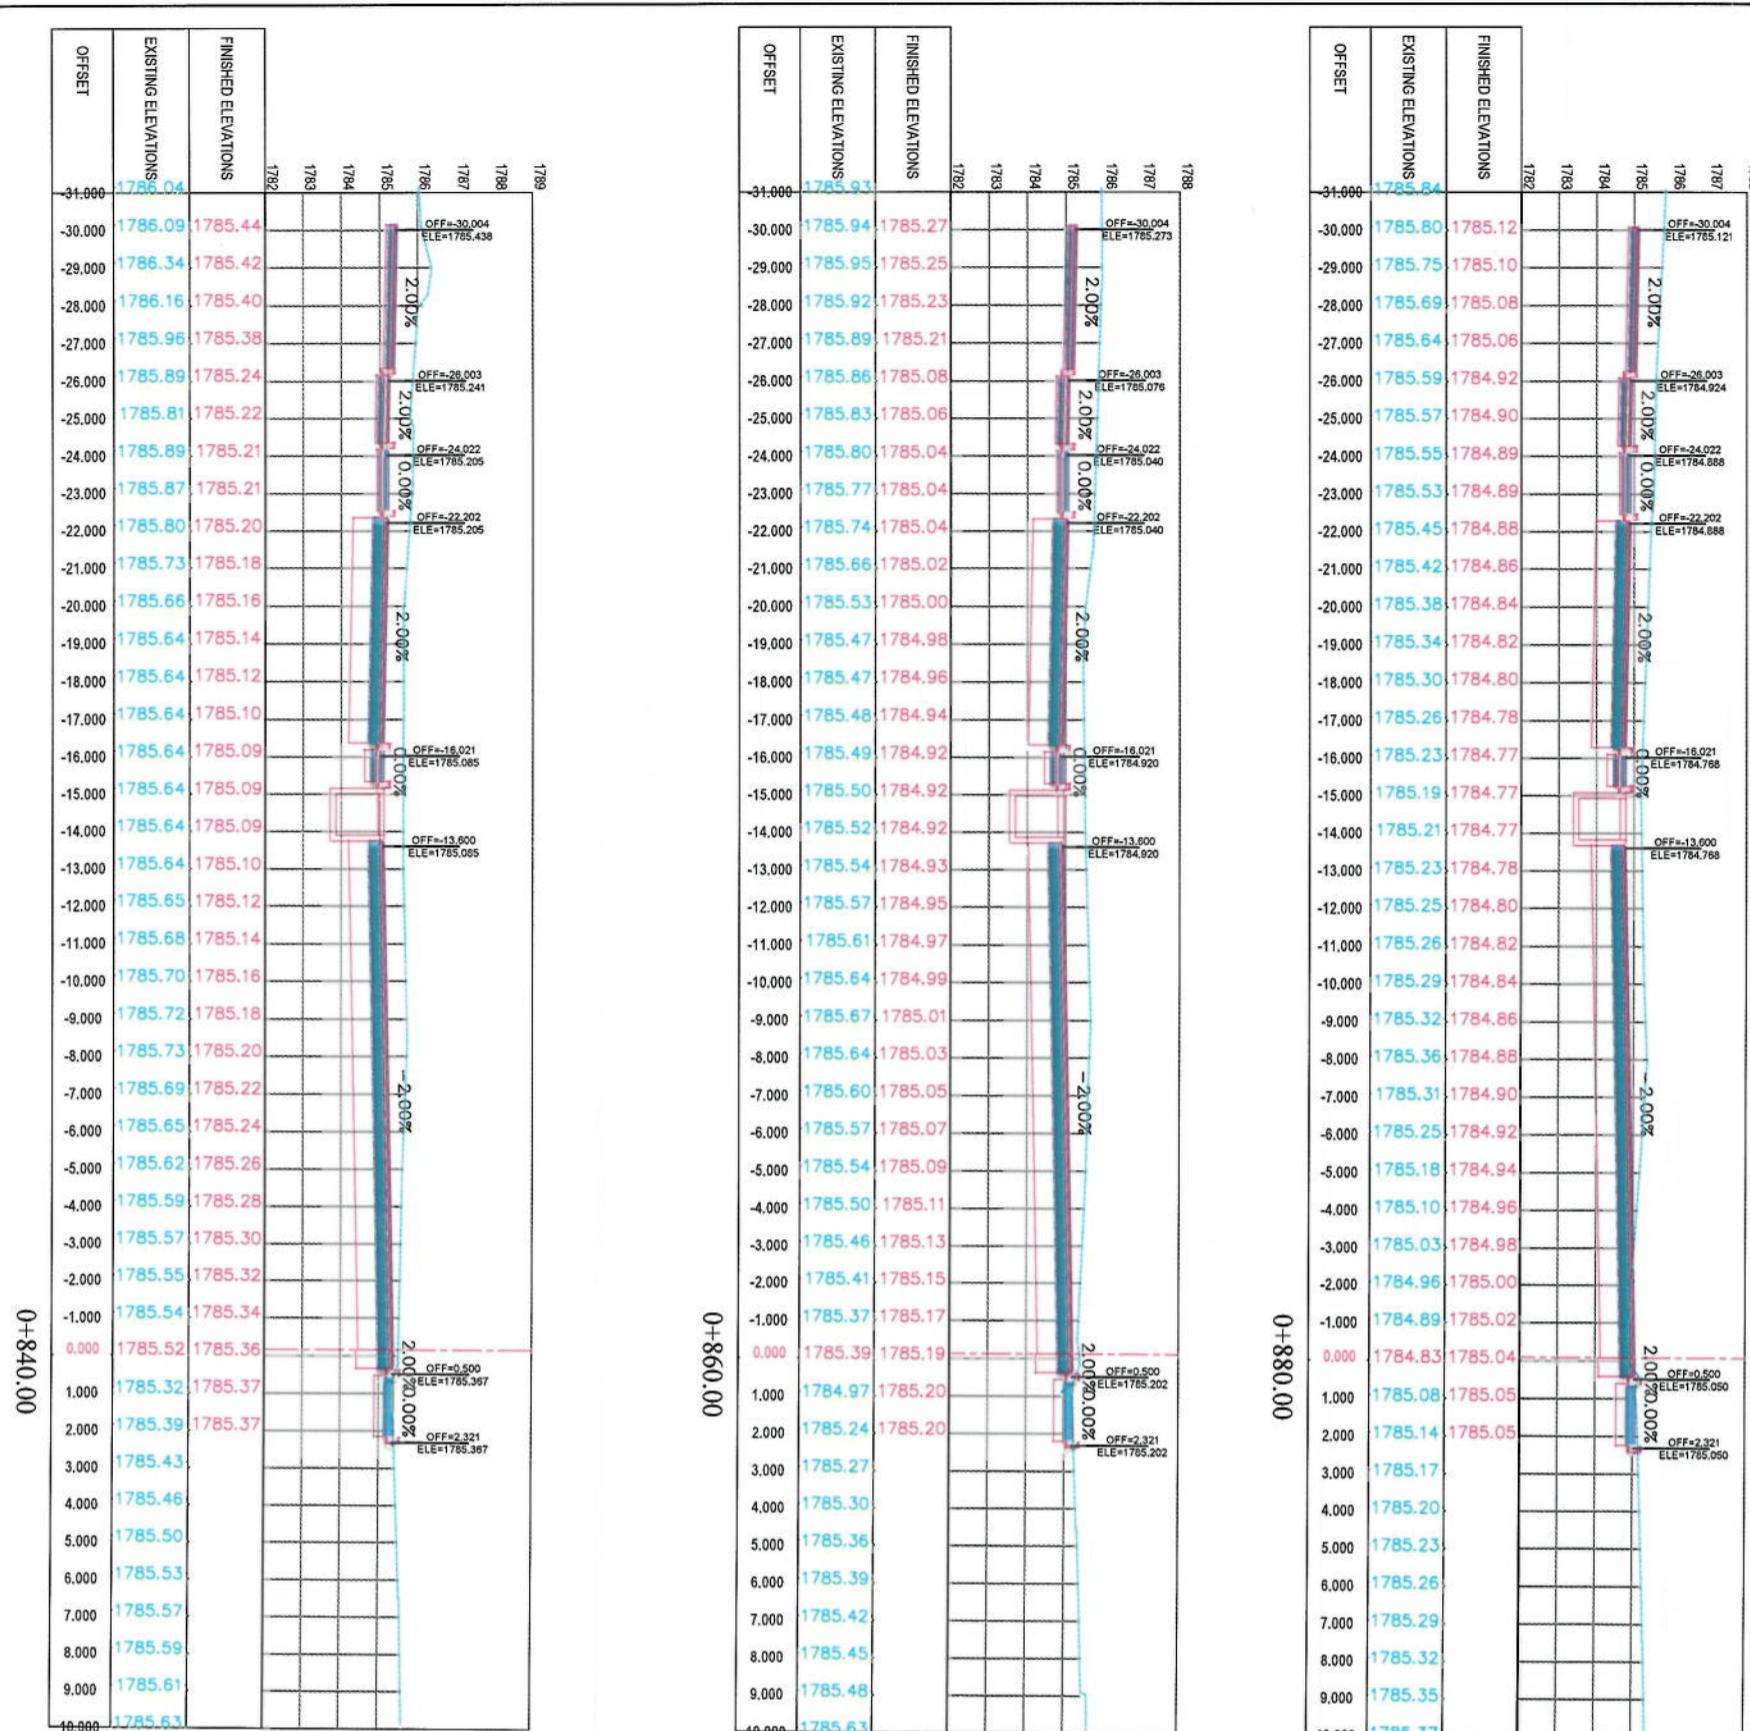



NOTE:

1. All dimensions are in metres unless otherwise indicated.


LEGENDS		
<span style="color:red;">—</span>	CENTER-LINE	
<span style="color:blue;">—</span>	EXISTING SURFACE	
<span style="color:blue;">—</span>	EXISTING SIDE DITCH	



Project Name:	KABUL MUNICIPALITY DESIGN TEAM
Drawing Title:	Co-e-Swag To Demazang Road Object
Designed by:	KABUL MUNICIPALITY
Checked by:	Husnulah Shabiz
Date:	6/7/2023
Scale:	1:200
Status:	FINAL DESIGN
Project Code:	CS-15
Drawing Number:	00

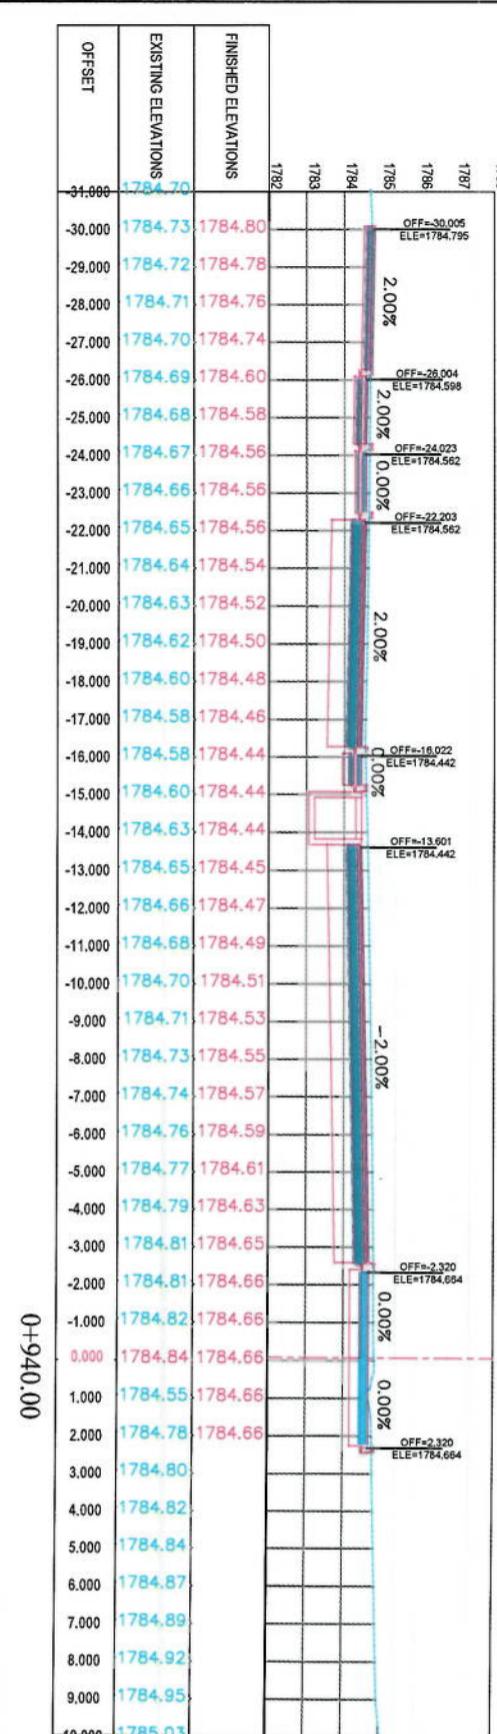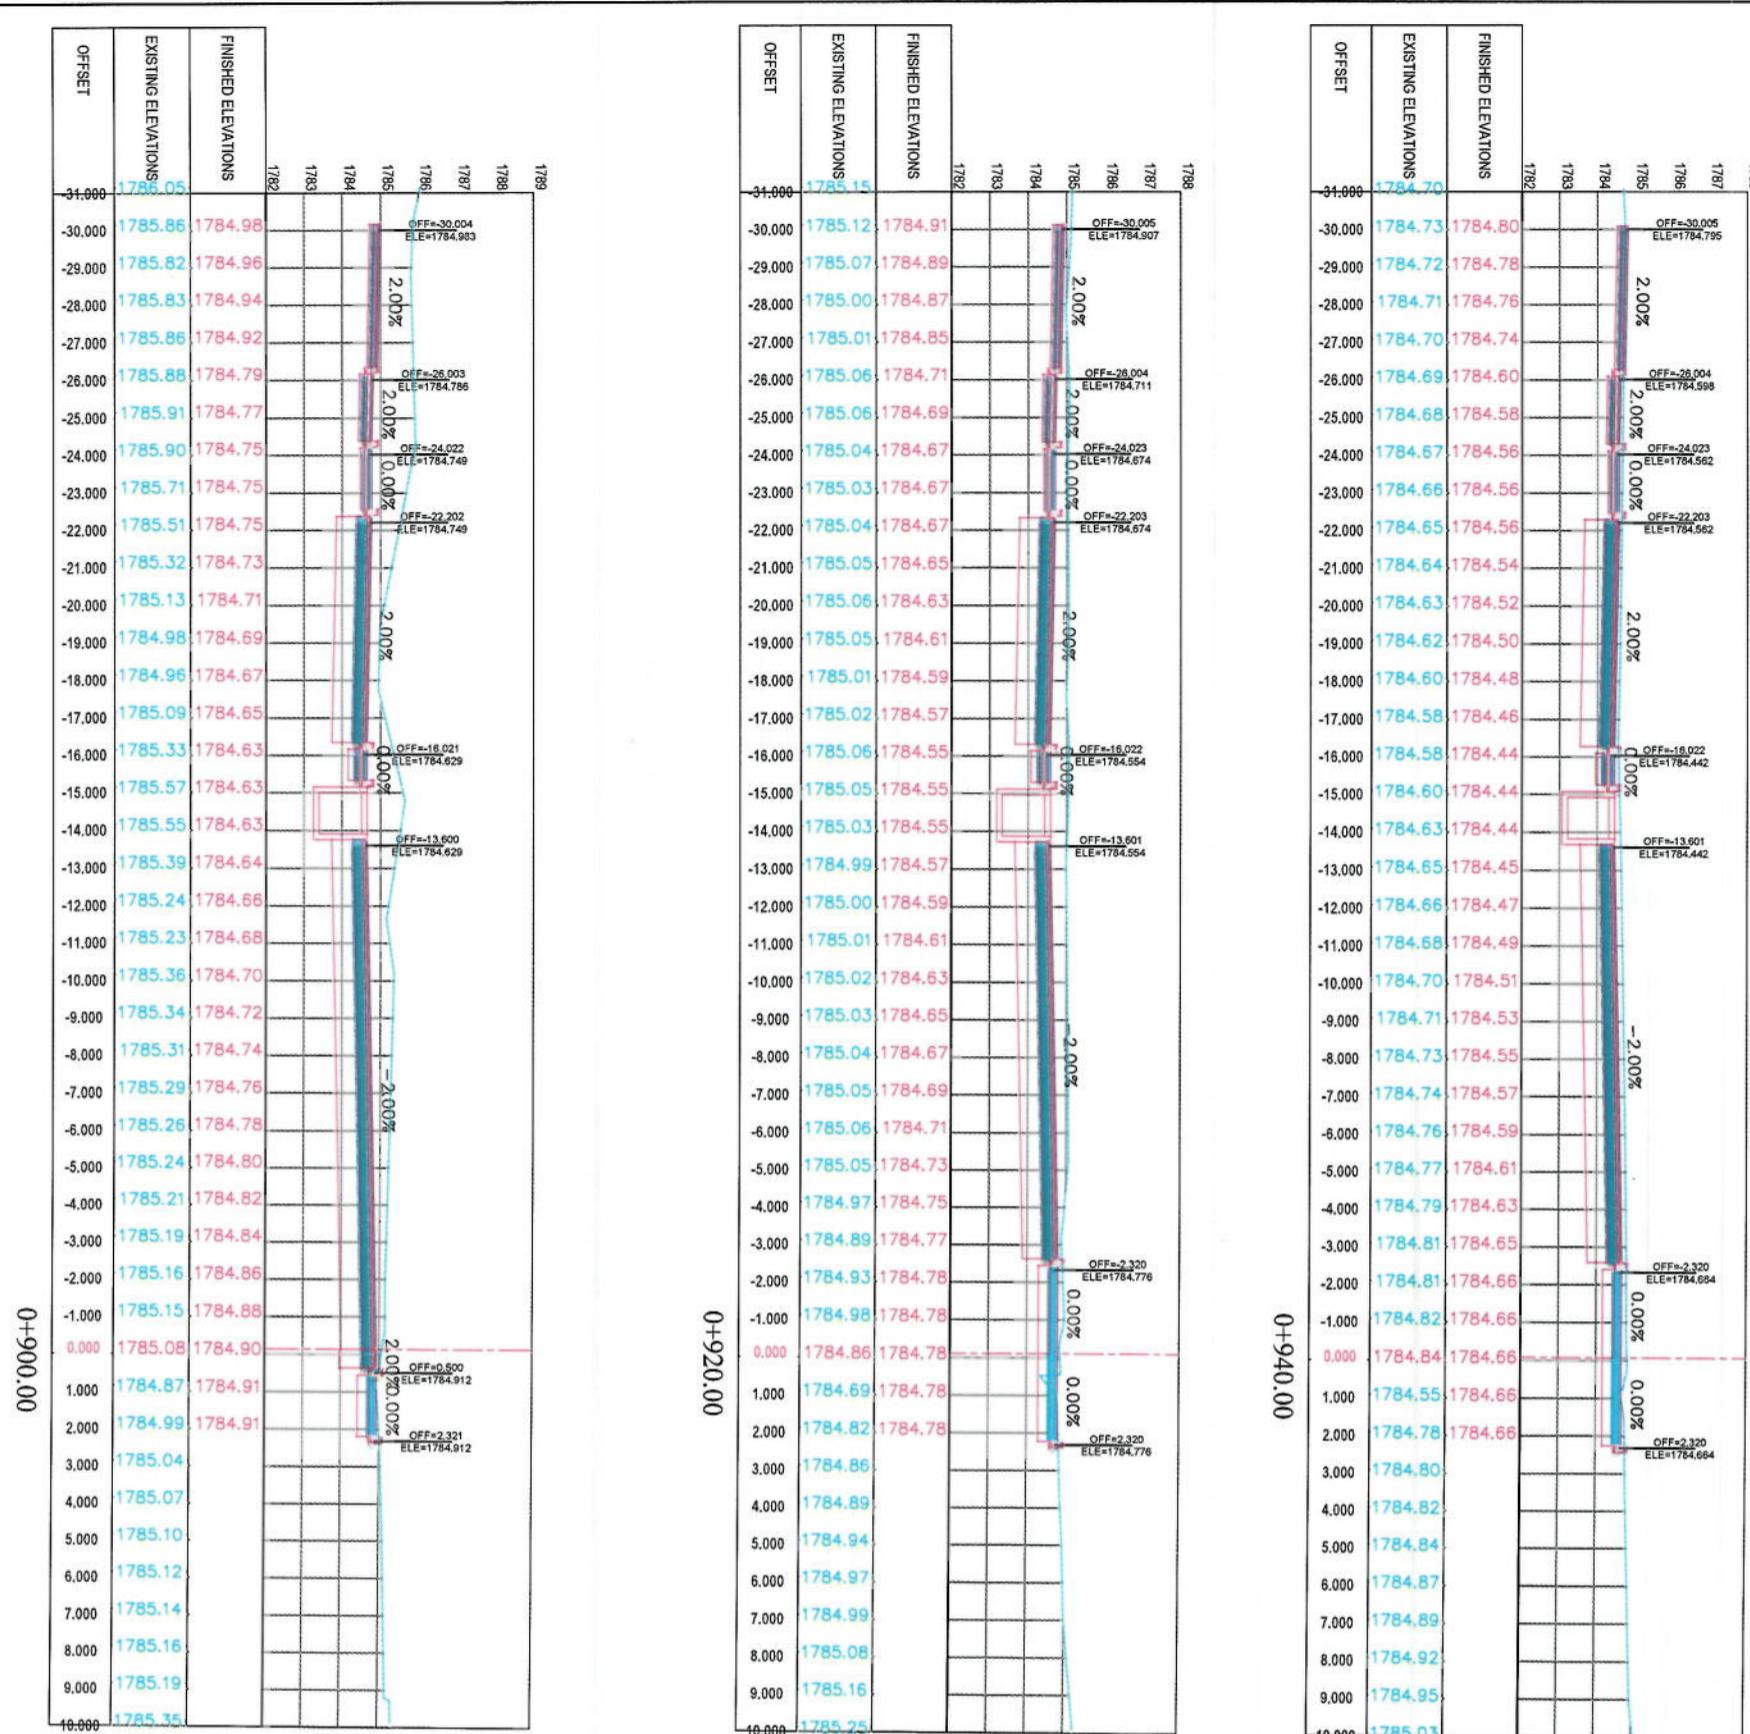

0+960.00

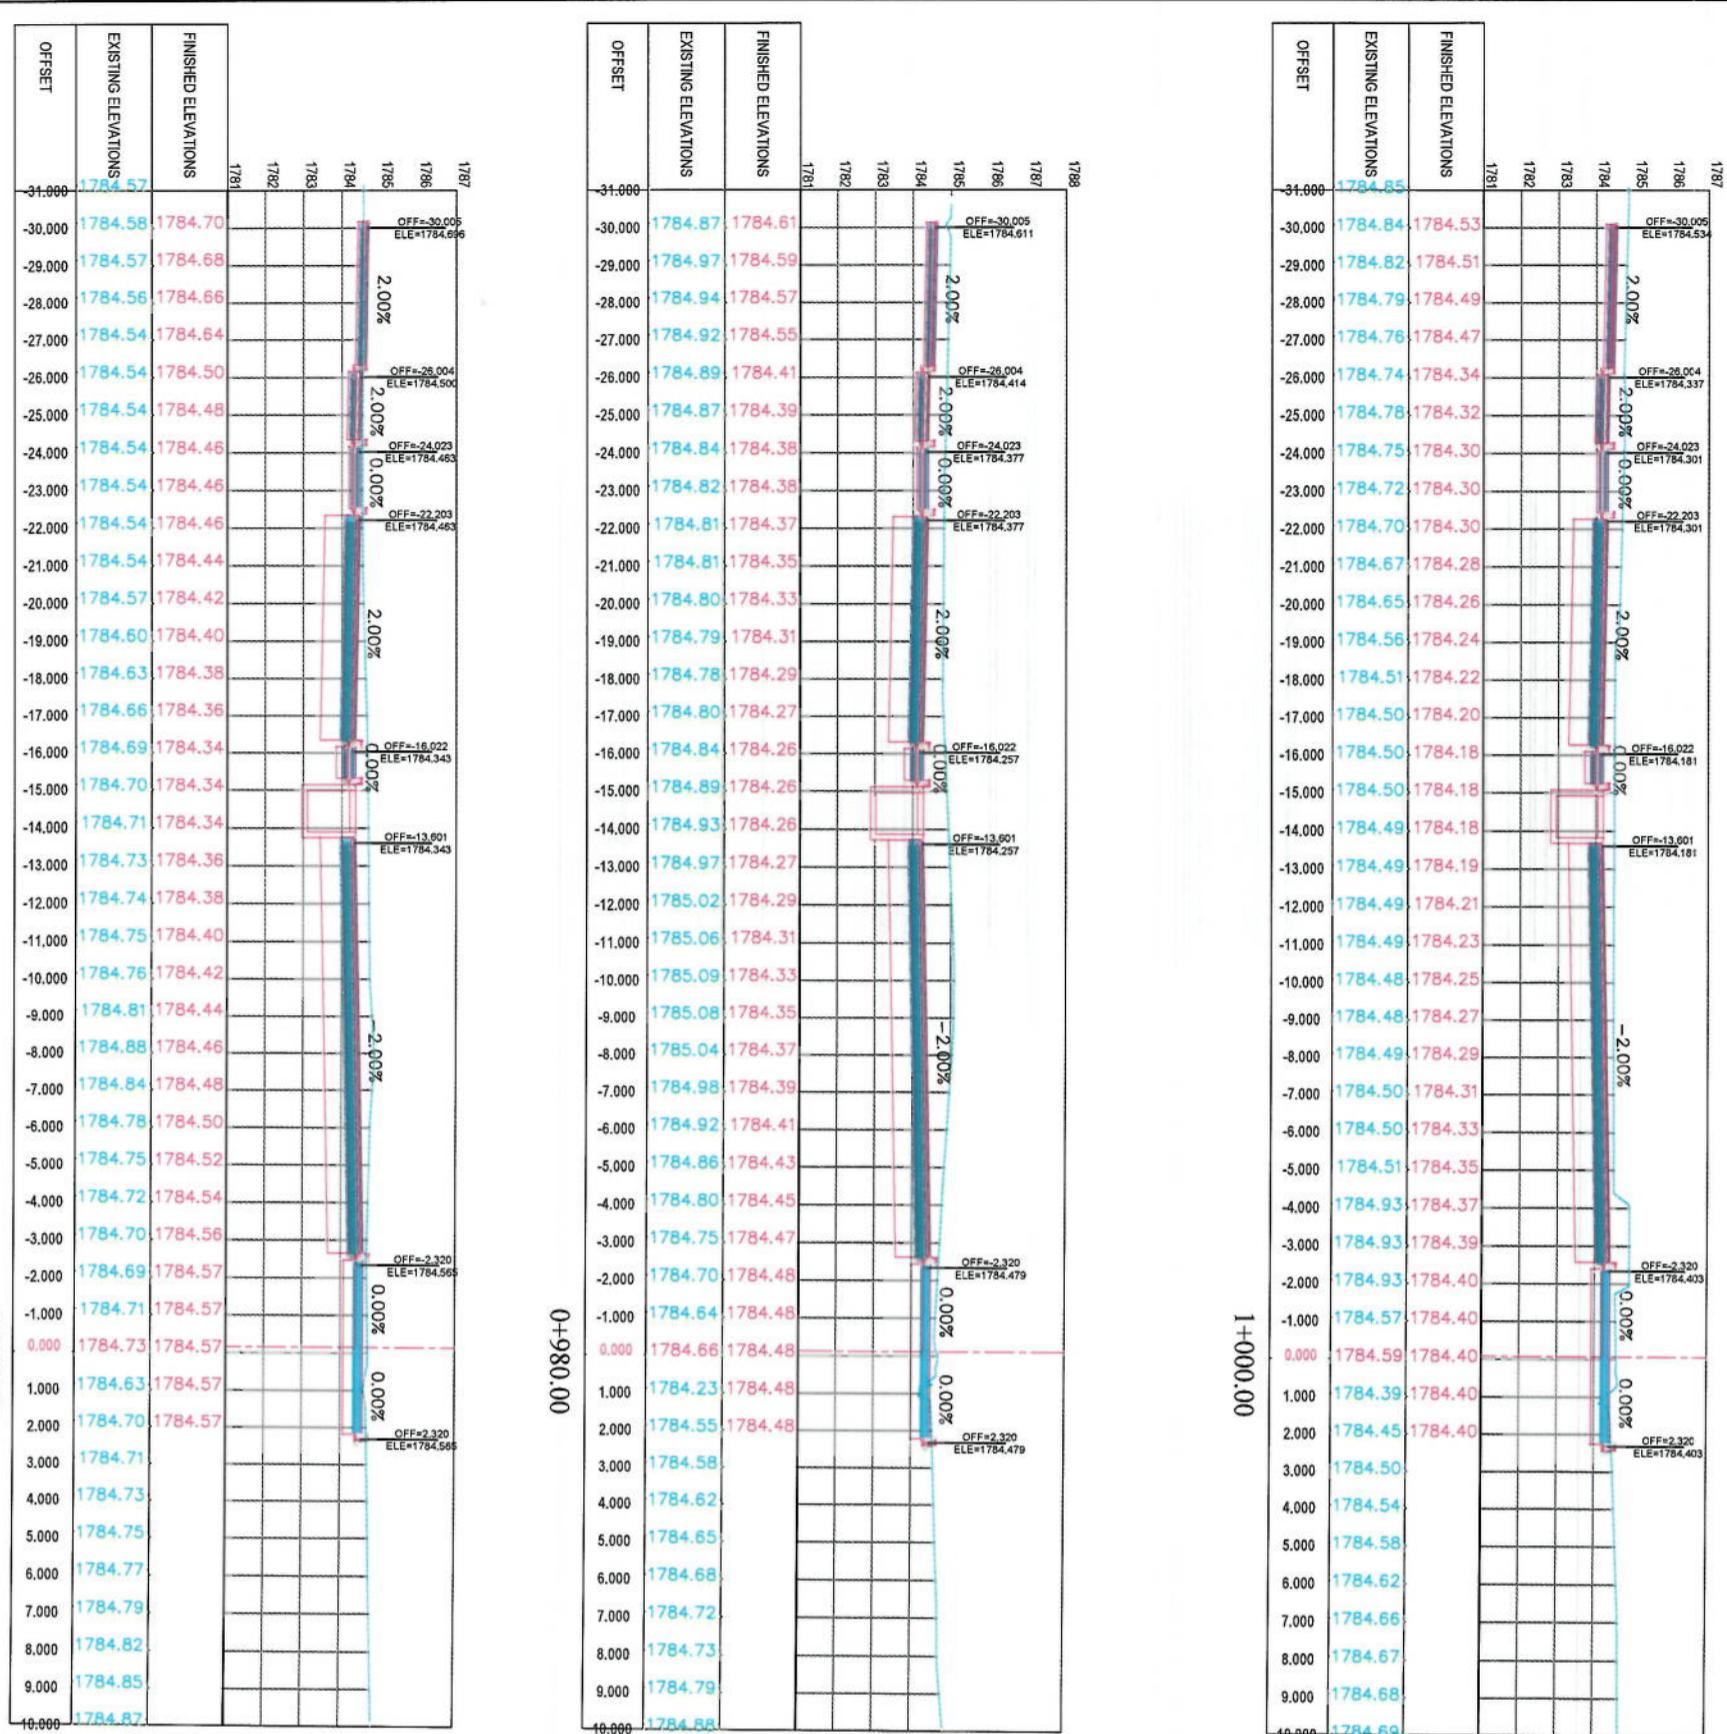


NOTE:

1. All dimensions are in metres unless otherwise indicated

**LEGENDS**

- CENTER-LINE
- EXISTING SURFACE
- EXISTING SIDE-DITCH

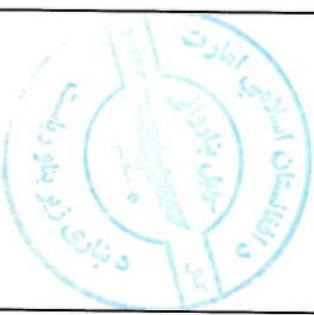

ISLAMIC EMIRATE OF  
AFGHANISTAN  
KABUL MUNICIPALITY

Designed by:  
KARUIL MUNICIPALITY  
DESIGN TEAM

Project Name:  
Cord-Sangi To Demizing  
Road Project

CROSS SECTIONS





Designed by:  
Mohammad Eesa Sirat  
Drawn by:  
Mohammad Eesa Sirat  
Checked by:  
Hamidullah Shabizi

Date: 6/7/2023      Scale: 1:200

Same: FINAL DESIGN

Project Code: CS-17


Revision: 00

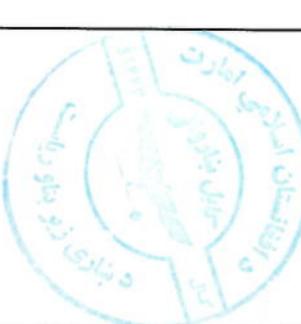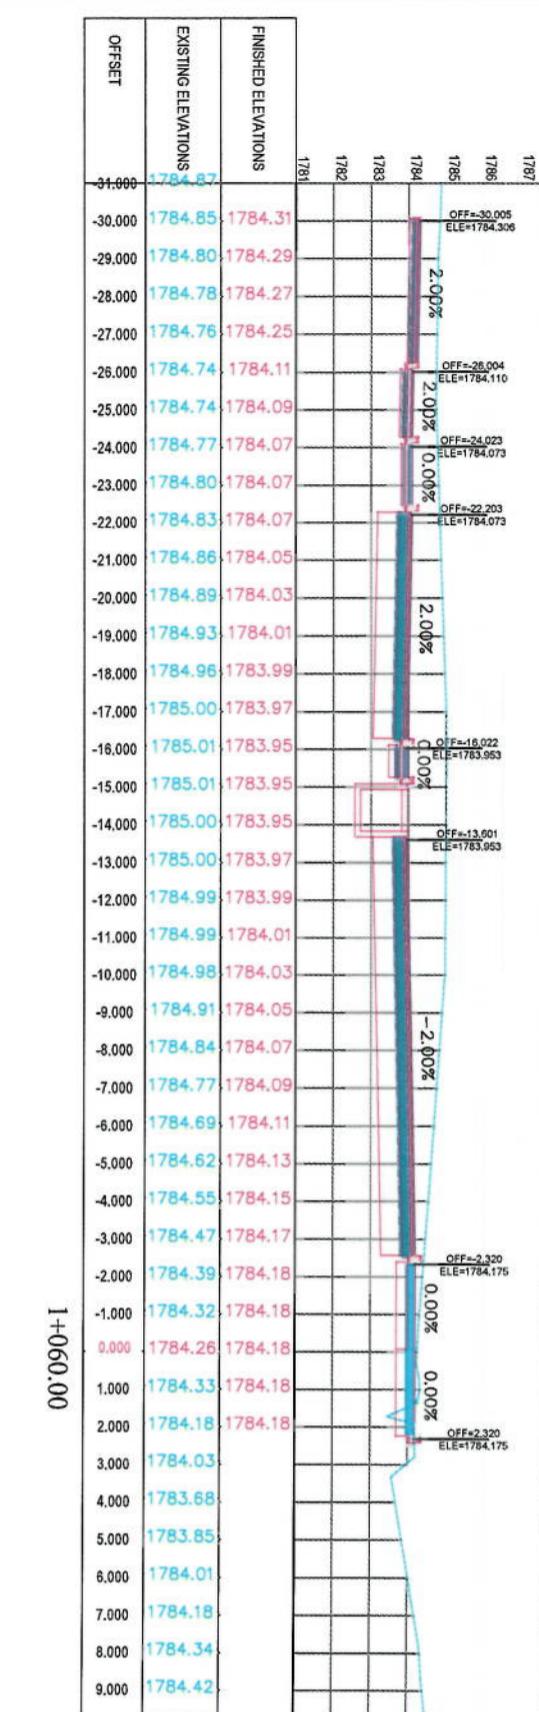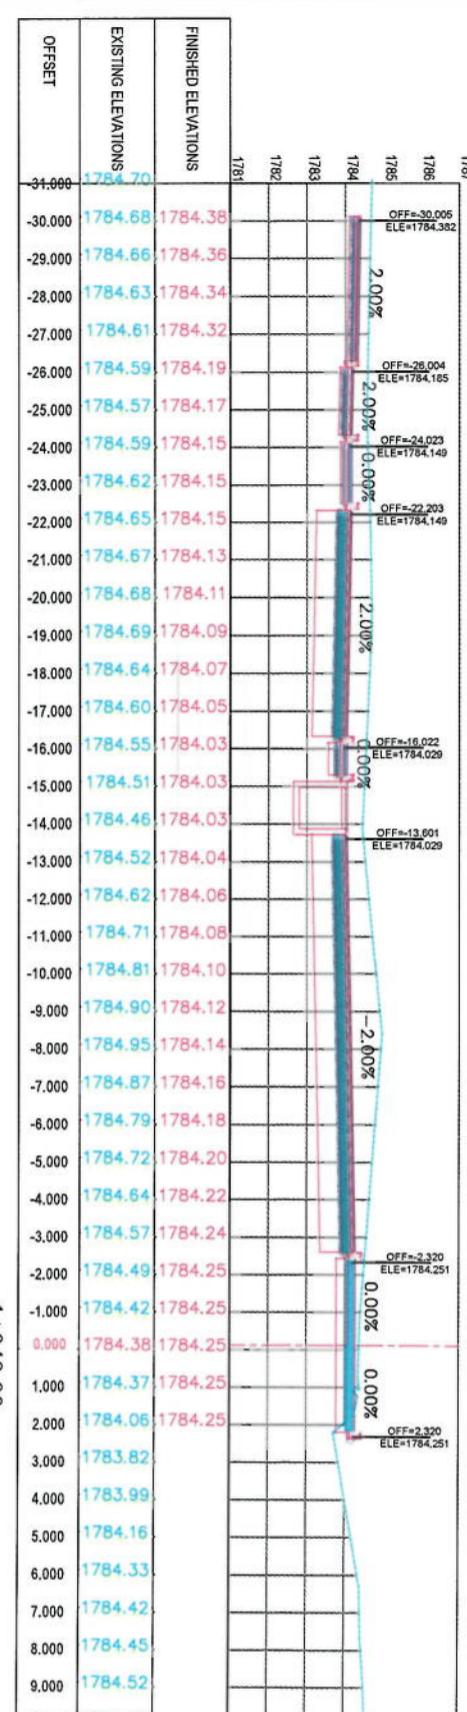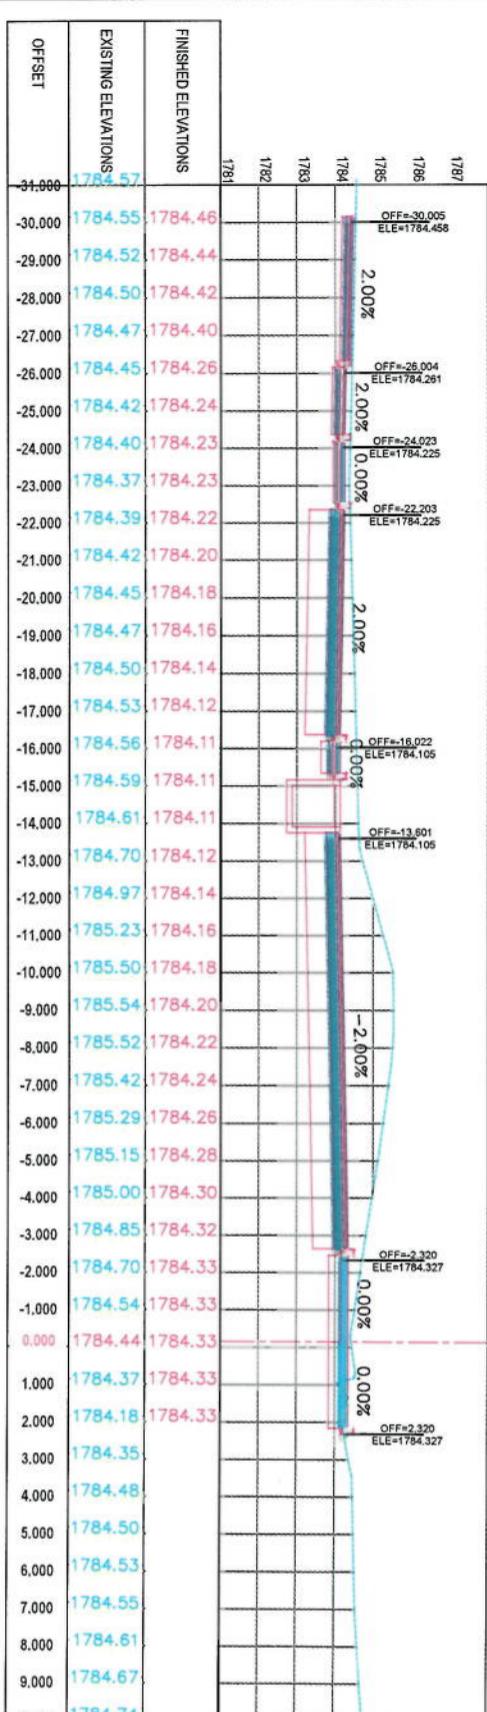

NOTE  
1. All dimensions are in meters unless otherwise indicated.

LEGENDS  
 — CENTER-LINE  
 - - - EXISTING SURFACE  
 - - - EXISTING SIDE DITCH

Project Name:	KABUL MUNICIPALITY DESIGN TEAM	
Drawing Title:	Cot-e-Sang To Demzang Road project	
Checked by:	Hasnullah Shabazi	
Date:	6/7/2023	
Status:	FINAL DESIGN	
Project Code:	CS-18	
Drawing Number:	00	

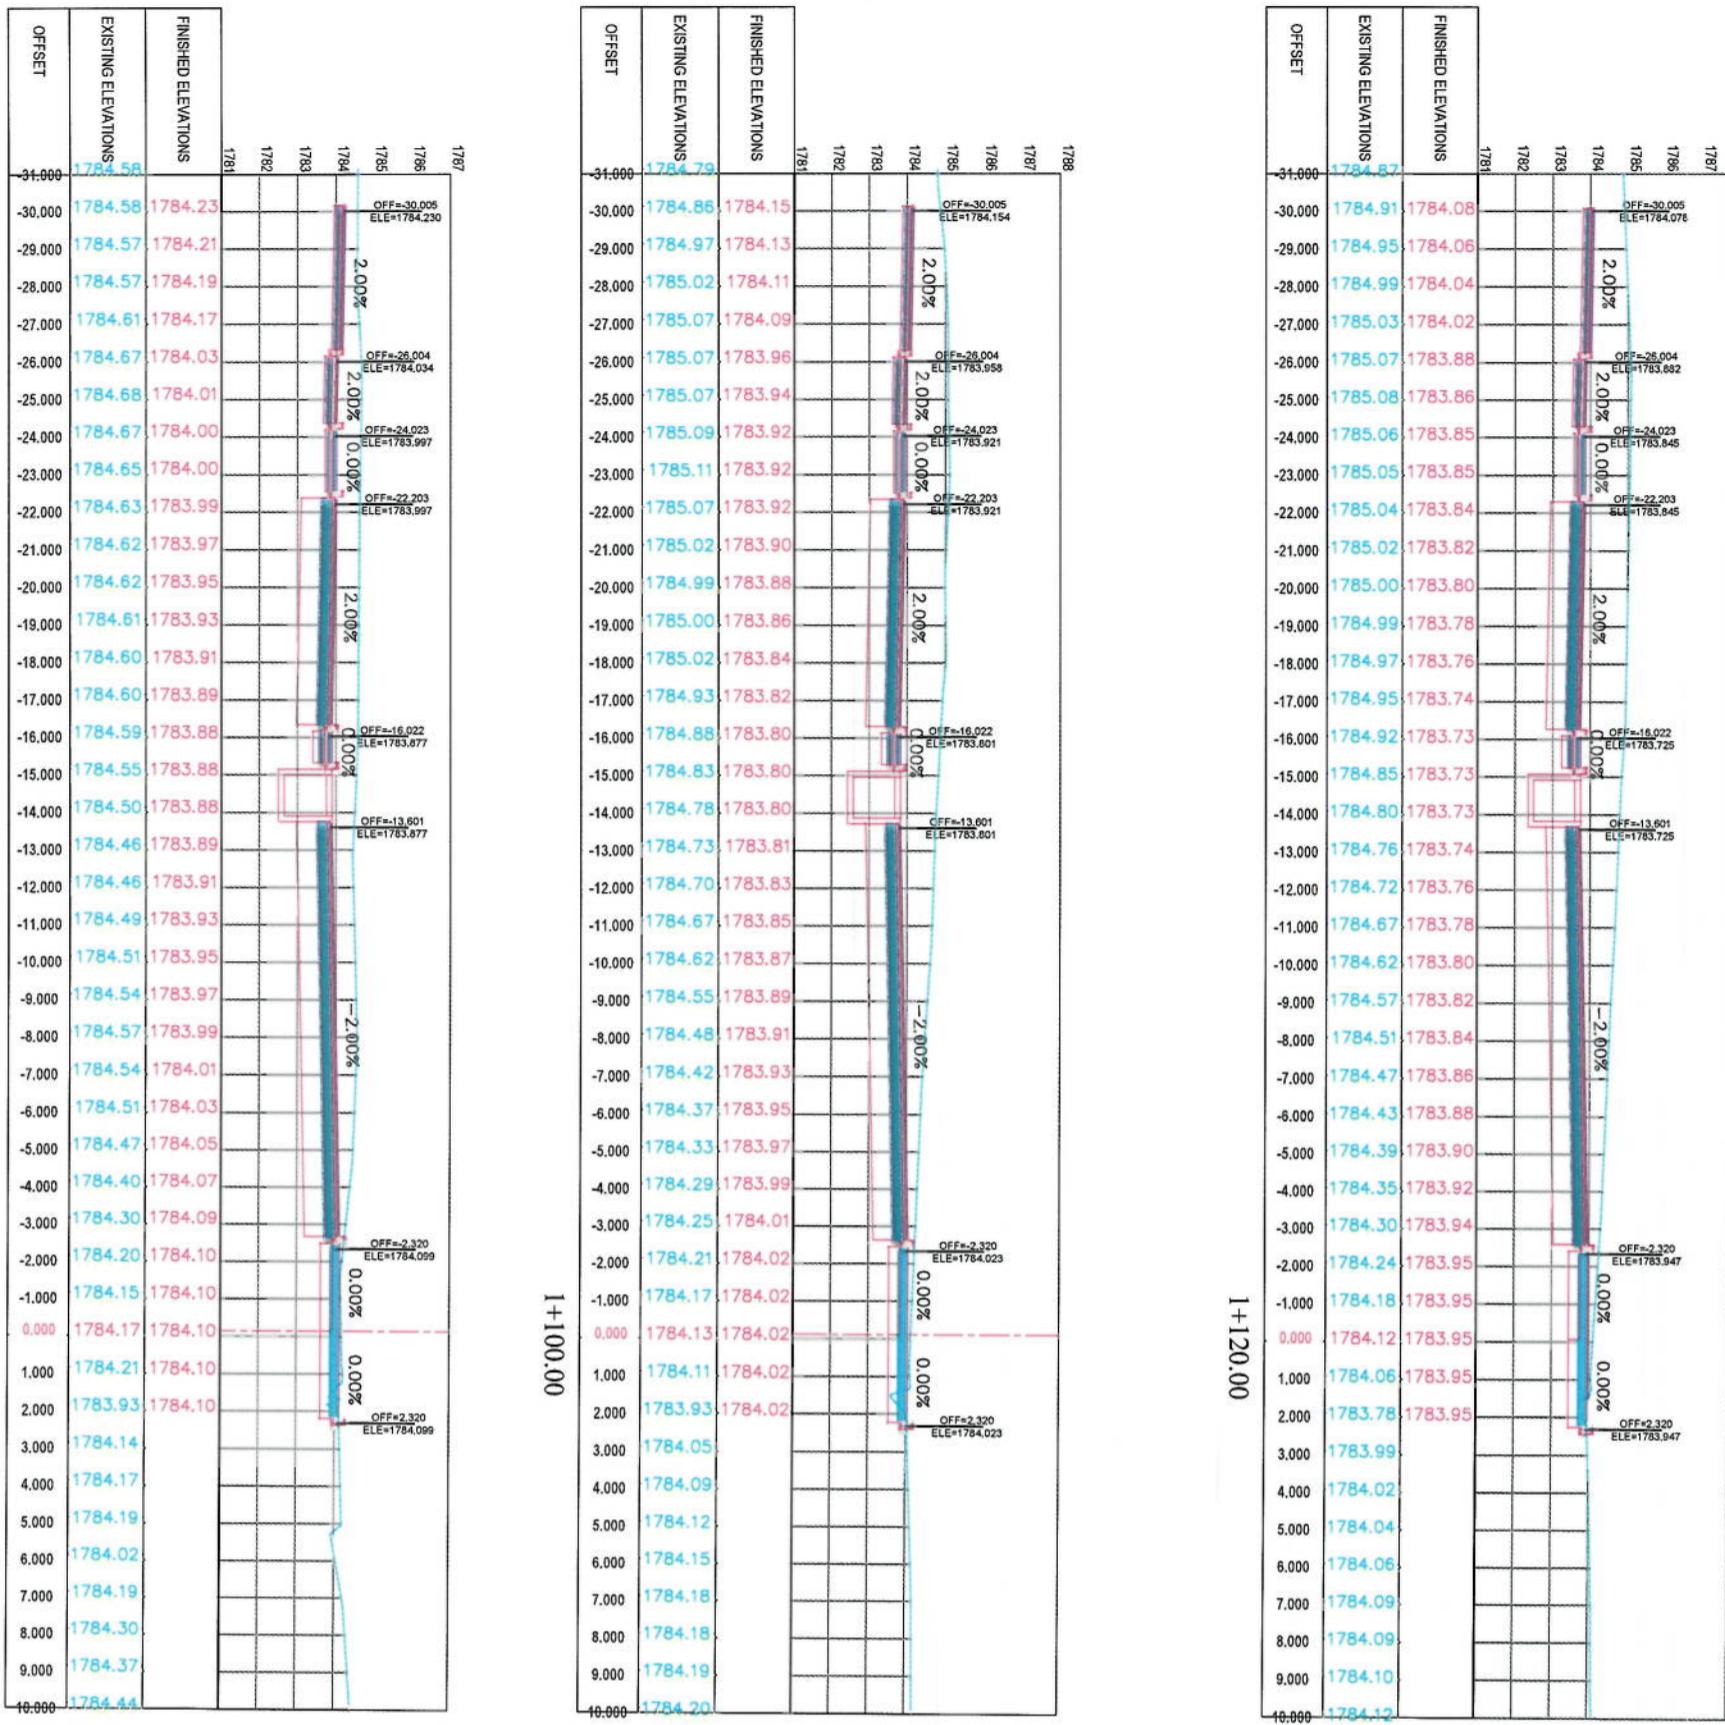

Project Name:	KABUL MUNICIPALITY DESIGN TEAM		
Drawing Title:	Cross-Section To Demazang Road Project		
Designed By:	KABUL MUNICIPALITY		
Drawn by:	Signature: Mohammad Esa Sait		
Checked by:	Signature: Hashimullah Saitz		
Date:	6/7/2023		
Scale:	1:200		
Status:	FINAL DESIGN		
Project Code:			
Drawing Number:	CS-19	Revision:	00




NOTE:

1. All dimensions are in meters unless otherwise indicated.

LEGENDS

- CENTER-LINE
- EXISTING SURFACE
- EXISTING SIDE DITCH



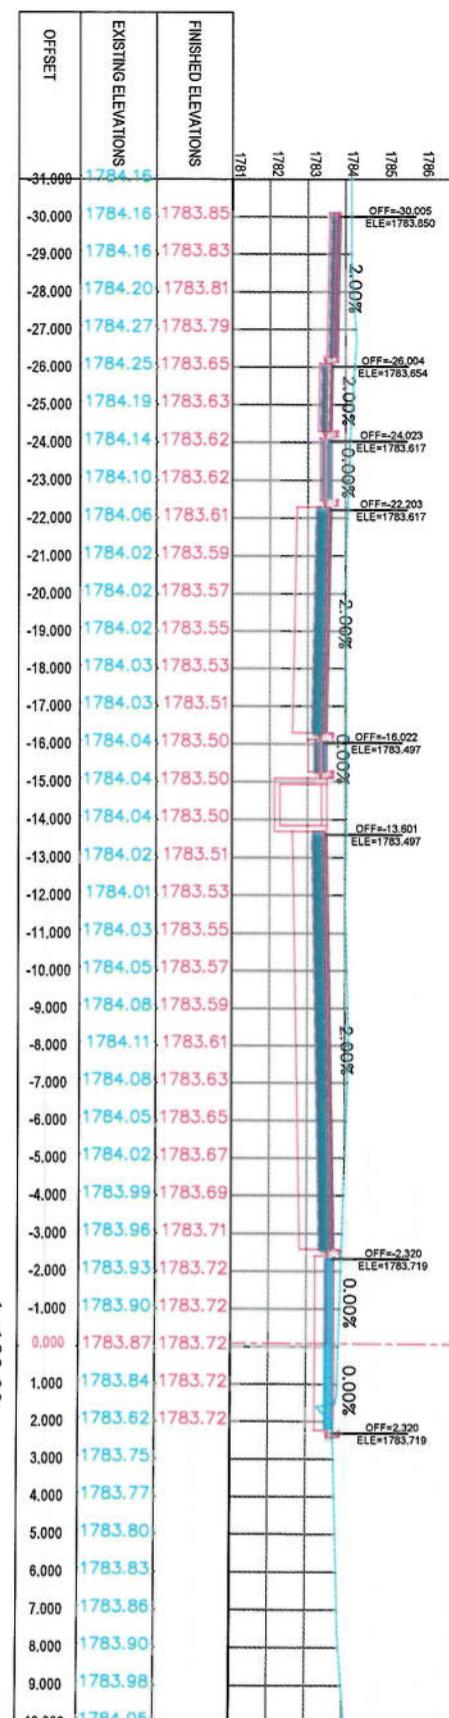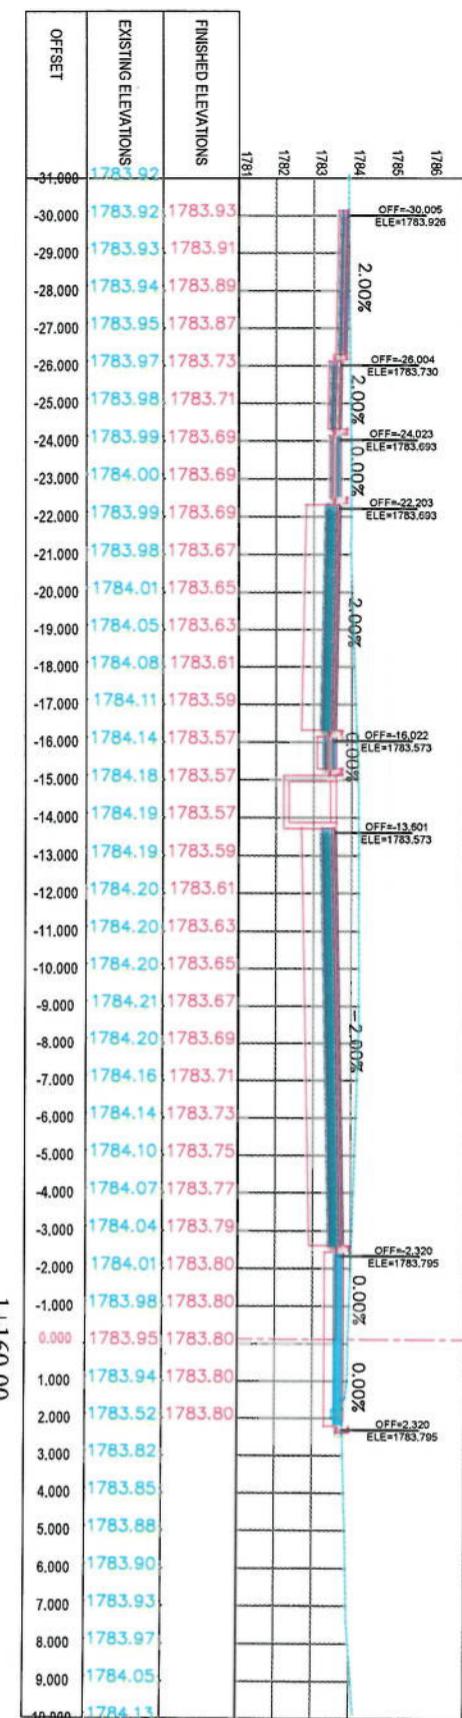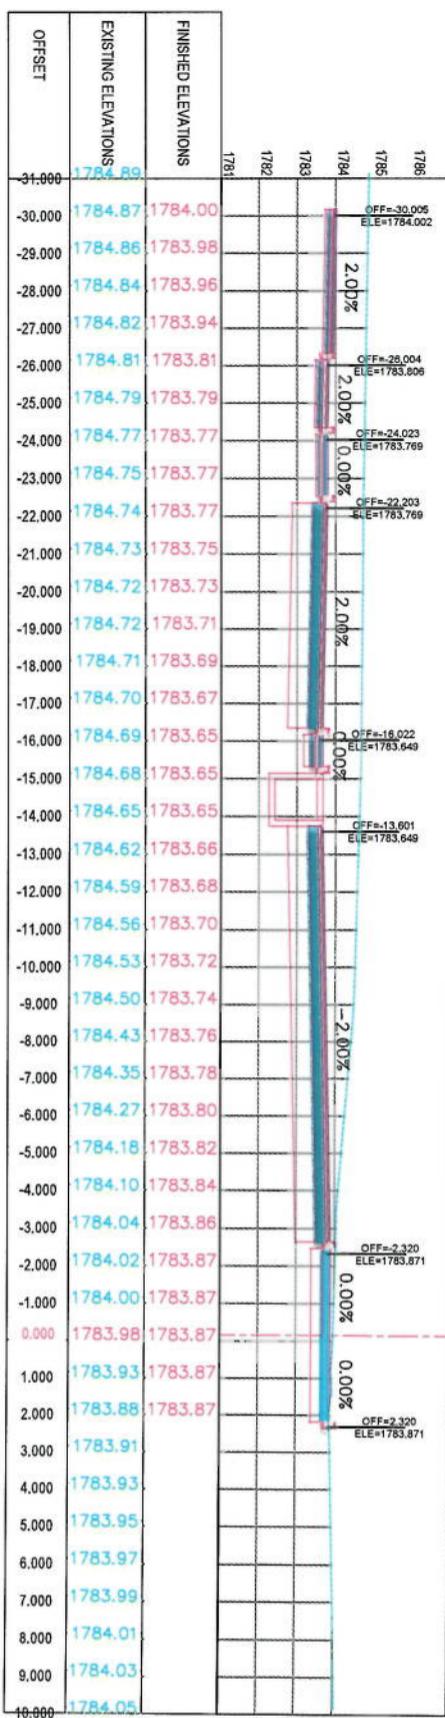


1+140.00

1+160.00


1+180.00

NOTE:  
1. All dimensions are in metres unless  
otherwise indicated.



LEGENDS	
<span style="color:red;">—</span>	CENTER-LINE
<span style="color:blue;">—</span>	EXISTING SURFACE
<span style="color:blue;">—</span>	EXISTING SIDE DITCH

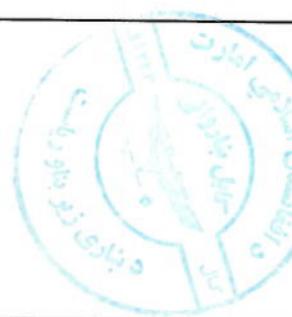

CROSS SECTIONS	
Designed by:	KABUL MUNICIPALITY DESIGN TEAM
Project Name:	KABUL MUNICIPALITY AFGHANISTAN
Drawing Title:	Coce-Sang To Demzang Road Project
Designed By:	Mohammad Eesa Sint 
Drawn by:	Mohammad Eesa Sint 
Checked by:	Hassanullah Shabaz 
Date:	6/7/2023
Scale:	1:200
Status:	FINAL DESIGN
Project Code:	
Drawing Number:	CS-20
Revision:	00

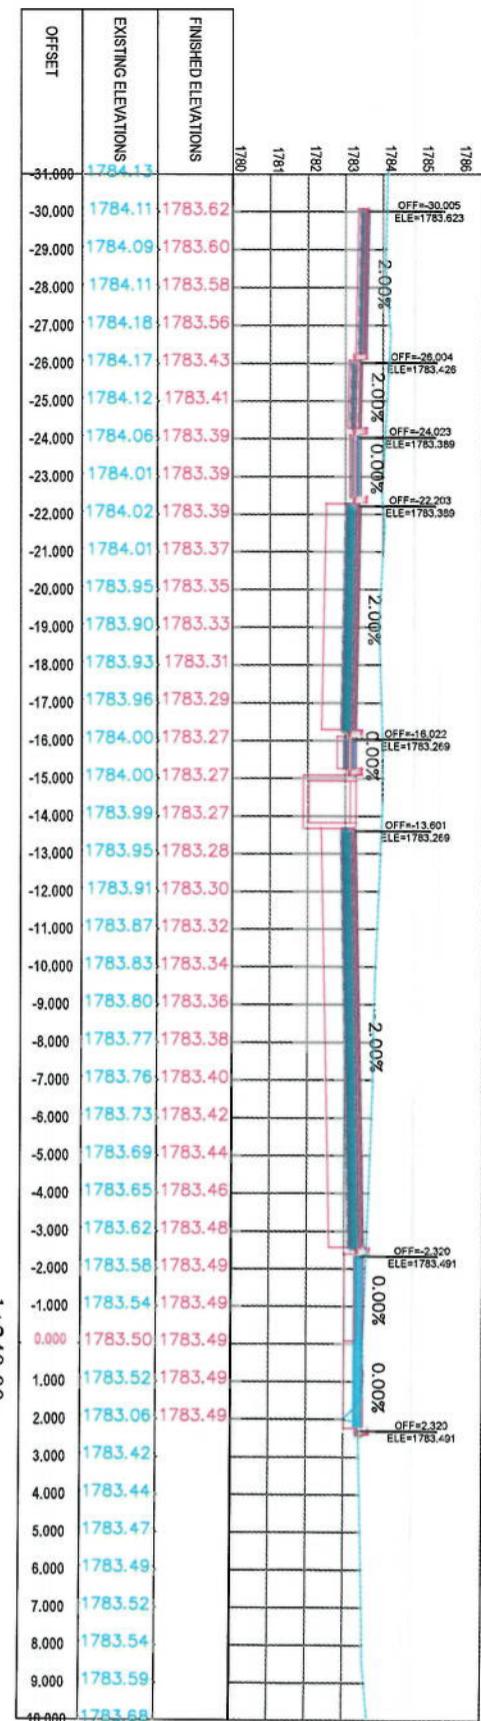

1+240.00

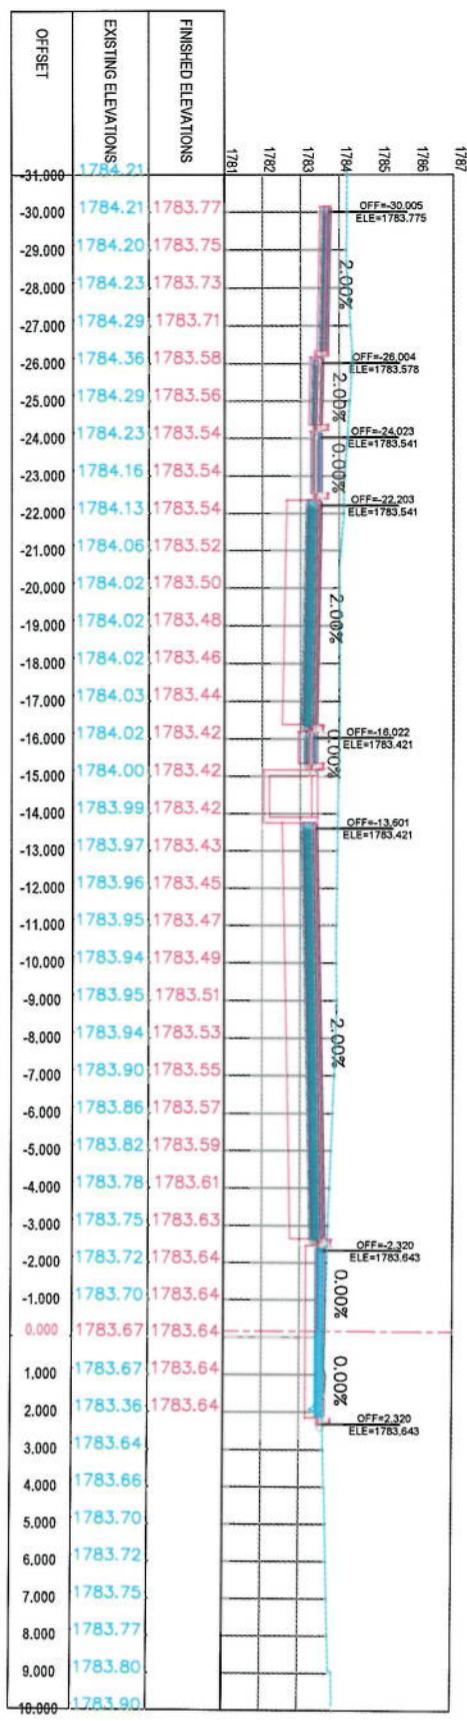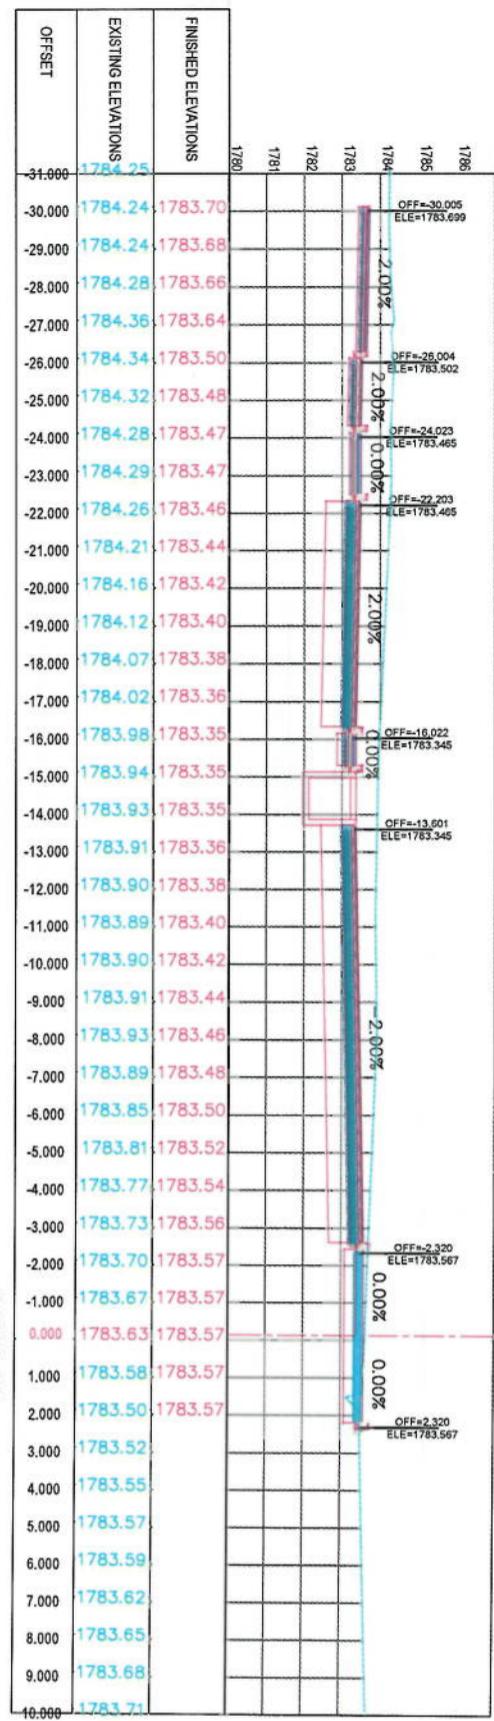

Project Name:	KABUL MUNICIPALITY		
Drawing Title:	CROSS SECTIONS		
Designed by:	Signature: Mohammad Ehsan Sial		
Drawn by:	Signature: Mohammad Ehsan Sial		
Checked by:	Signature: Hameedullah Sialzi		
Date:	6/7/2023		
Scale:	1:200		
Status:	FINAL DESIGN		
Project Code:			
Drawing Number:	CS-21	Revision	00




LEGENDS

CENTER-LINE

EXISTING SURFACE

EXISTING SIDE DITCH


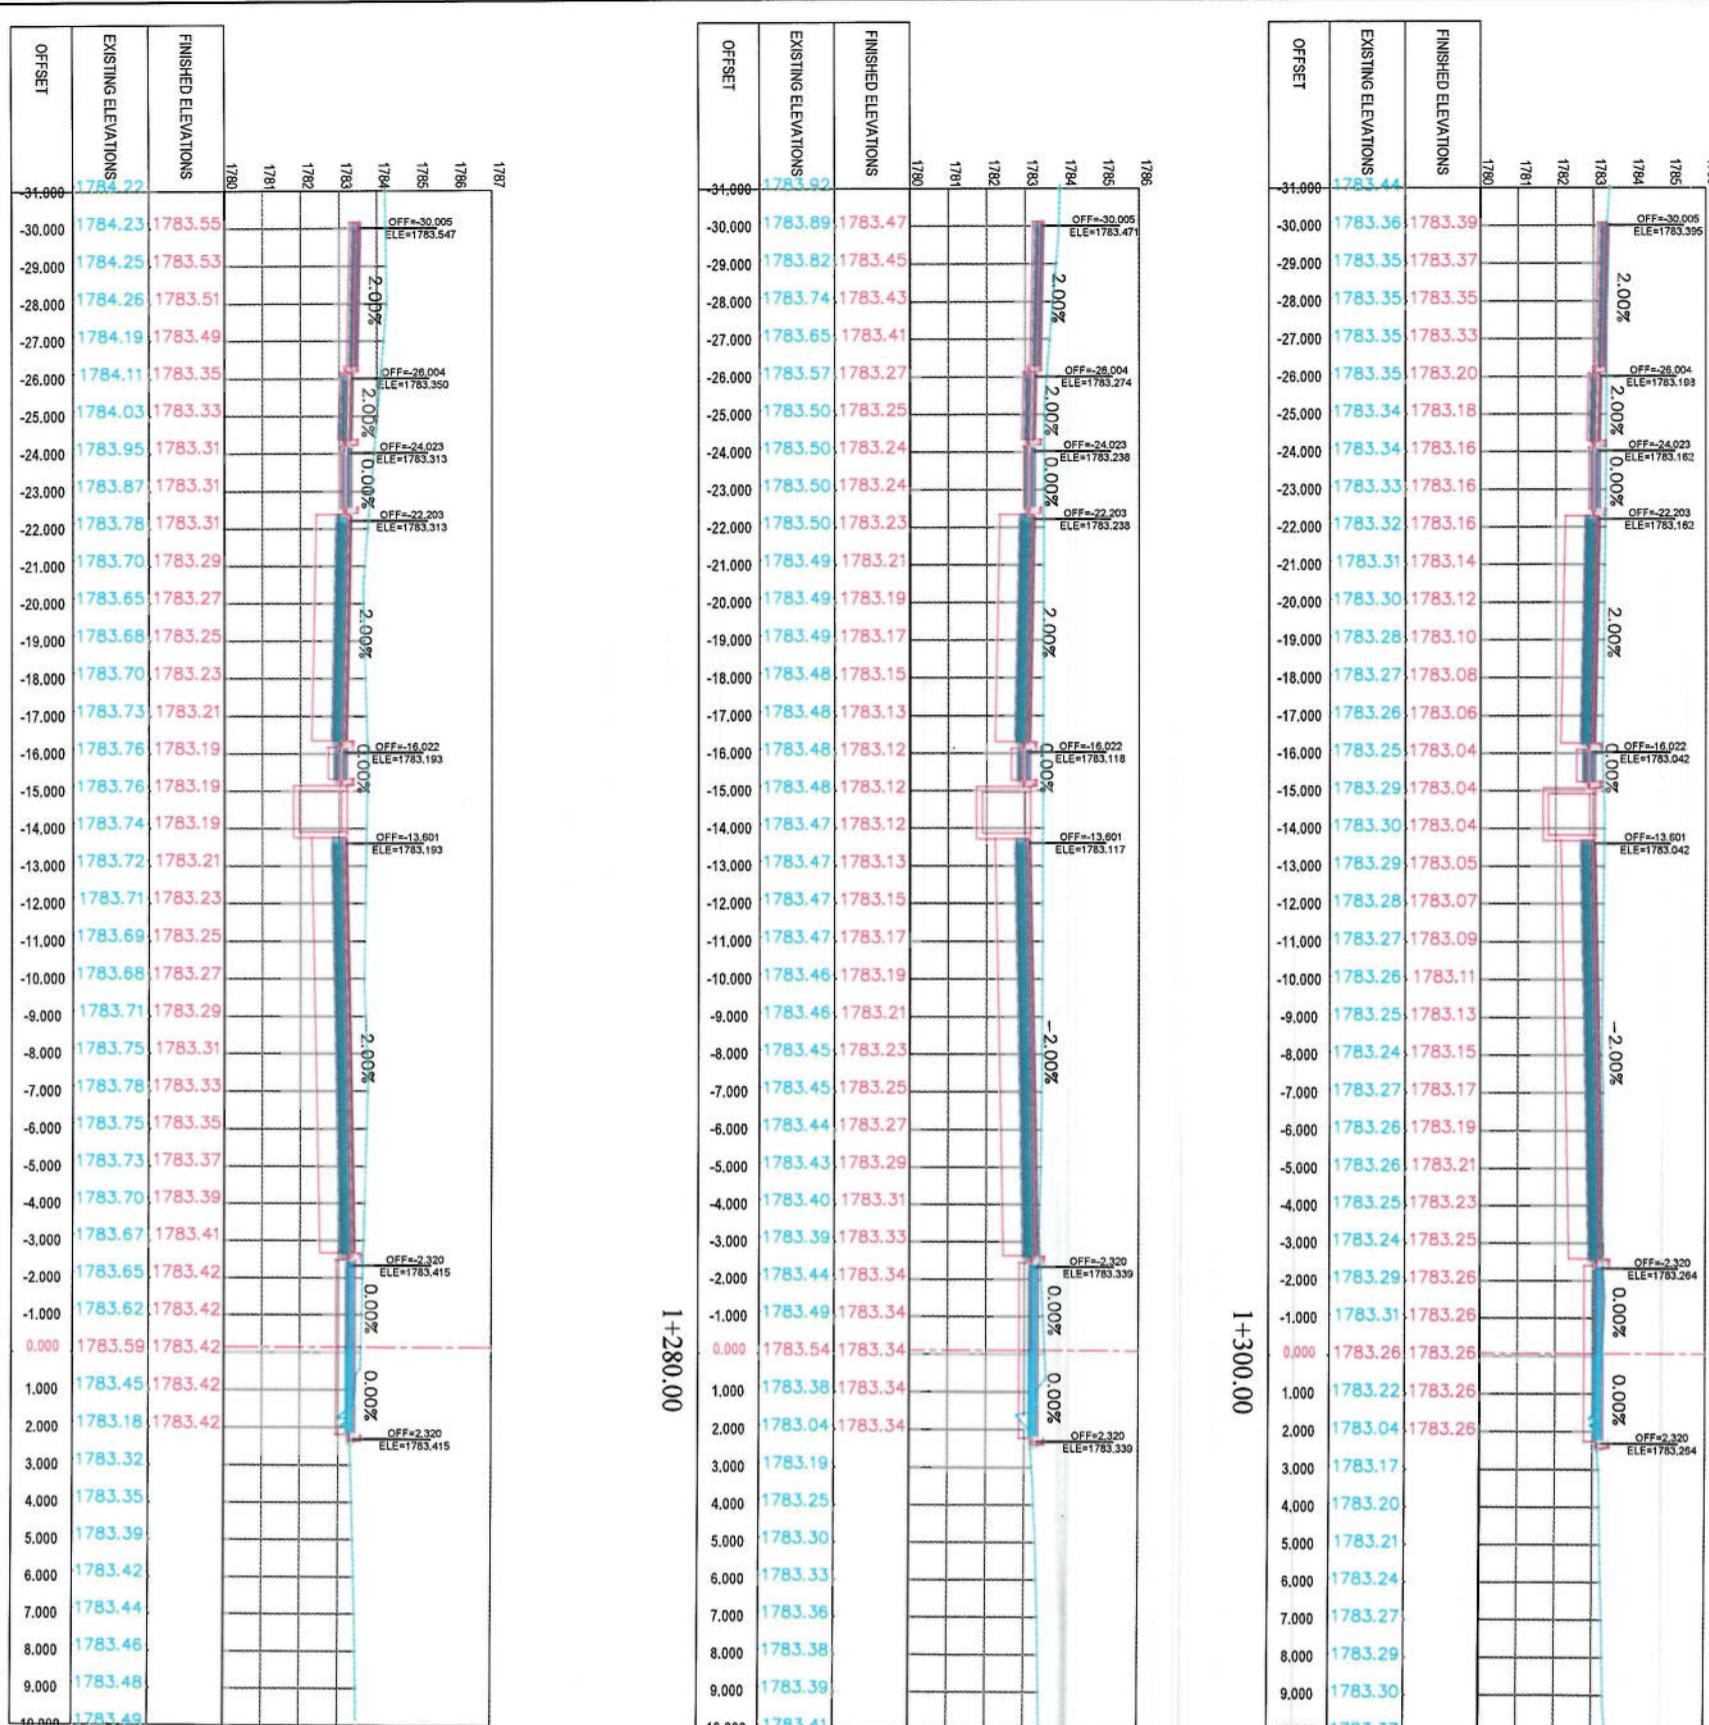


1+260.00

1+280.00

1+300.00



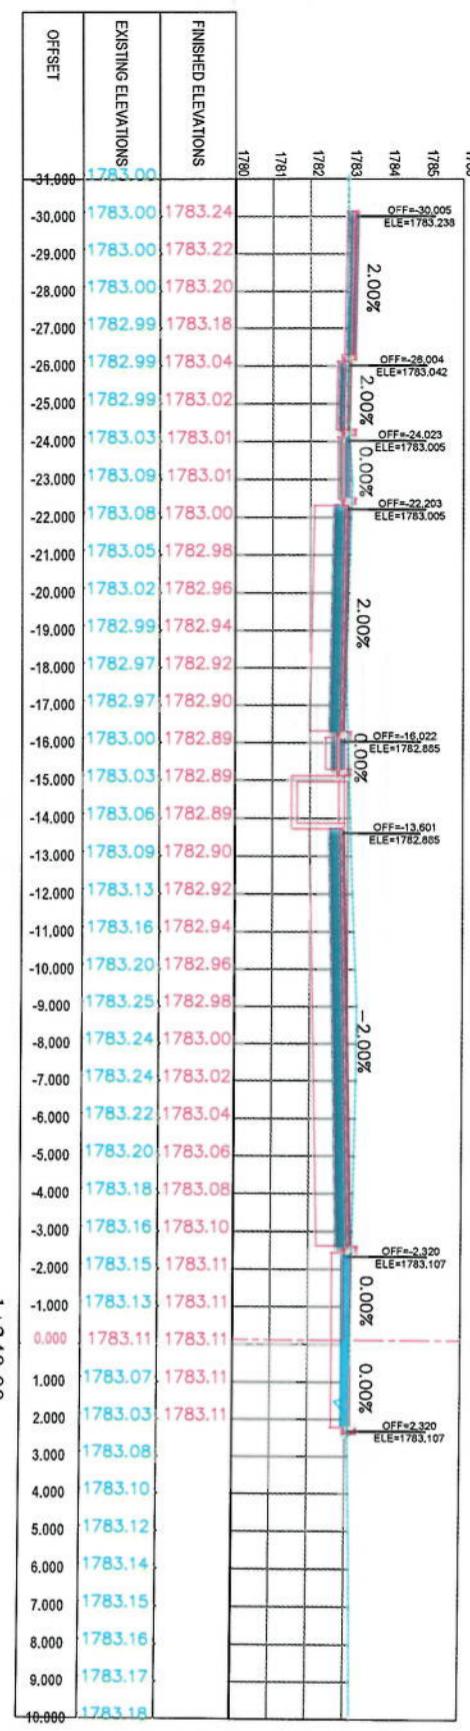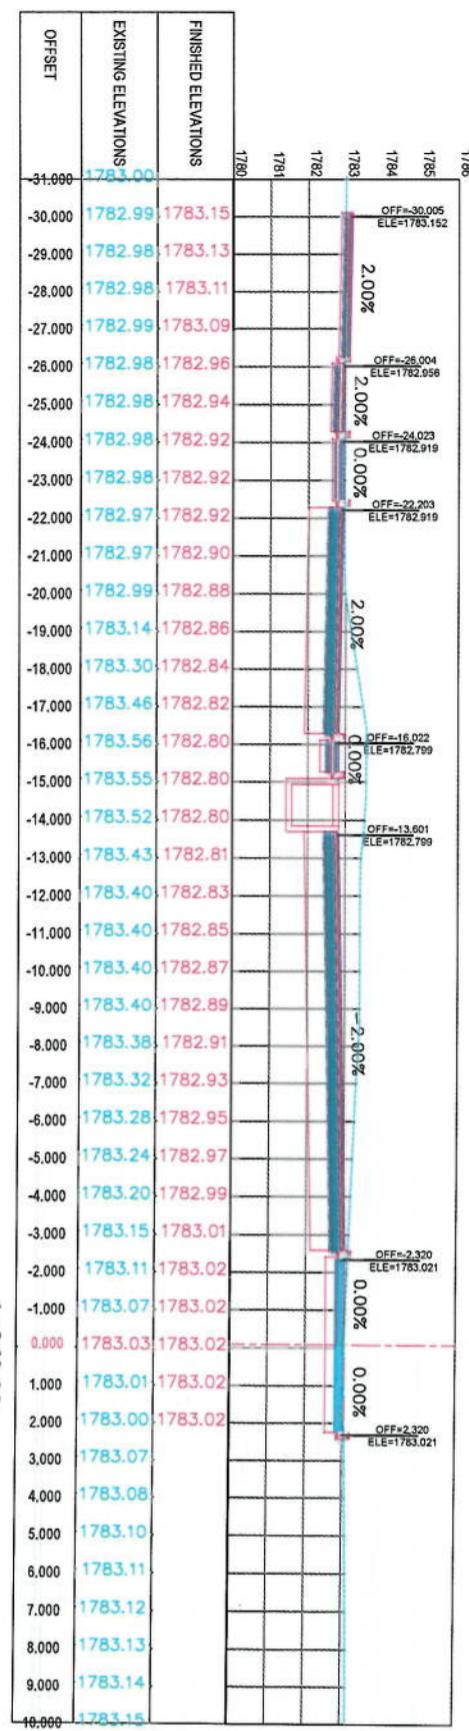

1+320.00

1+340.00

Project Name:	KABUL MUNICIPALITY	
Code-Sign To Remazang	Road project	
Checked by:	Hasanullah Shahzai	
Designed by:	Signature: Mohammad Easa Sait	
Drawn by:	Signature: Mohammad Easa Sait	
Drawn Date:	6/7/2023	
Status:	FINAL DESIGN	
Project Code:	CS-23	
Drawing Number:	00	
Revision:		

NOTE


1. All dimensions are in meters unless otherwise indicated.





**LEGENDS**

- CENTER-LINE**: Solid red line.
- EXISTING SURFACE**: Dashed blue line.
- EXISTING SIDE DITCH**: Blue line with a vertical segment.

1+380.00

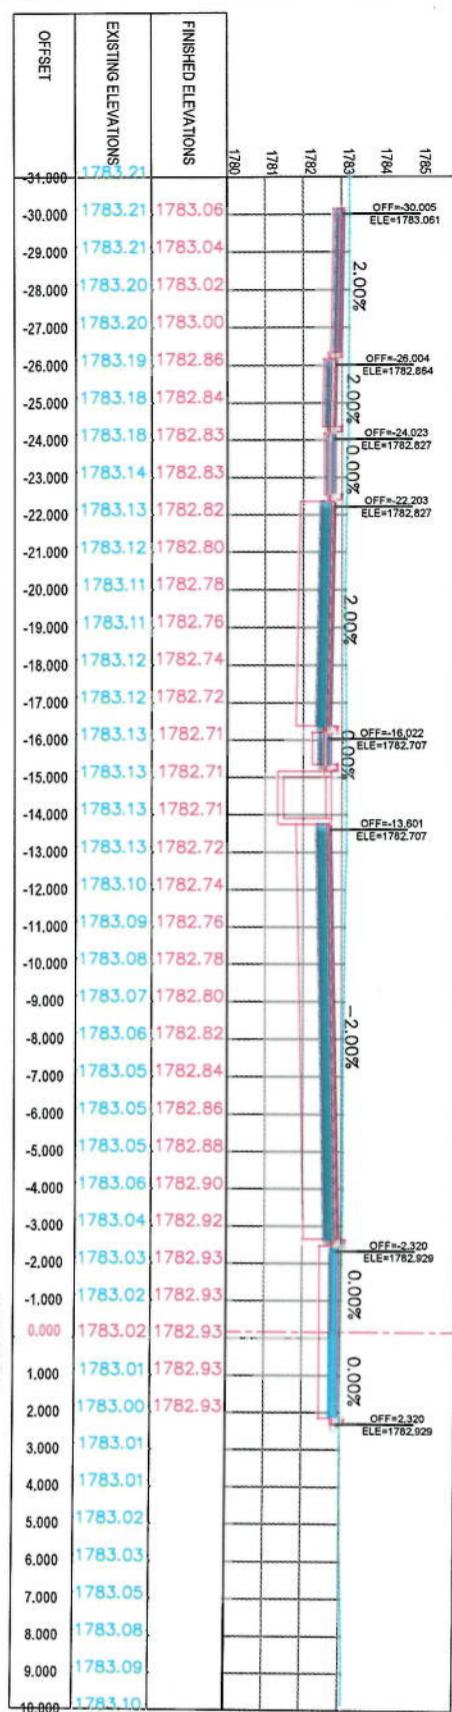

1+400.00

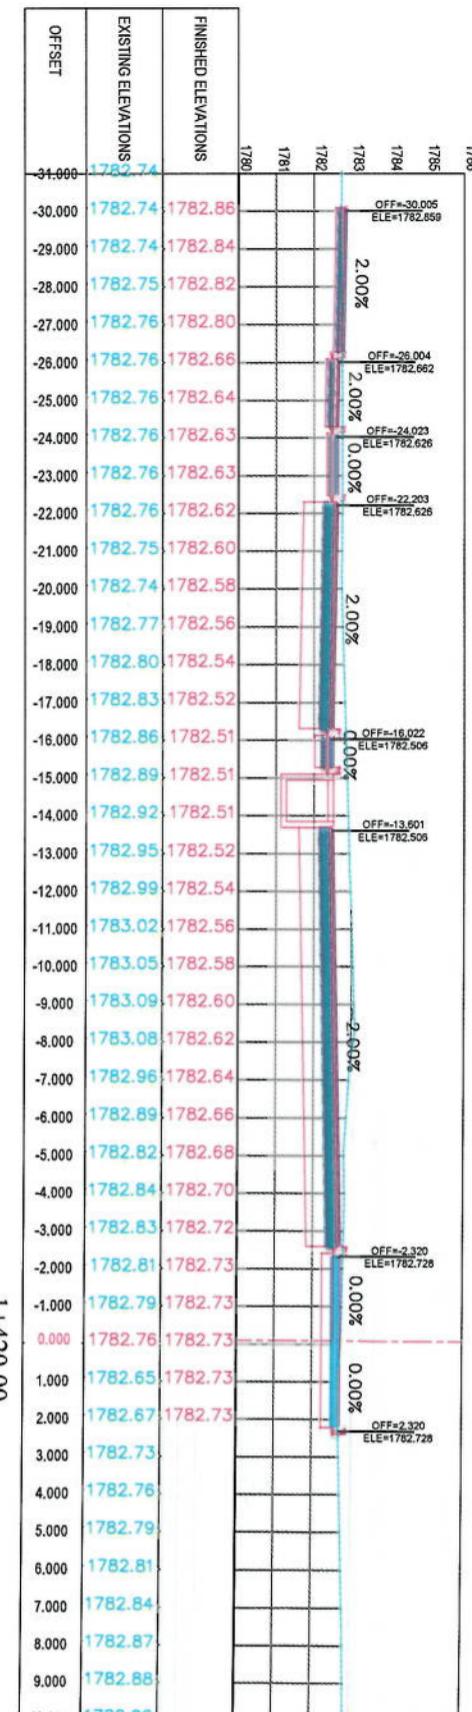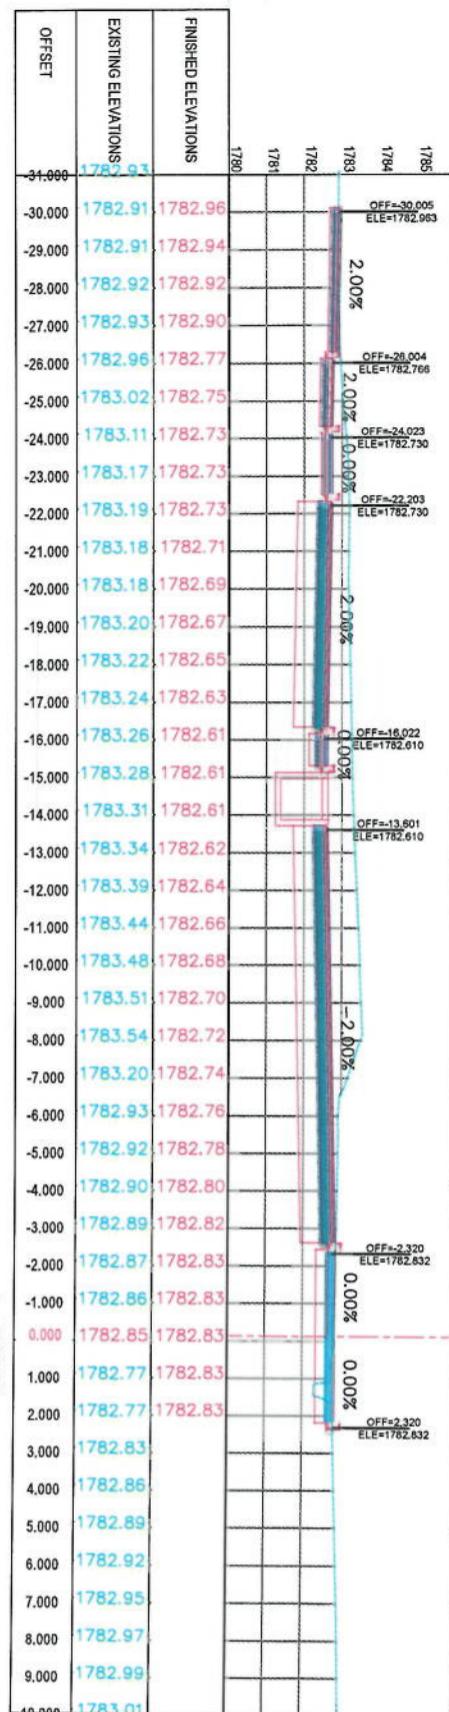

NOTE:


1. All dimensions are in meters unless otherwise indicated.

LEGENDS

- CENTER-LINE
- EXISTING SURFACE
- EXISTING SIDE DITCH



Project Code:	CS-24
Drawing Number:	00

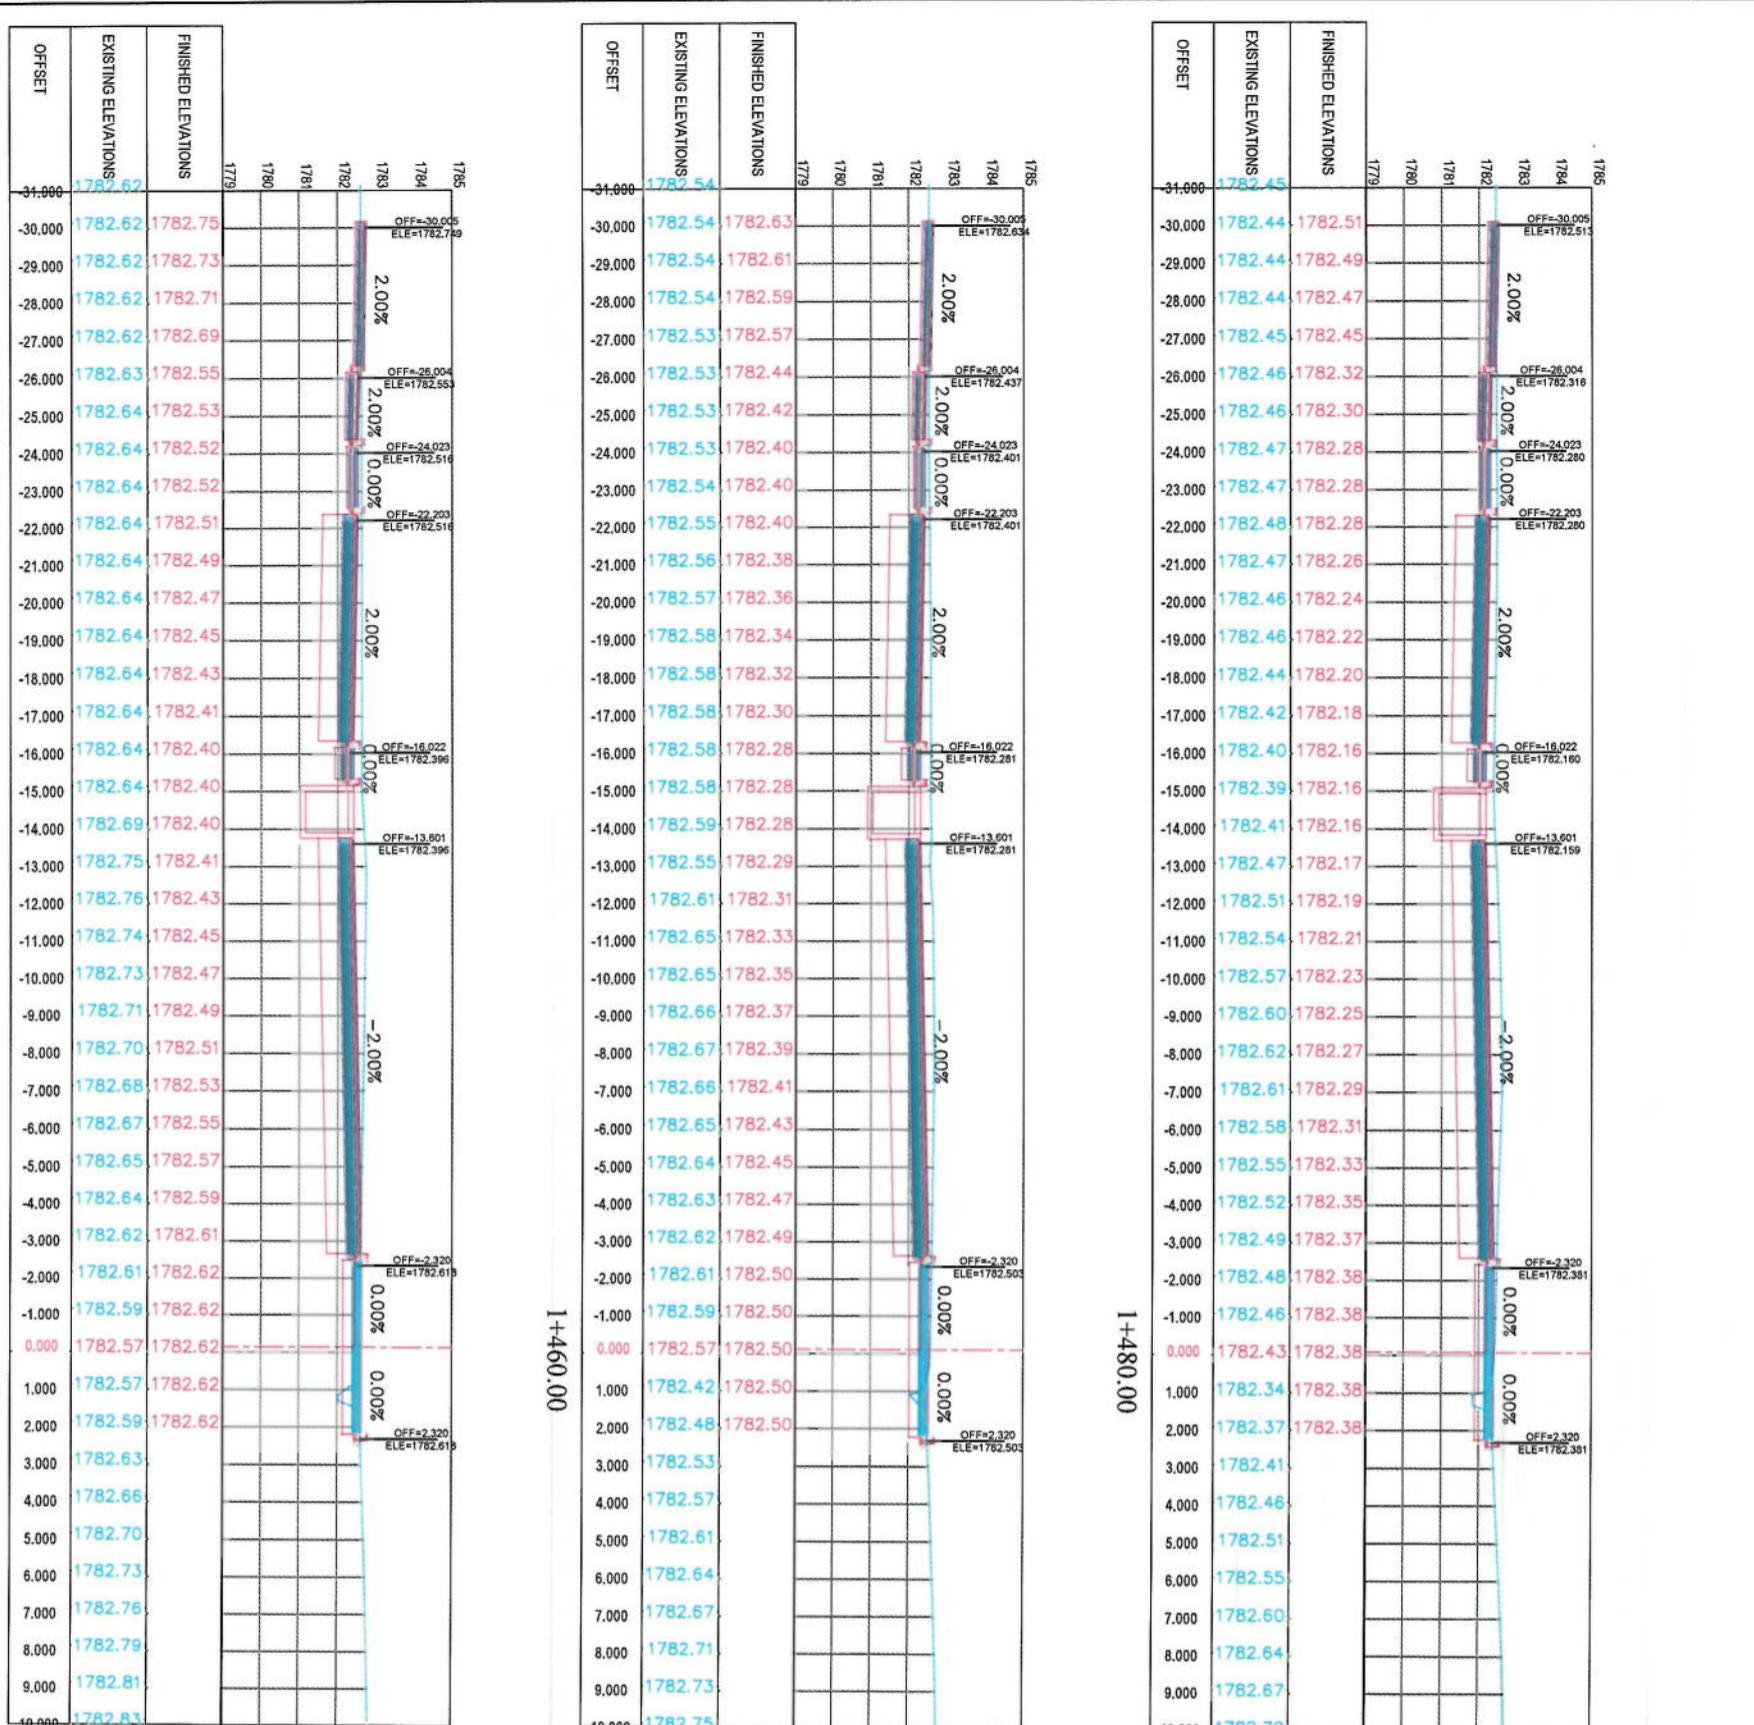

1+440.00

1+460.00




1+480.00

		ISLAMIC EMIRATE OF AFGHANISTAN	
		Client	
			KABUL MUNICIPALITY
		Designed by:	
		KABUL MUNICIPALITY DESIGN TEAM	
Project Name:		Cot-e-Sangi To Demazang Road Project	
Drawing Title:			
CROSS SECTIONS			
Designed by:	Mohammad Faiz Sint	Signature	
Drawn by:	Mohammad Easa Sint	Signature	
Checked by:	Hassanullah Shatiz	Signature	
Date:	6/7/2023	Scale:	1:200
Status:	FINAL DESIGN		
Project Code:			
Drawing Number:	CS-25	Revision:	00
Date:	Revision Details		
	Drawn		



NOTE

1+500.00

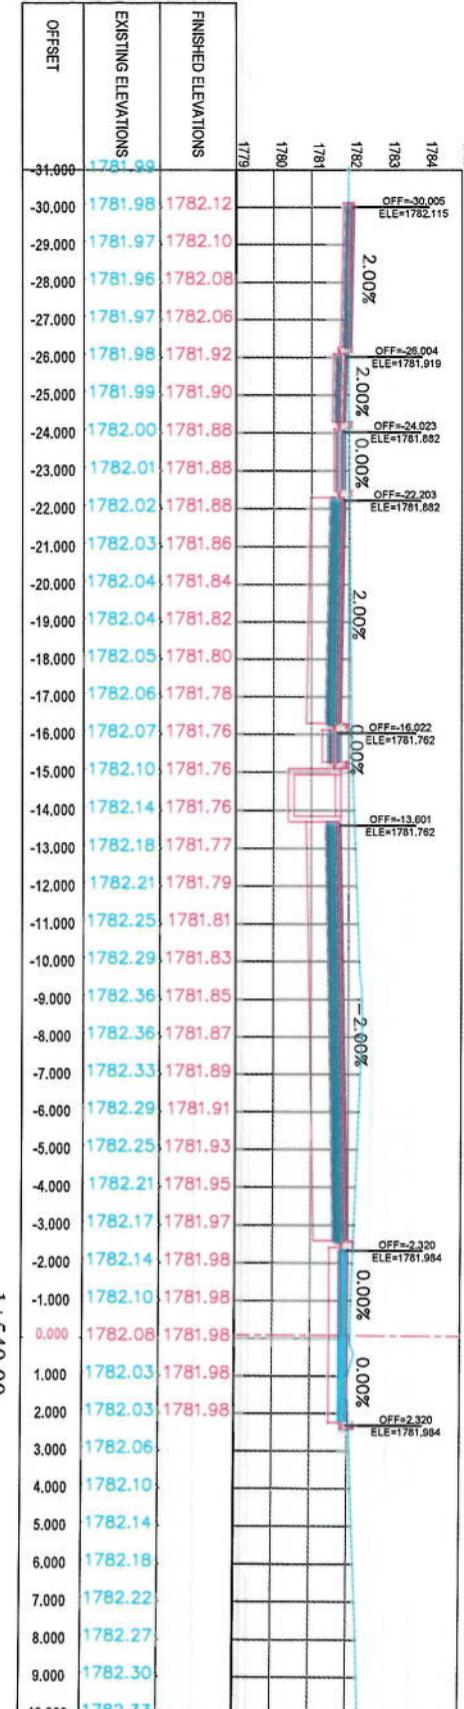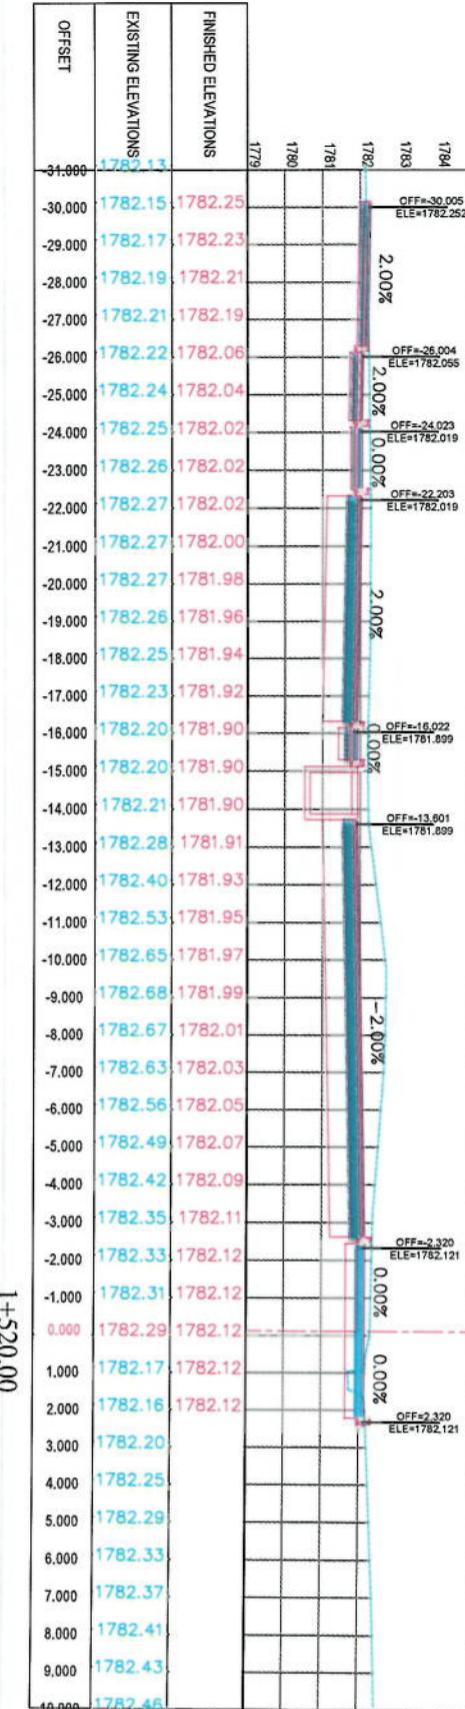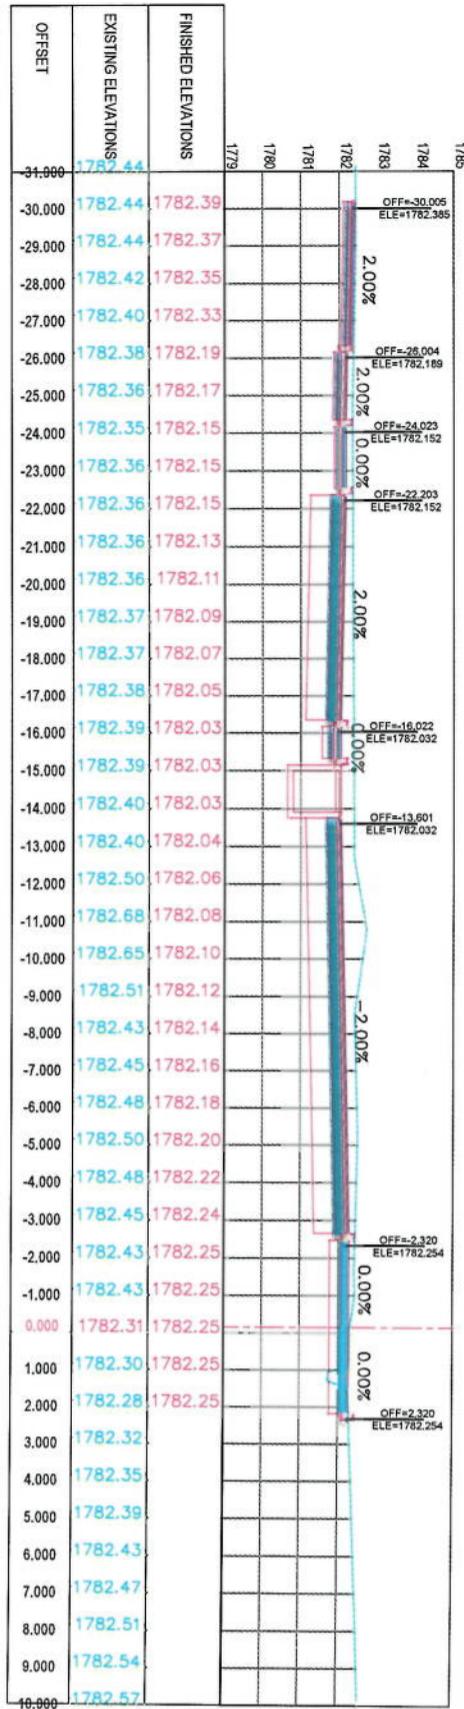

NOTE:


1. All dimensions are in metres unless otherwise indicated.

LEGENDS

- CENTER-LINE
- EXISTING SURFACE
- EXISTING SIDE DITCH




Drawing Number: CS-26  
Revision: 00  
Project Code: 1+500.00  
Status: FINAL DESIGN  
Drawing Title: CROSS SECTIONS  
Client: KABUL MUNICIPALITY  
ISLAMIC EMIRATE OF AFGHANISTAN  
Designed by: KABUL MUNICIPALITY DESIGN TEAM  
Drawing No: CS-26  
Date: 6/7/2023  
Scale: 1:200  
Checked by: Hananullah Shamsi  
Driver by: Mohammad Eisa Sint  
Designed by: Mohammad Eisa Sint  
Signature: [Signature]

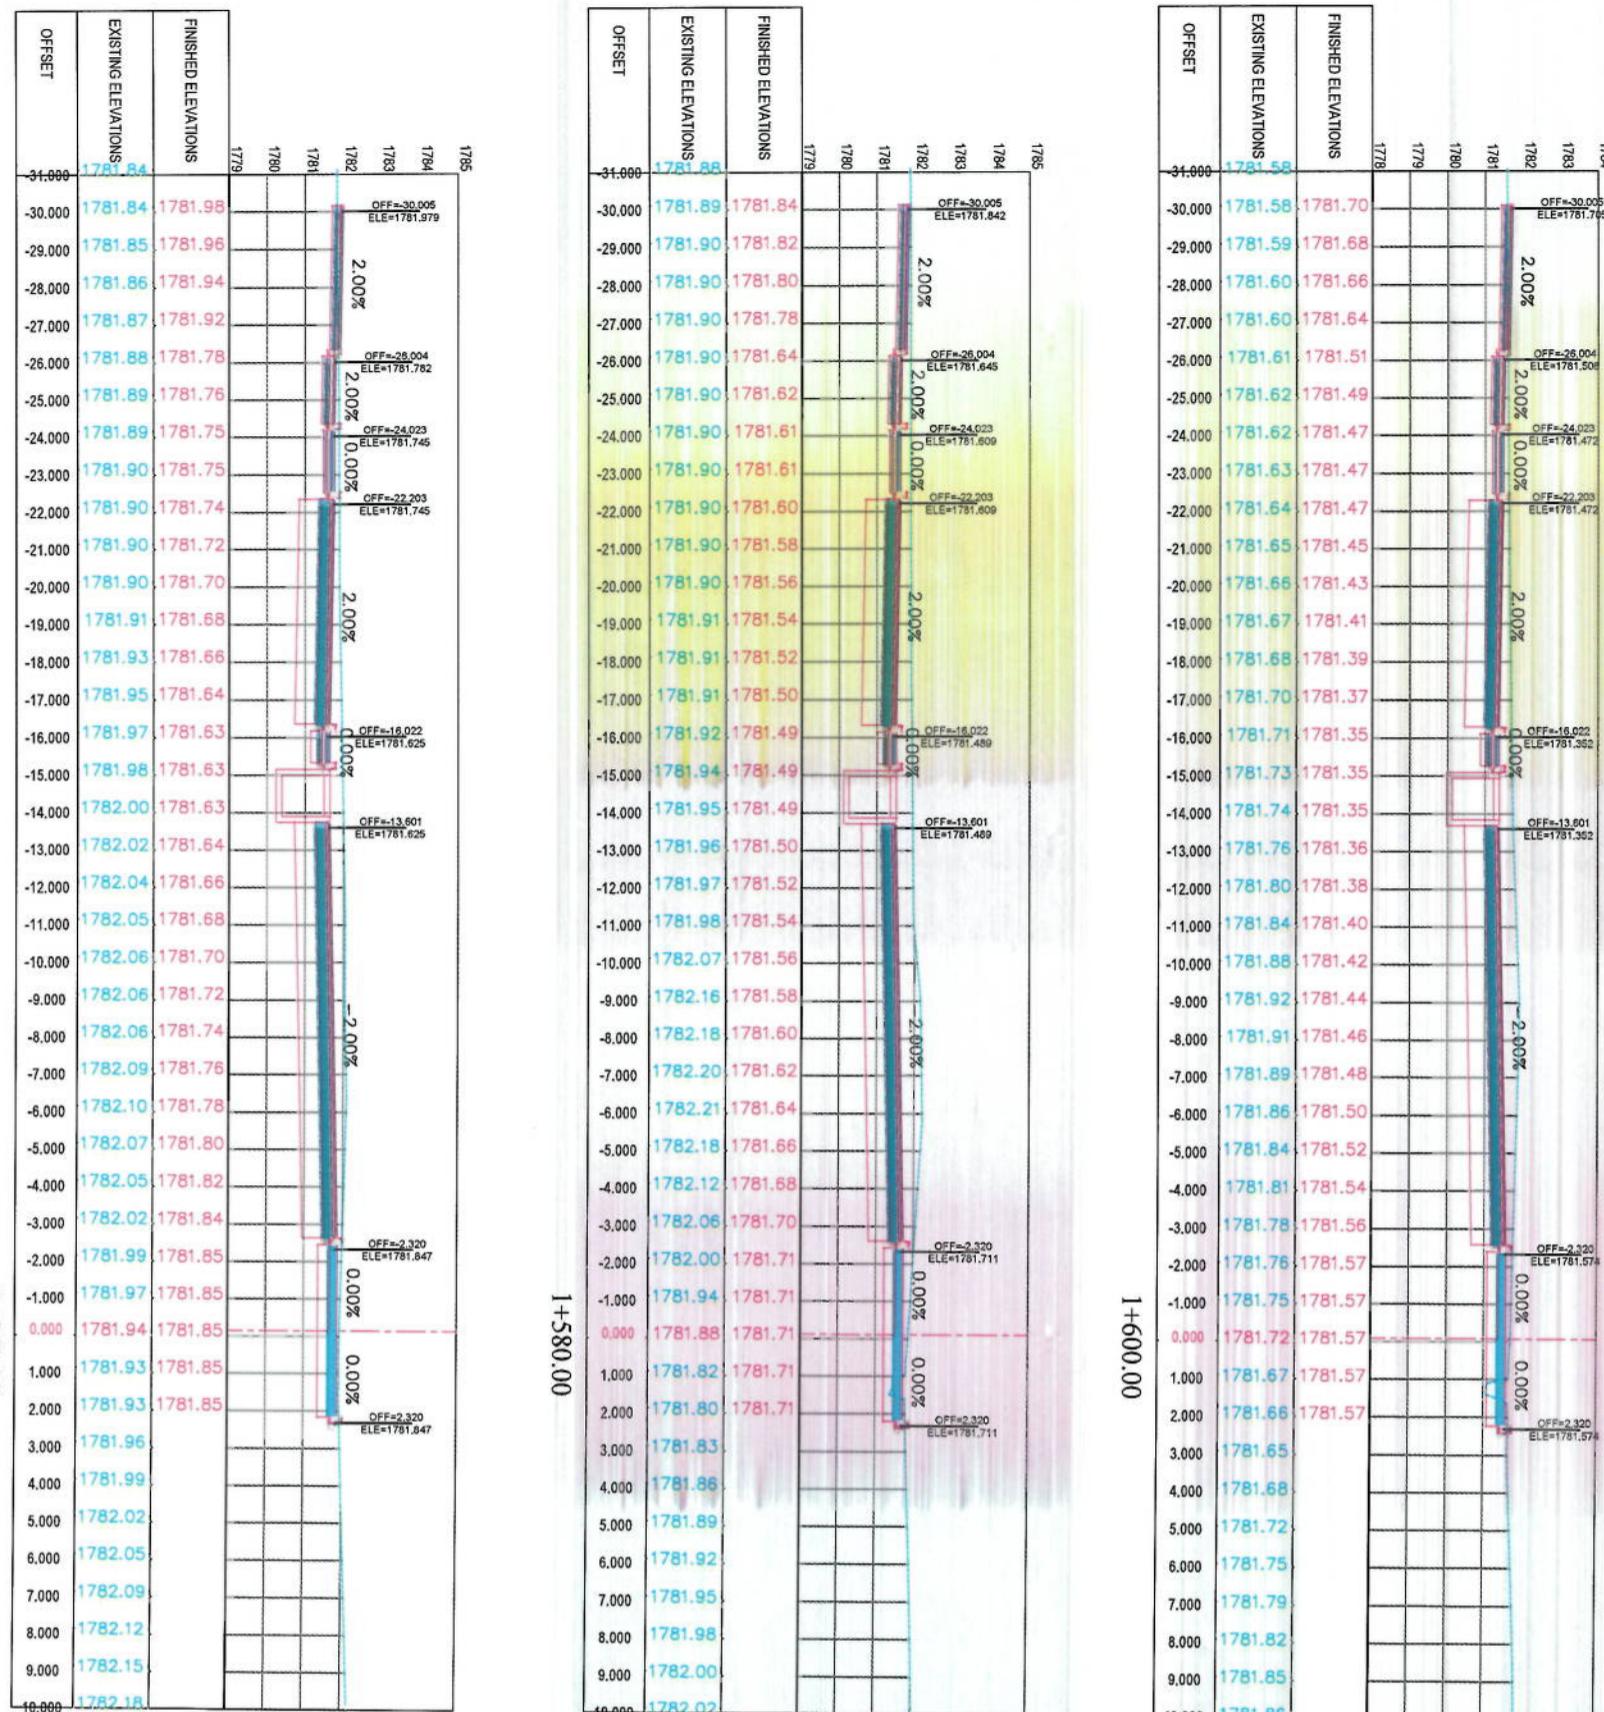


NOTE:

1. All dimensions are in meters unless otherwise indicated.


LEGENDS	
CENTER-LINE	—
EXISTING SURFACE	---
EXISTING SIDE DITCH	—

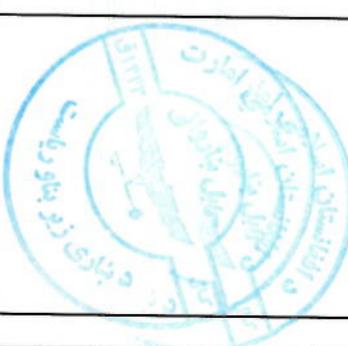

Project Name:	KABUL MUNICIPALITY DESIGN TEAM
Drawing Title:	CROSS SECTIONS
Code-Stage To Demazang	Road project
Designed By:	Mohammad Esa Sial
Drawn By:	Mohammad Esa Sial
Checked By:	Hassanullah Shahzad
Date:	6/7/2023
Scale:	1:200
Status:	FINAL DESIGN
Project Code:	
Drawing Number:	CS-27
Revision:	00

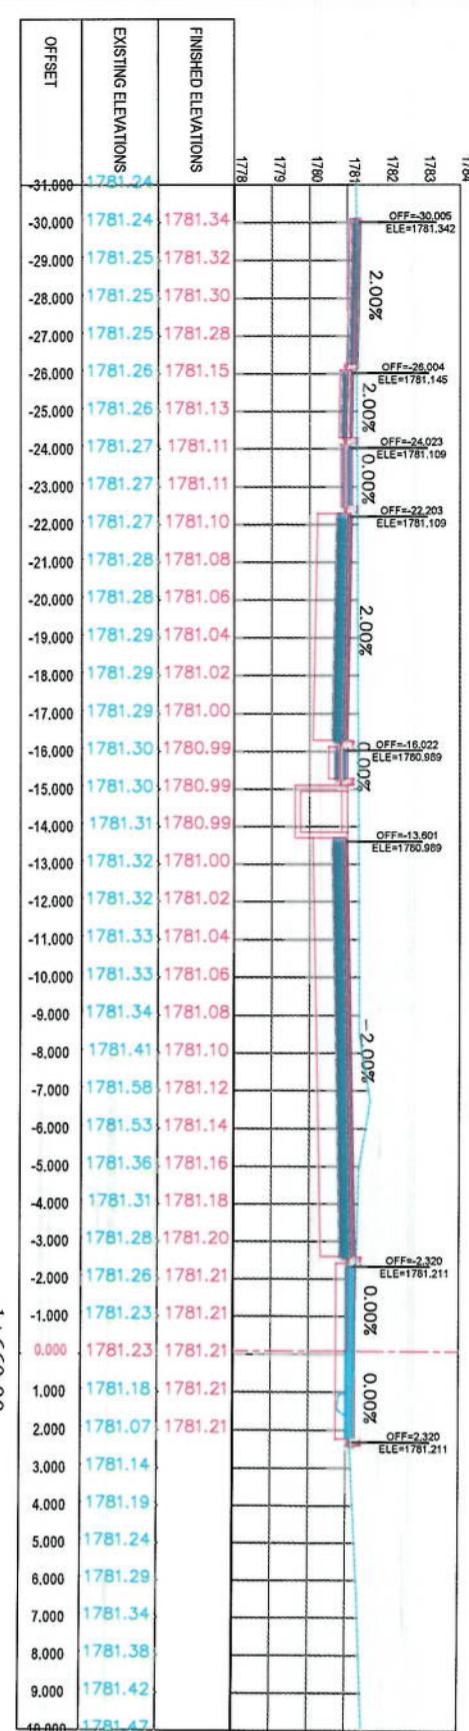

1+660.00

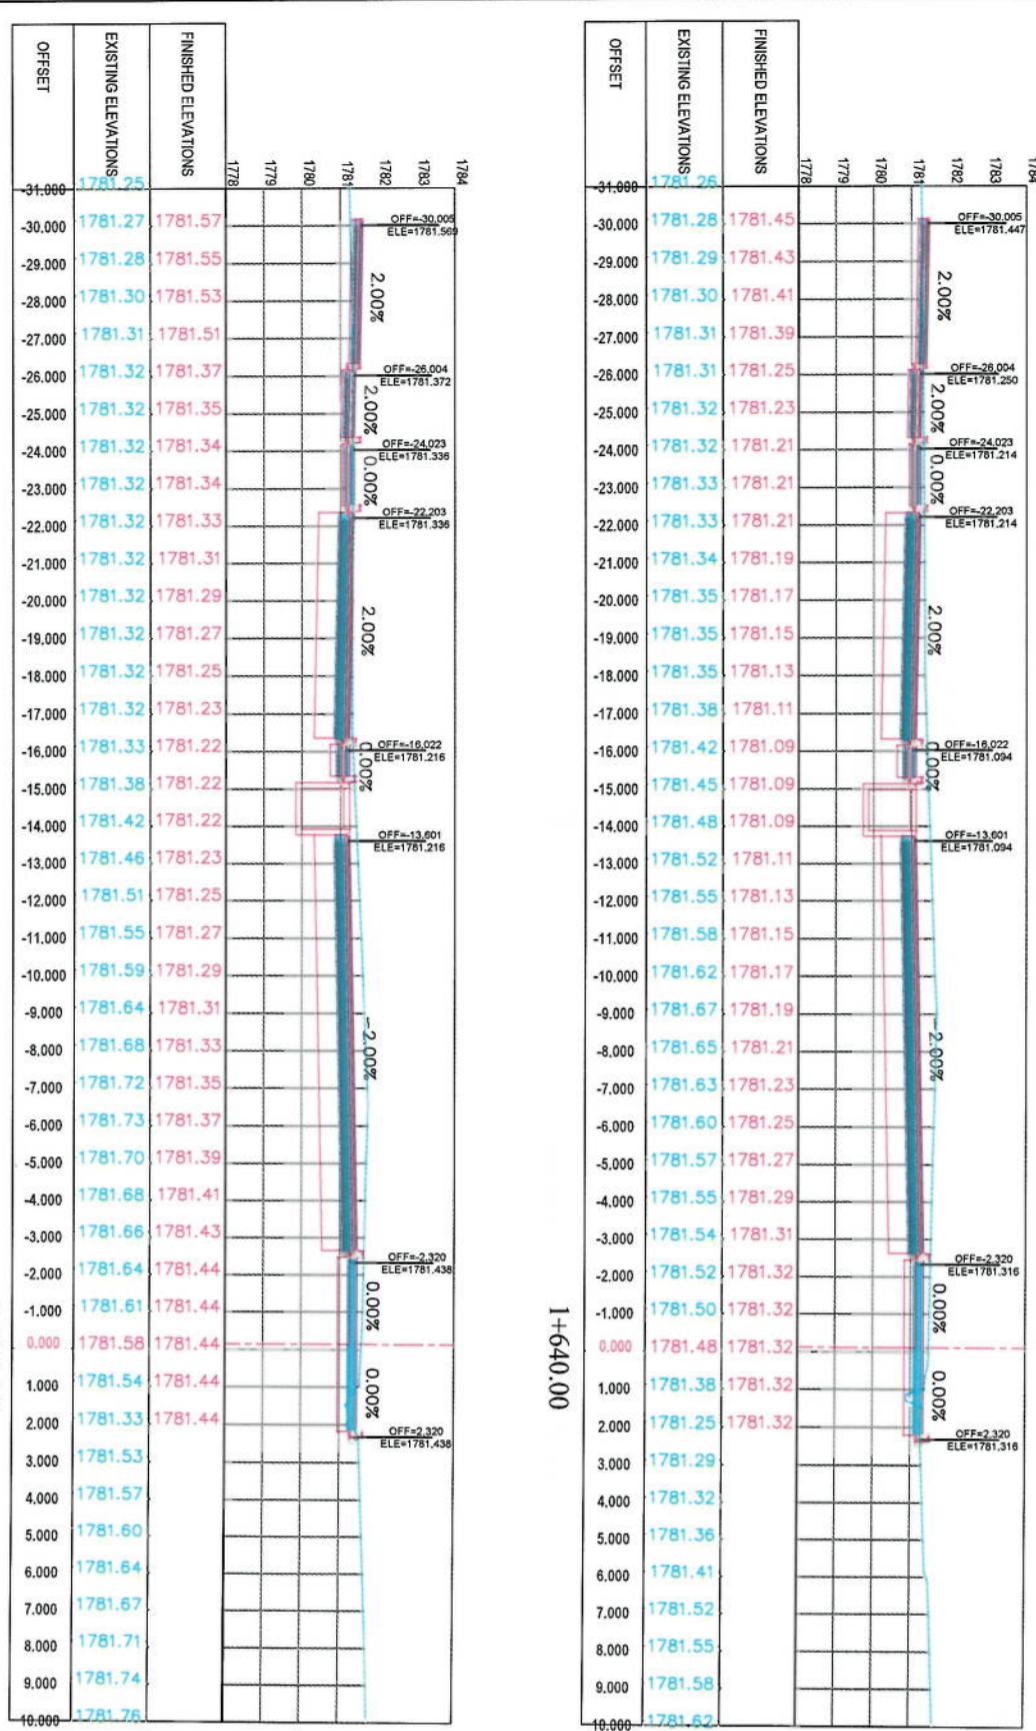

1+640.00




NOTE:

1. All dimensions are in meters unless otherwise indicated.

LEGENDS	
	CENTER-LINE
	EXISTING SURFACE
	EXISTING SIDE DITCH



Project Name: Code-Sang To Demazang Road Project	Designed by: KABUL MUNICIPALITY DESIGN TEAM
Drawing Title: CROSS SECTIONS	
Designed by: Mohammad Eesa Sial 	Signature:
Drawn by: Mohammad Eesa Sial 	Signature:
Checked by: Hasanullah Shamsi 	Signature:
Date: 6/7/2023	Scale: 1:200
Status: FINAL DESIGN	
Drawing Number: CS-28	Revision: 00

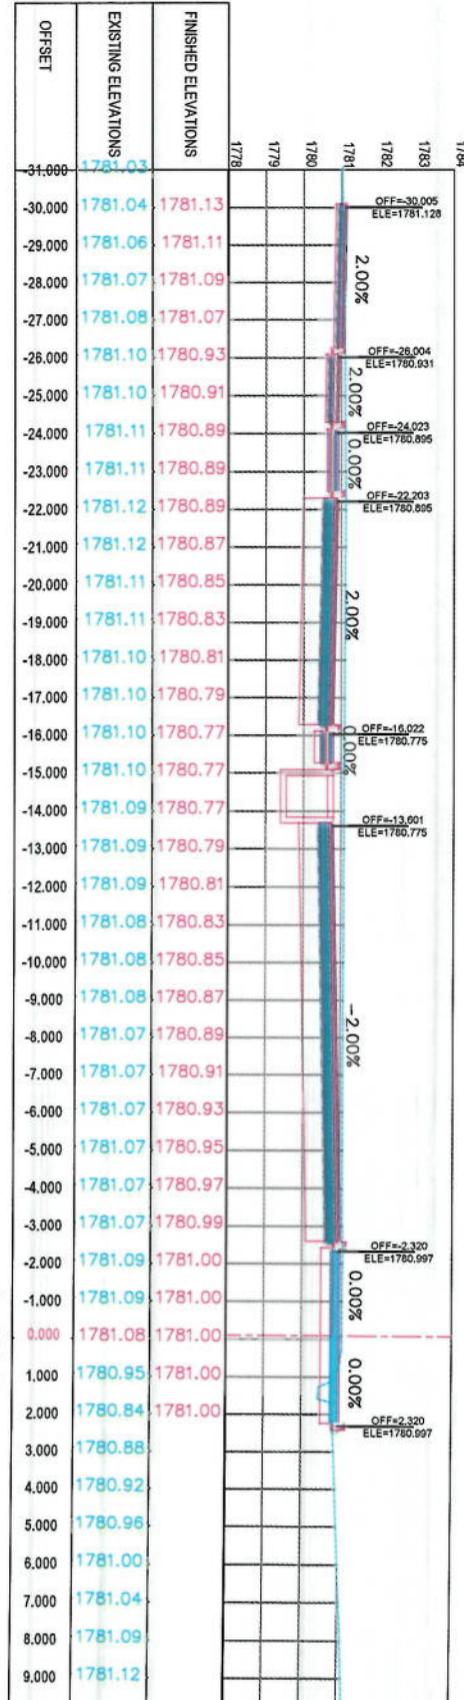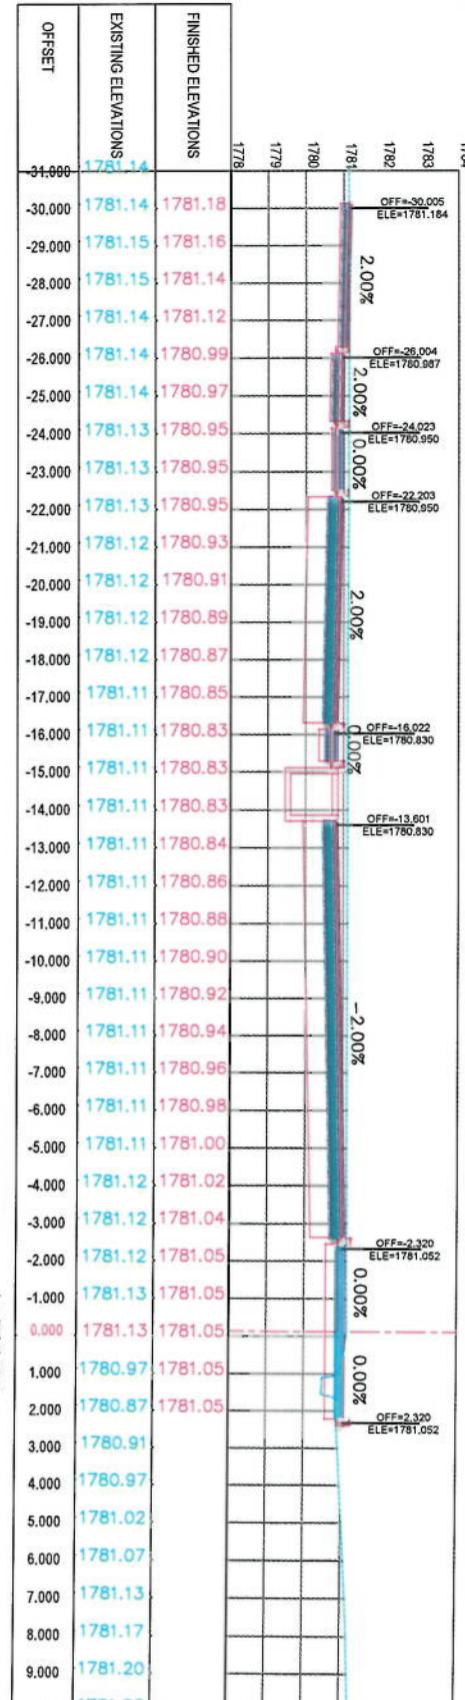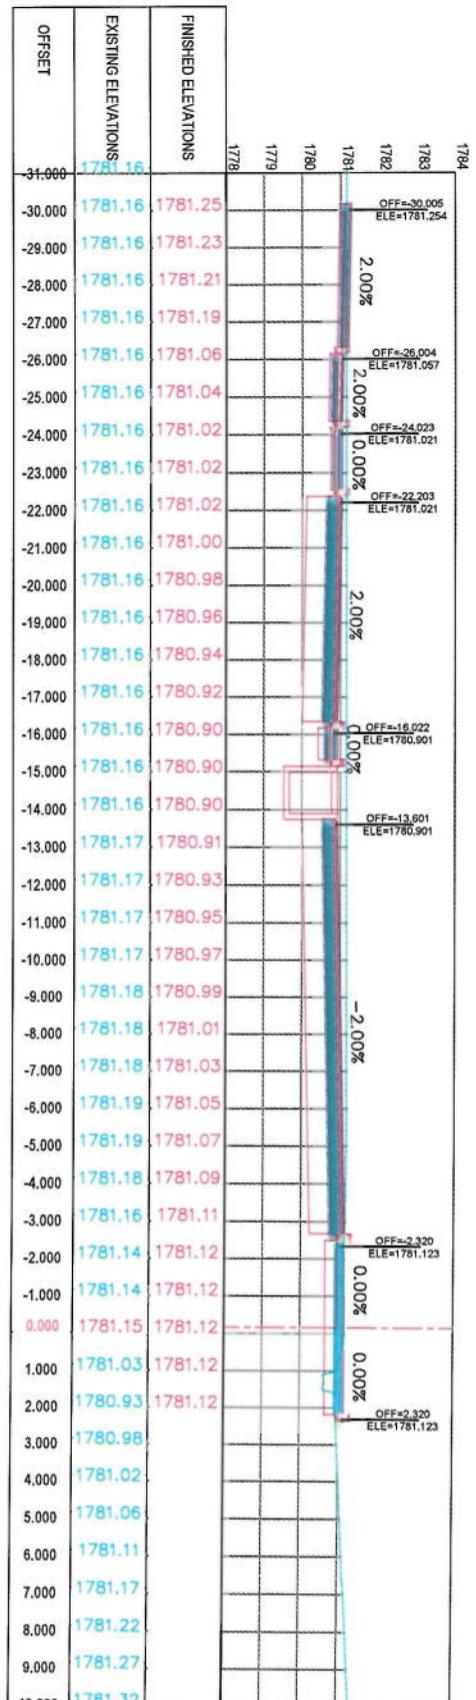


1+700.00

1+720.0C


1+680.00

KABUL MUNICIPALITY  
DESIGN TEAM


NOTE

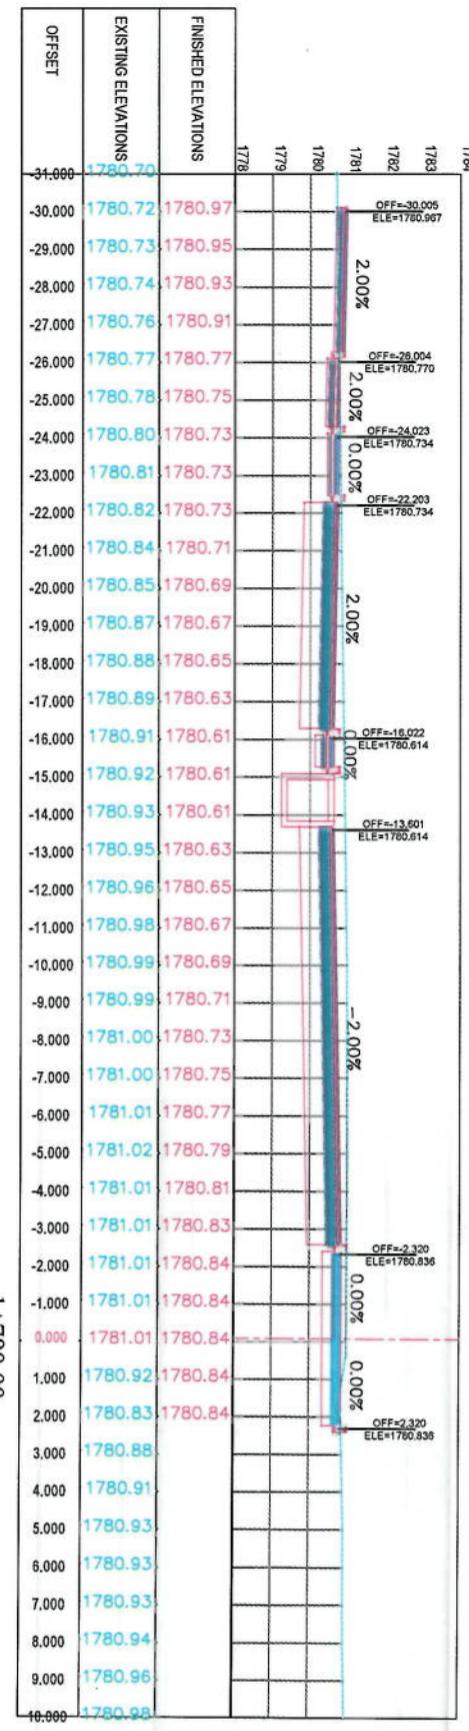

1+780.00

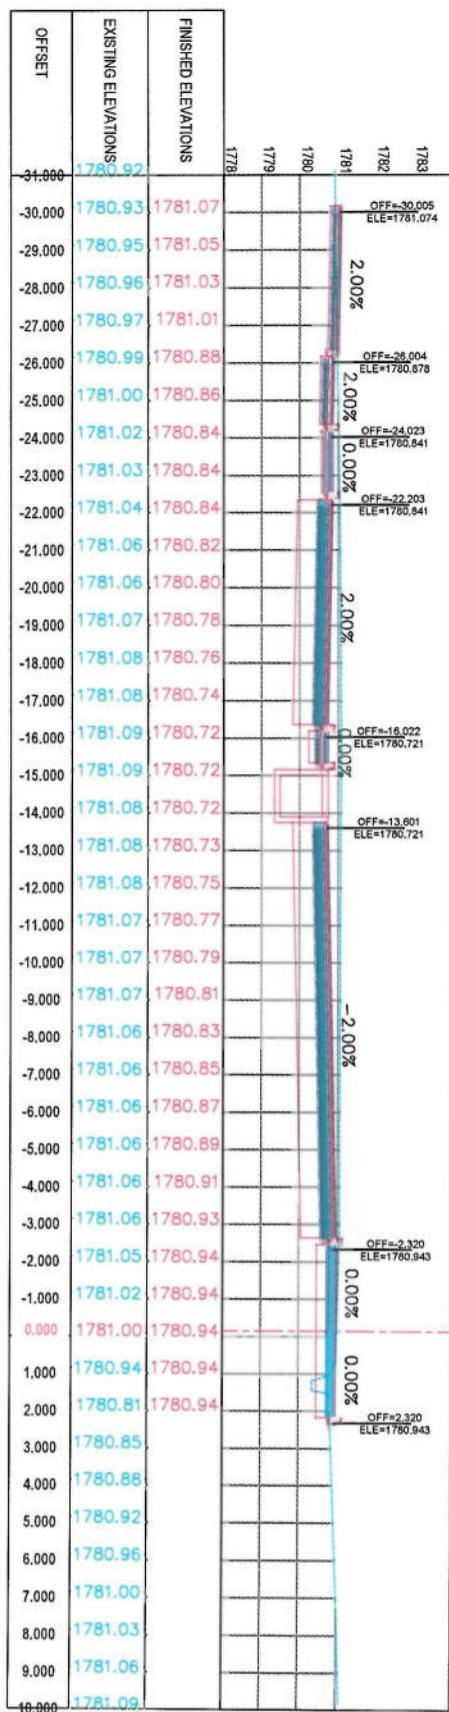

1+760.00

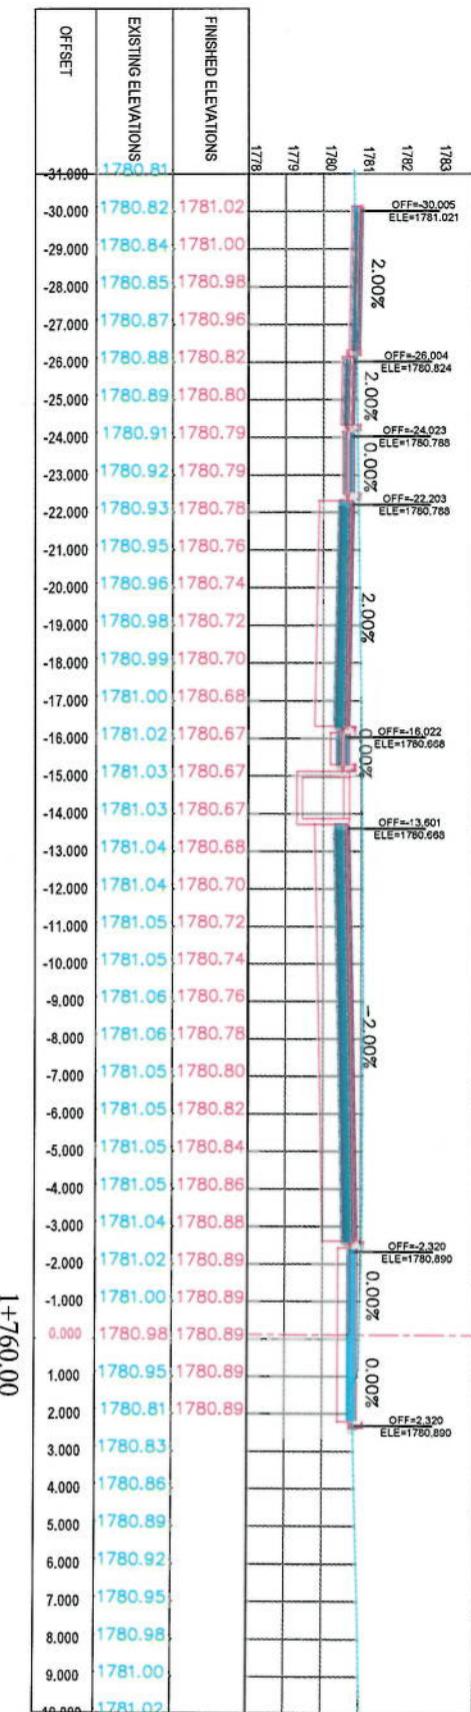

**CROSS SECTIONS**

Designed by:	KABUL MUNICIPALITY DESIGN TEAM
Project Name:	Kabul-Sangi To Demazang
Drawing Title:	Road project
Drawn by:	Mohammad Esa Sial
Checked by:	Hassanullah Shahzai
Date:	6/7/2023
Scale:	1:200
Sheet No.:	FINAL DESIGN
Project Code:	CS-30
Drawing Number:	00
Revision:	



NOTE:  
1. All dimensions are in meters unless otherwise indicated.

LEGENDS

CENTER-LINE

EXISTING SURFACE


EXISTING SIDE DITCH

## NOTE


1. All dimensions in meters unless otherwise indicated.

## LEGENDS


- CENTER-LINE
- EXISTING SURFACE
- EXISTING SIDE DITCH

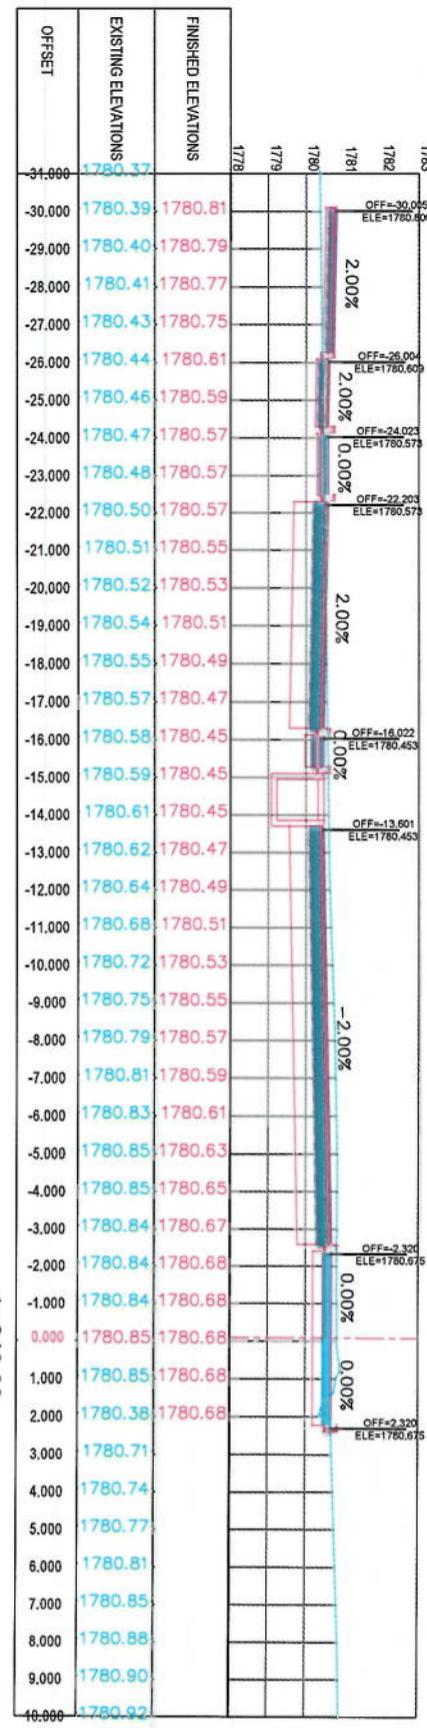

1+840.00

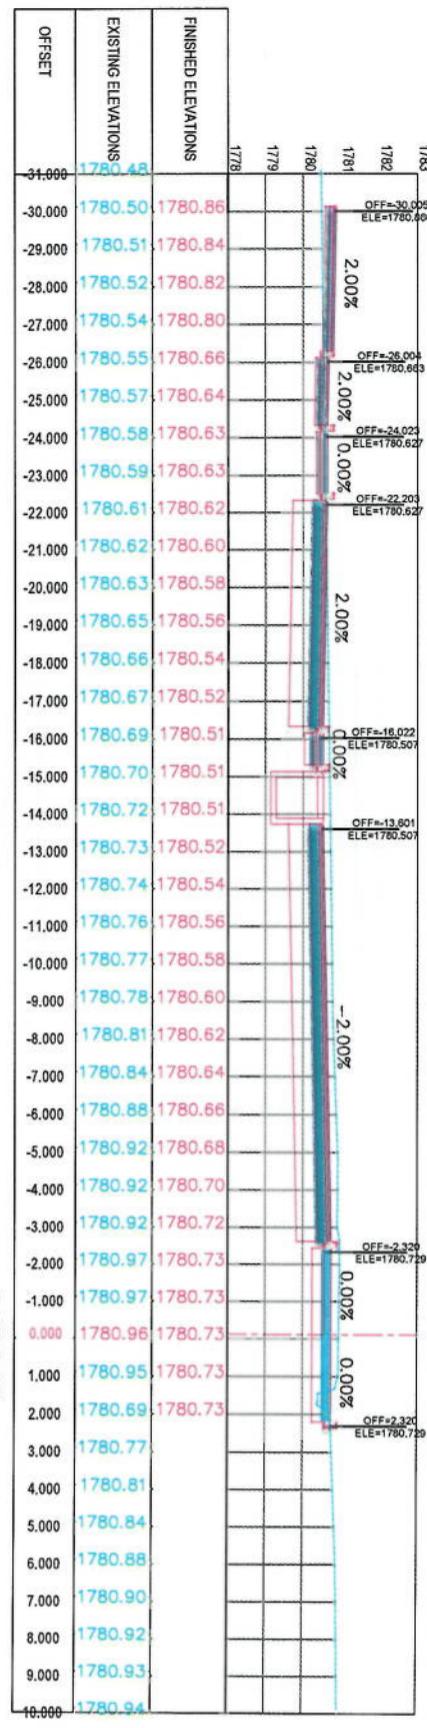


1+820.00


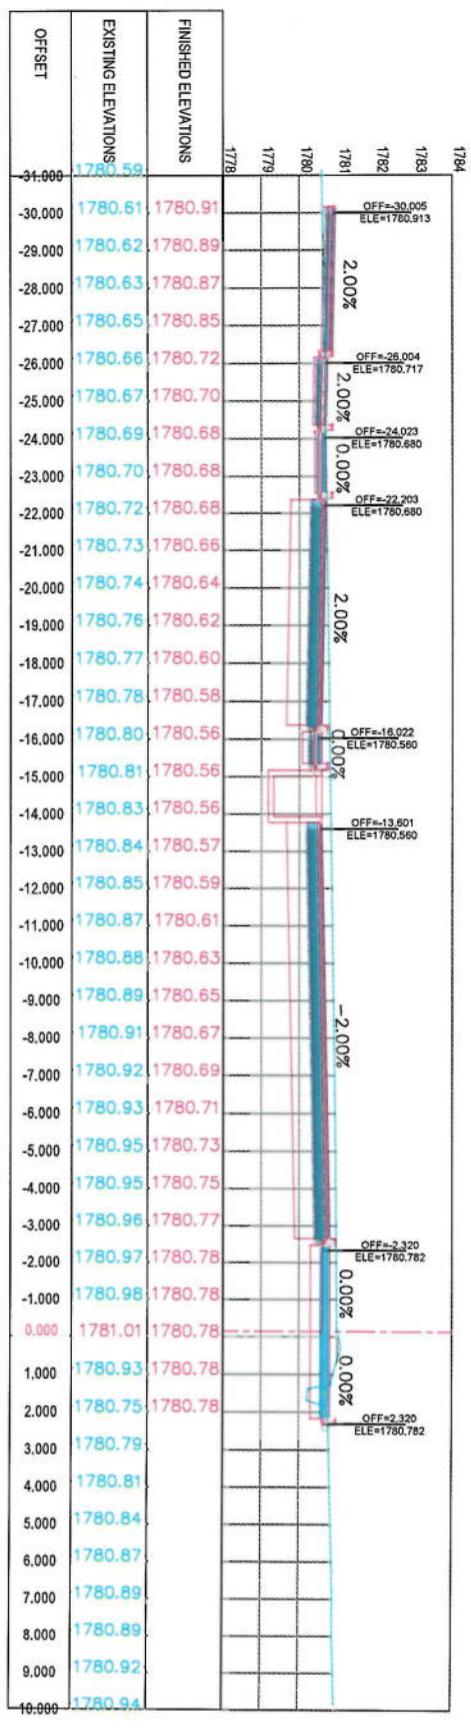


1+800.00

Project Name:	KABUL MUNICIPALITY DESIGN TEAM	
Designed by:	Colle-Sauve To Demazang Road project	
Drawing Title:	CROSS SECTIONS	
Designed by:	Signature:	Signature:
Drew by:	Signature:	Signature:
Checked by:	Signature:	Signature:
Date:	6/7/2023	Scale: 1:200
Status:	FINAL DESIGN	
Project Code:	CS-31	Revision: 00

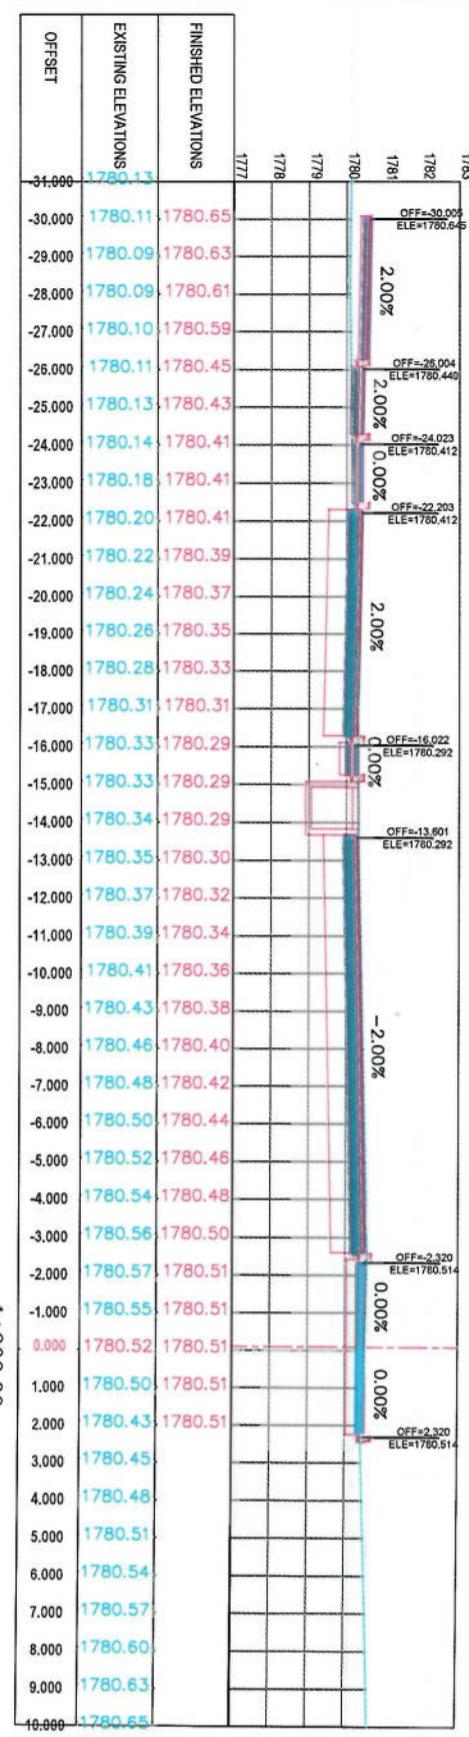

1+900.00

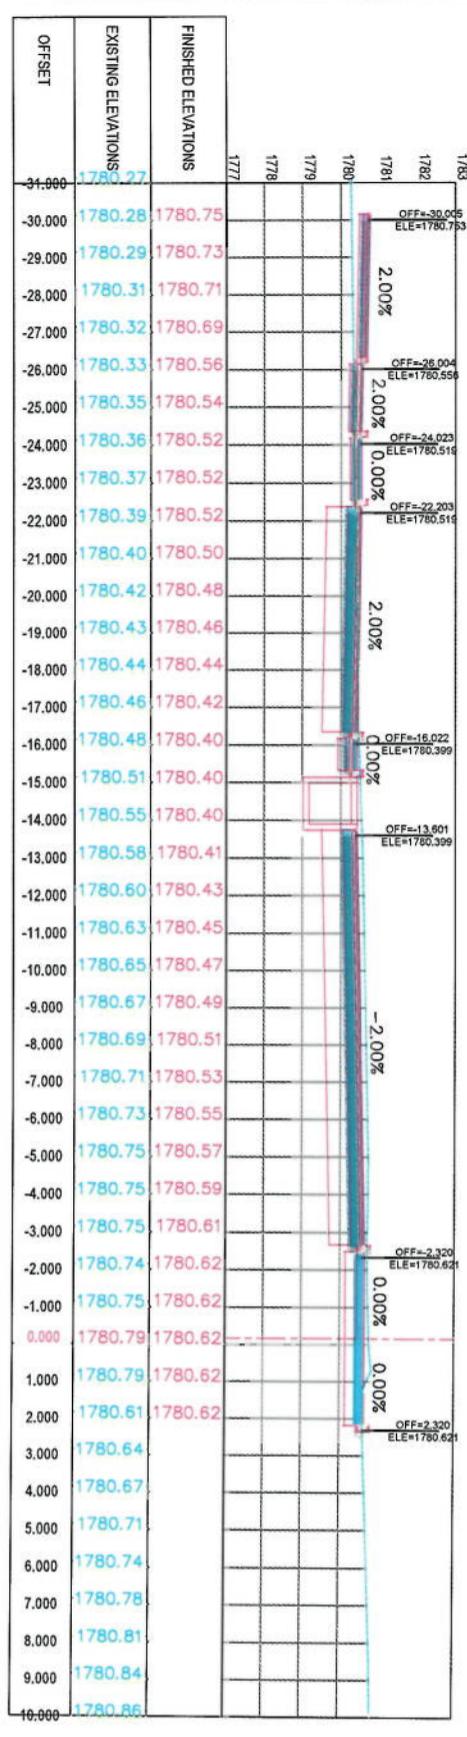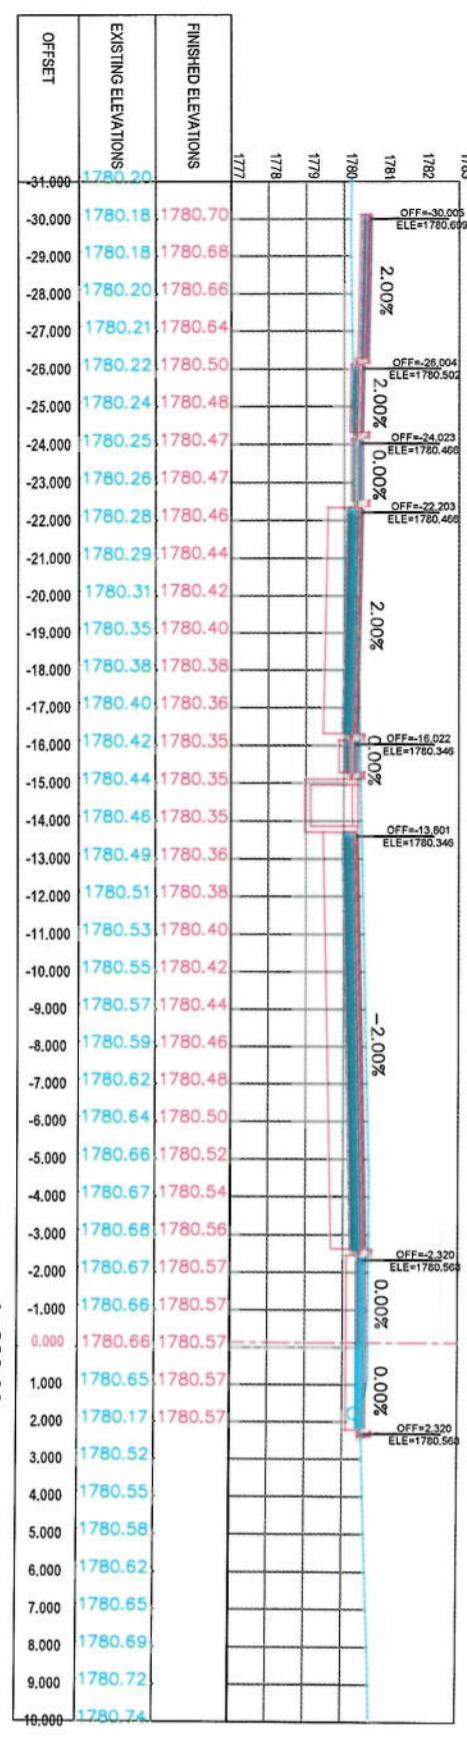

LEGENDS	
CENTER-LINE	—
EXISTING SURFACE	---
EXISTING SIDE DITCH	—

NOTE:  
1. All dimensions are in meters unless otherwise indicated

ISLAMIC EMIRATE OF  
AFGHANISTAN

KABUL MUNICIPALITY

Designed by:  
KABUL MUNICIPALITY  
DESIGN TEAM

Project Name:  
Coke-Sangi To Demazang  
Road Object

Drawing Title:  
CROSS SECTIONS


Designed by:  
Mohammad Eissa Sirel  
Drawn by:  
Signature: Mohammad Eissa Sirel  
Checked by:  
Signature: Hasmullah Shabir

Date: 6/7/2023 State: 1:200


Status: FINAL DESIGN

Project Code:


Drawing Number CS-32 Revision 00

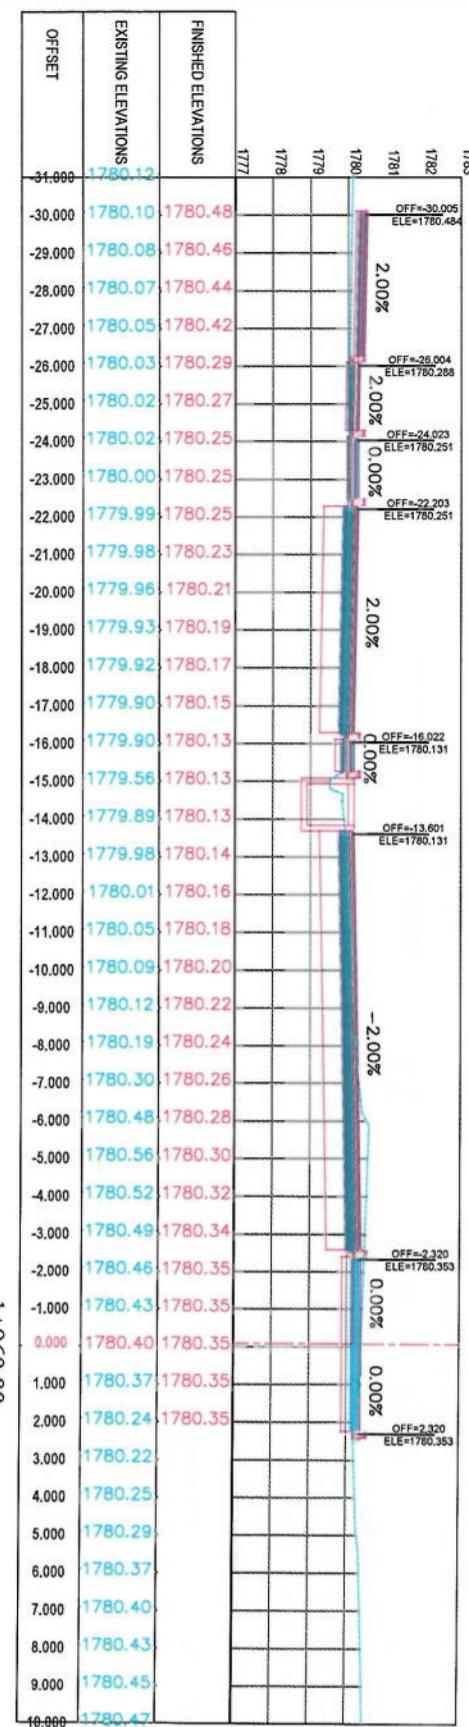

1+960.00

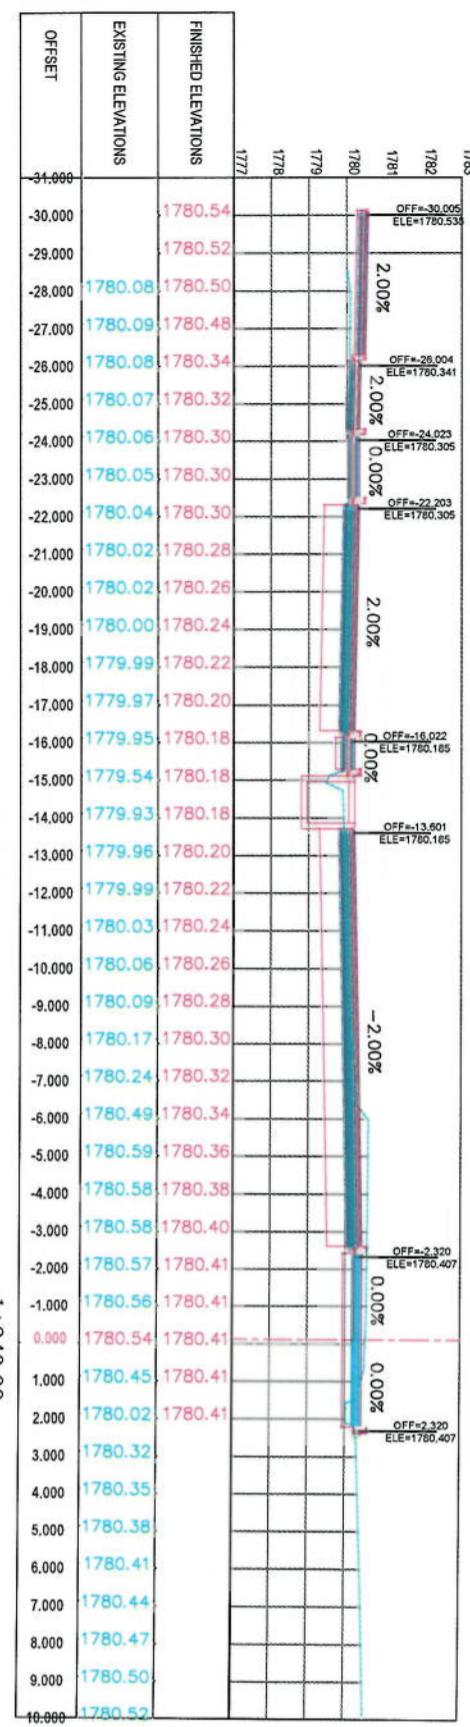

1+940.00

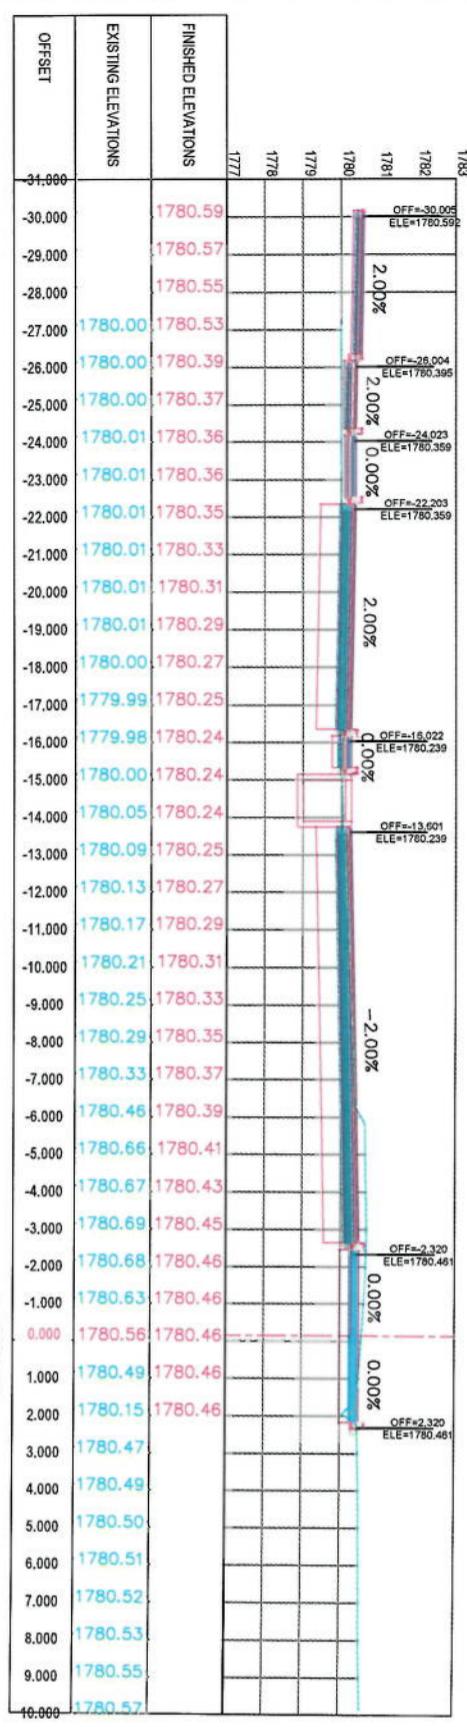

1+920.00

NOTE:  
1. All dimensions are in meters unless otherwise indicated.

LEGENDS		
CENTER-LINE	EXISTING SURFACE	EXISTING SIDE-DITCH



ISLAMIC EMIRATE OF  
AFGHANISTAN  
Client  
KABUL MUNICIPALITY  
Designed by:  
KABUL MUNICIPALITY  
DESIGN TEAM  
Project Name:  
Cone-Samp To Demazing  
Road Project

### CROSS SECTIONS

Designed by:  
Mohammad Esa Sari

Drawn by:  
Mohammad Esa Sari


Checked by:  
Hasanullah Shamsi

Date: 6/7/2023  
Scale: 1:200


Status: FINAL DESIGN

Project Code: CS-33  
Drawing Number: 00  
Revision:


1+980.00

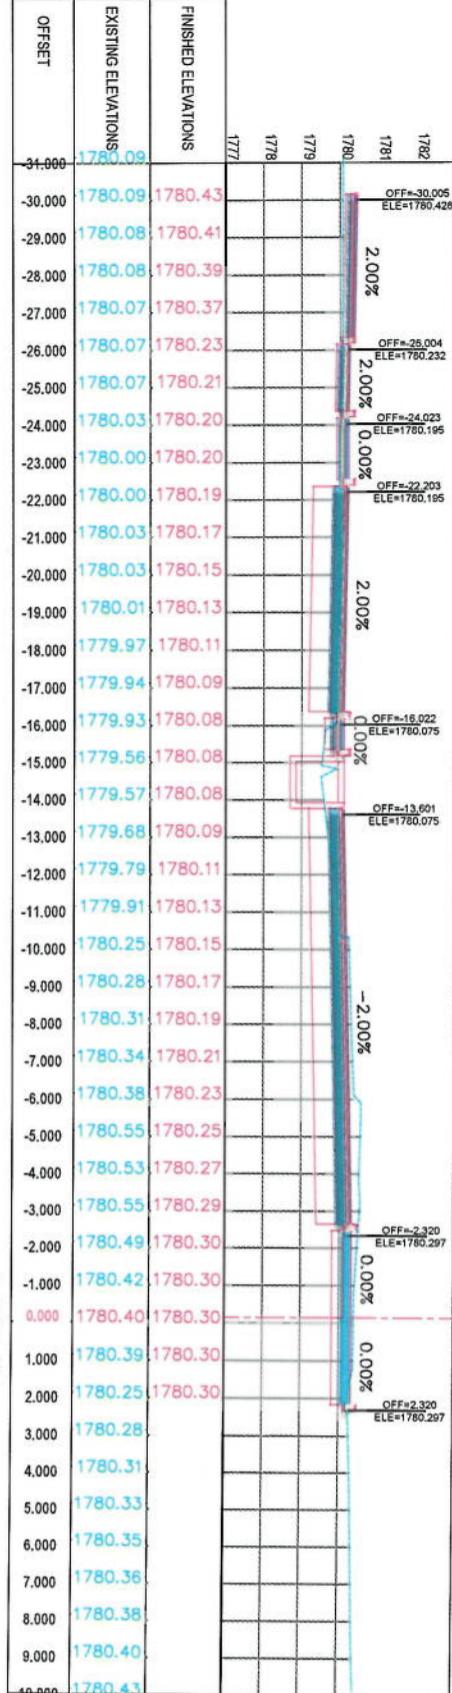

2+000.00

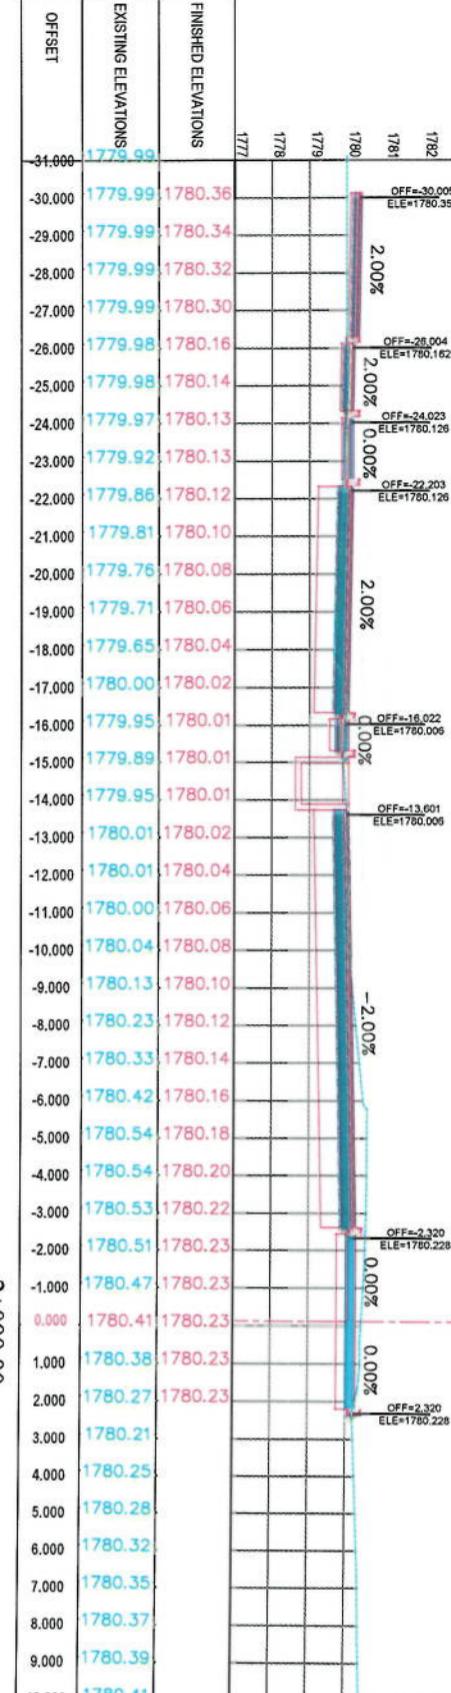


2+020.00

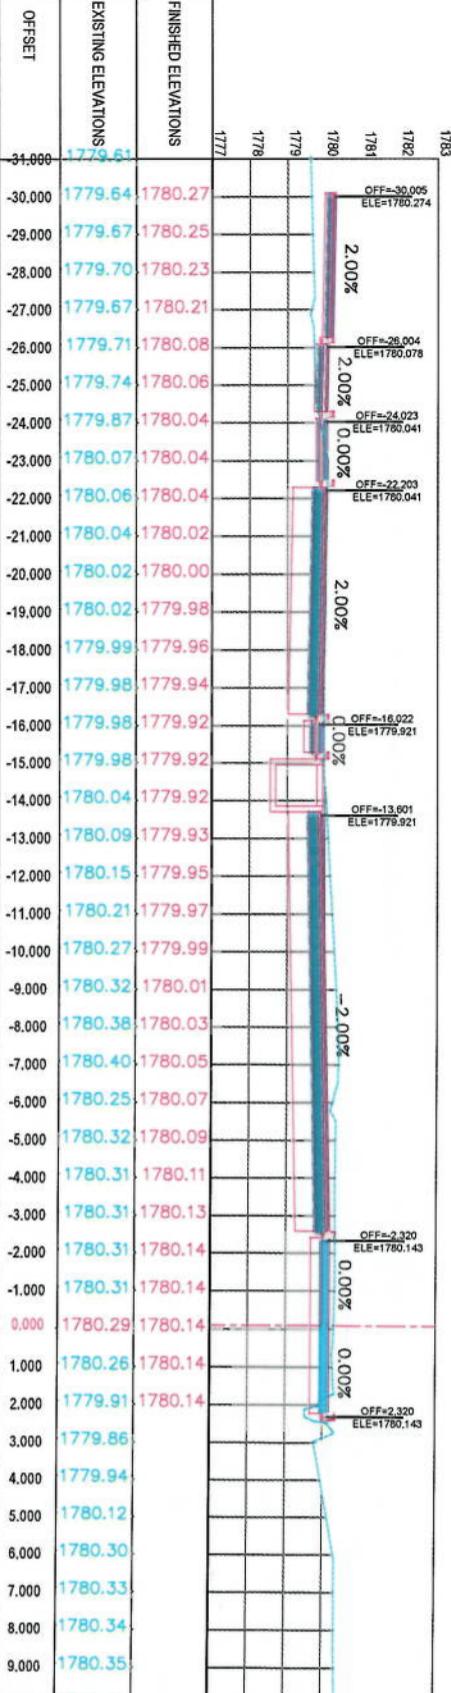
NOTE:  
1. All dimensions are in meters unless otherwise indicated.

LEGENDS:


	CENTER-LINE
	EXISTING SIDE DITCH
	EXISTING SURFACE

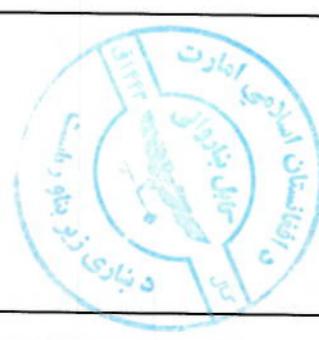


Project Name:	Corr-Sangi To Demzang Road project	
Drawing Title:	CROSS SECTIONS	
Designed by:	KABUL MUNICIPALITY DESIGN TEAM	
Date:	6/7/2023	
Scale:	1:200	
Status:	FINAL DESIGN	
Project Code:	CS-34	
Drawing Number:	00	
Revision:		

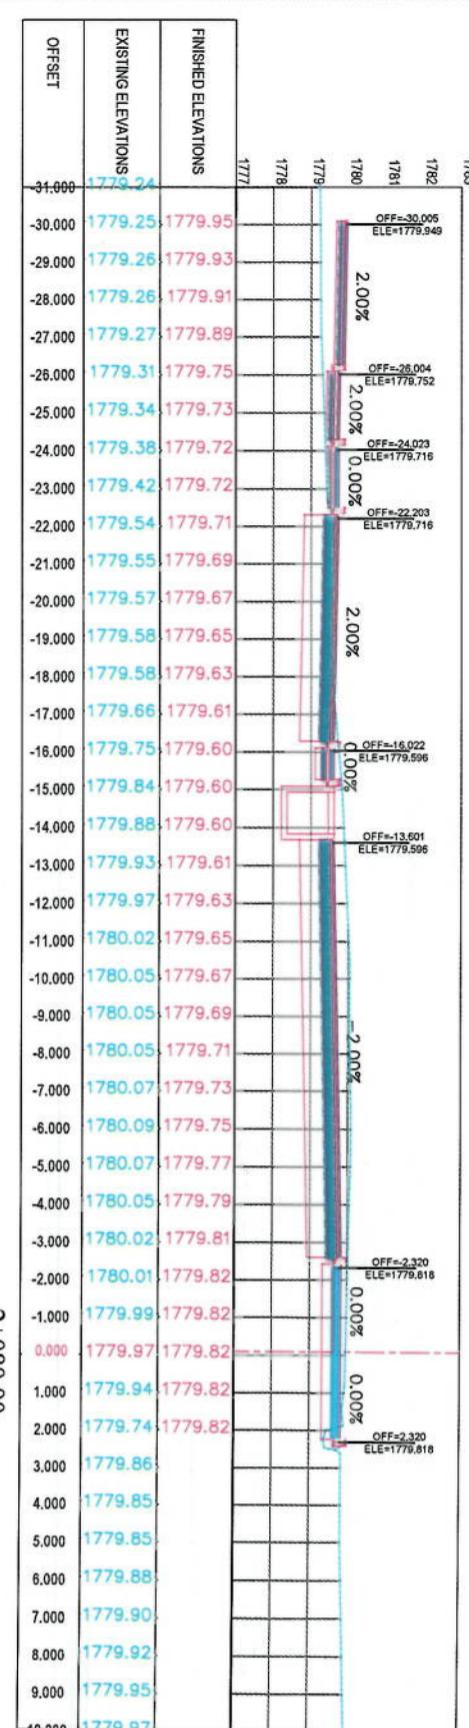

2+080.00

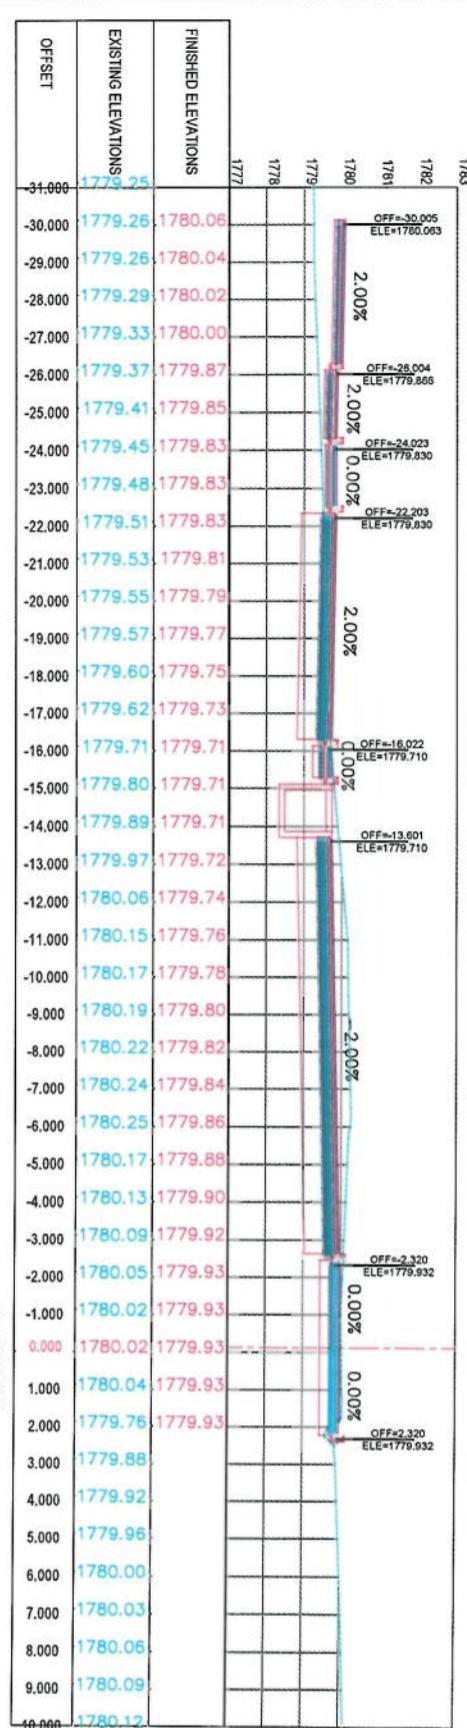

2+060.00

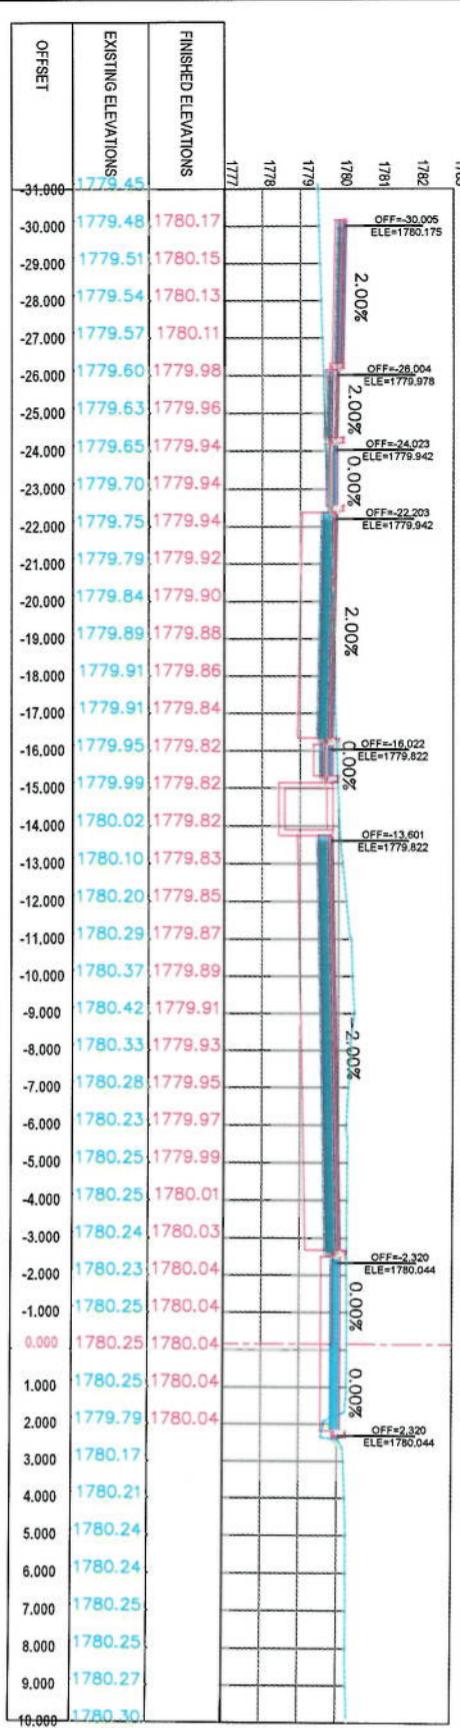

2+040.00


Project Name:		ISLAMIC EMIRATE OF AFGHANISTAN		
Drawing Title:		KABUL MUNICIPALITY		
CROSS SECTIONS				
Designed by:				
Drawn by:				
Checked by:				
Date:				
Status:		FINAL DESIGN		
Project Code:				
Drawing Number	CS-35	Revision 00		




NOTE:  
1. All dimensions are in meters unless otherwise indicated.

**LEGENDS**


- CENTER-LINE
- EXISTING SURFACE
- EXISTING SIDE DITCH

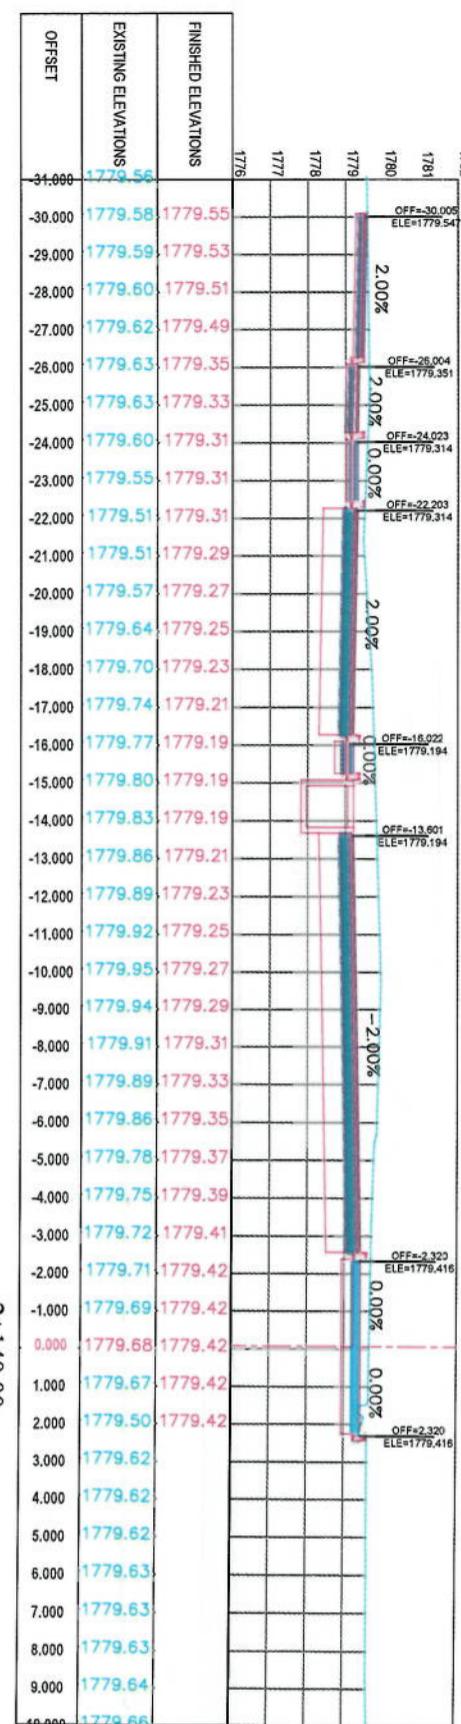


2+140.00

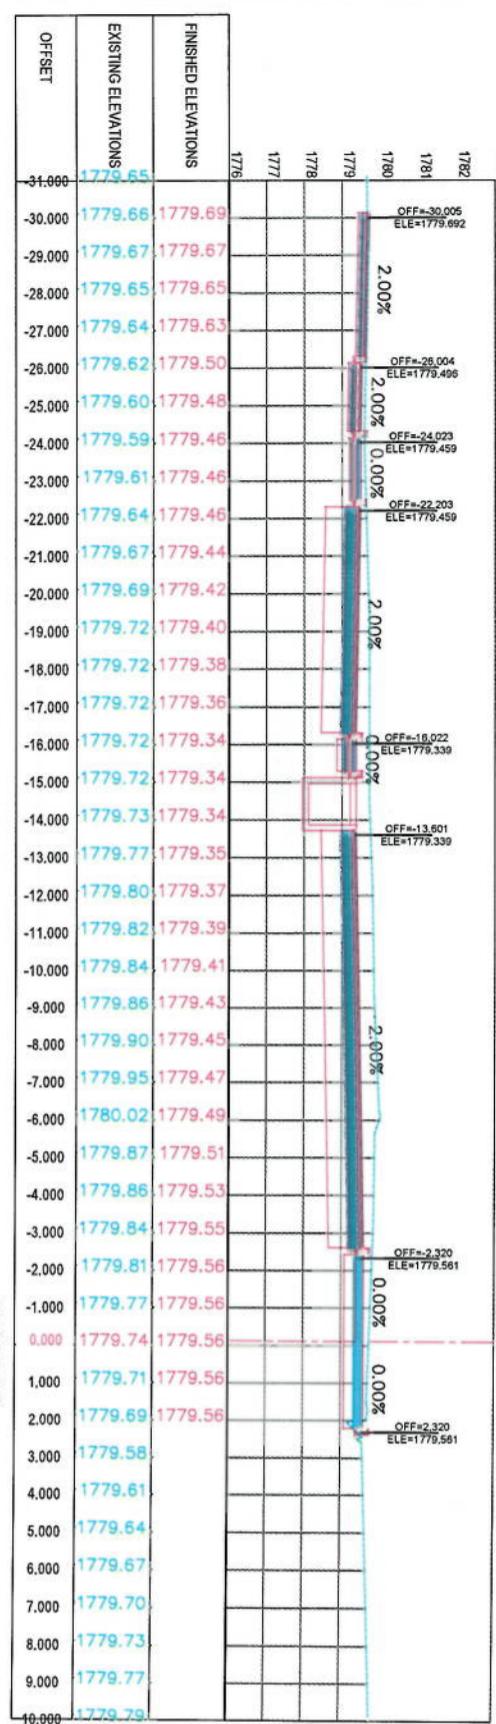

2+120.00

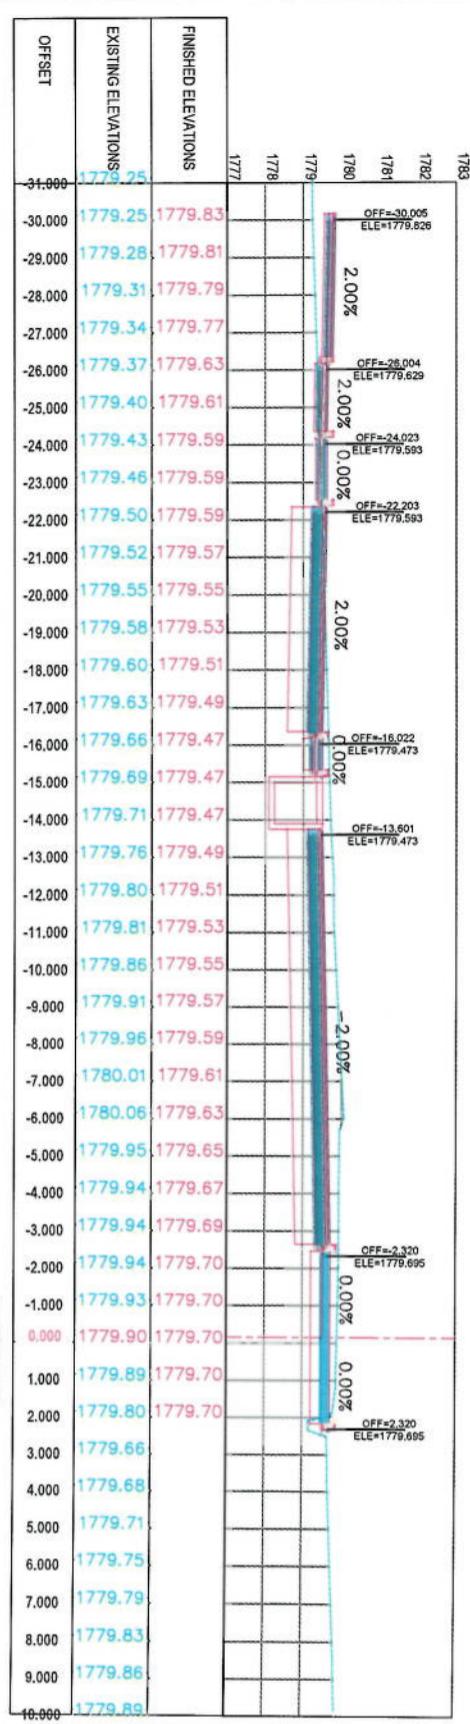


CROSS SECTIONS

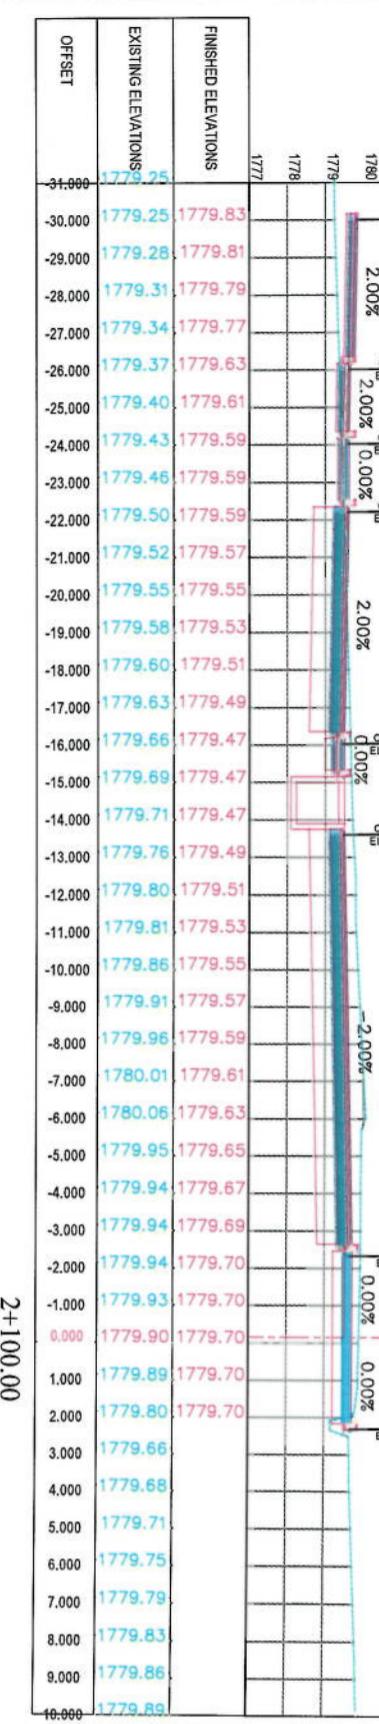



2+100.00

Designed by:	Mohammad Eesa Sint
Drawn by:	Mohammad Eesa Sint
Checked by:	Hassanullah Sint
Date:	6/7/2023
Scale:	1:200
Same:	FINAL DESIGN
Project Code:	CS-36
Revision:	00

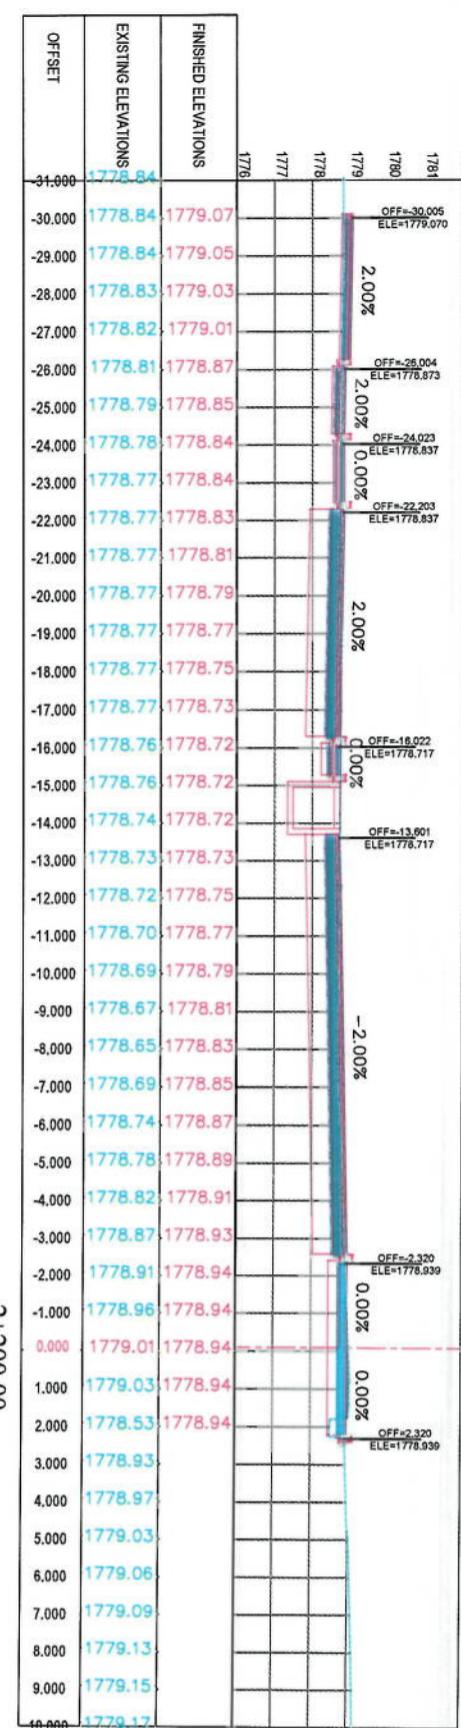

2+200.00

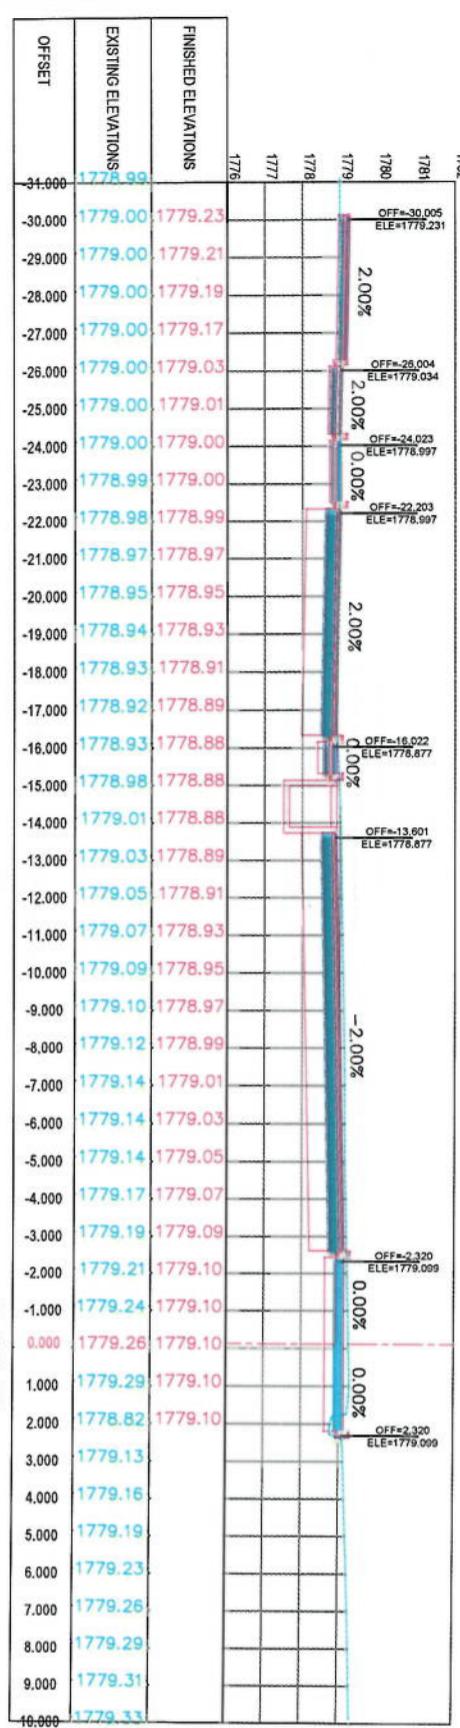

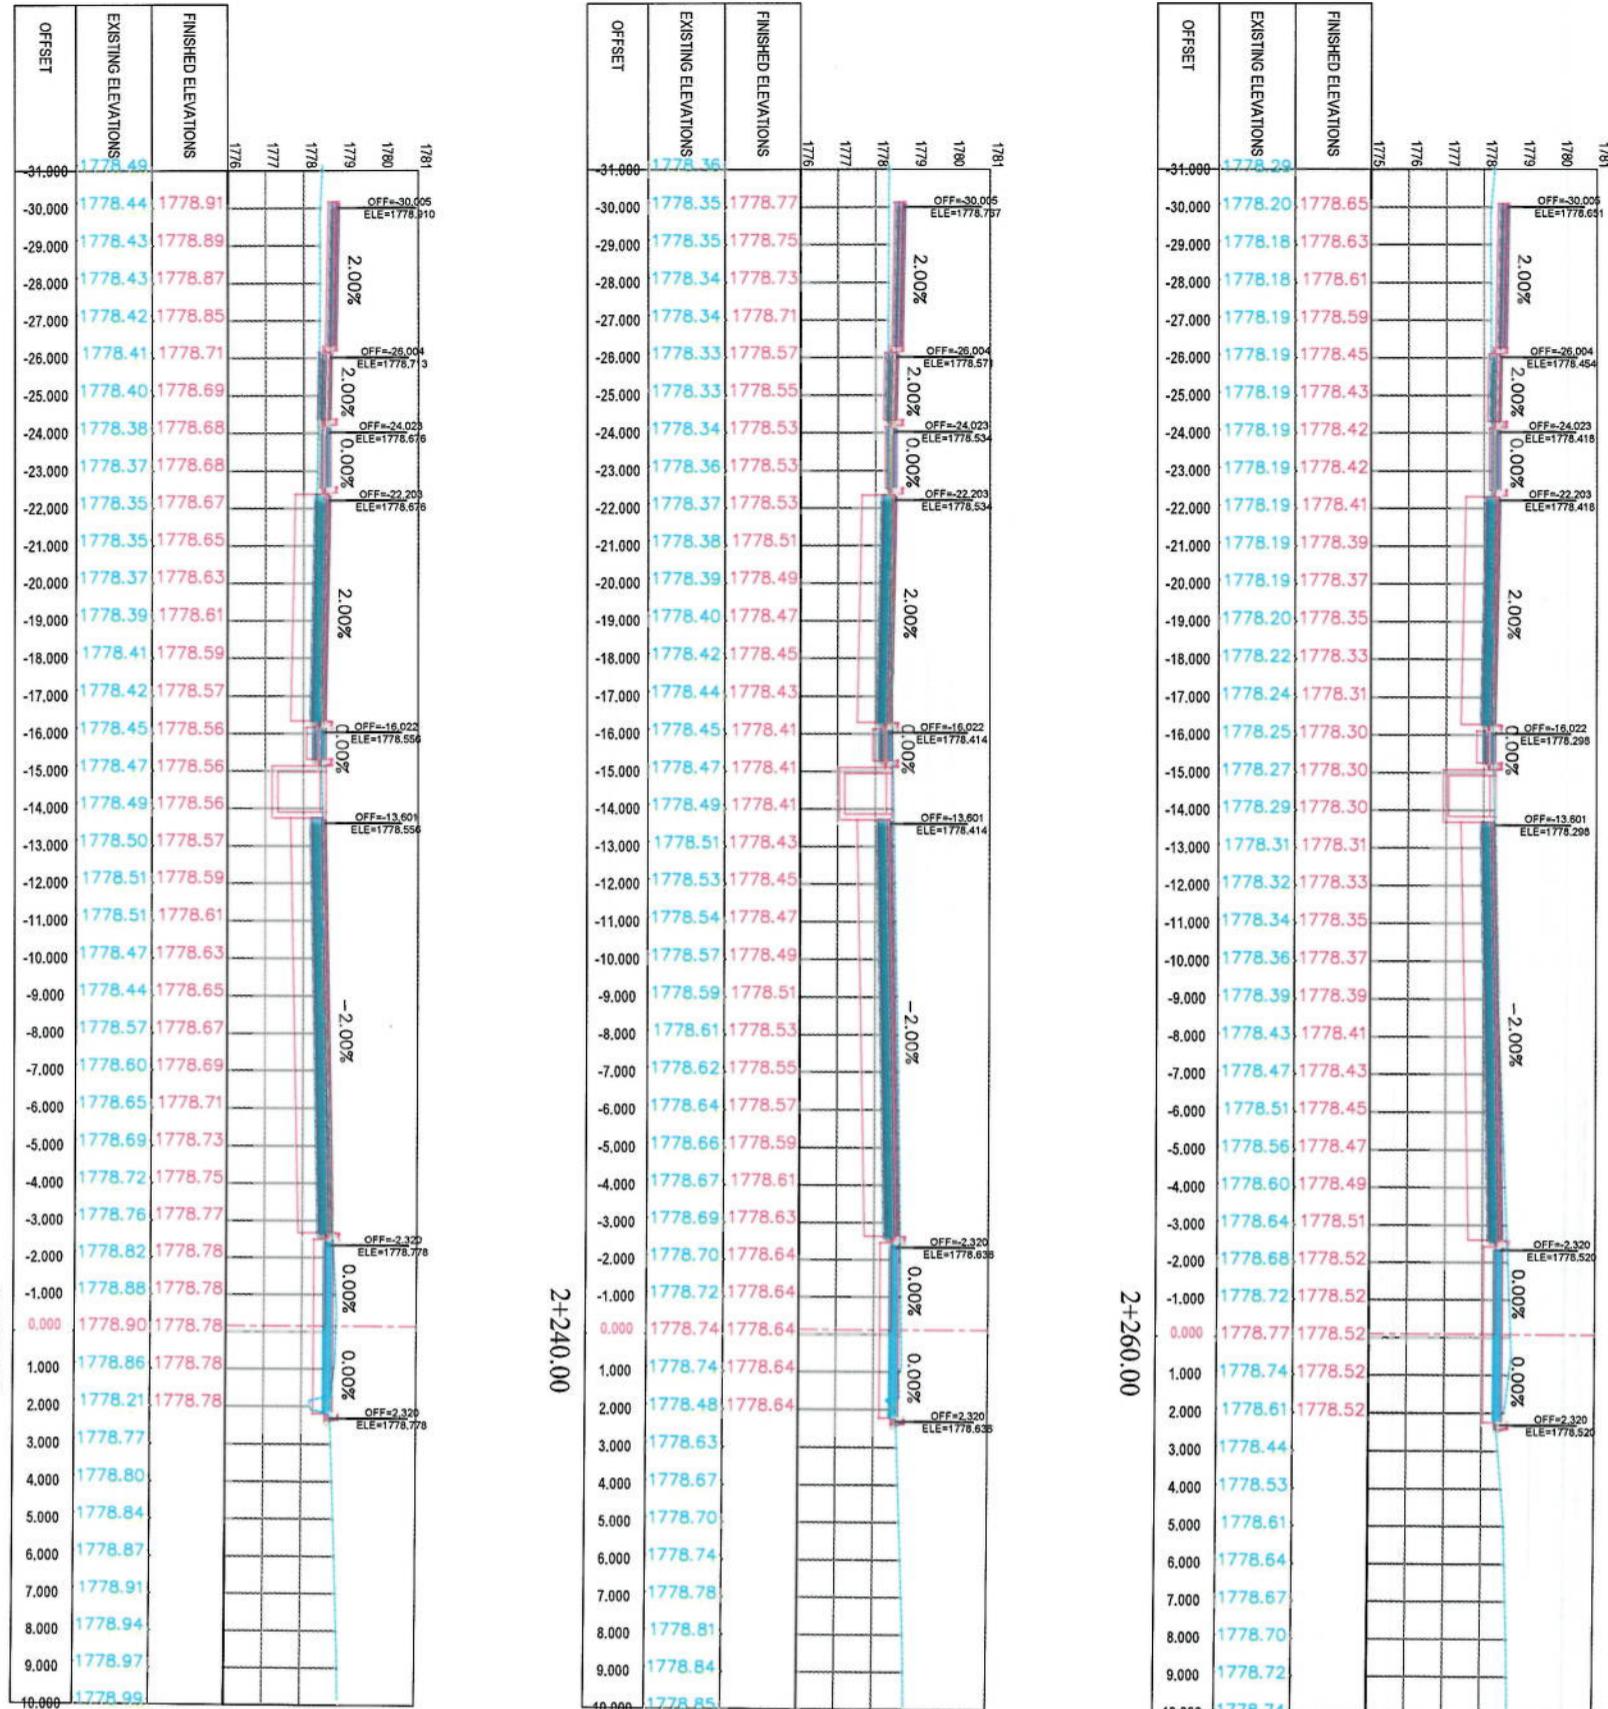

## NOTE:


1. All dimensions are in meters unless otherwise indicated.

LEGENDS	
	CENTER-LINE
	EXISTING SURFACE
	EXISTING SIDE-DITCH



CROSS SECTIONS	
Designed by: KABUL MUNICIPALITY DESIGN TEAM	
Project Name: KABUL MUNICIPALITY AFGHANISTAN	
Client: KABUL MUNICIPALITY	
Date:	
Revision:	
Drawings:	

Offset	1778.49	1778.50	1778.51	1778.99
FINISHED ELEVATIONS	1778.49	1778.50	1778.51	1778.99
EXISTING ELEVATIONS	1778.49	1778.50	1778.51	1778.99
OFFSET	-31.000	-30.000	-29.000	-28.000	-27.000	-26.000	-25.000	-24.000	-23.000	-22.000	-21.000	-20.000	-19.000	-18.000	-17.000	-16.000	-15.000	-14.000	-13.000	-12.000	-11.000	-10.000	-9.000	-8.000	-7.000	-6.000	-5.000	-4.000	-3.000	-2.000	-1.000	0.000	1.000	2.000	3.000	4.000	5.000	6.000	7.000	8.000	9.000	10.000									

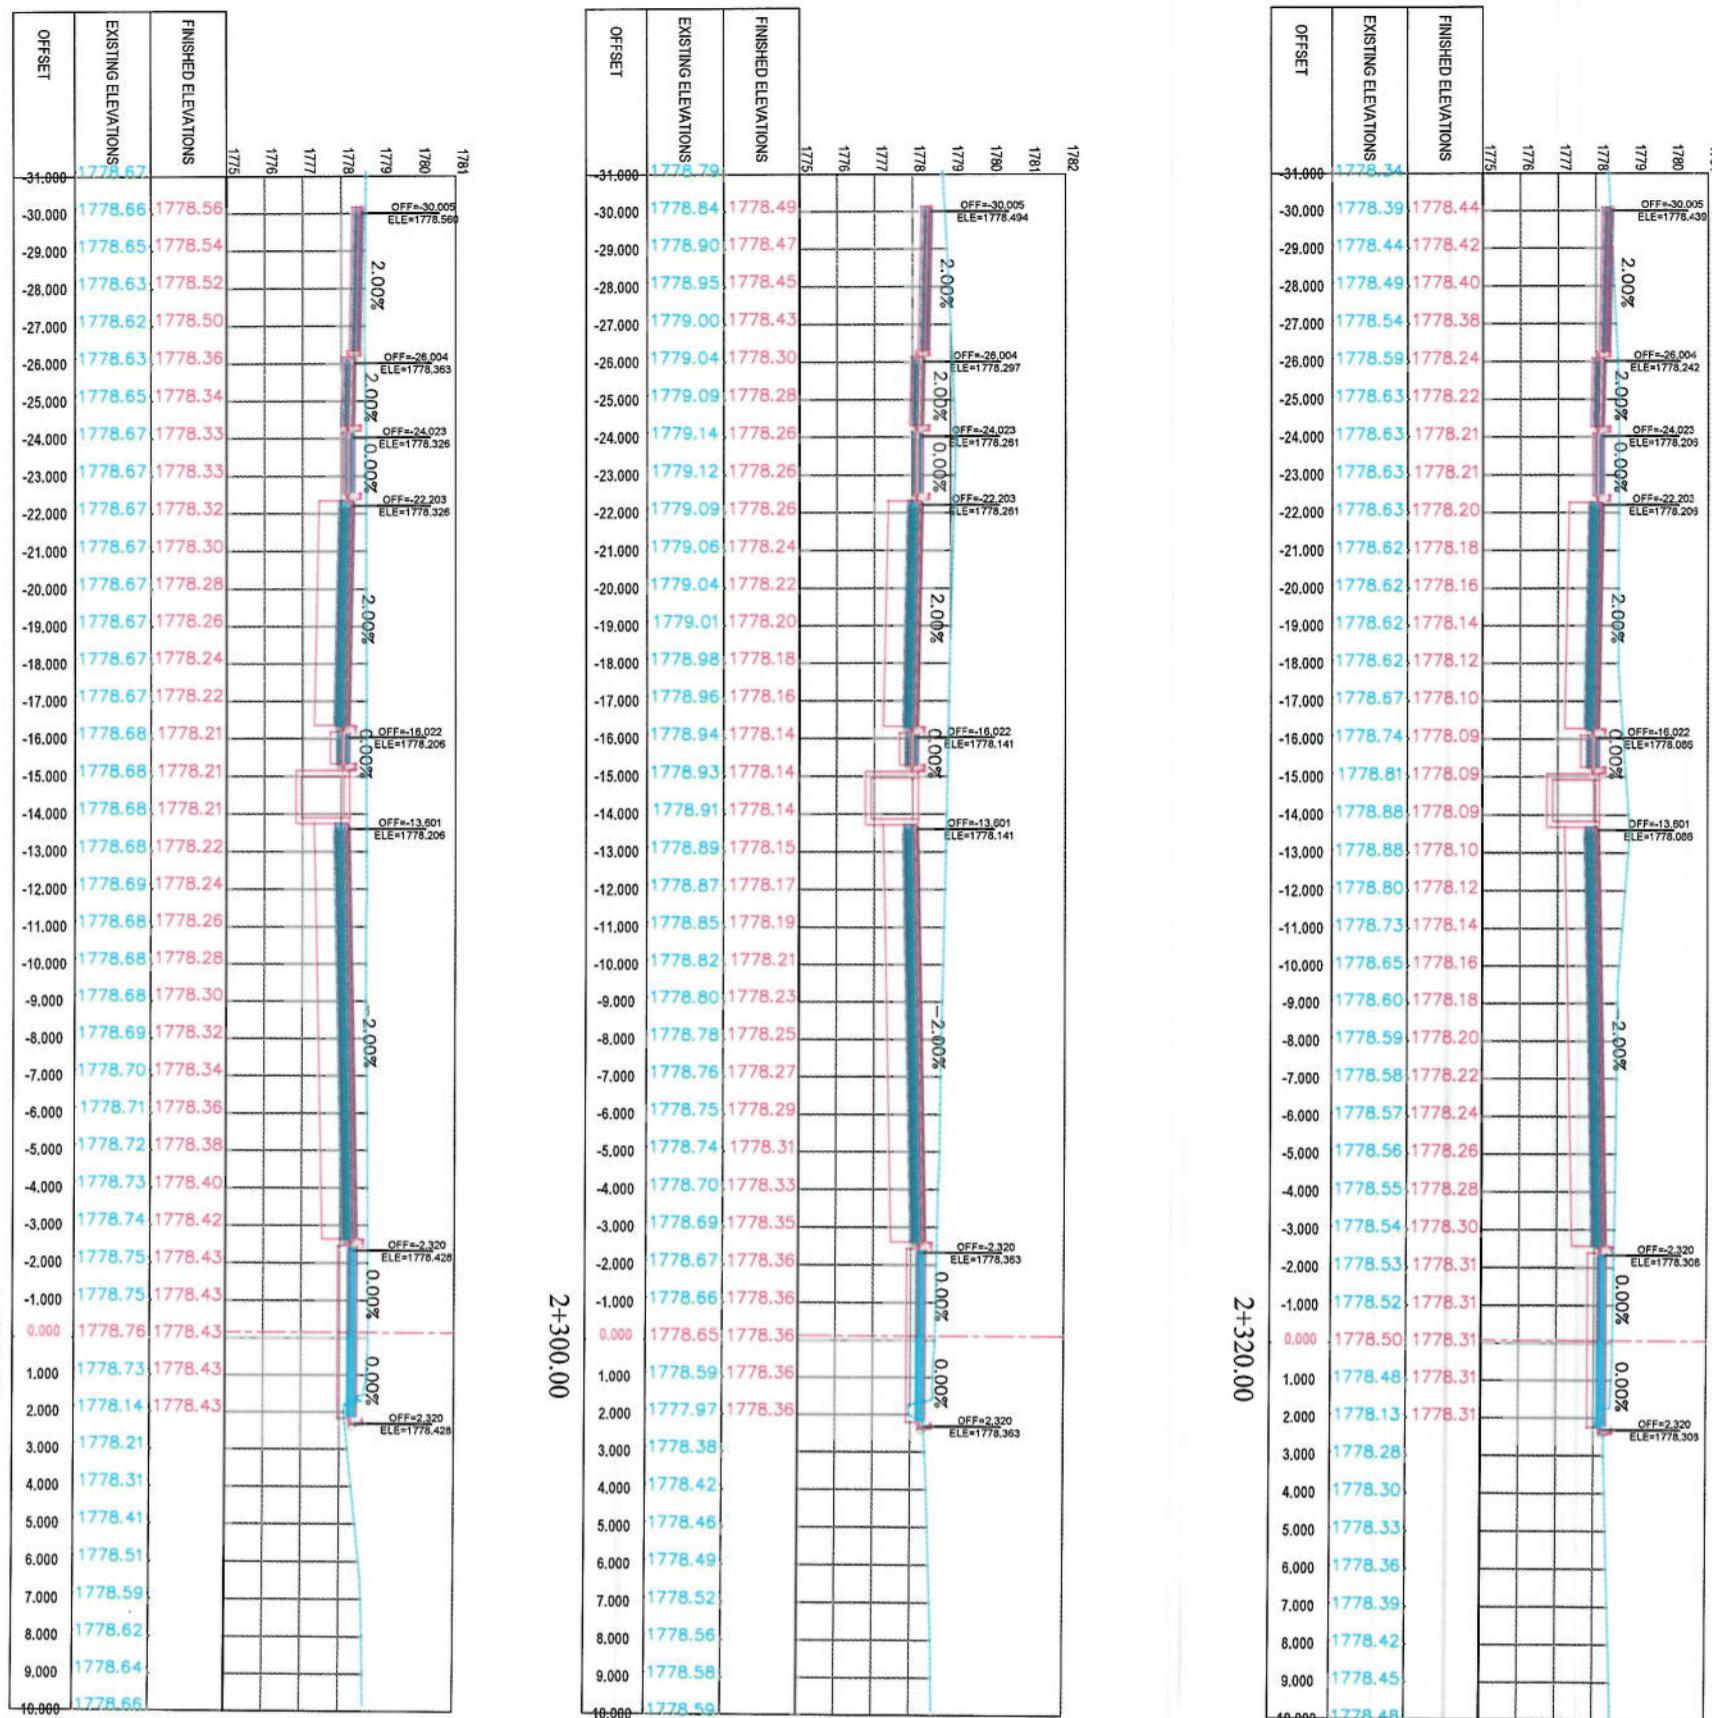


2+280.00

2+300.00

2+320.00




NOTE:	
1. All dimensions are in meters unless otherwise indicated	
<b>LEGENDS</b> <ul style="list-style-type: none"> <li><span style="color: red;">—</span> — <span style="color: red;">—</span> CENTER-LINE</li> <li><span style="color: blue;">---</span> EXISTING SURFACE</li> <li><span style="color: blue;">—</span> EXISTING SIDE DITCH</li> </ul>	
	
<p align="center"><b>ISLAMIC EMIRATE OF AFGHANISTAN</b></p>	
<p align="center">Client  KABUL MUNICIPALITY</p>	
<p align="center">Designed by: <b>KABUL MUNICIPALITY DESIGN TEAM</b></p>	
<p align="center">Project Name: <b>Cole-Sangji To Demanzang Road project</b></p>	
<p align="center">Drawing Title: <b>Drawing Title</b></p>	
<p align="center"><b>CROSS SECTIONS</b></p>	
Designed By:	
Drawn By:	
Checked by:	
Date:	6/7/2023
Scale:	1:200
Status:	<b>FINAL DESIGN</b>
Project Code:	
Drawing Number:	CS-39
Revision:	00

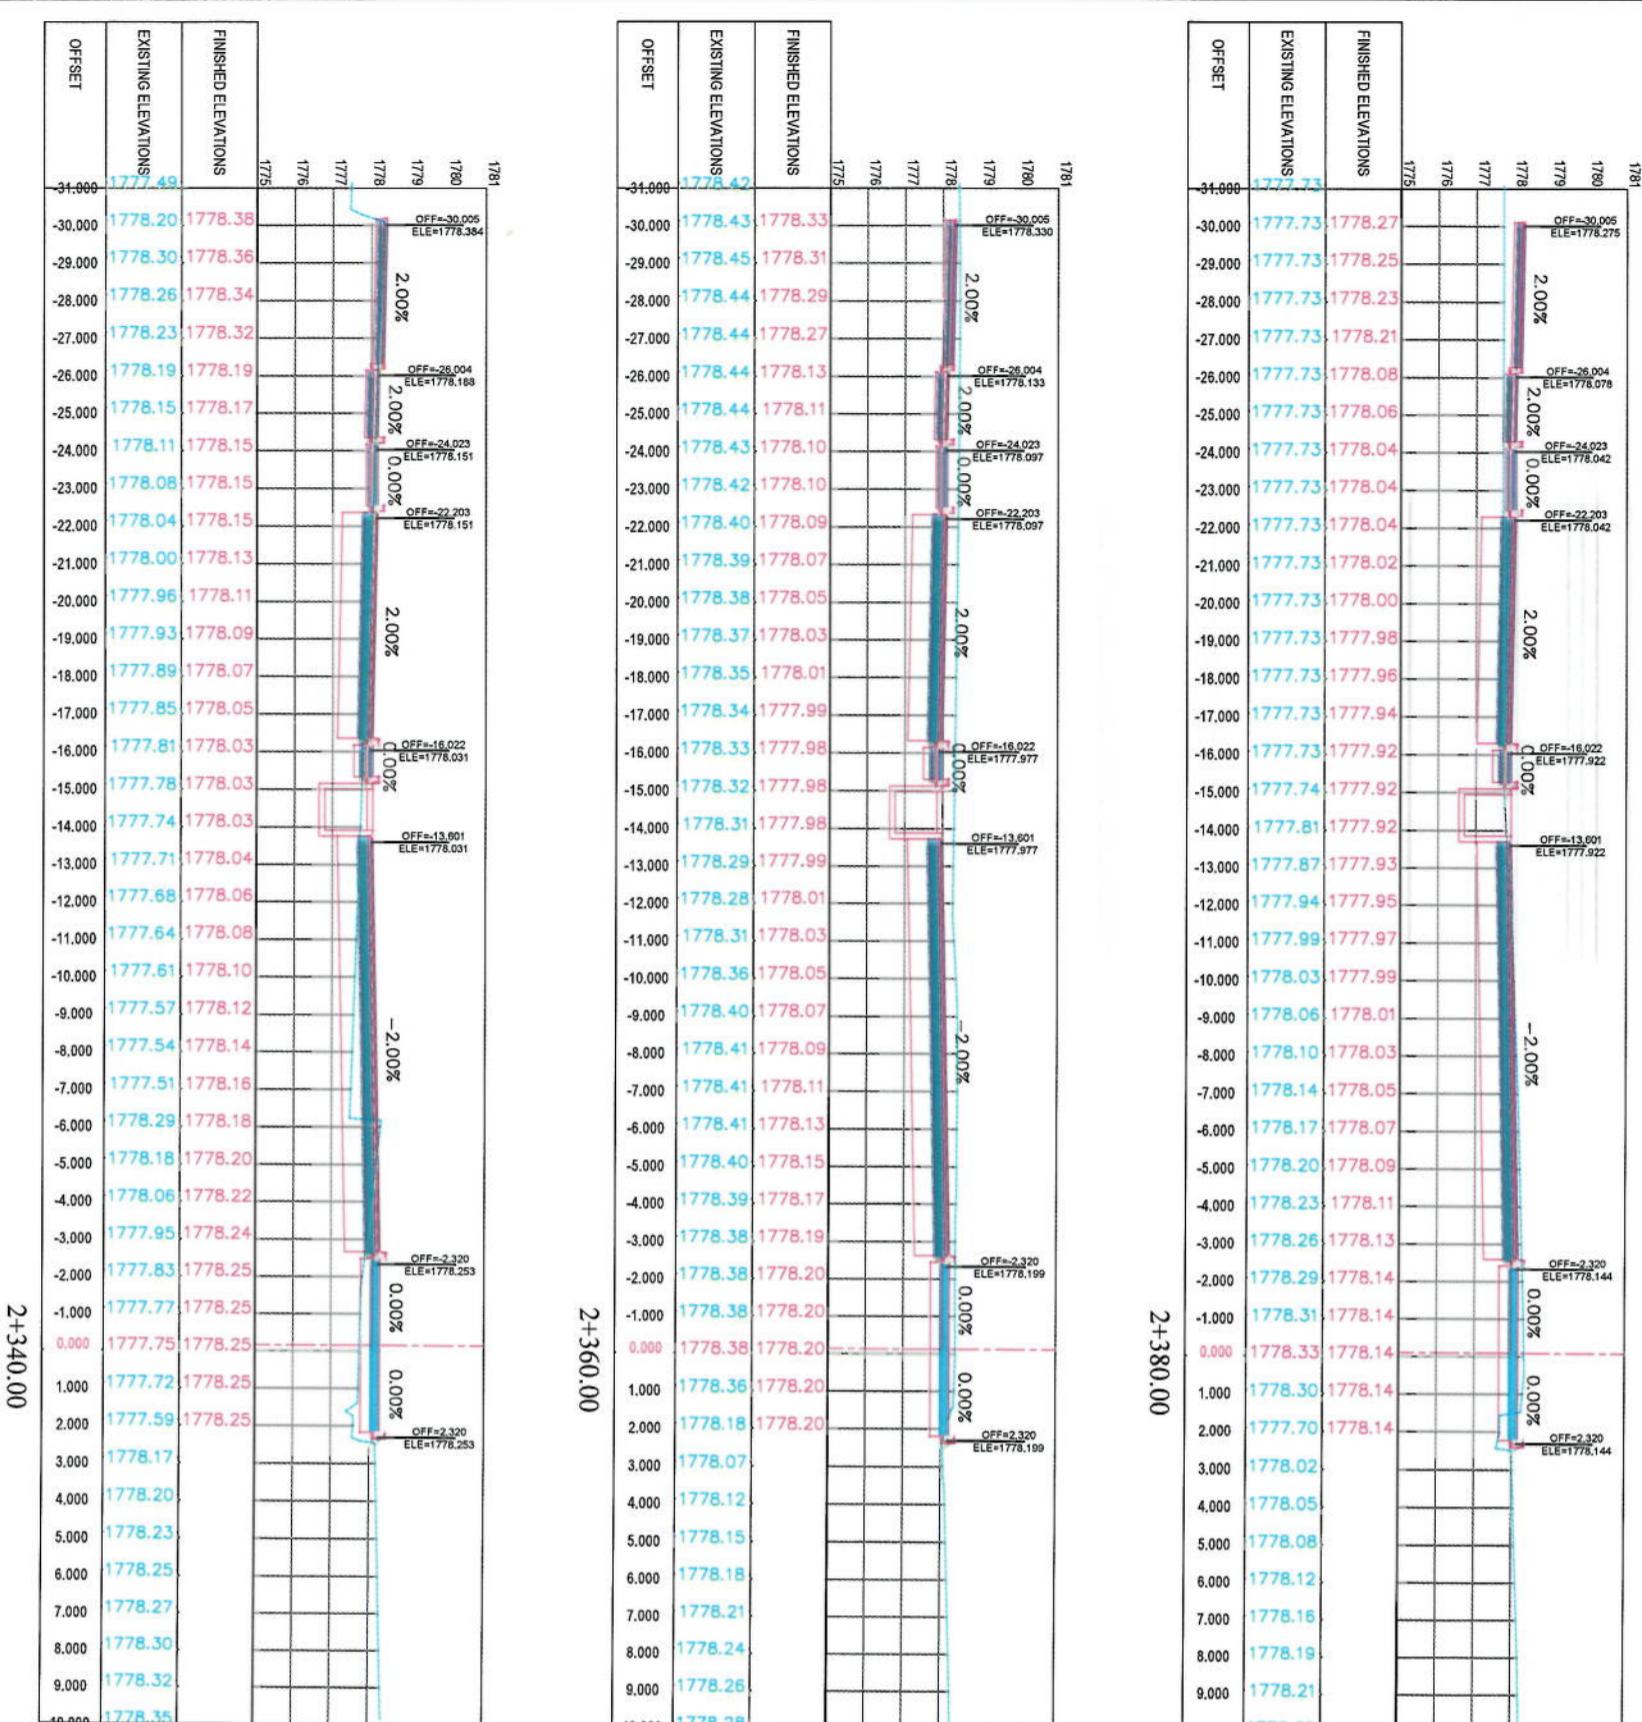


NOTE:


1. All dimensions are in meters unless otherwise indicated.

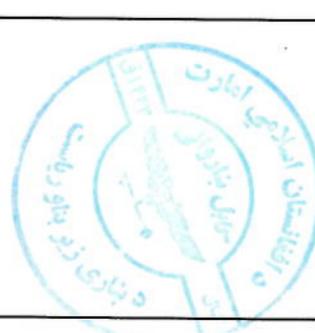

Project Name:	KABUL MUNICIPALITY DESIGN TEAM	
Designated by:	KABUL MUNICIPALITY	
Client:		
Designed by:	KABUL MUNICIPALITY	
Contractor:	KABUL MUNICIPALITY	
Date:	6/7/2023	
Status:	FINAL DESIGN	
Project Code:	CS-40	
Drawing Number:	00	

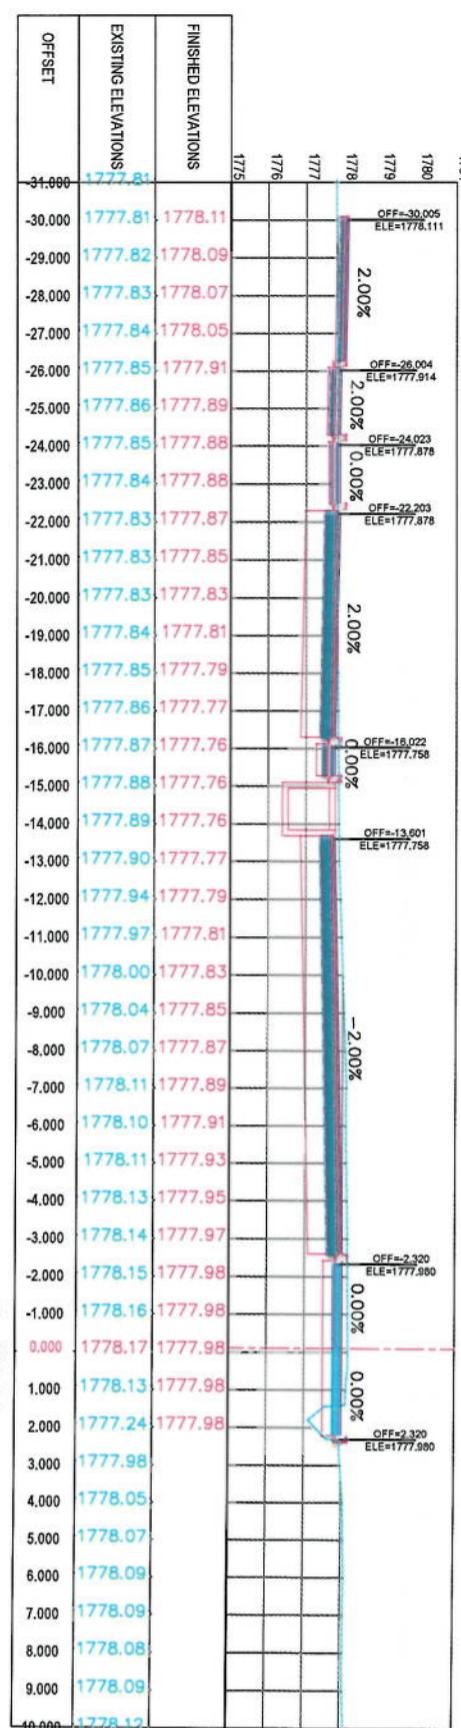

2+440.00

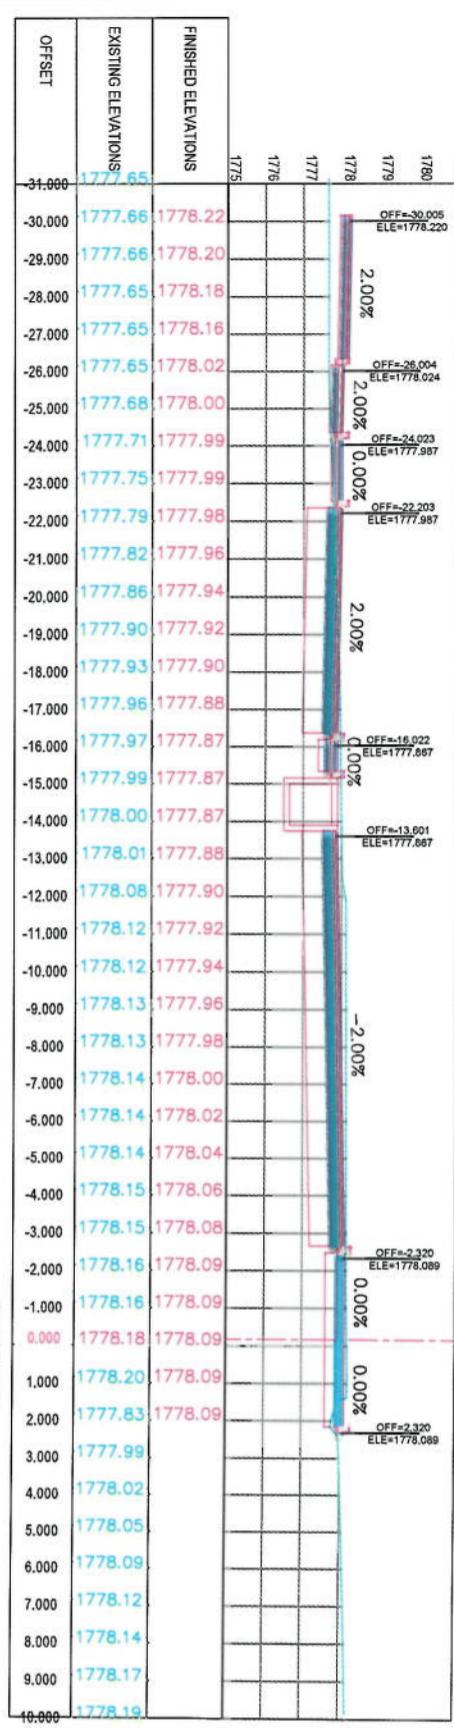

2+420.00

NOTE:

1. All dimensions are in meters unless otherwise indicated.

LEGENDS

CENTER-LINE


EXISTING SURFACE

EXISTING SIDE DITCH




Project Name:	KABUL MUNICIPALITY DESIGN TEAM		
Designed by:	Client	KABUL MUNICIPALITY	
Date:	Revision Details	Printed	
Drawing Title:	CROSS SECTIONS		
Designed by:	Signature:		
Drawn by:	Signature:		
Checked by:	Signature:		
Date:	Scale:		
6/7/2023	1:200		
Status:	FINAL DESIGN		
Project Code:			
Drawing Number:	CS-4-1	Revision	00



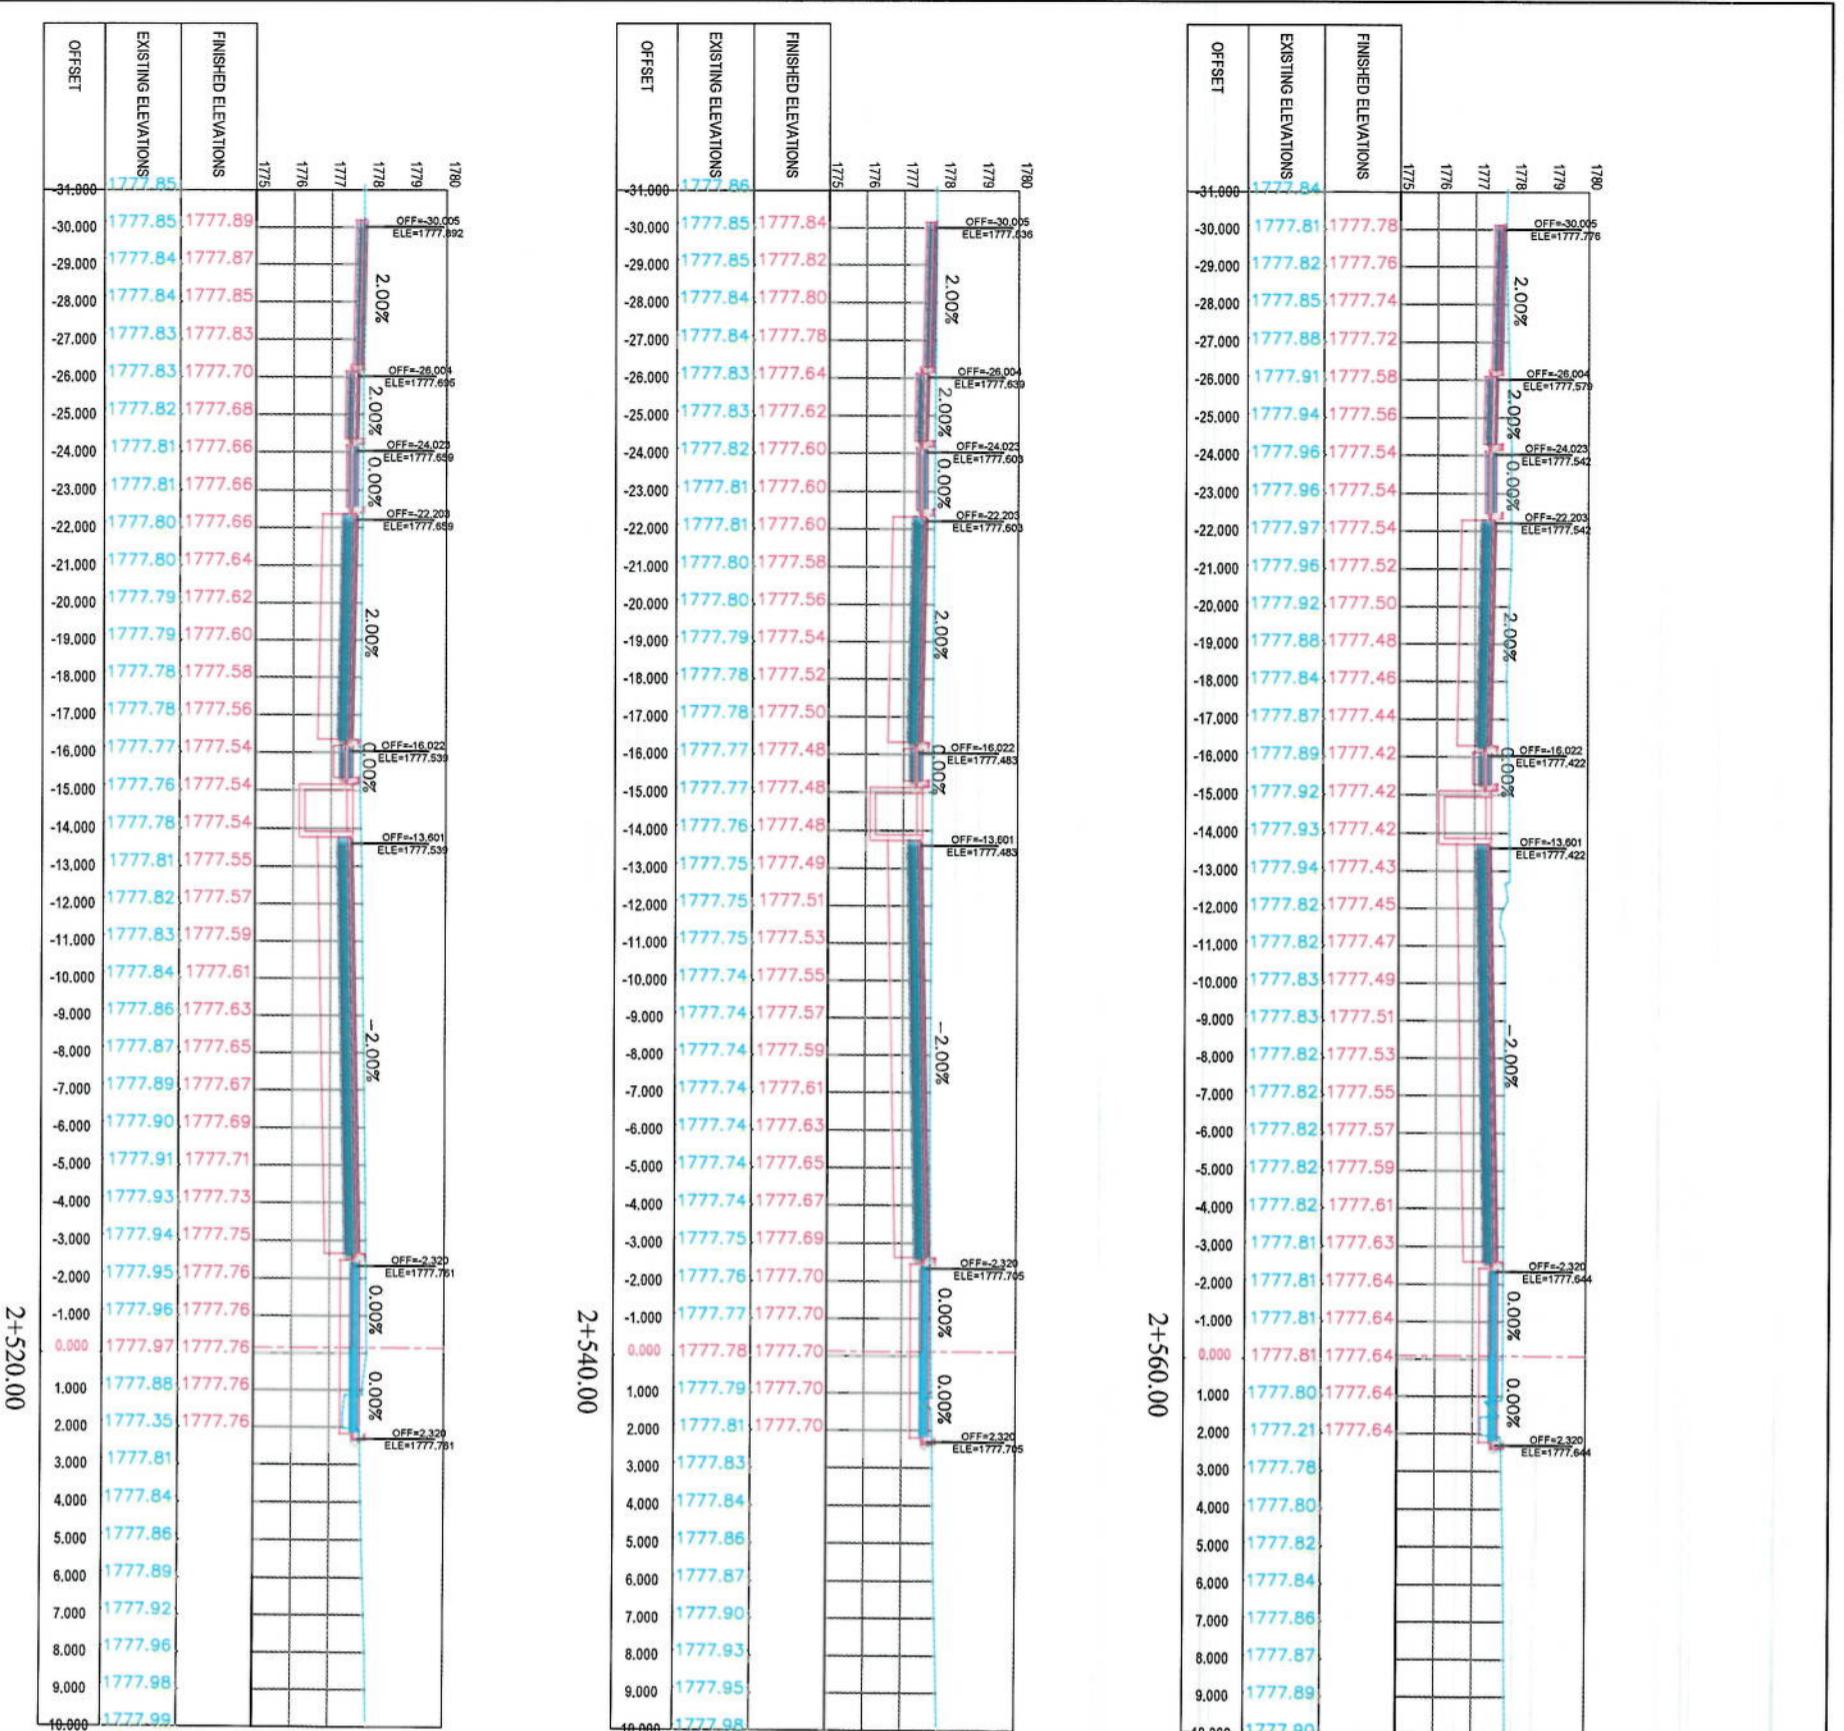

CROSS SECTIONS		ISLAMIC EMIRATE OF AFGHANISTAN	
Designed by:	KABUL MUNICIPALITY DESIGN TEAM	Client	KABUL MUNICIPALITY
Project Name: One-Stop To Demazang Road project			
Drawing Title:			
Designed By: Mohammad Esa Sait Drawn By: Mohammad Esa Sait Checked by: Hasbullah Shabiz			
Date: 6/7/2023	Scale: 1:200		
Status: FINAL DESIGN	Project Code:		
Drawing Number: CS-43	Revision: 00		

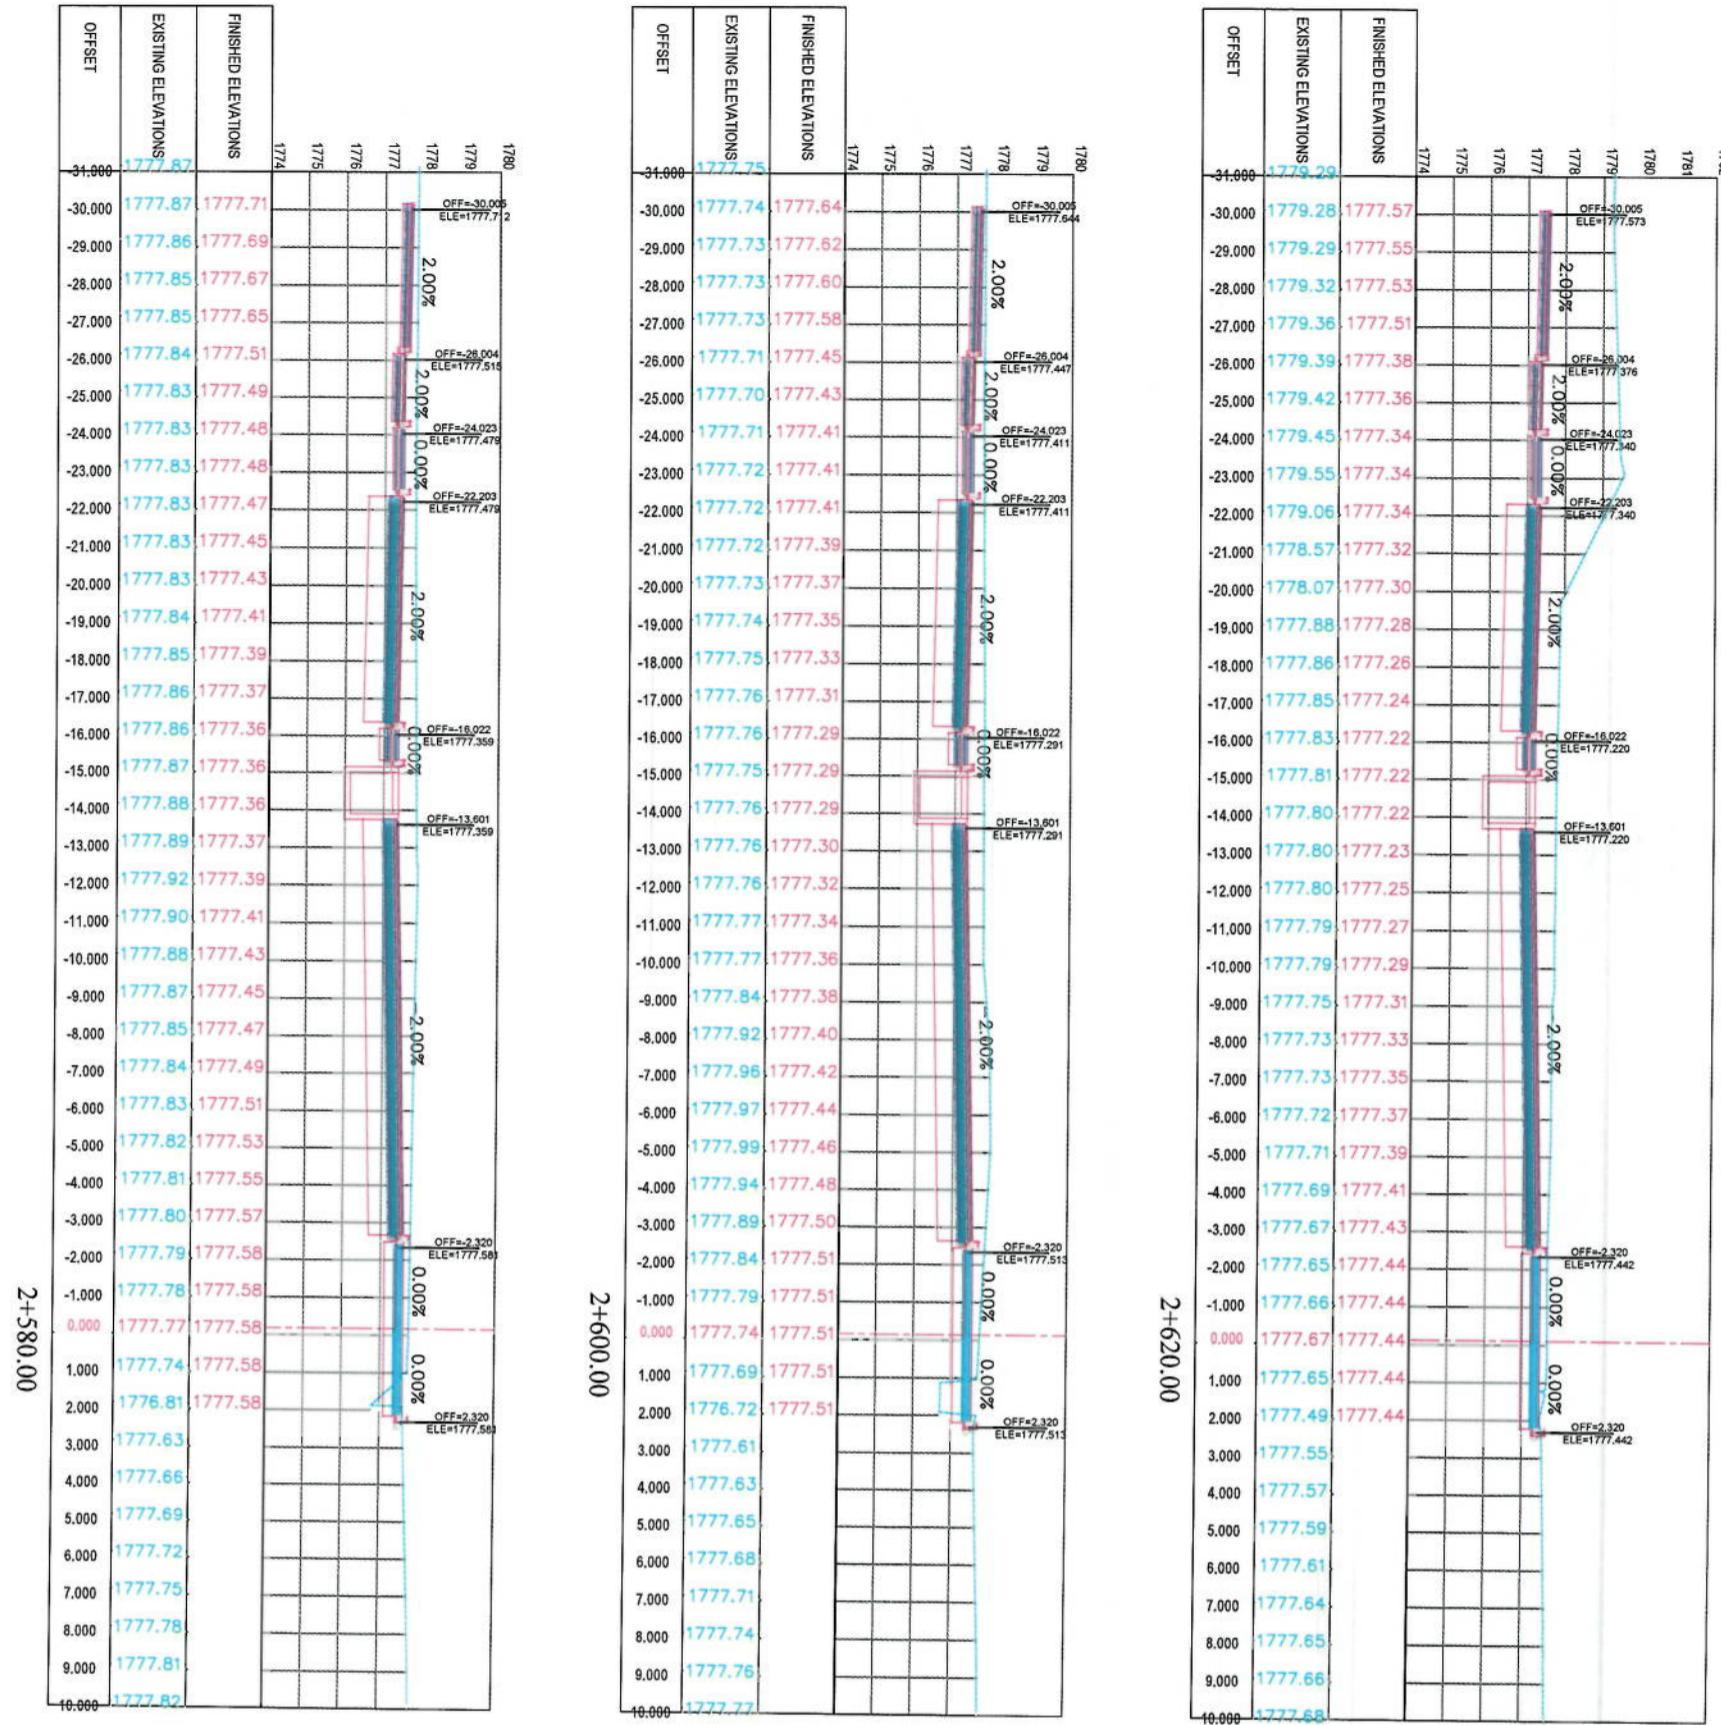

Project Name: *Or-e-Sangi To Demazang Road Project*

Designed by: *KABUL MUNICIPALITY DESIGN TEAM*

Client: *KABUL MUNICIPALITY*

ISLAMIC EMIRATE OF AFGHANISTAN



NOTE:  
1. All dimensions are in meters unless otherwise indicated

**LEGENDS**

- CENTER-LINE**
- EXISTING SURFACE**
- EXISTING SIDE DITCH**

Drawing Title: *CROSS SECTIONS*

Designed by: *Mohammad Esa Sut*

Checked by: *Habibullah Shahzai*


Date: *6/7/2023*

Scale: *1:200*


Status: *FINAL DESIGN*

Project Code: *CS-44*


Revision: *00*

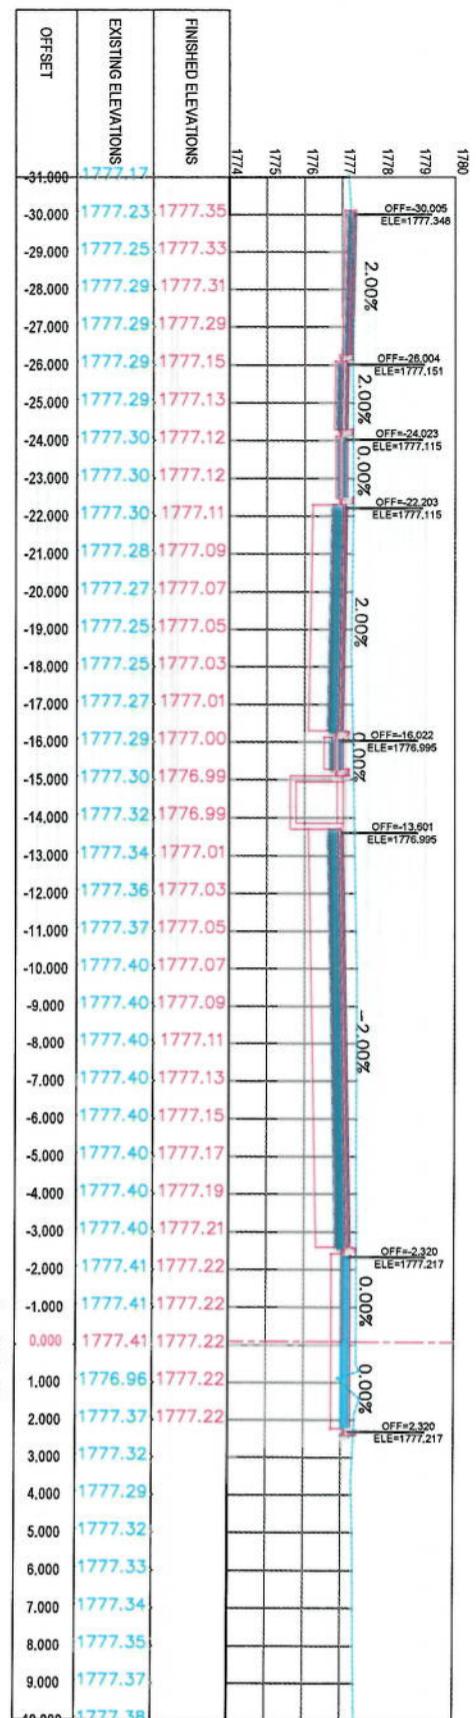

2+680.00

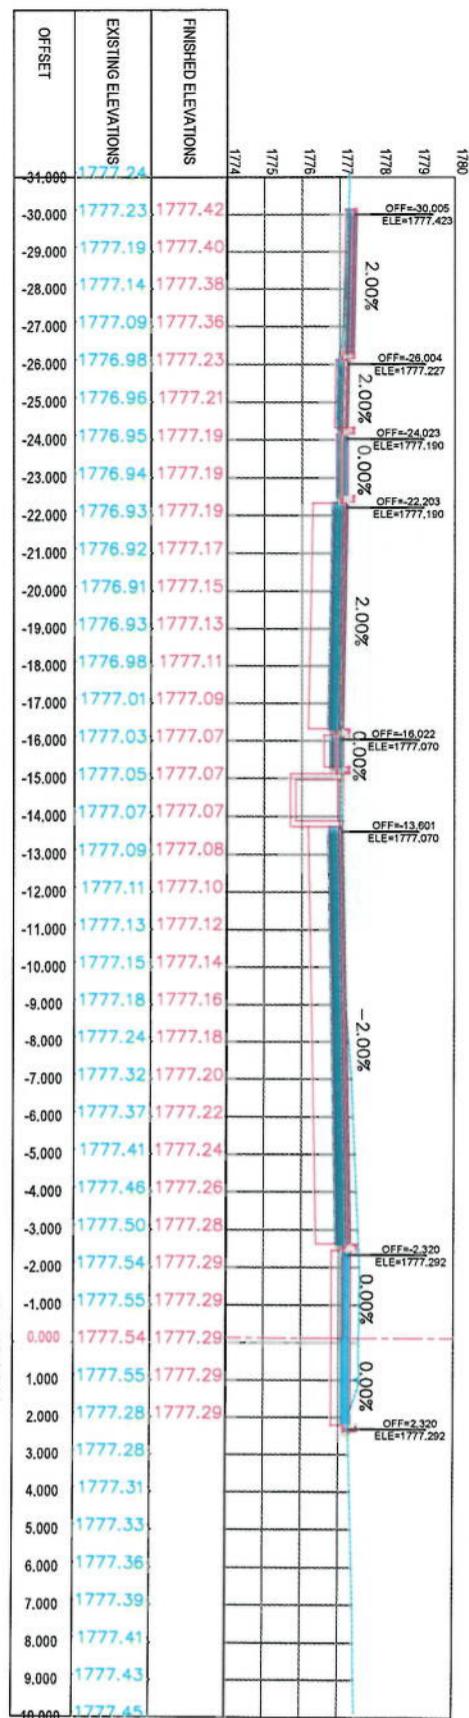

2+660.00

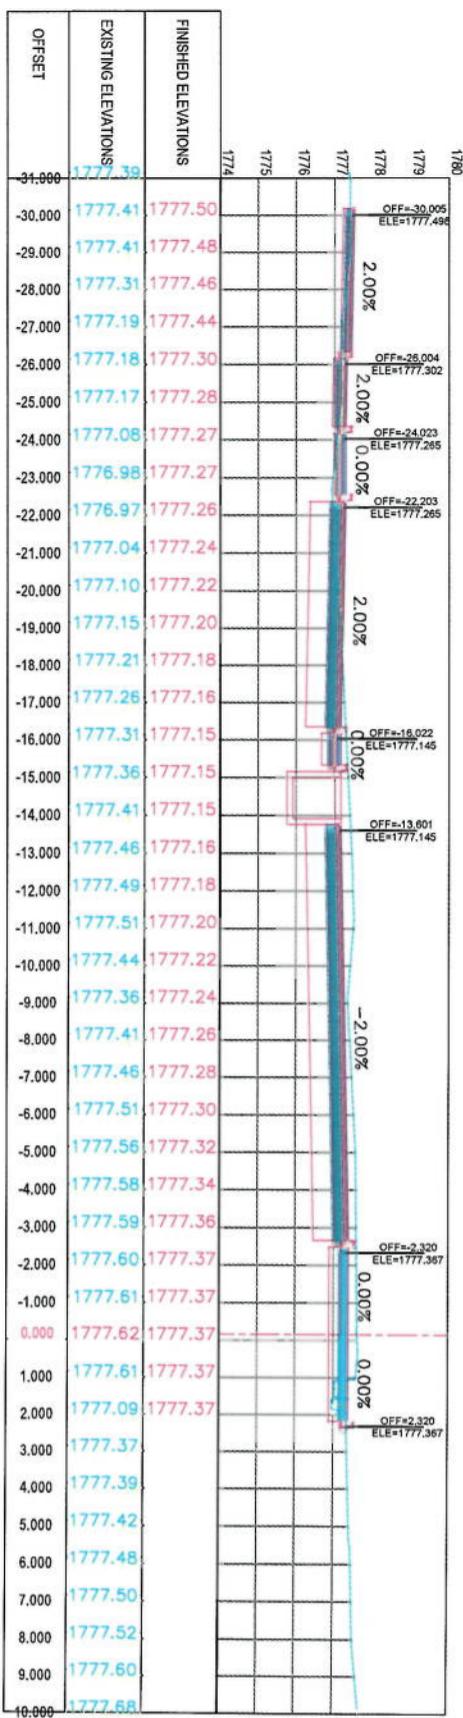

2+640.00




NOTE:  
1. All dimensions are in meters unless otherwise indicated.

**LEGENDS**

- CENTER-LINE
- EXISTING SURFACE
- EXISTING SIDE DITCH
- ISLAMIC EMIRATE OF AFGHANISTAN  
KABUL MUNICIPALITY



Designed by:	Signature:
Drawn by:	Signature:
Checked by:	Signature:
Project Name:	KABUL MUNICIPALITY DESIGN TEAM
Code-Signed To Designing	Road project
Drawing Title:	CROSS SECTIONS
Designed by:	Signature:
Mohammad Eisa Siaat	
Drawn by:	Signature:
Mohammad Eisa Siaat	
Checked by:	Signature:
Hassanullah Shalizi	
Date:	6/7/2023
Scale:	1:200
Status:	FINAL DESIGN
Project Code:	CS-45
Revision:	00

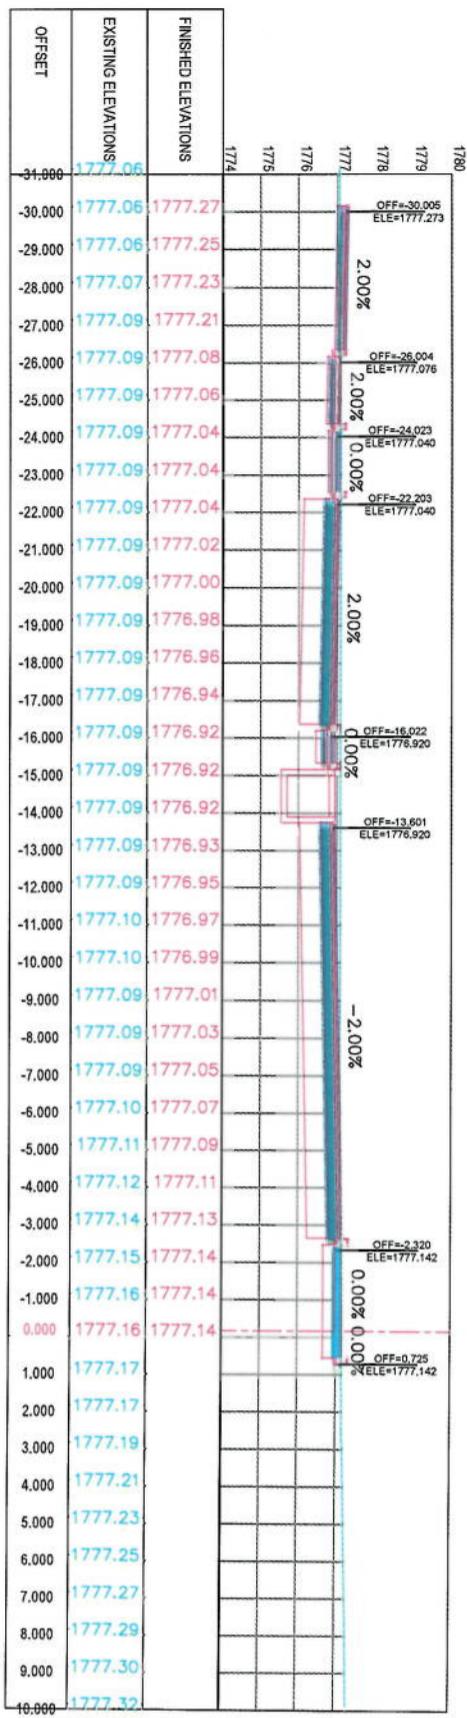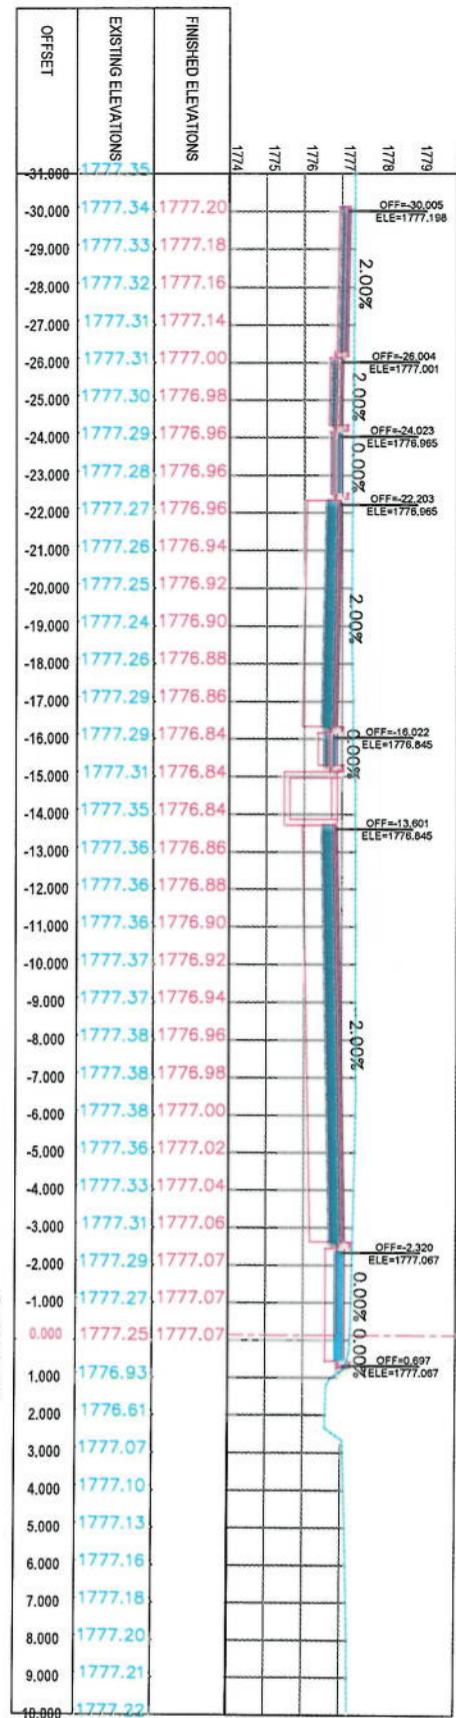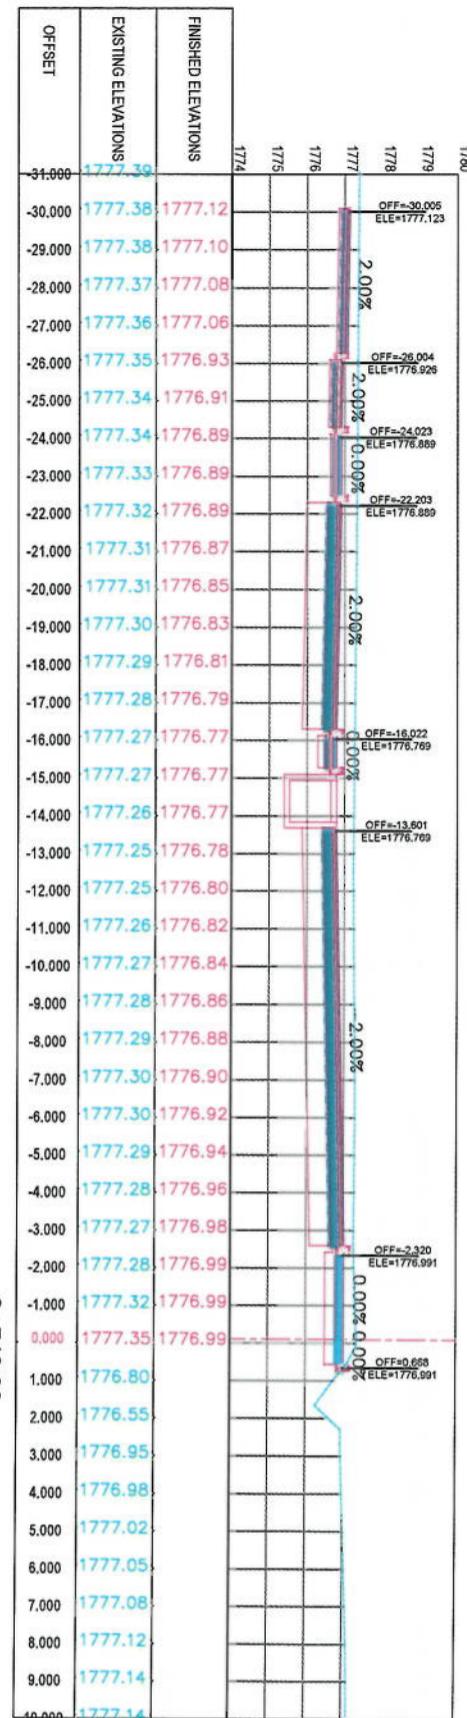

2+700.00

CROSS SECTIONS


Designed by:	Signature:
Mohammad Eisa Sint	
Drew by:	Signature:
Mohammad Eisa Sint	
Checked by:	Signature:
Habibullah Shabani	
Date: 6/7/2023	Scale: 1:200
Status: FINAL DESIGN	Project Code: CS-46
Drawing Number: 00	Revision:




LEGENDS

- CENTER-LINE
- EXISTING SURFACE
- EXISTING SIDE DITCH

NOTE:  
1. All dimensions are in meters unless otherwise indicated

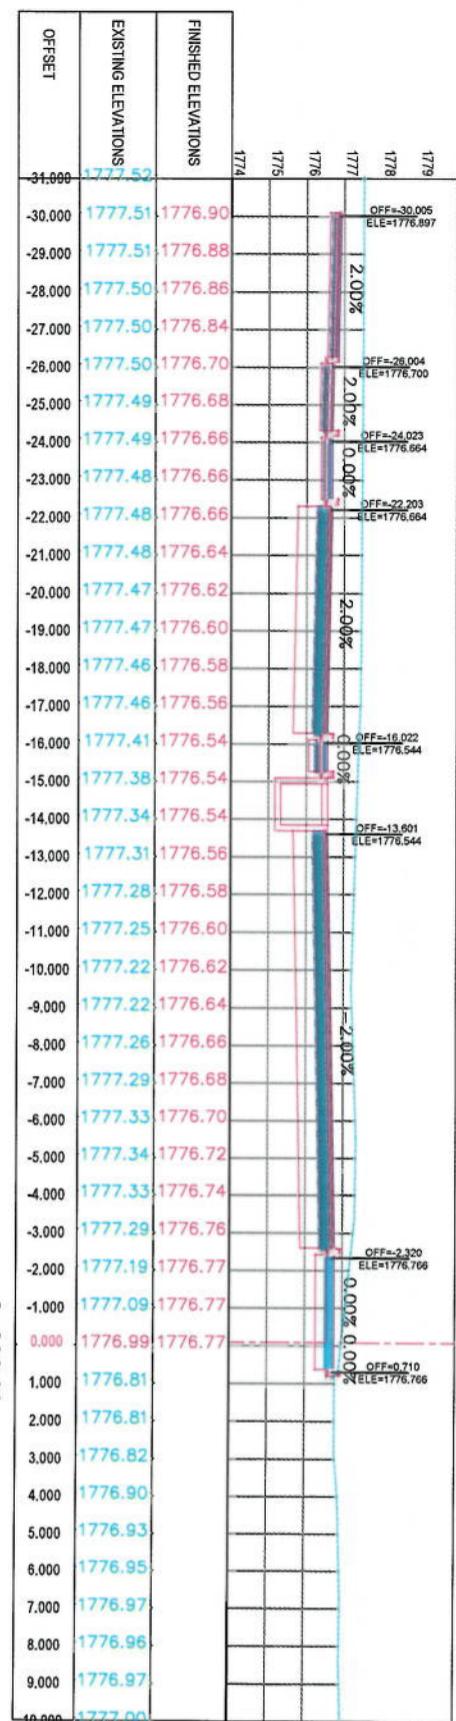

2+780.00

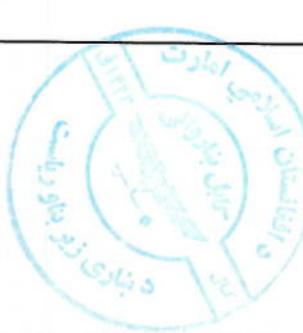


NOTE:

- All dimensions are in meters unless otherwise indicated


**LEGENDS**

- CENTER-LINE**: Dashed line
- EXISTING SURFACE**: Dashed-dotted line
- EXISTING SIDE DITCH**: Blue line

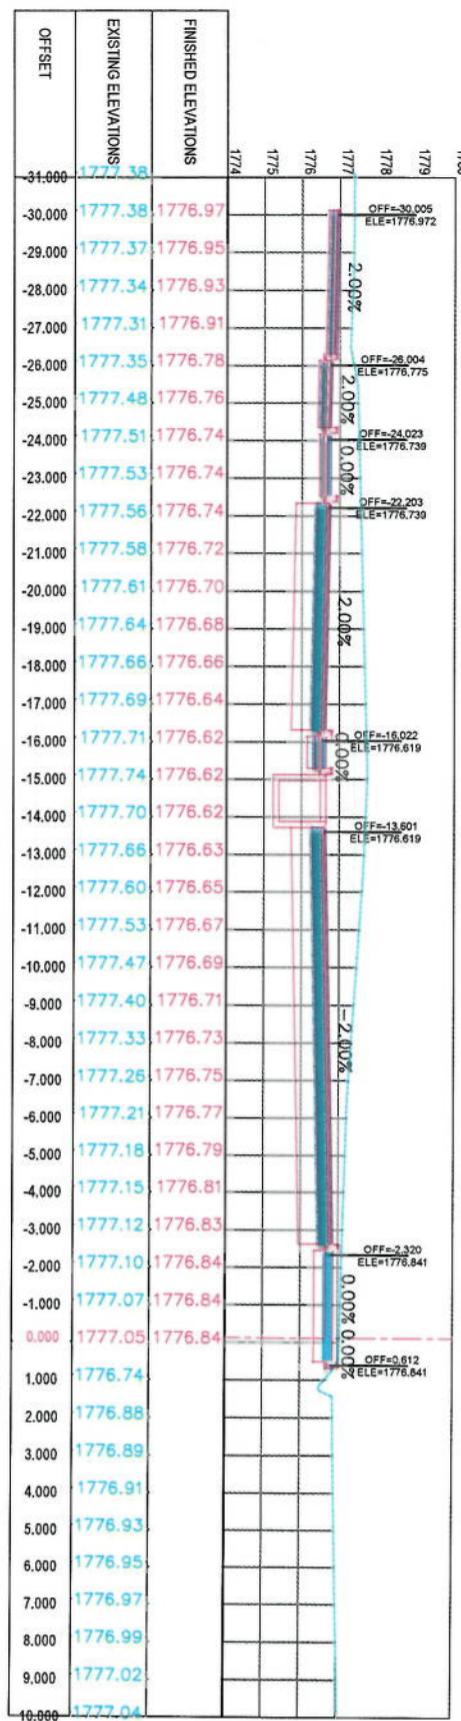

2+780.00

ISLAMIC EMIRATE OF AFGHANISTAN	
Designed by:	KABUL MUNICIPALITY
Project Name:	KABUL MUNICIPALITY
Co-Design To:	
Drawing Title:	Road project
CROSS SECTIONS	
Designed by:	Mohammad Ihsan Sint
Drawn by:	Mohammad Ihsan Sint
Checked by:	Hassanullah Statiz
Date:	6/7/2023
Scale:	1:200
Status:	FINAL DESIGN
Project Code:	CS-47
Revision:	00

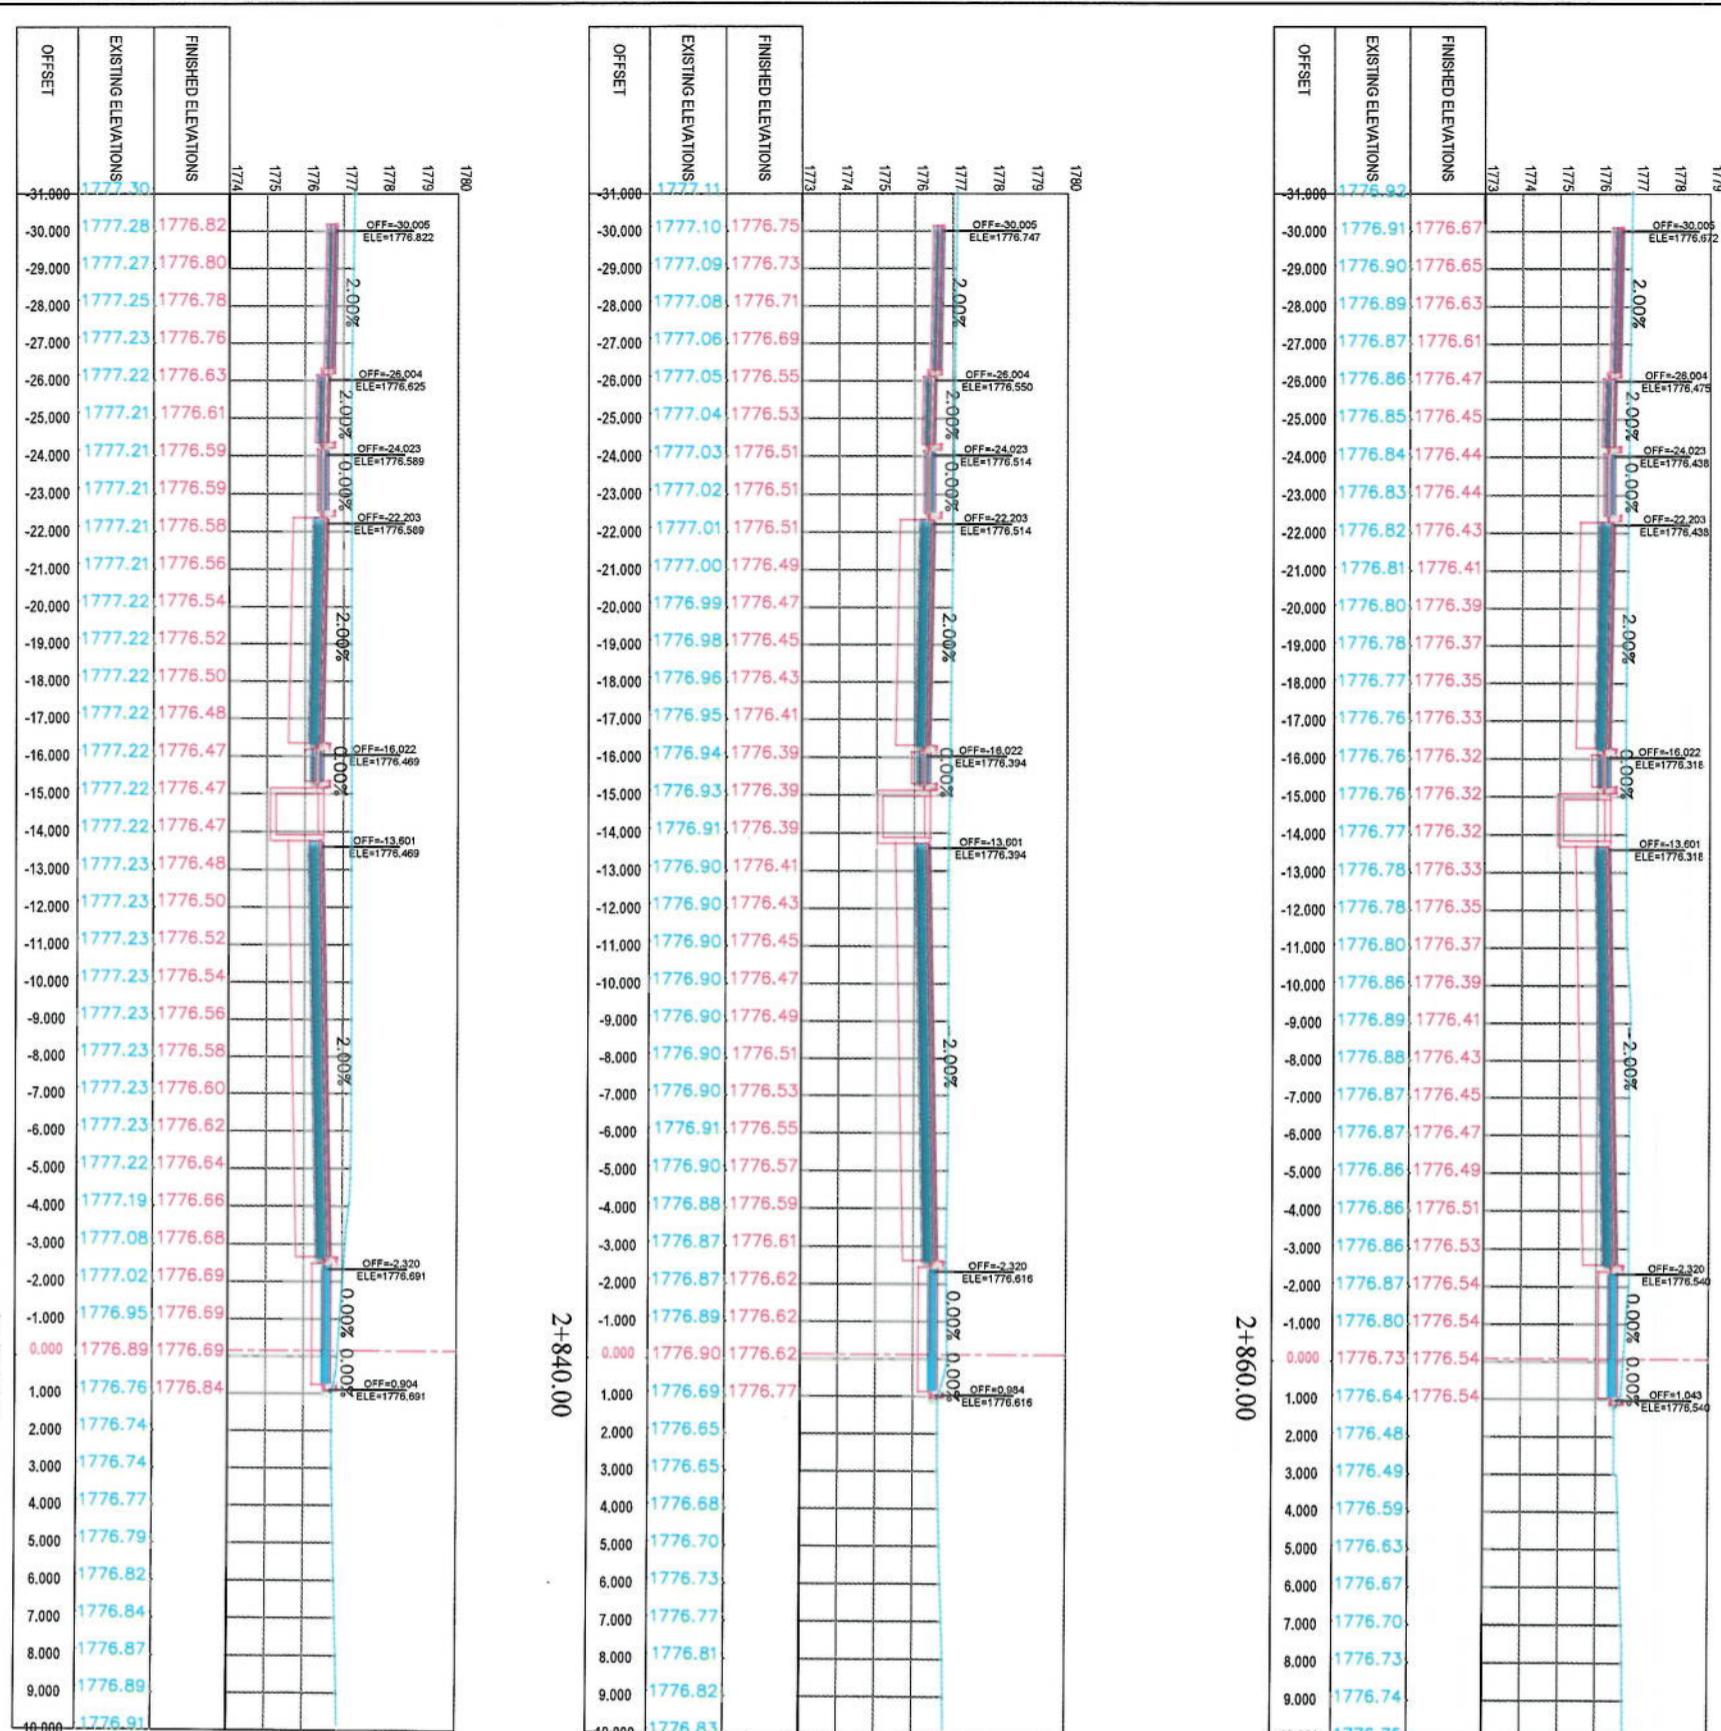



NOTE


1. All dimensions are in meters unless otherwise indicated

LEGENDS
CENTER-LINE
EXISTING SURFACE



Project Code	CS-48	Revision	00
Drawing Number			
Date	6/7/2023	Scale	1:200
Status:	FINAL DESIGN		

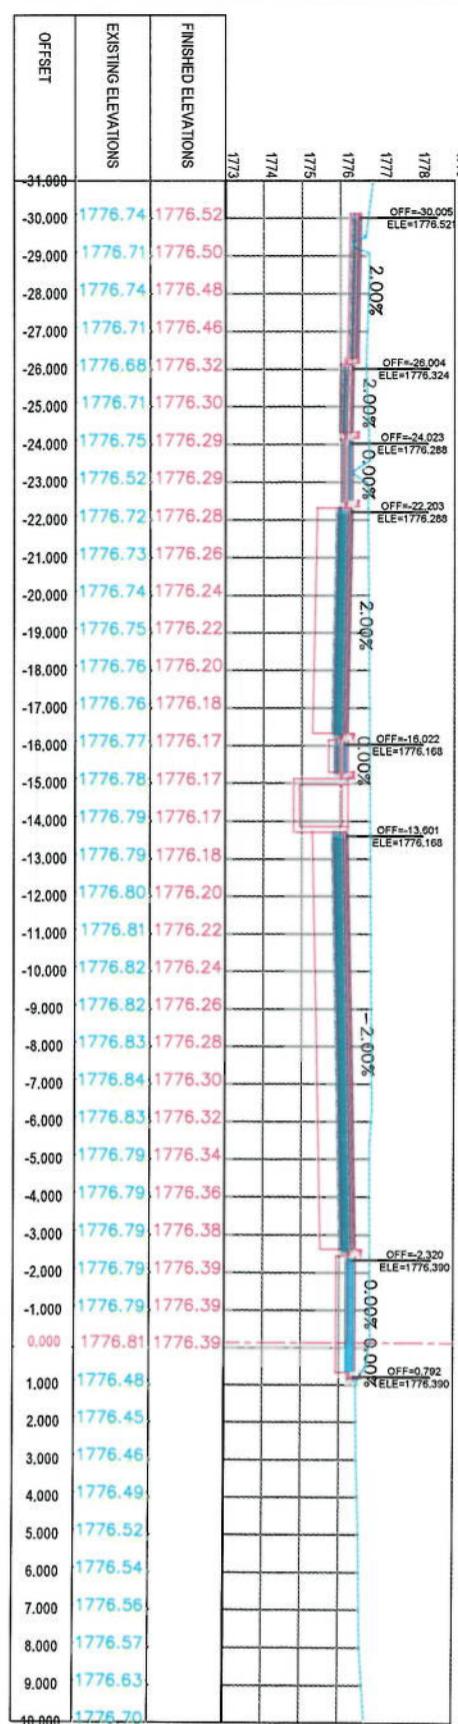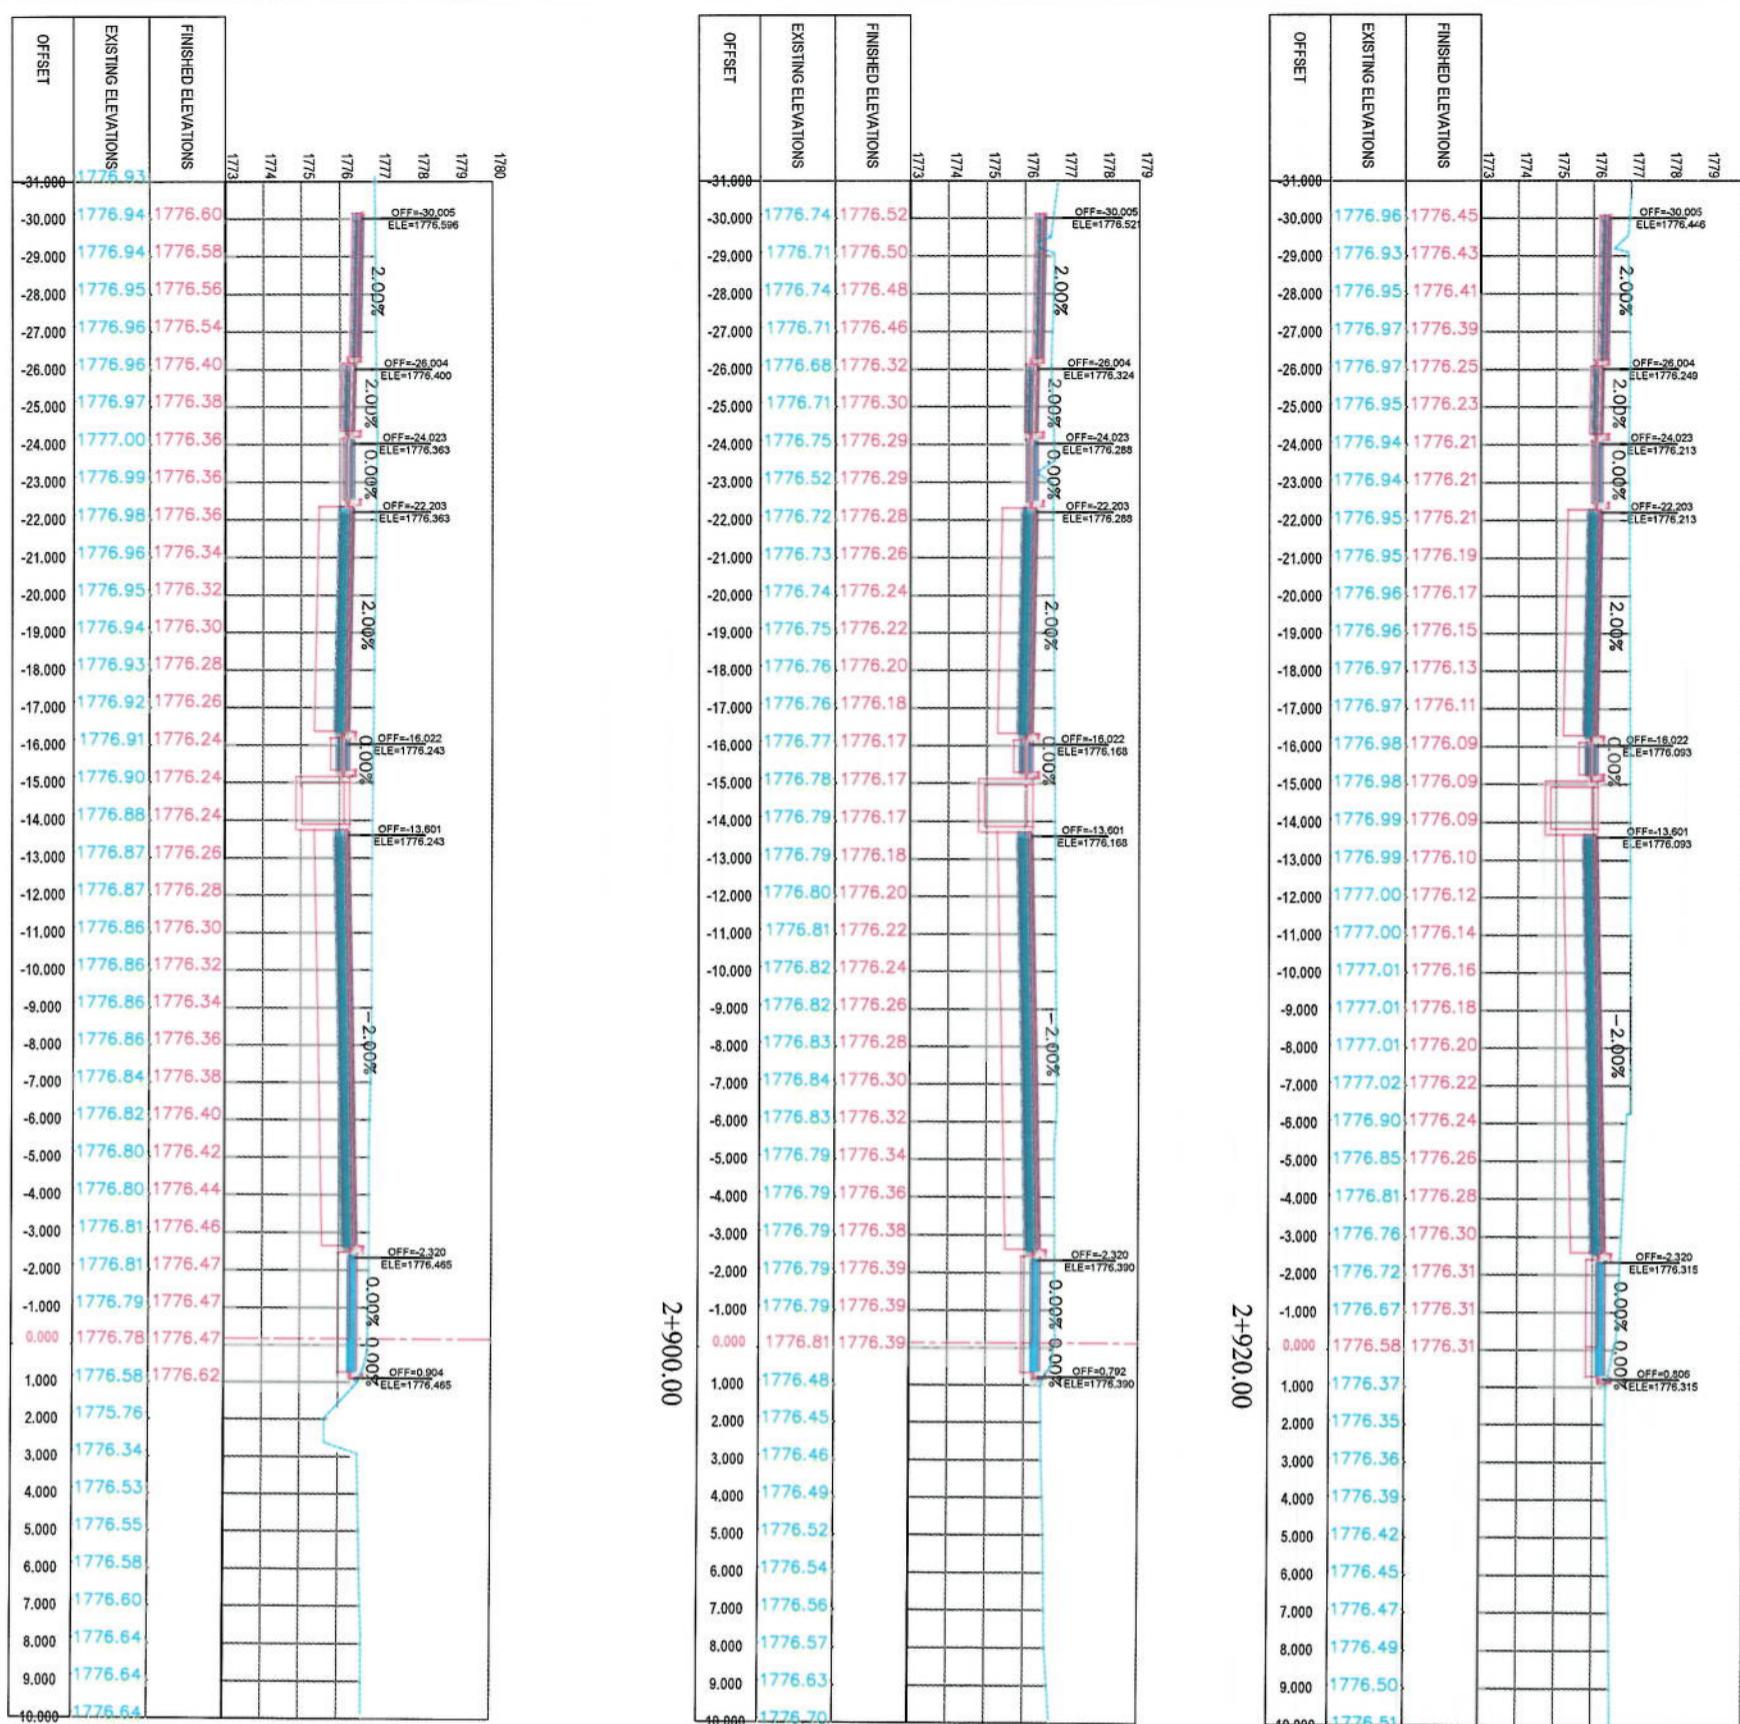

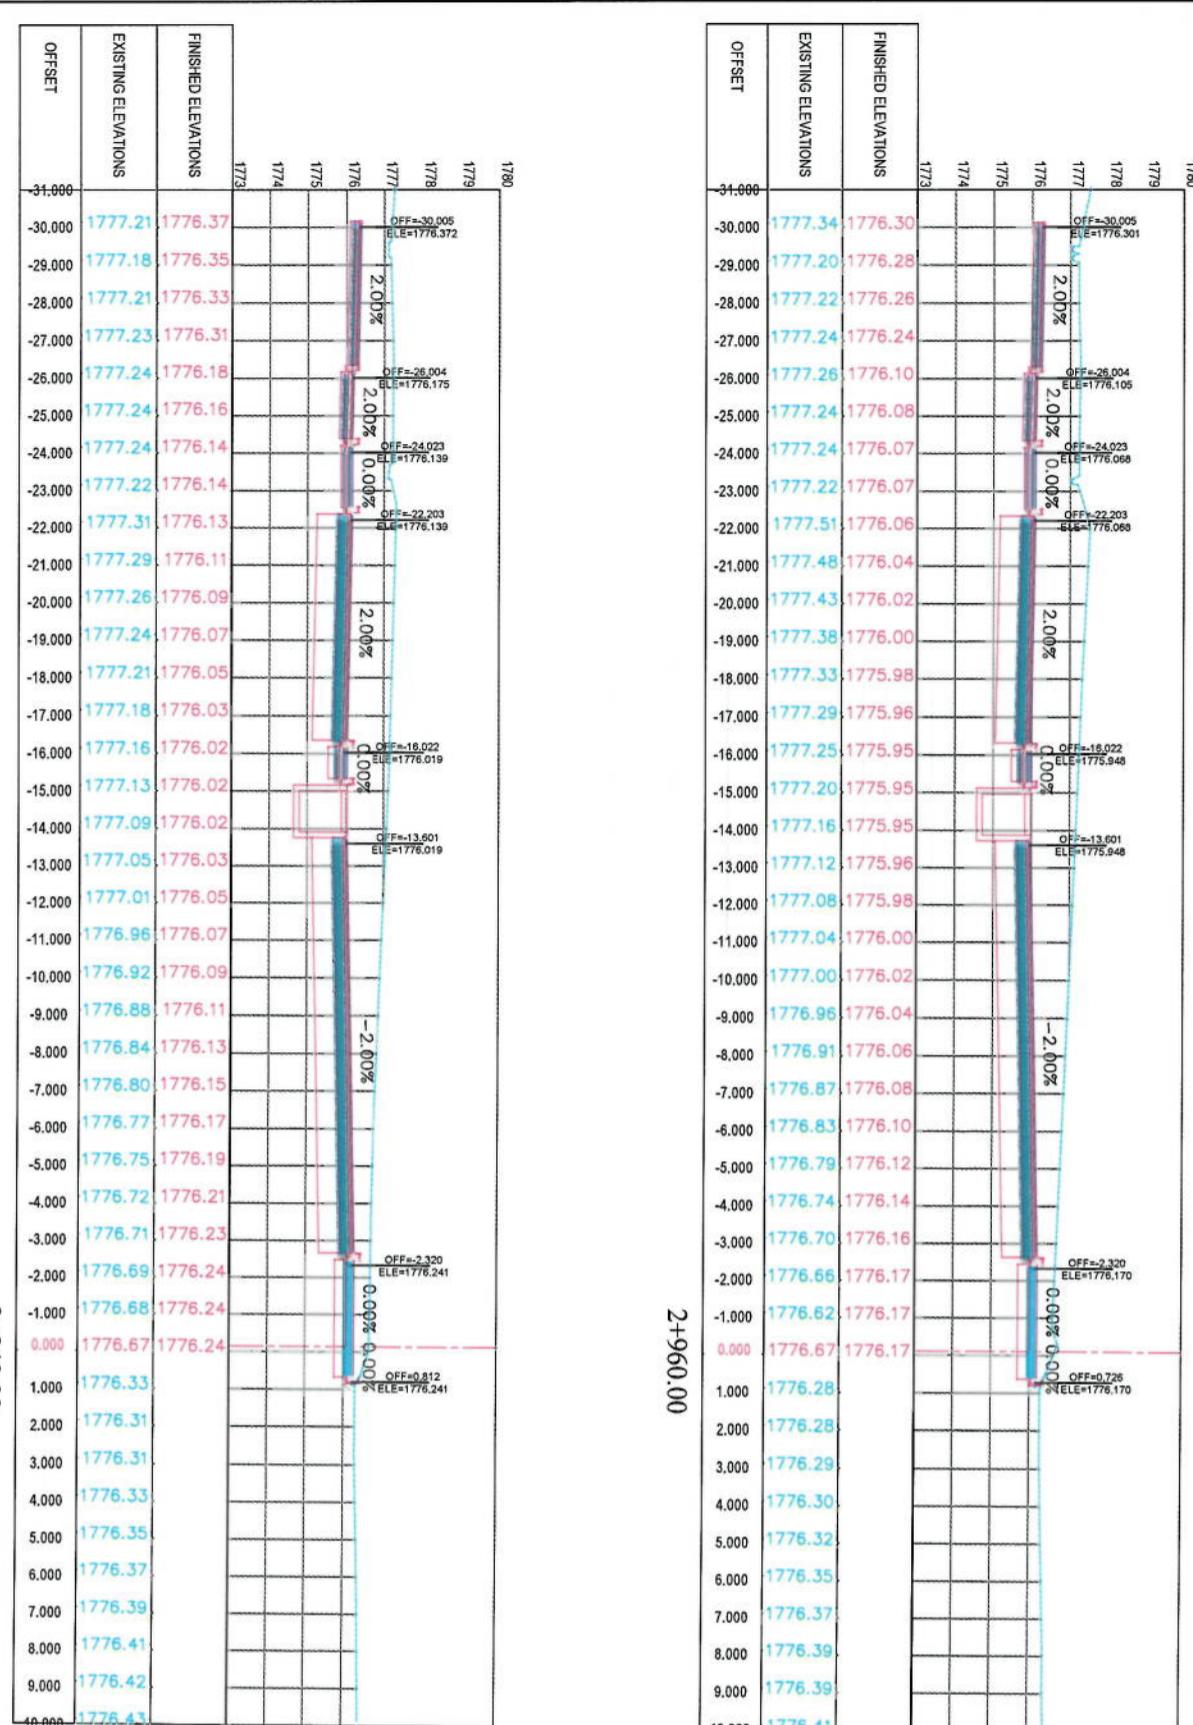

NOTE:

1. All dimensions are in meters unless otherwise indicated.

**LEGENDS**

- CENTER-LINE
- EXISTING SURFACE
- EXISTING SIDE DITCH



Client:

KABUL MUNICIPALITY

 Designed by:  
**KABUL MUNICIPALITY DESIGN TEAM**

 Project Name:  
**Cot-e-Sangi To Demazang  
Road project**

Drawing Title:



**CROSS SECTIONS**
 Designed by:  
**Mohammad Easa Sial**

 Drawn by:  
**Mohammad Ishaq Sial**

 Checked by:  
**Hastullah Sialzi**

Date: 6/7/2023      Scale: 1:200

 Status: **FINAL DESIGN**  
 Project Code: CS-50      Revision: 00

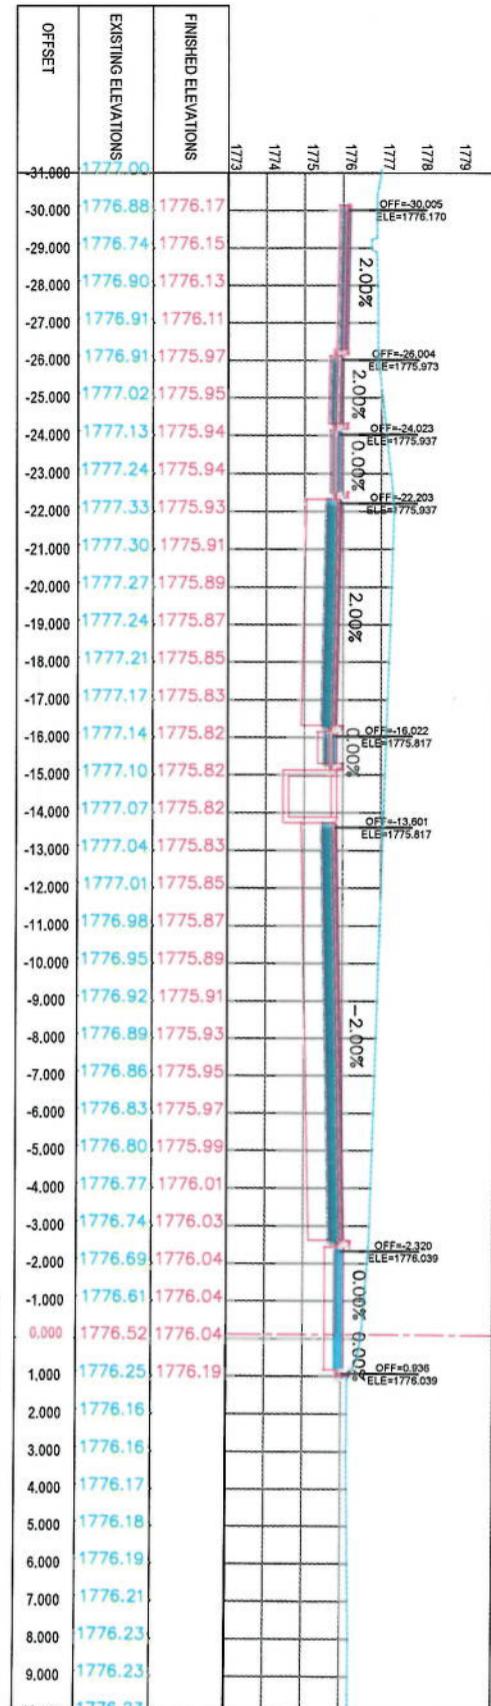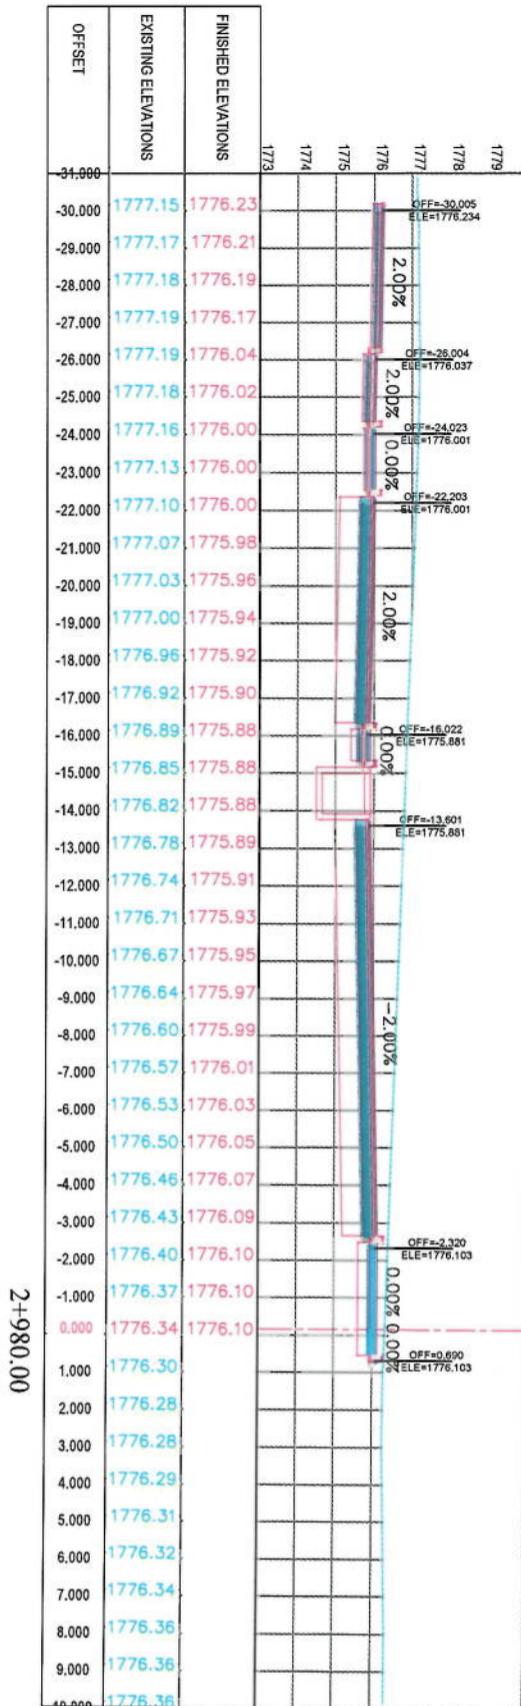


NOTE:

- All dimensions are in meters unless otherwise indicated


LEGENDS  
— CENTER-LINE  
— EXISTING SURFACE  
— EXISTING SIDE DITCH




Project Code		
Drawing Number	Date	Scale
CS-51	6/7/2023	1:200
Status:		FINAL DESIGN

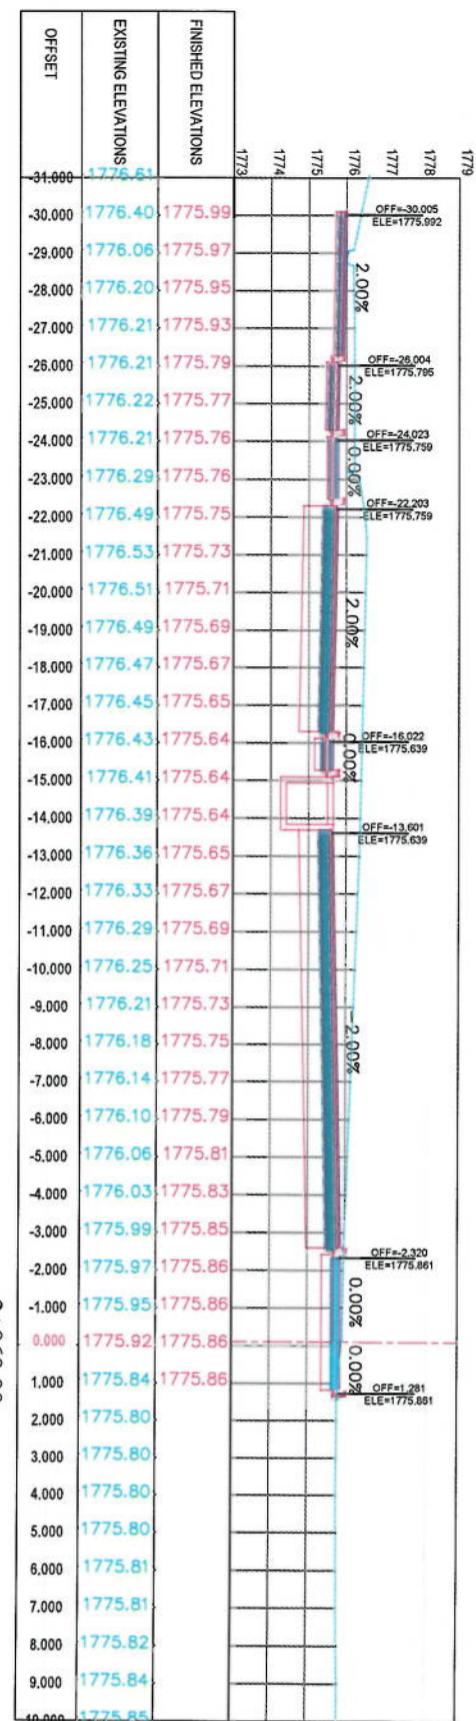

3+060.00

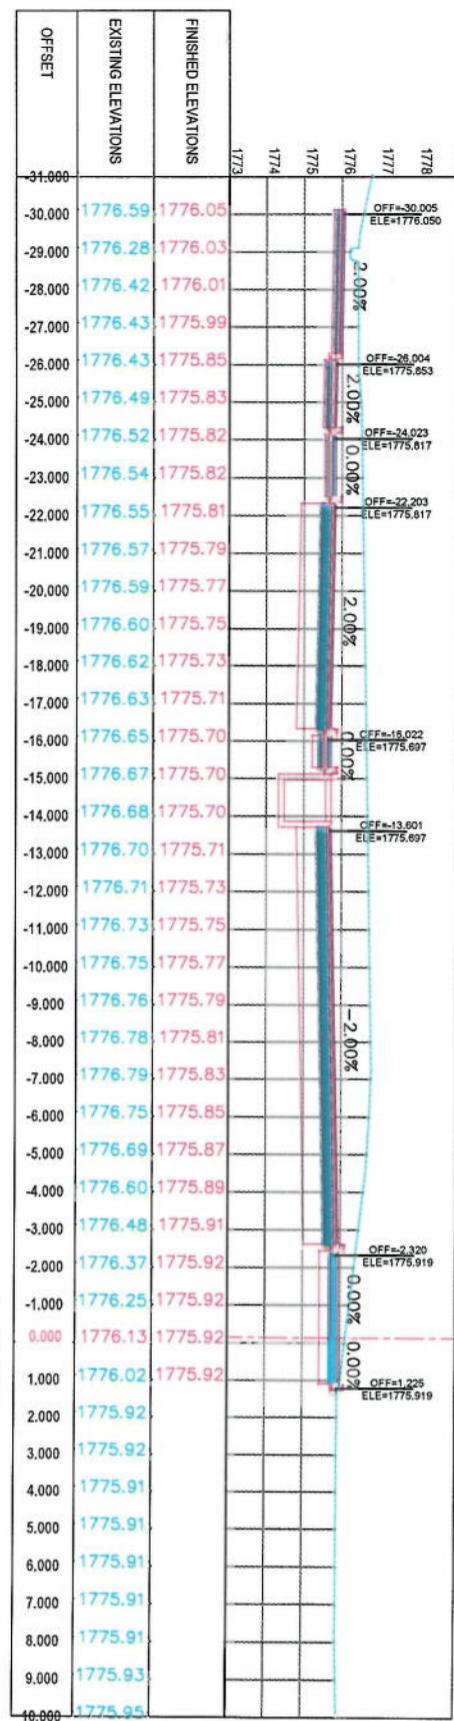

3+040.00

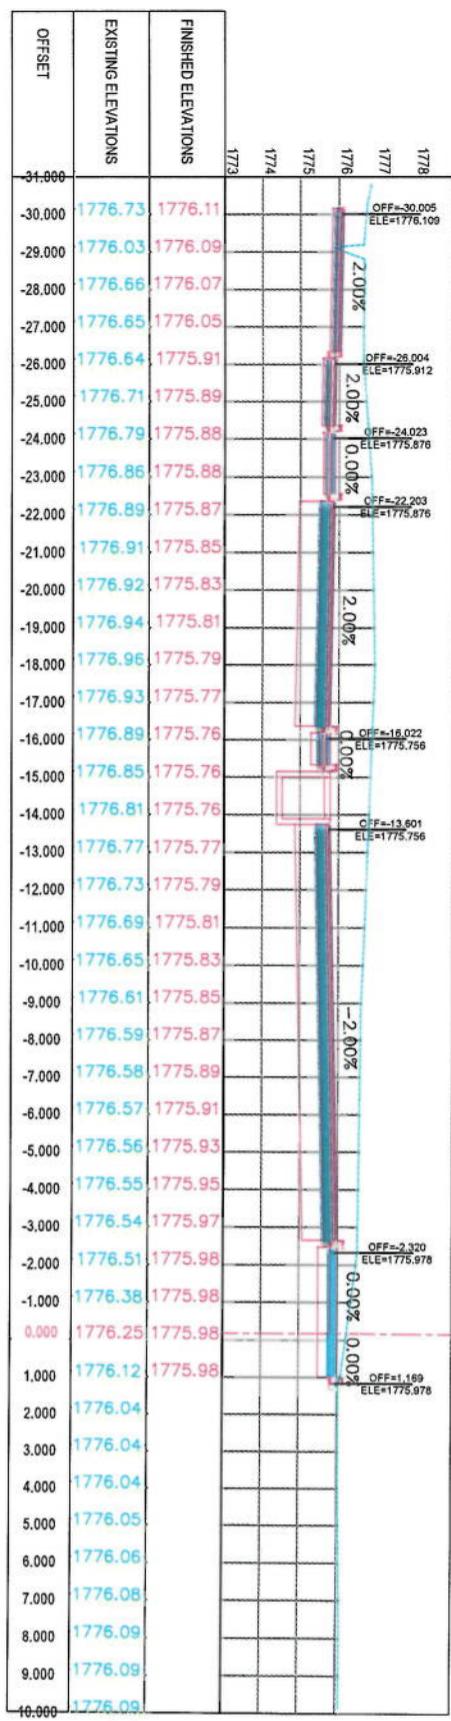**CROSS SECTIONS**

Designed by:  
Mohammad Esa Sint  
Drawn by:  
Mohammad Esa Sint  
Checked by:  
Hasanullah Shahzai

KABUL MUNICIPALITY  
DESIGN TEAM  
Client:  
ISLAMIC EMIRATE OF  
AFGHANISTAN

Drawing Title:






LEGENDS

- CENTER-LINE
- - - EXISTING SURFACE
- EXISTING SIDE DITCH

NOTE:  
1. All dimensions are in meters unless otherwise indicated.


Project Name:	Co-e-Sang To Benazang
Road Project	
Designed by:	
Mohammad Esa Sint	
Date: 6/7/2023	Scale: 1:300
Status: FINAL DESIGN	
Project Code: CS-52	Revision: 00

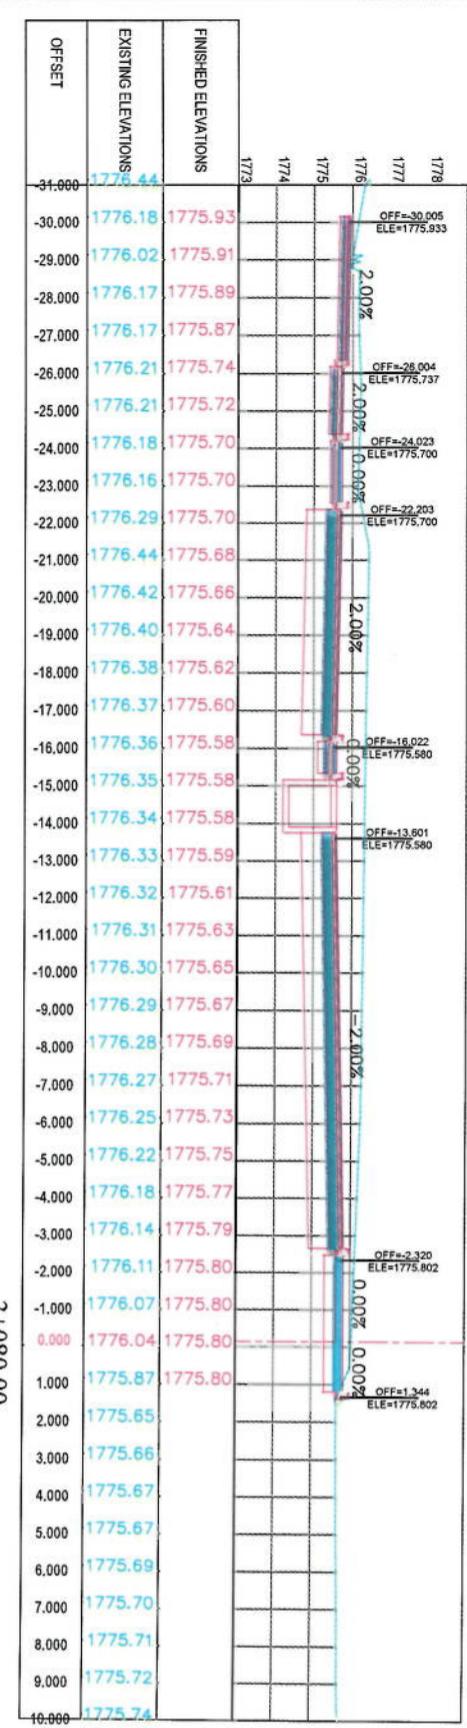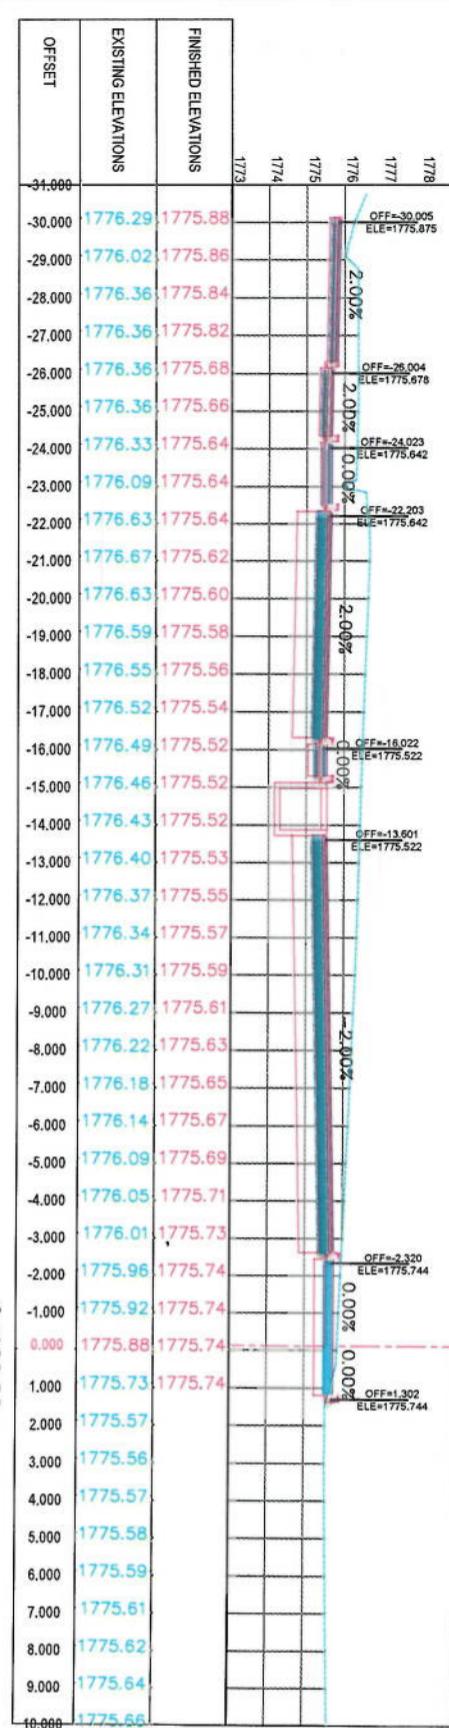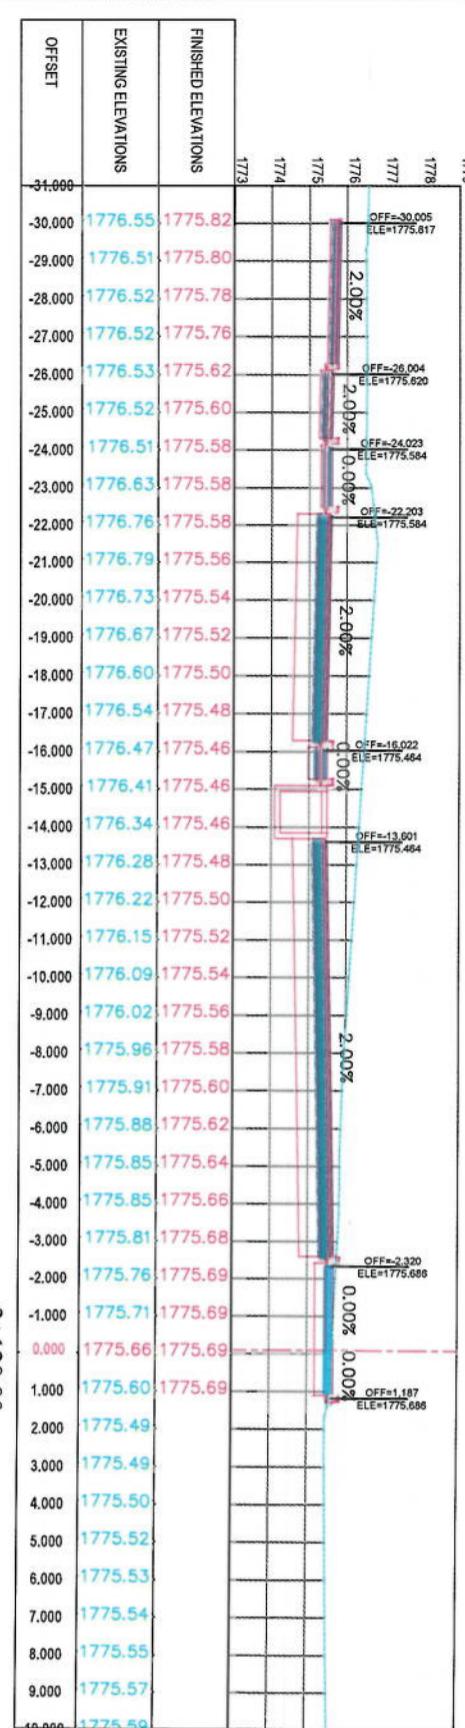

LEGENDS  
 CENTER-LINE  
 EXISTING SURFACE  
 EXISTING SIDE DITCH

NOTE:  
1. All dimensions are in meters unless otherwise indicated

Designed by:	Signature:
Drafter by:	Signature:
Checked by:	Signature:
Drawn by:	Signature:
Project Name:	KABUL MUNICIPALITY DESIGN TEAM
Cert-Sign To Demarcate	Road project
Drawing Title:	CROSS SECTIONS
Designed by:	Signature:
Date:	6/7/2023
Scale:	1:200
Status:	FINAL DESIGN
Project Code:	
Drawing Number:	CS-53
Revision:	00

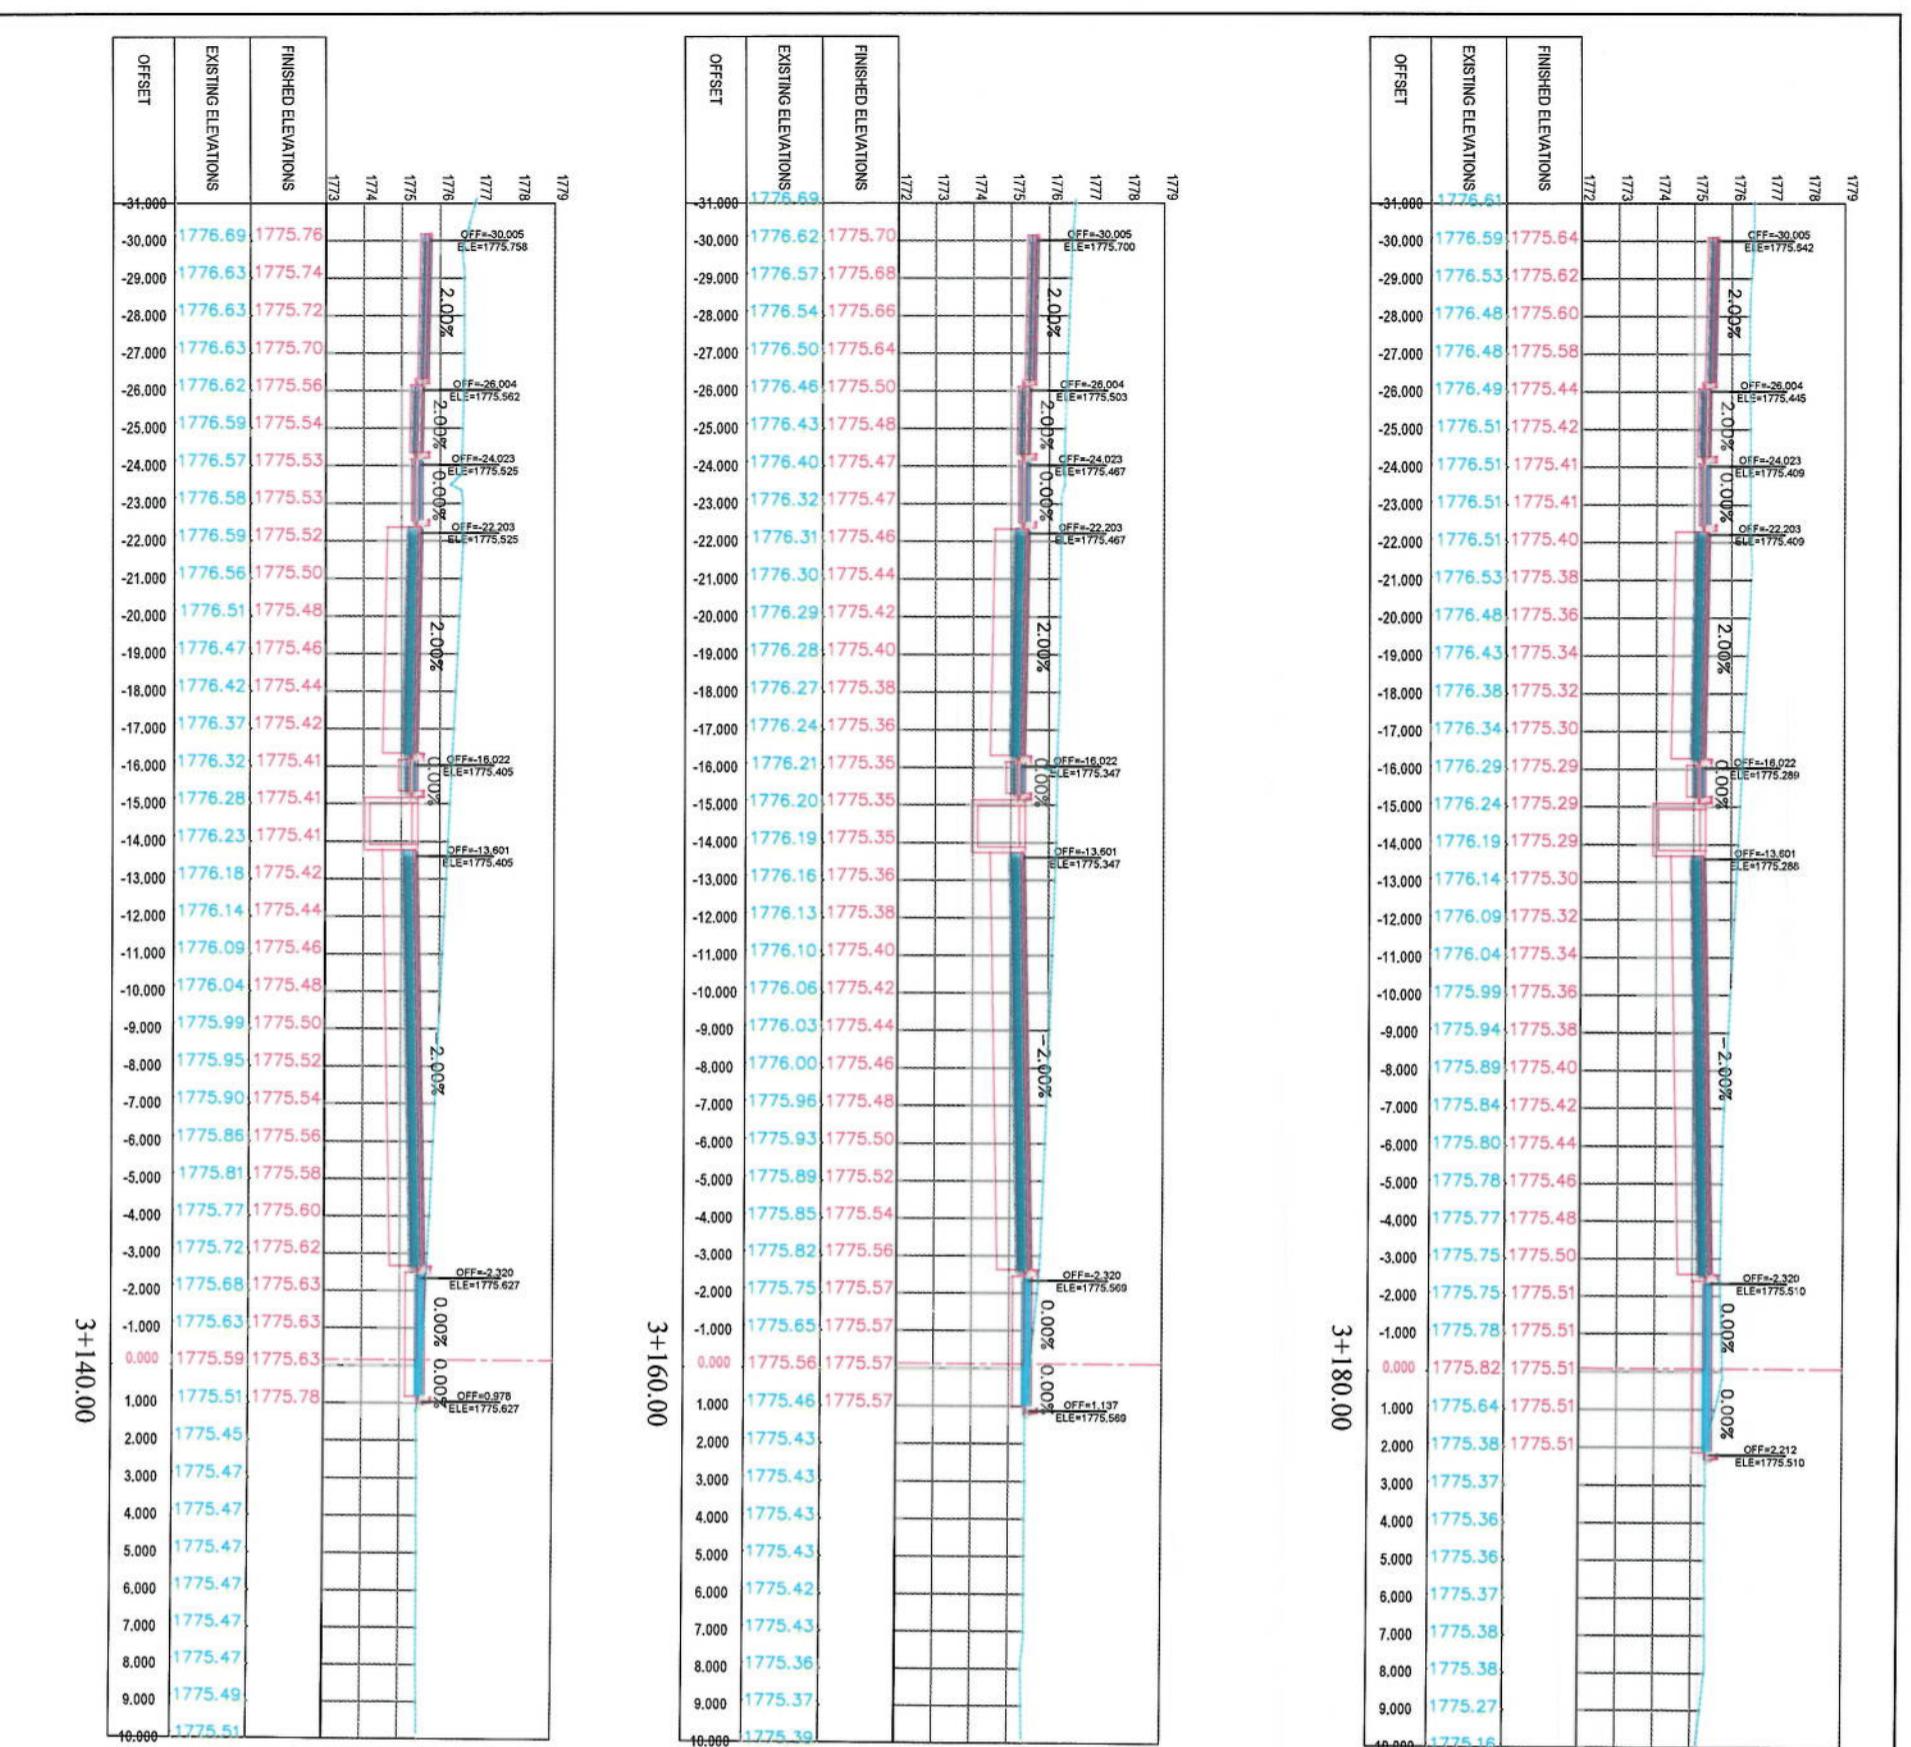

NOTE:

1. All dimensions are in meters unless otherwise indicated

LEGENDS

CENTER-LINE


EXISTING SURFACE

EXISTING SIDE-DITCH

3+140.00

3+180.00

Project Name:	KABUL MUNICIPALITY DESIGN TEAM	
Designed by:	Kabul Municipality	
Drawn by:	Mohammad Eesa Sait	
Checked by:	Hamidullah Shahzai	
Drawing Title:	CROSS SECTIONS	
Designed by:	Mohammad Eesa Sait	
Drawn by:	Mohammad Eesa Sait	
Checked by:	Hamidullah Shahzai	
Date:	6/7/2023	
Scale:	1:200	
Status:	FINAL DESIGN	
Project Code:	CS-54	
Drawing Number:	Revision 00	

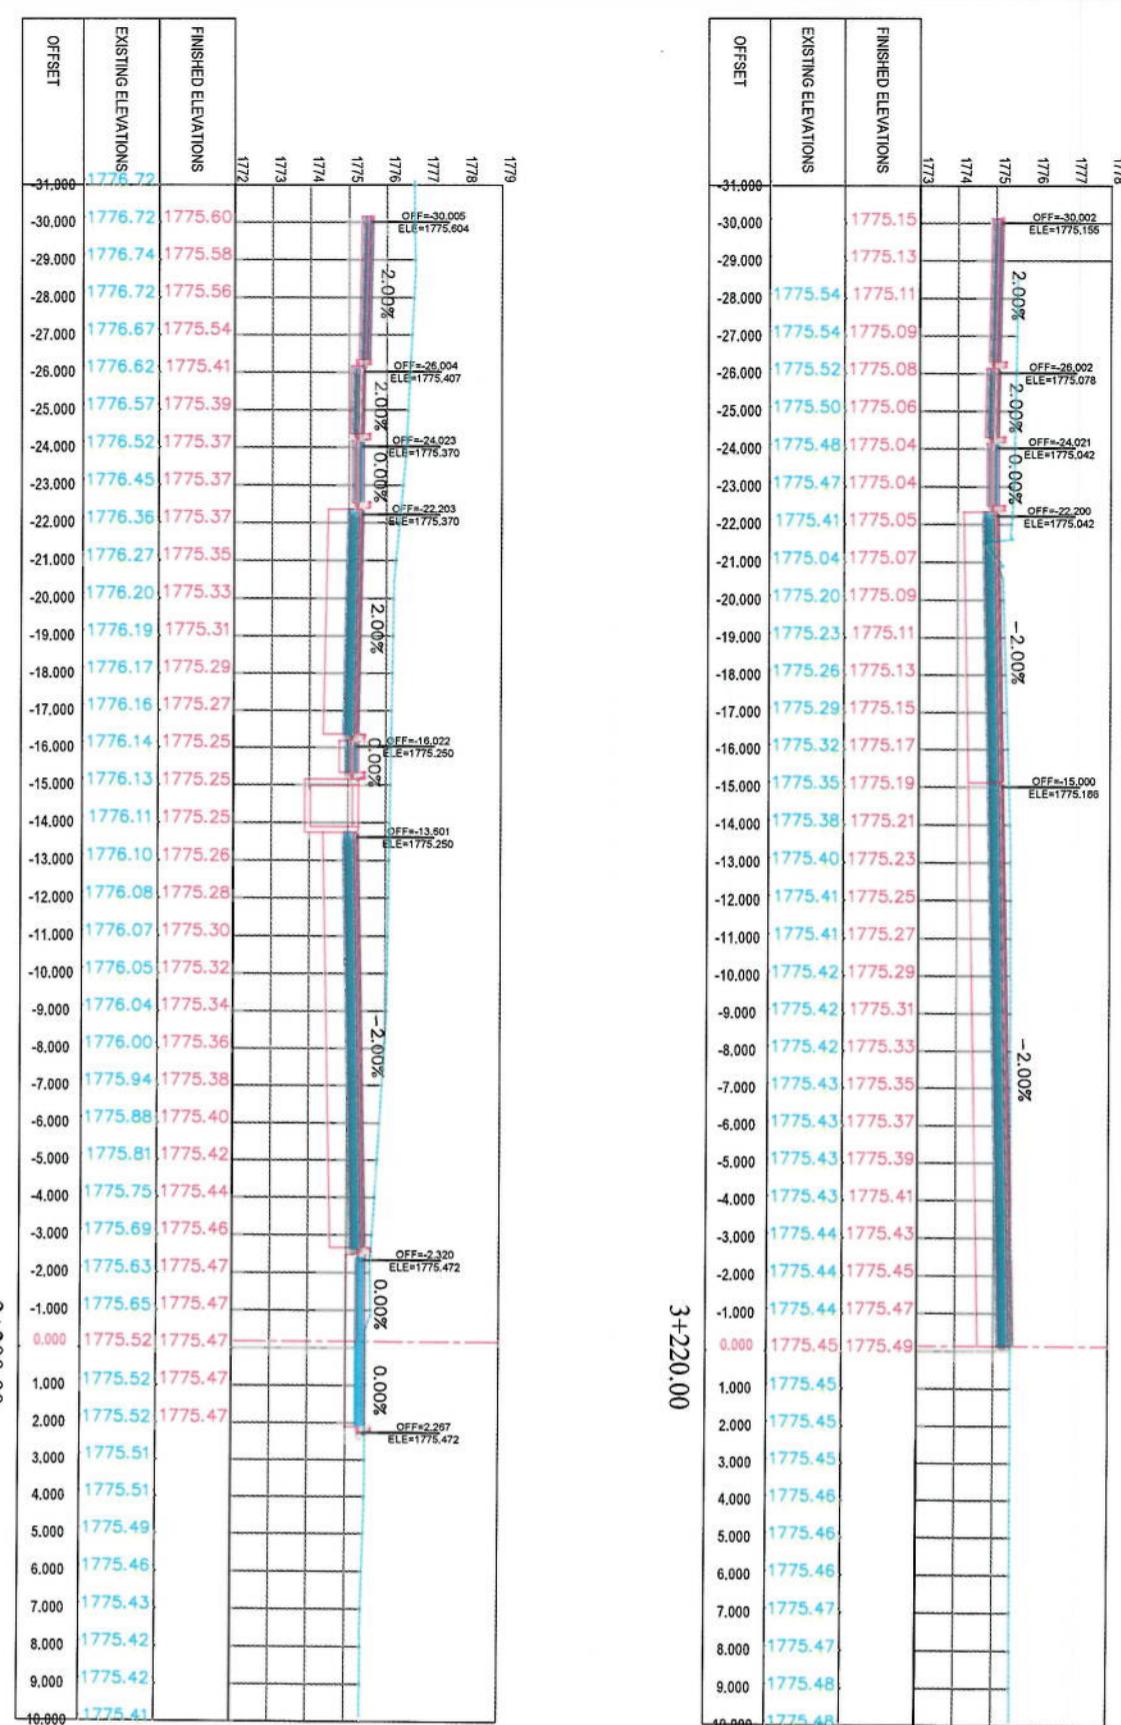

NOT

**1.** All dimensions are in meters unless otherwise indicated


LEGEND

— CENTER-LINE  
- - - EXISTING SURFACE



Drawing Number		CS-55	Revision	00
Status:				
Project Code:				
Date:	6/7/2023	Scale:	1:200	
Drawing Title				
CROSS SECTIONS				
Designed by:	Signature: Mohammad Hessam Sint			
Drawn by:	Signature: Mohammad Hessam Sint			
Checked by:	Signature: Hashemullah Shokouhi			
Project Name: Core-Sangai To Demazang Road project				
Drawing Title				
ISLAMIC EMIRATE OF AFGHANISTAN				
KABUL MUNICIPALITY				
Designed by: KABUL MUNICIPALITY DESIGN TEAM				
Project Name: Core-Sangai To Demazang Road project				
Drawing Title				
CROSS SECTIONS				
Designed by:	Signature: Mohammad Hessam Sint			
Drawn by:	Signature: Mohammad Hessam Sint			
Checked by:	Signature: Hashemullah Shokouhi			
Date:	6/7/2023	Scale:	1:200	
Status:				
Project Code:				
Drawing Number	CS-55	Revision	00	



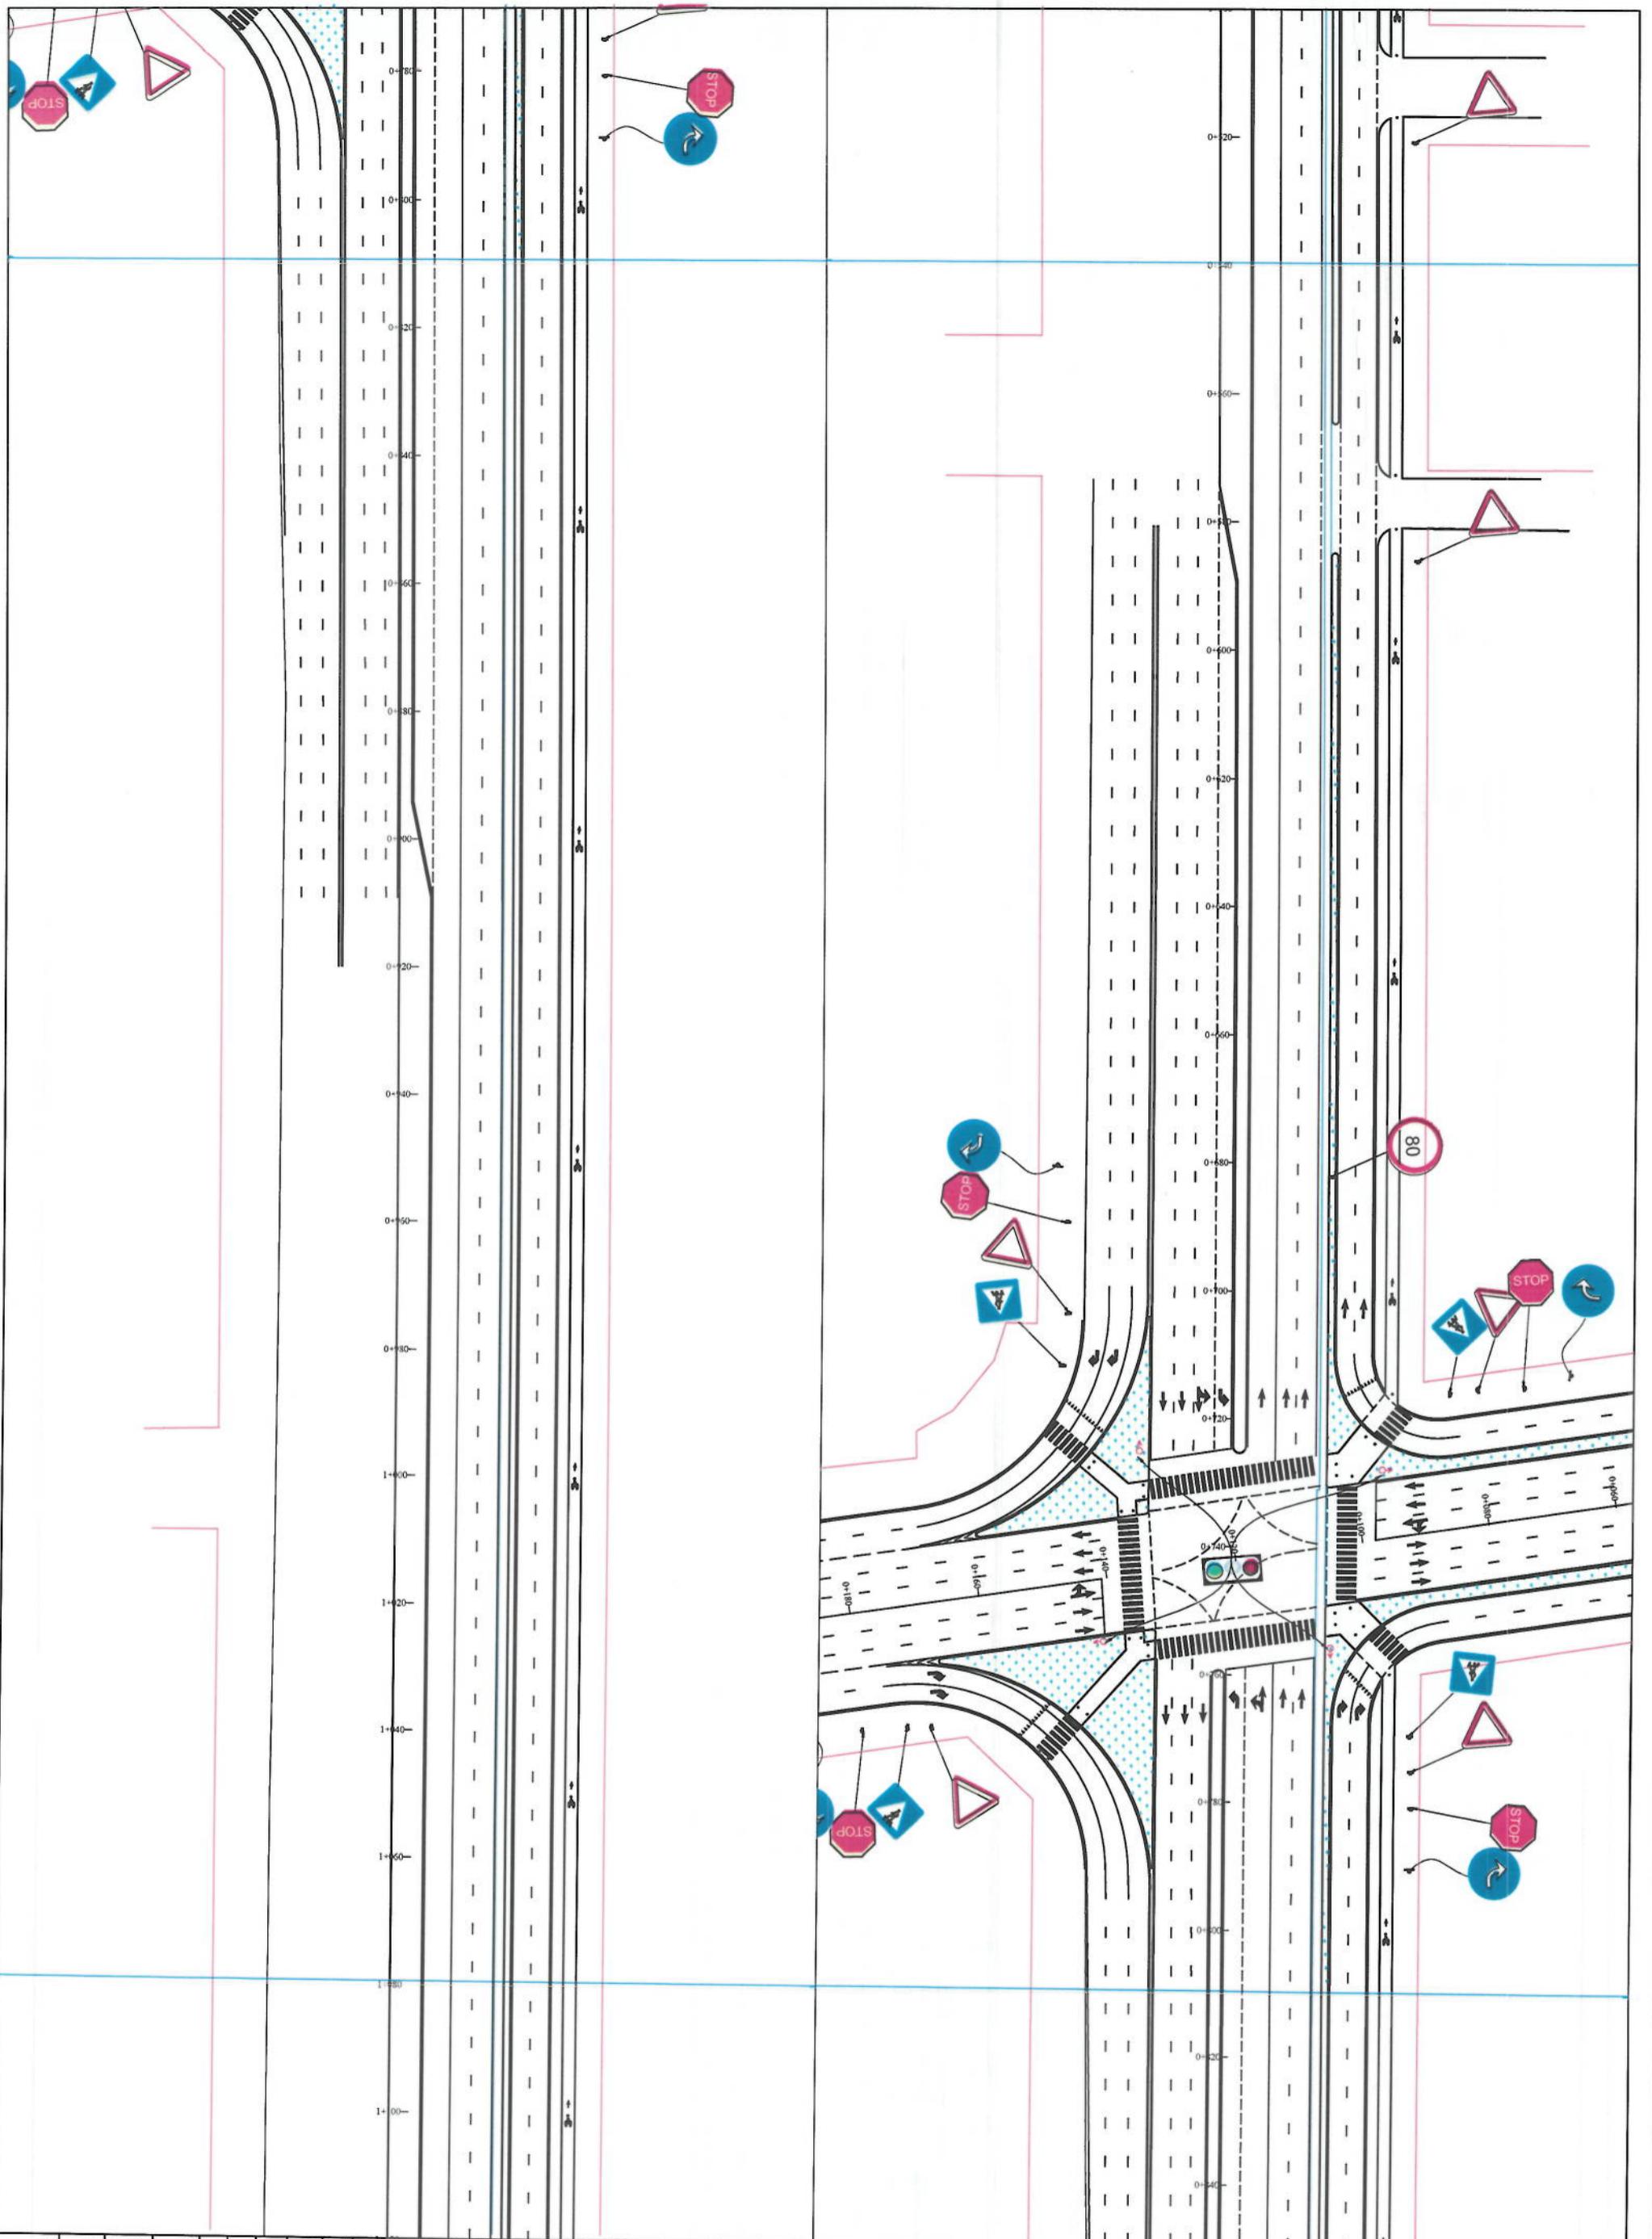

ROAD MARKING	
Designed by:	KABUL MUNICIPALITY DESIGN TEAM
Drawn by:	Mohammed Esa Sint
Checked by:	Hassanullah Shauzai
Date:	6/8/2023
Project Code:	FINAL DESIGN
Drawing Number	Rm-2
Revision	00



NOTE:  
1. All dimensions are in meters unless otherwise indicated

LEGENDS	
	CENTER-LINE
	EXISTING SURFACE
	EXISTING SIDE DITCH



Date	Revision Details	Drawn

ISLAMIC EMIRATE OF  
AFGHANISTAN



Designed by:  
KABUL MUNICIPALITY  
DESIGN TEAM

Project Name:  
Coco-Sand To Dalmazang  
Road Project

Drawing Title:

### ROAD MARKING

Designed by:  
Mohammad Esa Sial

Signature:

Drawn by:  
Mohammad Esa Sial

Signature:

Checked by:  
Hasbullah Shauzi

Signature:

Date: 6/8/2023  
Scale: 1:1000  
Status: FINAL DESIGN

Project Code: PPP-3  
Drawing Number: 00  
Revision:

NOTE:

1. All dimensions are in meters unless otherwise indicated.

LEGENDS

— CENTER-LINE

- - - EXISTING SURFACE

— EXISTING SIDE DITCH



Date	Revision Details	Drawn By

ISLAMIC EMIRATE OF  
AFGHANISTAN

Client:



Designed by:  
KABUL MUNICIPALITY  
DESIGN TEAM

Project Name:  
Cite-e-Sangi To Delmangal

Road Project

Drawing Title:

ROAD MARKING

Designed by:  
Mohammad Eesa Sirl

Signature:

Drawn by:  
Mohammad Eesa Sirl

Signature:

Checked by:  
Hasibullah Shairzai

Signature:

Date: 6/8/2023  
Status: FINAL DESIGN  
Project Code:

Drawing Number: PP-4  
Revision: 00

NOTE:

1. All dimensions are in meters unless otherwise indicated.

LEGENDS

CENTER-LINE

EXISTING SURFACE

EXISTING SIDE DITCH



ISLAMIC EMIRATE OF  
AFGHANISTAN



Designed by:  
KABUL MUNICIPALITY  
DESIGN TEAM

Project Name:  
Cote-Sangji To Dohmangan  
Road Project

Drawing Title:

ROAD MARKING

Designed by:

Mohammad Esa Sifat

Signature:

Drawn by:

Mohammad Esa Sifat

Signature:

Checked by:

Habibullah Shauzai

Signature:

Date: 6/8/2023  
Scale: 1:1000  
Status: FINAL DESIGN

Project Code:

Drawing Number:

PP-5

Revision: 00

NOTE:

1. All dimensions are in meters unless otherwise indicated

LEGENDS	
	CENTER-LINE
	EXISTING SURFACE
	EXISTING SIDE DITCH



ROAD MARKING

Designed by:	Signature:
Mohammad Esa Sifat	
Drawn by:	Signature:
Mohammad Esa Sifat	
Checked by:	Signature:
Habibullah Stanizi	
Date:	Date:
6/8/2023	6/8/2023
Scale:	Scale:
1:1000	1:1000
Status:	
FINAL DESIGN	
Project Code:	
Drawing Number:	PP-6
Revision:	00



نوت: ۱- ابعاد میزانهای متر است. ۲- مکان اشاره دهنده مسیر را باید توسط متخصص تغییرات در محدوده مسیر خود مشخص کرد. جهت تابل این محدوده مسیر ممکن باشند.

چهل راه از رو دارد




NOTE:

1. All dimensions are in metric unless otherwise indicated
2. Signal Location must be determined by Traffic Specialist

LEGENDS

- CENTER-LINE
- EXISTING SURFACE
- EXISTING SIDE DITCH

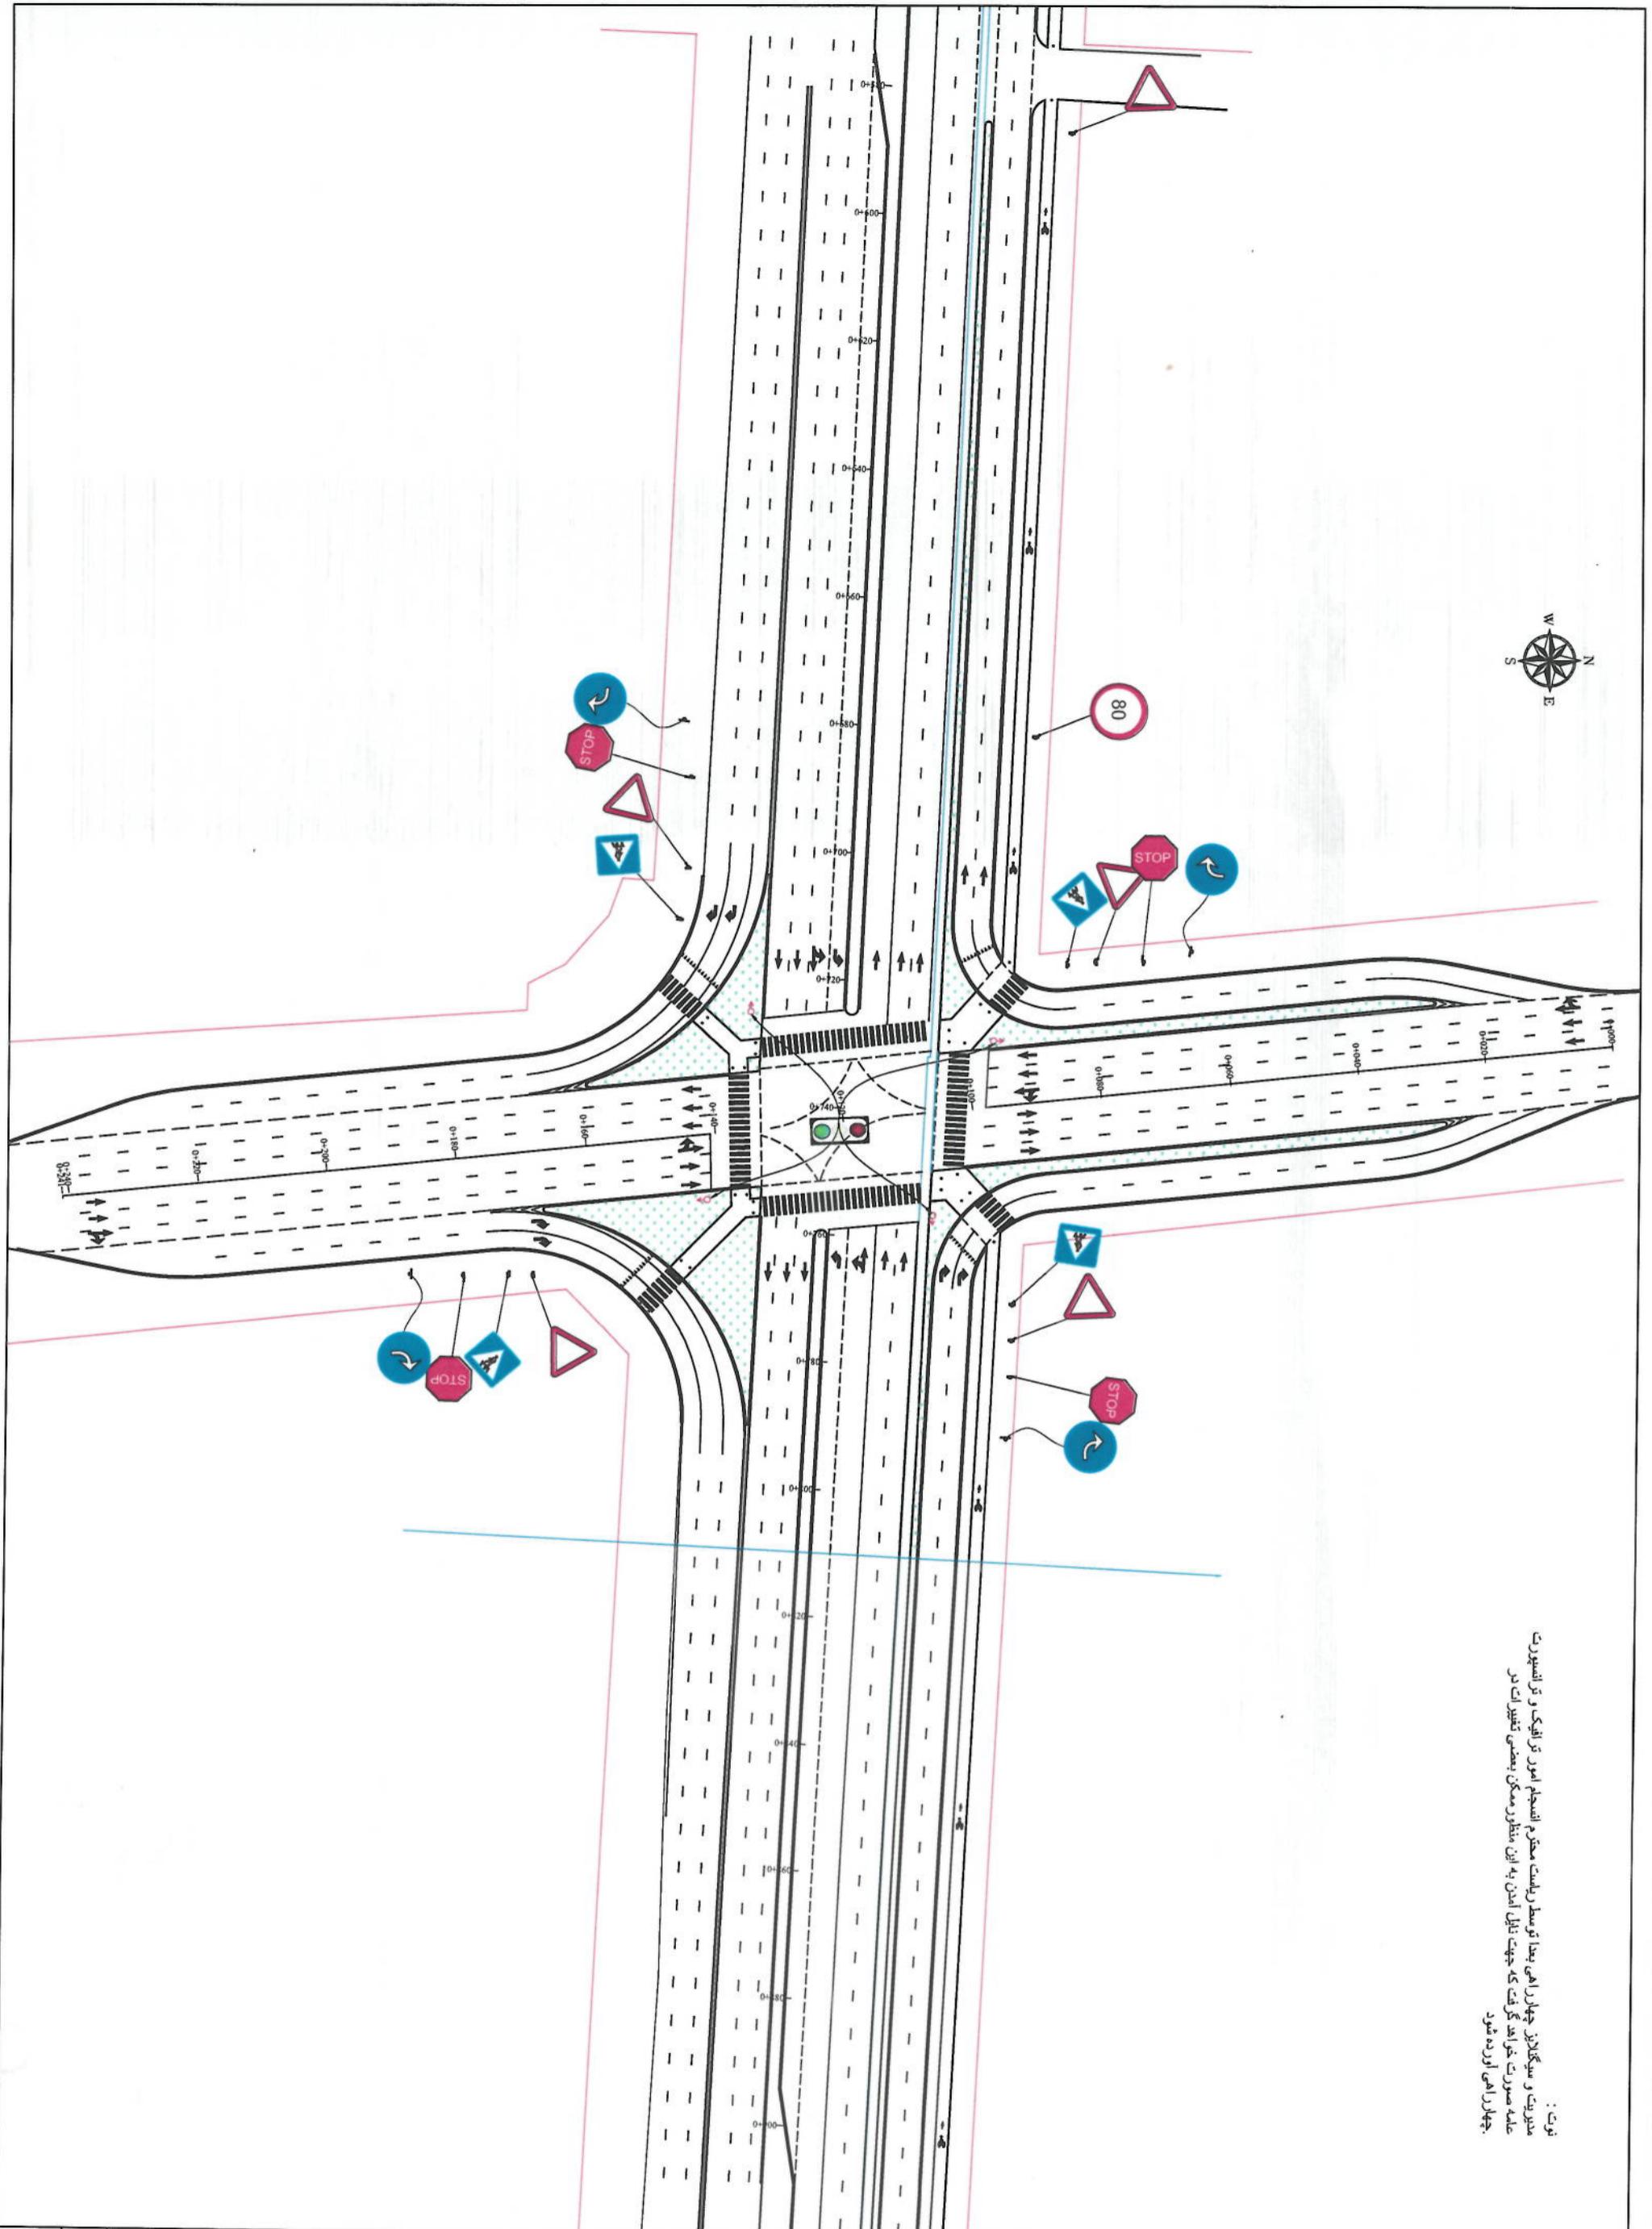

#### ROAD MARKING

Designed by:	Mohammed Esa Sharif	Signature:
Drawn By:	Mohammed Esa Sharif	Signature:
Checked by:	Rasibullah Shahzai	Signature:
Date:	6/7/2023	Scale:
Status:	FINAL DESIGN	

Project Code:	
Drawing Number:	RM-7

Revision  
00



## NOTE:


1. All dimensions are in meters unless otherwise indicated.

LEGENDS	
	CENTER-LINE
	EXISTING SURFACE
	EXISTING SIDE DITCH




Smooth & curved  
concrete finishing

Fastener bar  
Dia 4=mm  
Length300=mm

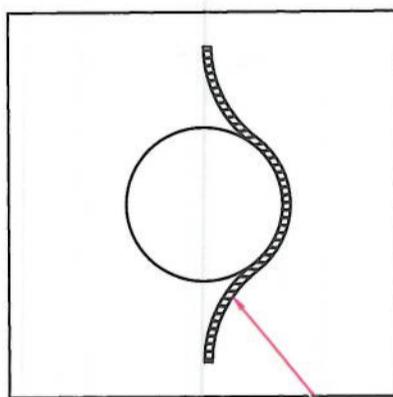


Steel Pipe(A)36  
Dia 6=inch  
Thickness3=mm

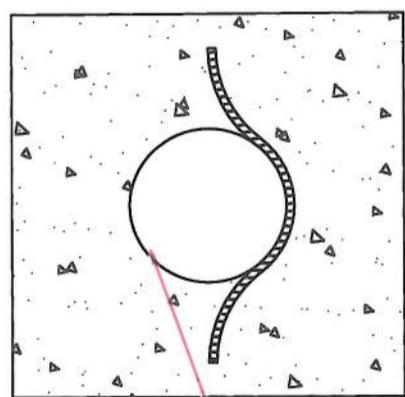

## Footpath



Mass concrete footing  
 $f_c=18\text{ MP}$

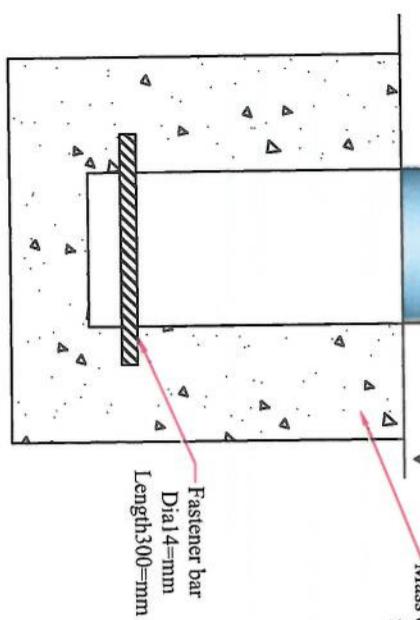

BOLLARD DETAILS, EACH @ 120cm C/C Based on Drawing  
SCALE: NTS

Designed By: Mohammad Esa Sial	Signature: 
Drawn by: Mohammad Esa Sial	Signature: 
Checked by: Hasbullah Shafizi	Signature: 
Date: 6/8/2023	Scale: 00
Status: FINAL DESIGN	
Project Code	
Drawing Number BD-1	Revision 00

NOTE:  
All dimensions are in meters  
unless mentioned.

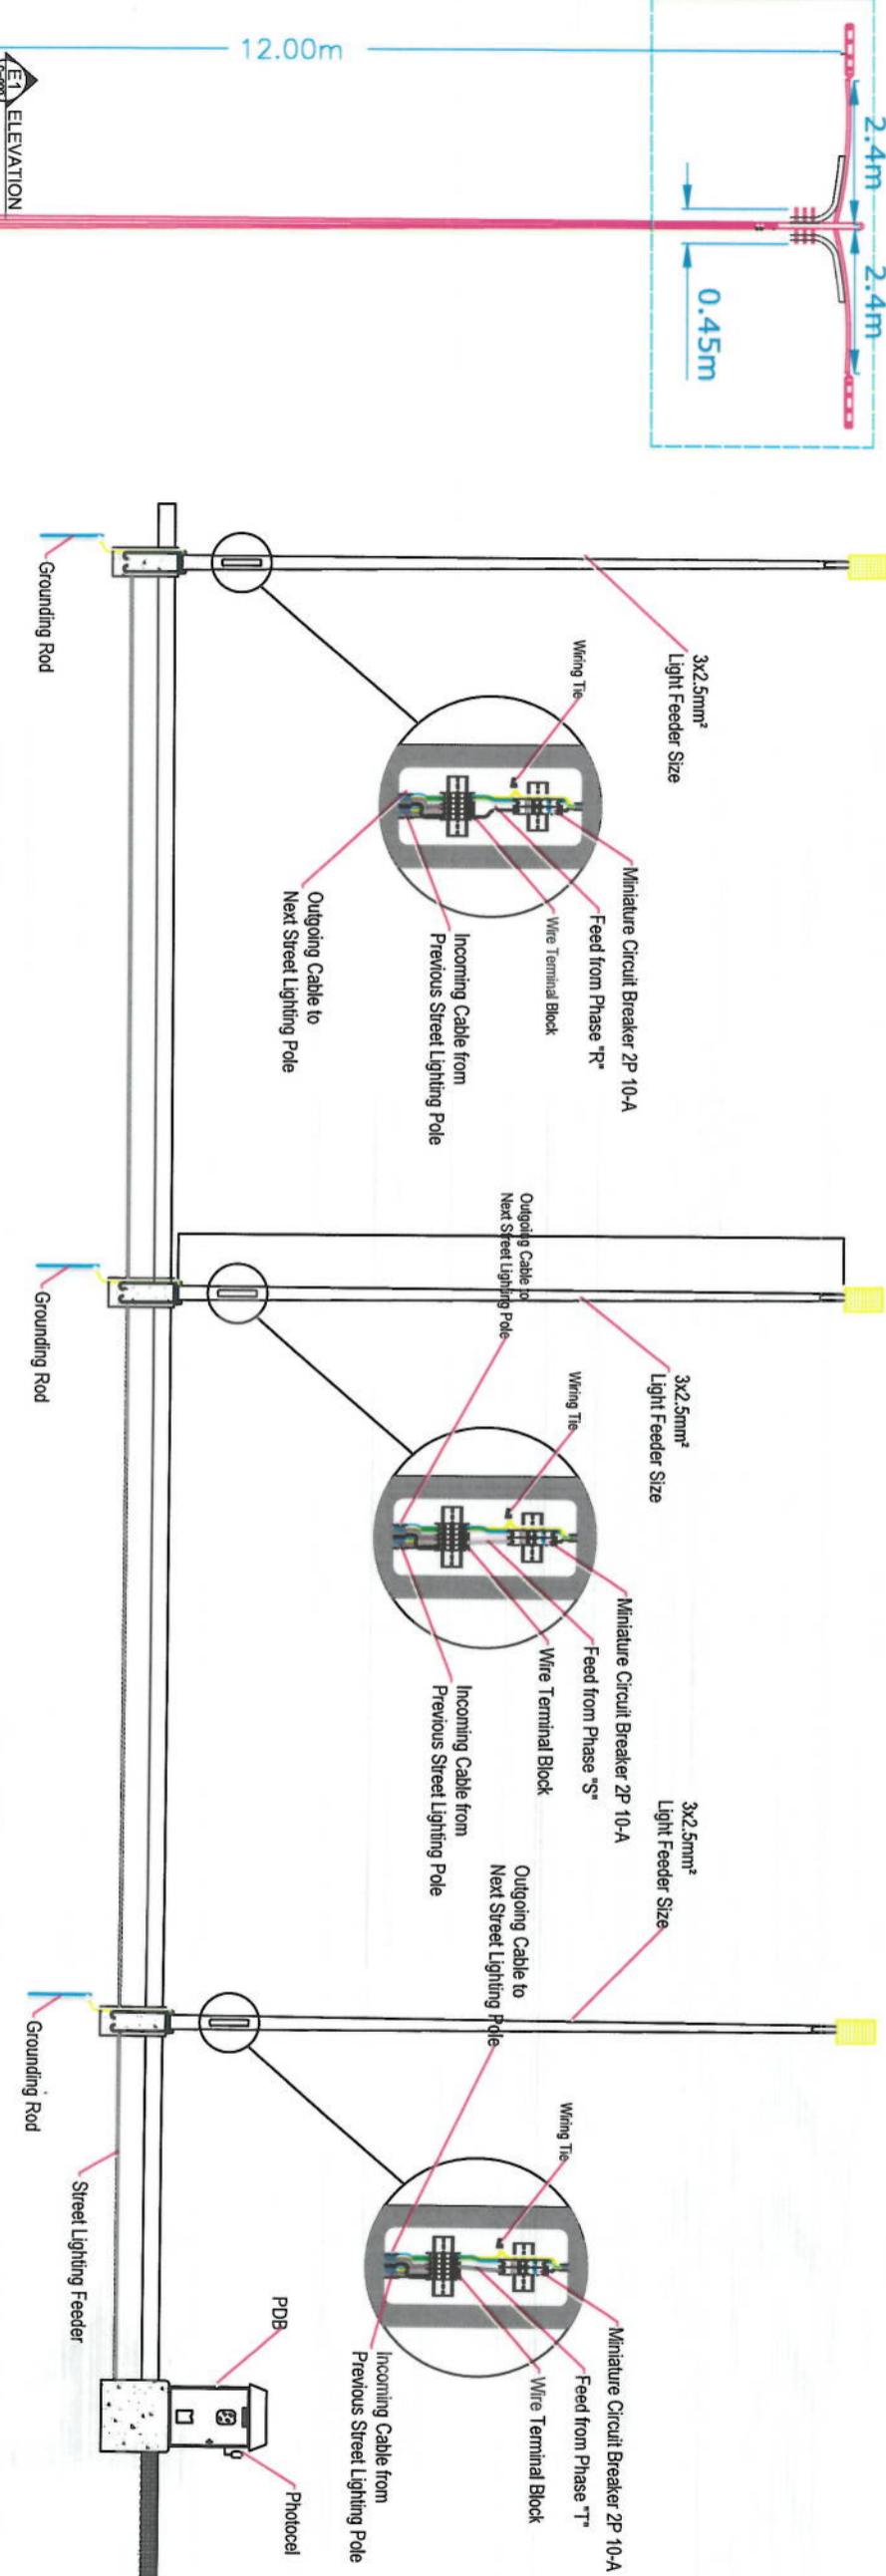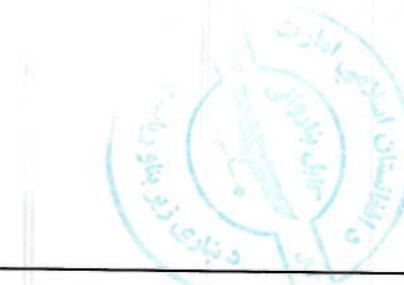


Street Light Poles Wiring System (Elevation)

128Extra Wide Street (EWS) Street Light  
or approved equivalent  
Lumin 15660min  
wattage 128watt


128Extra Wide Street (EWS) Street Light  
or approved equivalent  
Lumin 15660min  
wattage 128watt

Capping should be in proper way .

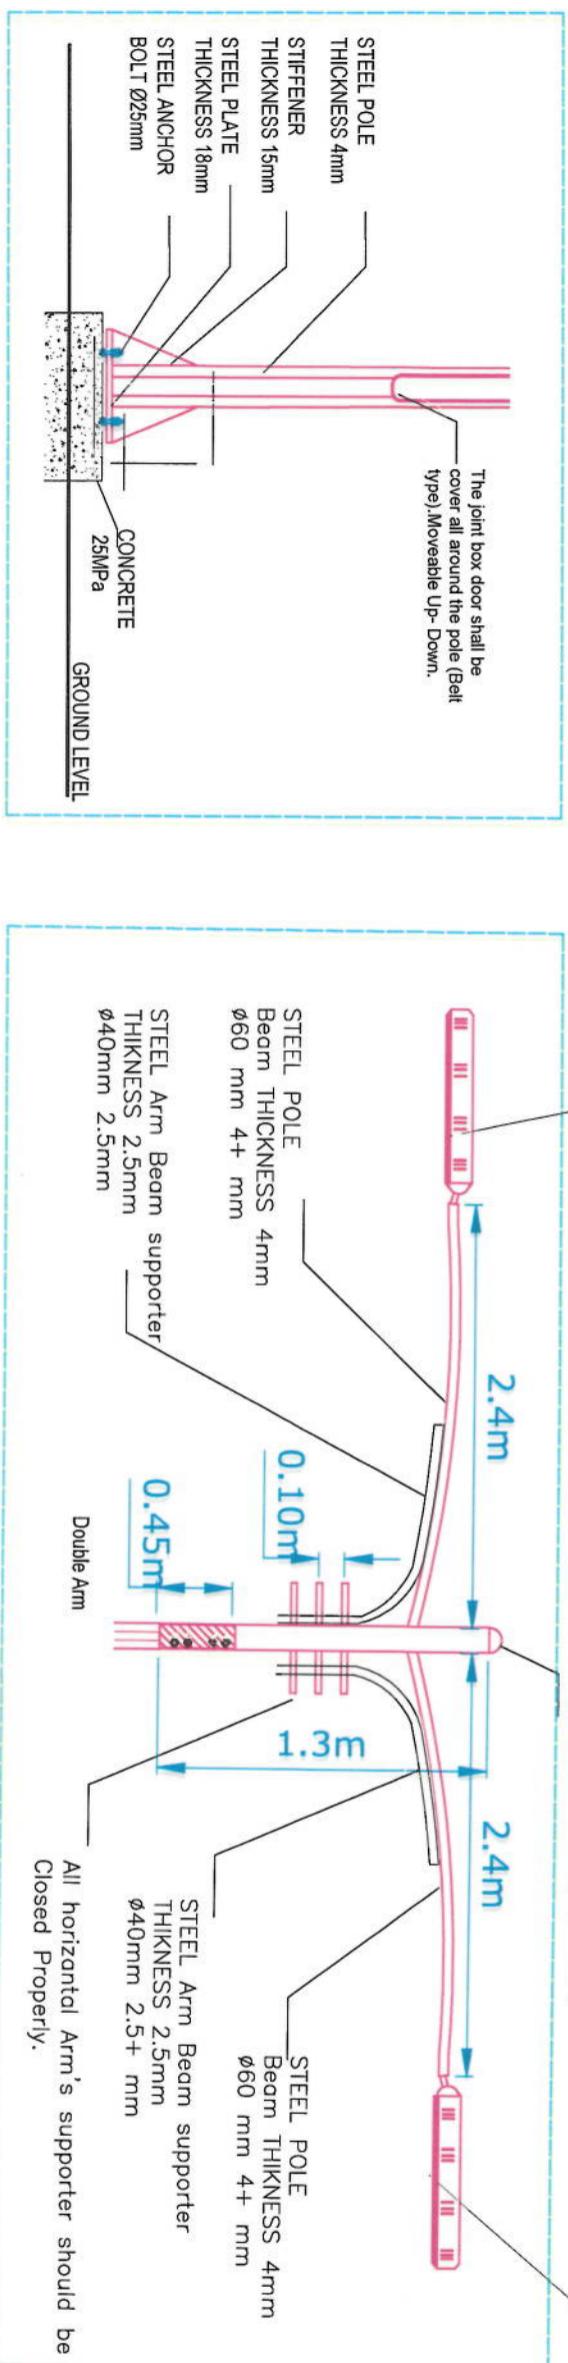

Street Light Pole Double Arm Detail

Project Name:	RAHMAN MINA ROAD		
Drawn by:	Signature	Checked by:	Signature
Mohammed Easa Sait		Hassanullah Shahzai	
Date:	6/7/2023	SCALE:	
Status:	FINAL DESIGN	Project Code:	
Drawing Number:	LD-01	Revision:	01

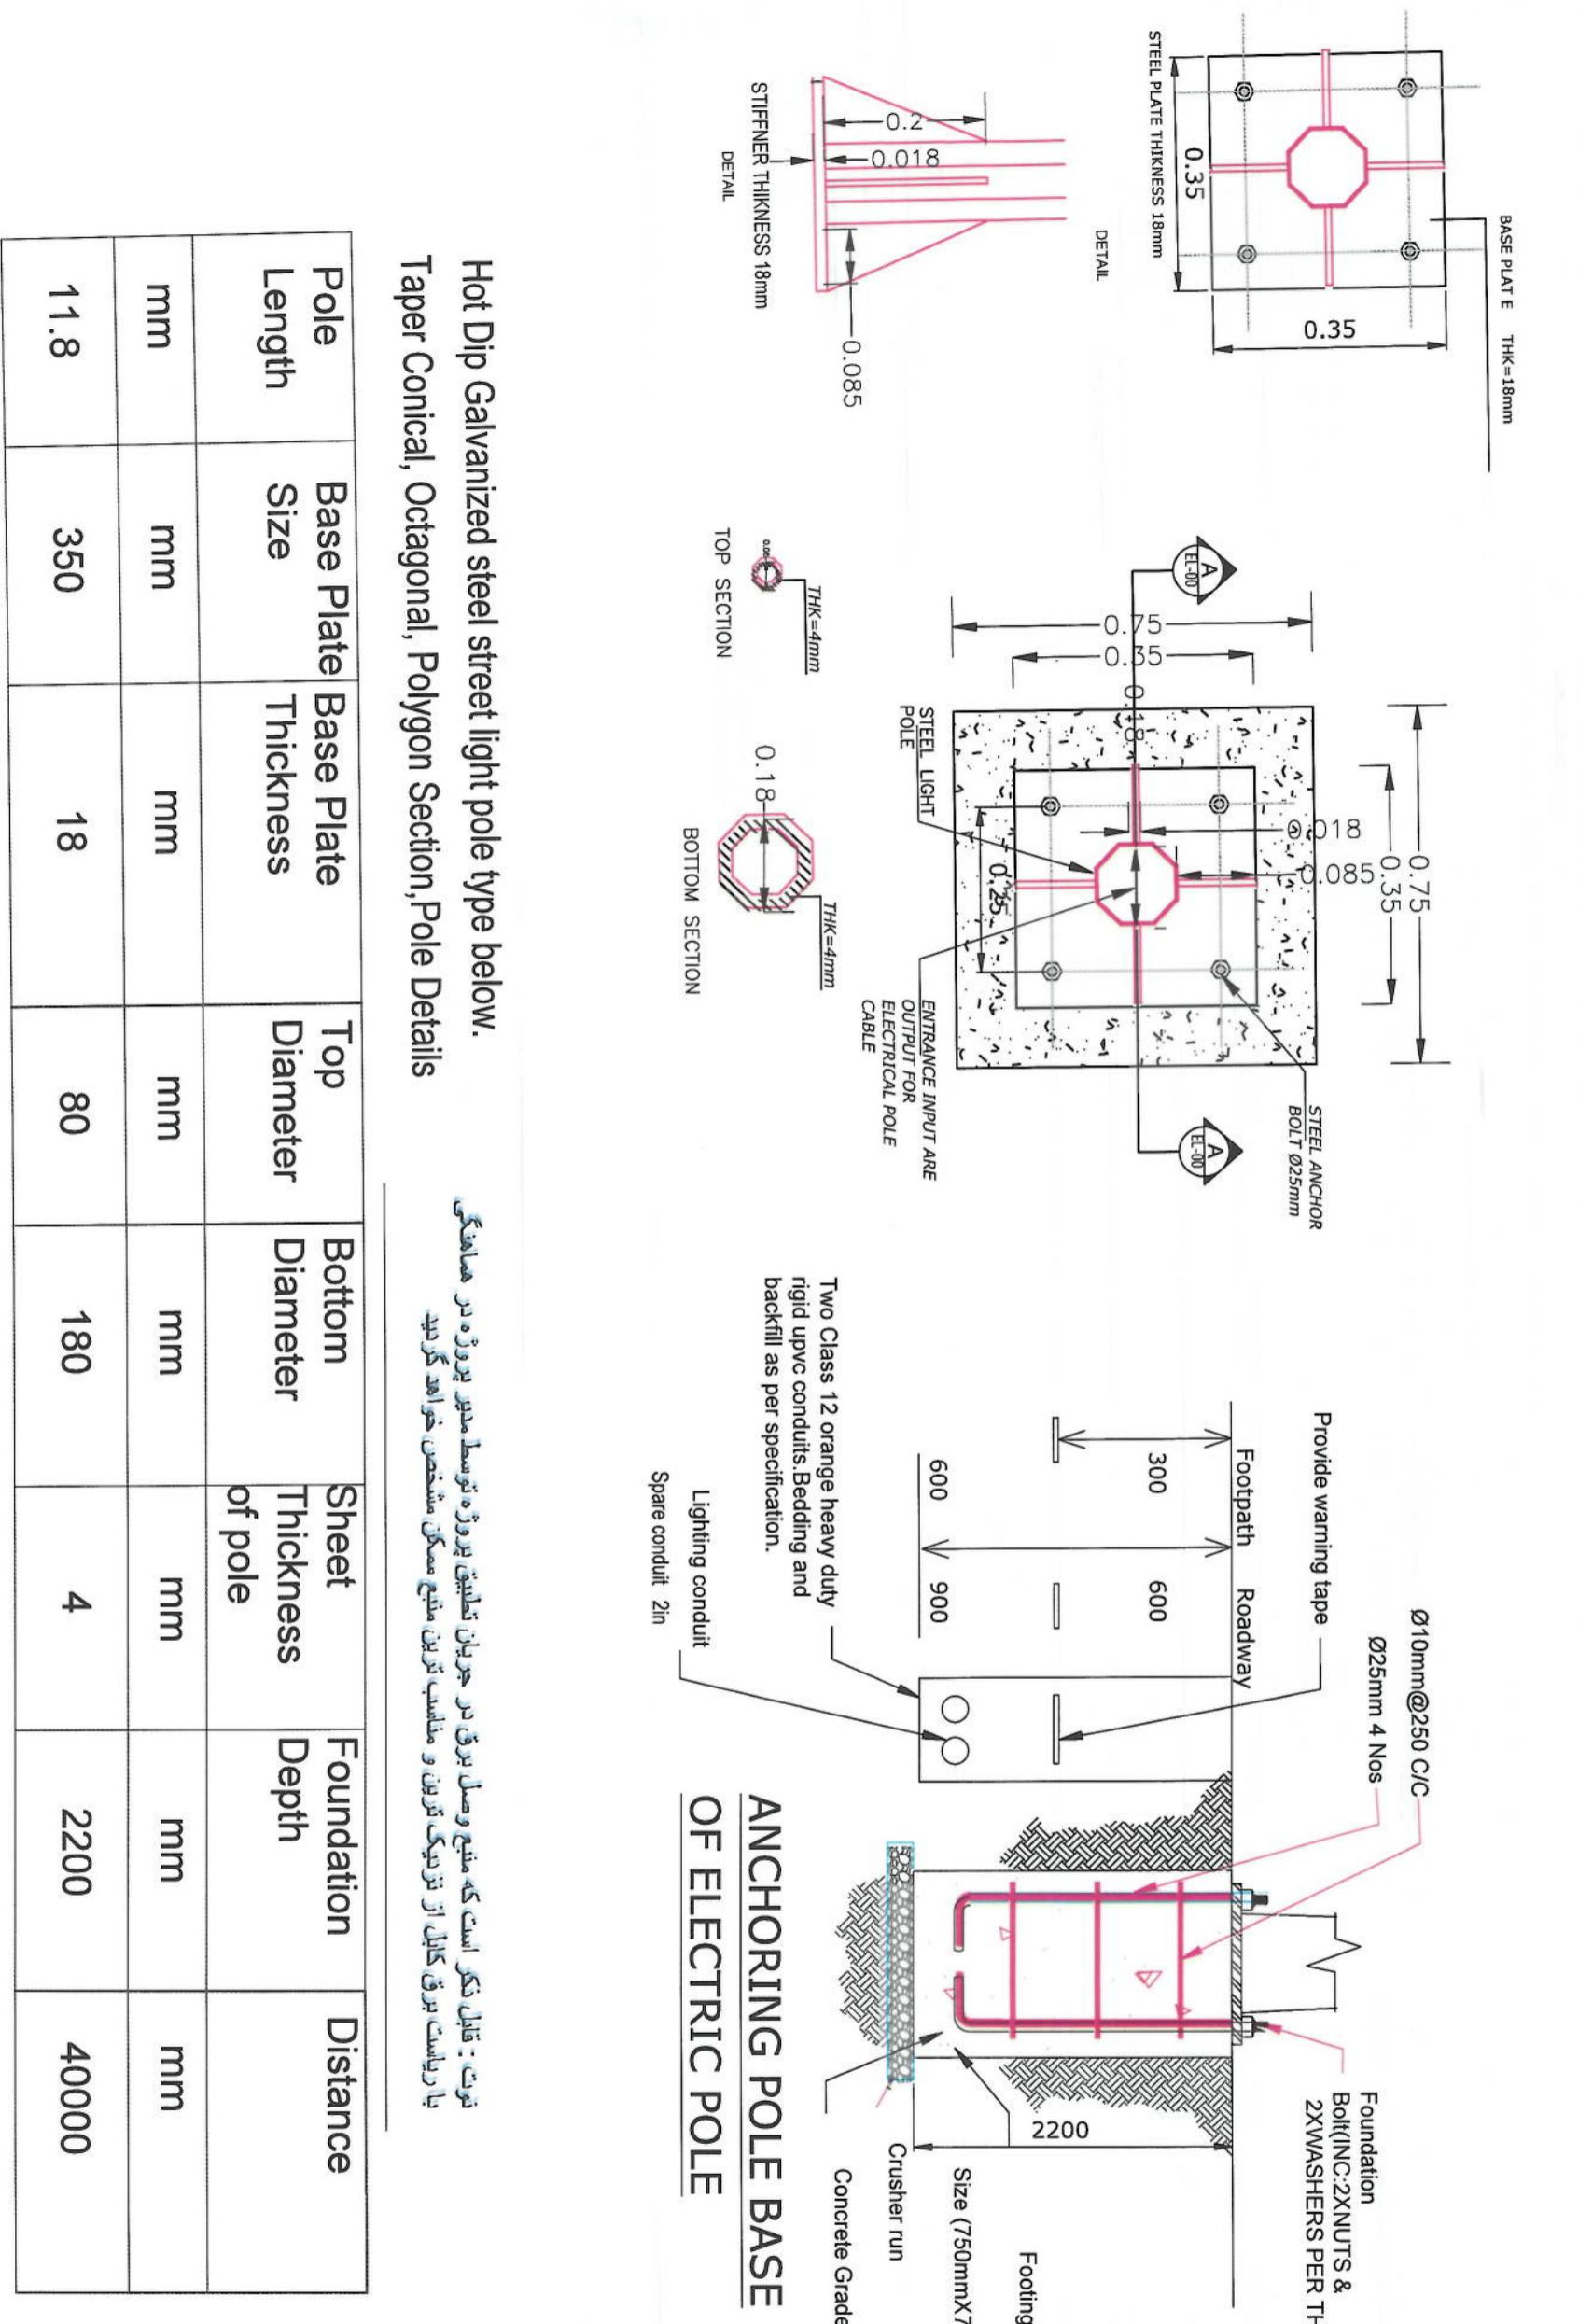

## ANCHORING POLE BASE OF ELECTRIC POLE

**نوت:** قبل نکر است که منیع وصل برق در جریان تطبیق بروزه توسعه مدیر بروزه در همانگی  
با ریاست برق کالای از نزدیک تولید و ملابس آن ملتم ممکن مشخص خواهد گردید

**Hot Dip Galvanized steel street light pole type below.**  
**Taper Conical, Octagonal, Polygon Section,Pole Details**

Pole Length	Base Plate Size	Base Plate Thickness	Top Diameter	Bottom Diameter	Sheet Thickness of pole	Foundation Depth	Distance
mm	mm	mm	mm	mm	mm	mm	mm
11.8	350	18	80	180	4	2200	40000

## Street Light Pole Double Arm Detail

Project Name:		RAHMAN MINA ROAD	
Drawing Title:		Lighting Detail	
Drawn by:			
Mohammad Fiaz Sial	Signature		
Checked by:			
Hashimullah Shahzai	Signature		
6/7/2023	SCALE:		
Status:	FINAL DESIGN		
Project Code:			
Drawing Number:	LD-02	Revision:	02
<p><b>NOTE:</b>  <b>All dimensions are in meters</b>  unless mentioned.</p>			